


PROJECT	DESIGNATION
1500153	1500153
CONTRACT	BRIDGE FILE
R-37820	N/A

INDIANA  
DEPARTMENT OF  
TRANSPORTATION

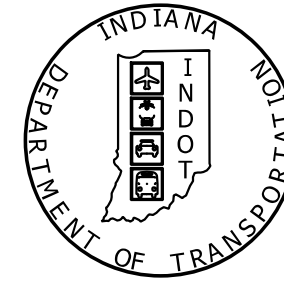


# ROAD PLANS

## I-65 & US 50 Interchange Modification PROJECT NO. 1500153 P.E. PROJECT NO. 1500153 CONST.

EXTENSION OF THE NORTHBOUND ACCELERATION LANE ON I-65  
BEGINNING AT THE GORE OF NORTHBOUND I-65 TO WESTBOUND US  
50 OFF RAMP EXTENDING NORTH 573 FEET. IN THE CITY OF  
SEYMOUR. SECTIONS 15, T-6-N, R-6-E IN JACKSON TOWNSHIP OF  
JACKSON COUNTY, INDIANA


RP 49+0.68 TO 49+0.78

I-65 NORTHBOUND	
<b>TRAFFIC DATA</b>	
A.A.D.T. (2019 PROJECTED)	15,660 VPD
A.A.D.T. (2039 PROJECTED)	16,710 VPD
D.H.V. (2039 PROJECTED)	1,131 VPD
DIRECTIONAL DISTRIBUTION	100% POSITIVE
TRUCKS	37.10% A.A.D.T., 31.33% DHV
<b>DESIGN DATA</b>	
DESIGN SPEED	70 MPH
PROJECT DESIGN CRITERIA	3R (Freeway)
FUNCTION CLASSIFICATION	Interstate
RURAL/URBAN	Urban
TERRAIN	Level
ACCESS CONTROL	Full Control

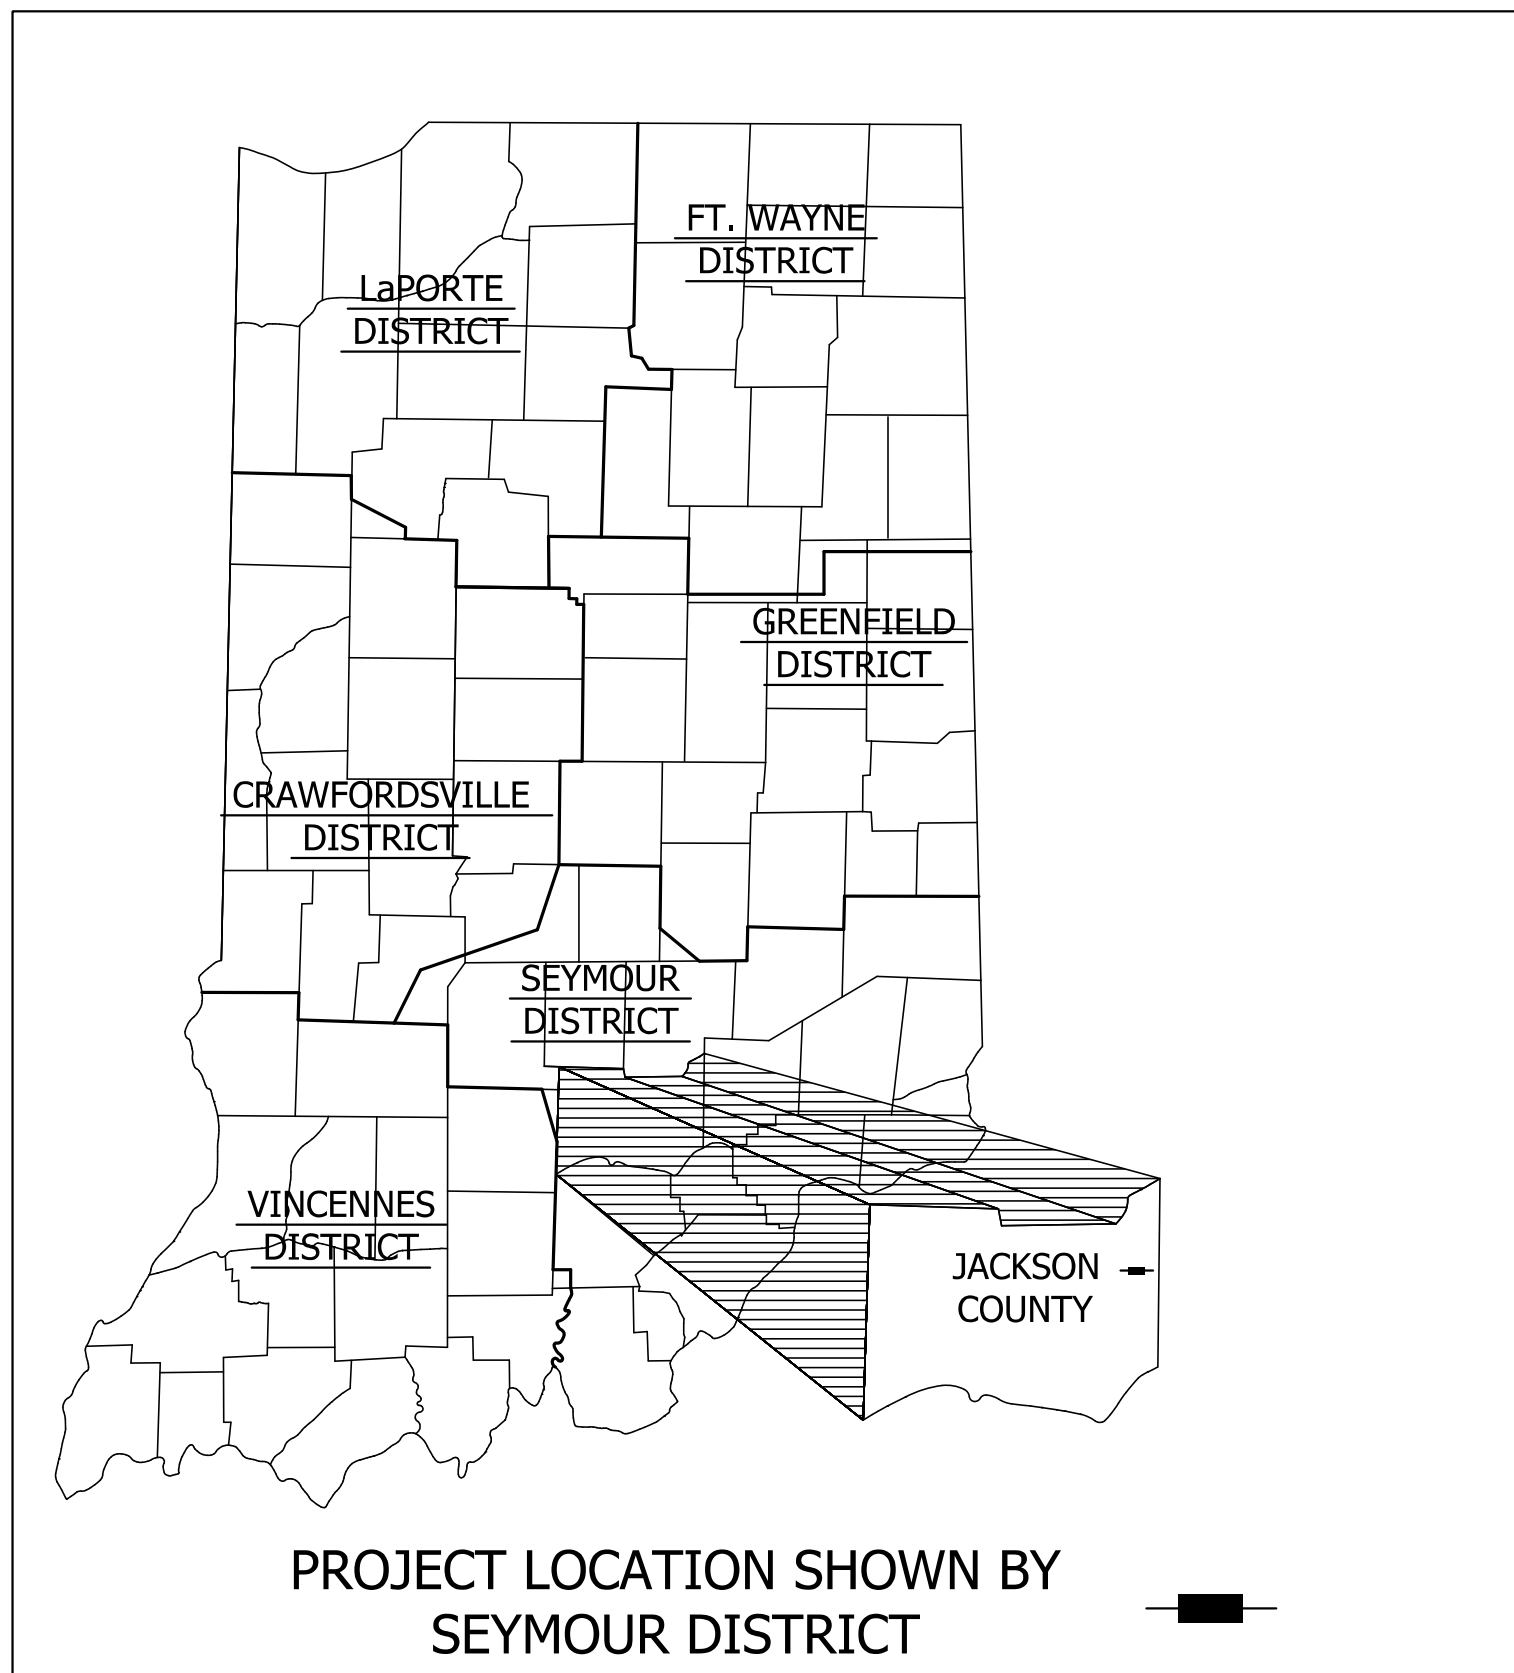

PROJECT LOCATION SHOWN BY  
SEYMOUR DISTRICT

Latitude 38°57'36" N Longitude 85°50'36" W

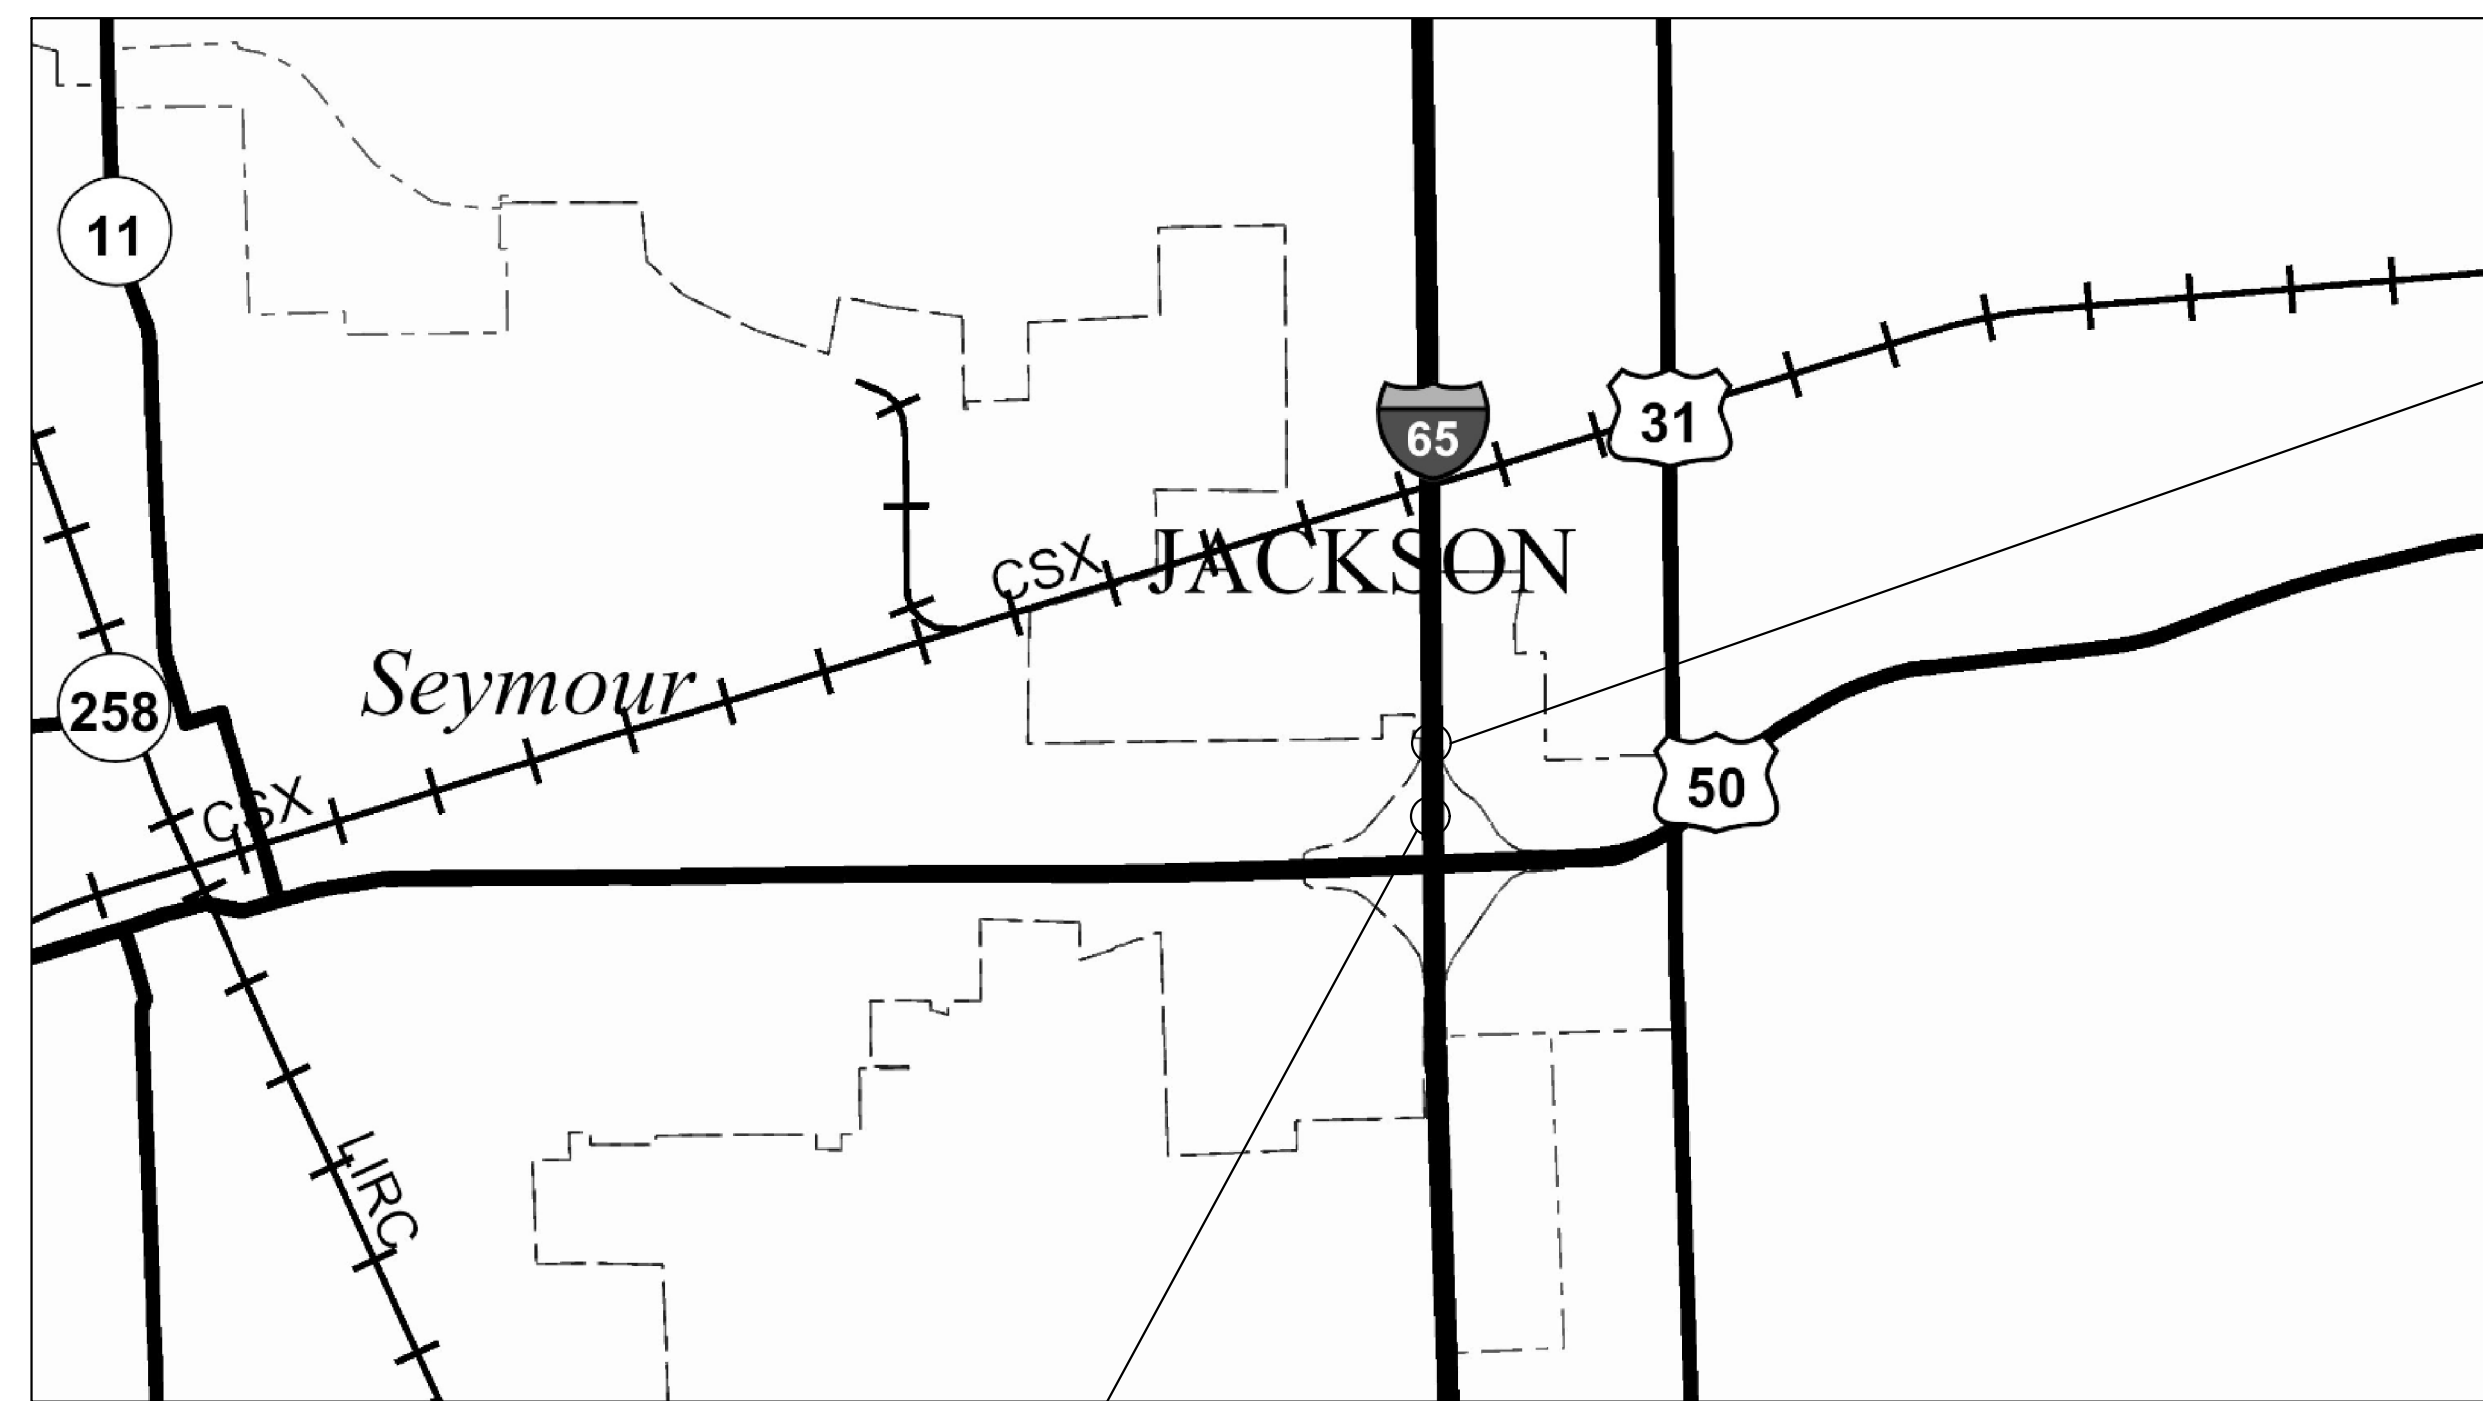

BEGIN PROJECT 1500153  
100+98.25 "A"

LOCATION MAP  
SCALE: 1" = 2000'

END PROJECT 1500153  
106+71.26 "A"

KIN PROJECT INFORMATION	
DES. NO.	PROJECT DESCRIPTION
1400090	U.S. 50 PAVEMENT RECONSTRUCTION
1400197	U.S. 50/U.S. 31 INTERSECTION IMPROVEMENT
1700403	U.S. 50 OVER SANDY BRANCH - 050-36-05106 CEBL
1700404	U.S. 50 OVER SANDY BRANCH - 050-36-05106 CWBL
1801163	I-65 BRIDGE OVER U.S. 50 - I65-049-04253 DNBL
1801169	I-65 BRIDGE OVER U.S. 50 - I65-049-04253 DSBL
1902195	U.S. 50 PEDESTRIAN/BIKE SHARED USE PATH


GROSS LENGTH:	0.11	MI.
NET LENGTH:	0.11	MI.
MAXIMUM GRADE:	-1.14	%

**BURGESS & NIPLE**  
Engineers ■ Architects ■ Planners

251 N. ILLINOIS ST.  
CAPITOL CENTER SUITE 920  
INDIANAPOLIS, IN 46204  
PHONE (317) 237-2760  
FAX (317) 237-2755


INDIANA DEPARTMENT OF TRANSPORTATION  
STANDARD SPECIFICATIONS DATED 2020  
TO BE USED WITH THESE PLANS

PLANS PREPARED BY:	BURGESS & NIPLE, INC.	(317) 237-2760
		PHONE NUMBER
PREPARED BY:	<i>Jason Mathias</i>	10/25/2019
		DATE
APPROVED FOR LETTING:	<i>Jeremy C. Hunter</i>	12/31/2019
	INDIANA DEPARTMENT OF TRANSPORTATION	DATE

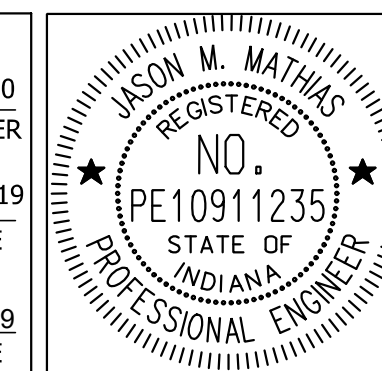


BRIDGE FILE	
N/A	
DESIGNATION	
1500153	
DWG. NO.	SHEET NO.
TI-01	1 of 18
CONTRACT	PROJECT
R-37820	1500153




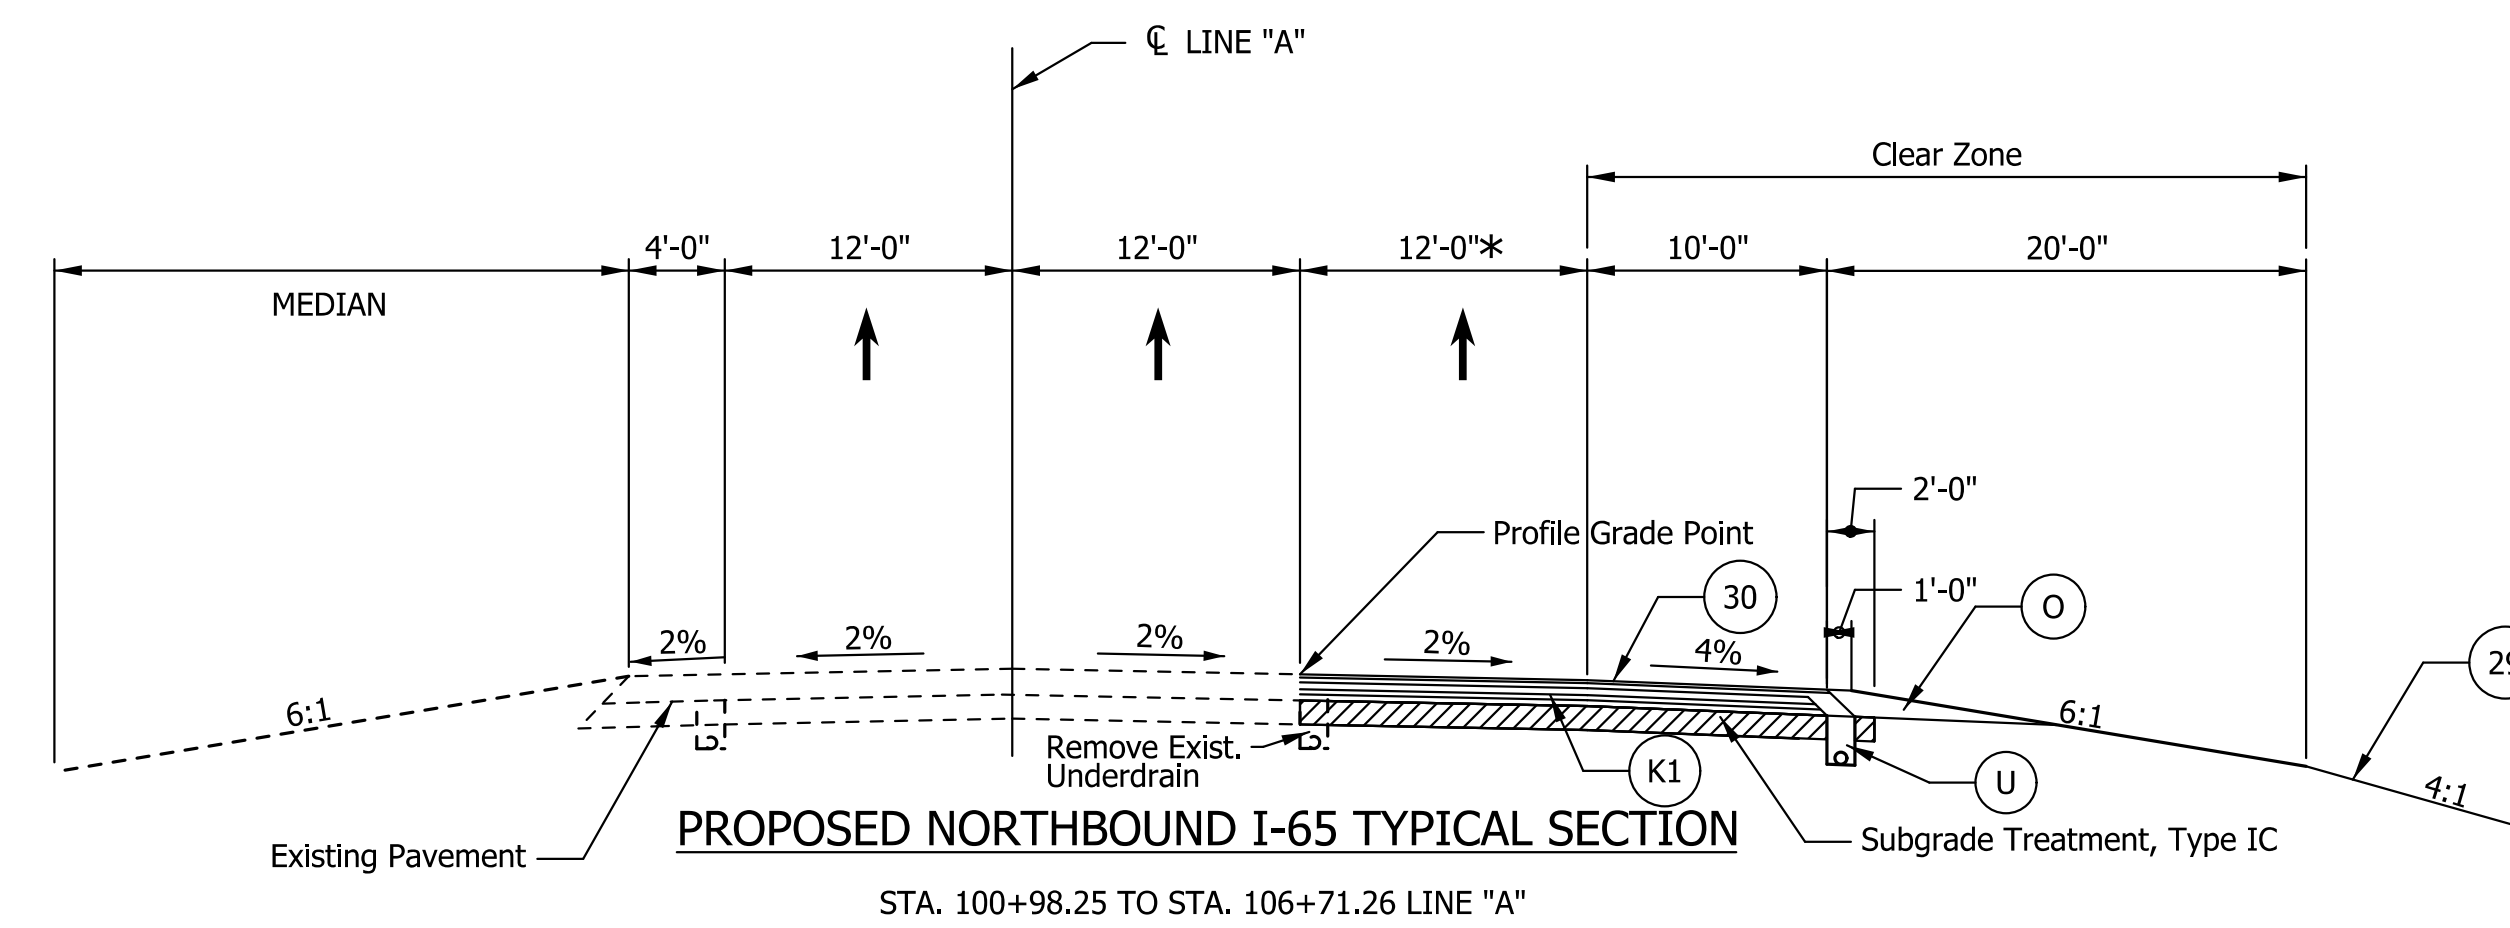

- LEGEND:**
- (K1) 165 #/SY QC/QA-HMA, 4, 76, SURFACE, 9.5 mm ON  
330 #/SY QC/QA-HMA, 4, 76, INTERMEDIATE, 19 mm ON  
385 #/SY QC/QA-HMA, 4, 64, BASE, 19 mm ON  
385 #/SY QC/QA-HMA, 4, 64, BASE, 19 mm ON  
385 #/SY QC/QA-HMA, 4, 64, BASE, 19 mm ON  
SUBGRADE TREATMENT, TYPE IC (12 IN. NO. 53 AGGREGATE)
  - (O) VARIABLE-DEPTH COMPACTED AGGREGATE, NO. 53
  - (U) UNDERDRAIN
  - (29) MULCHED SEEDING, U
  - (30) SHOULDER CORRUGATIONS
- \* STA. 103+71.26 TO STA. 106+71.26 LINE "A"  
VARIES 12'-0" TO 0'-0"

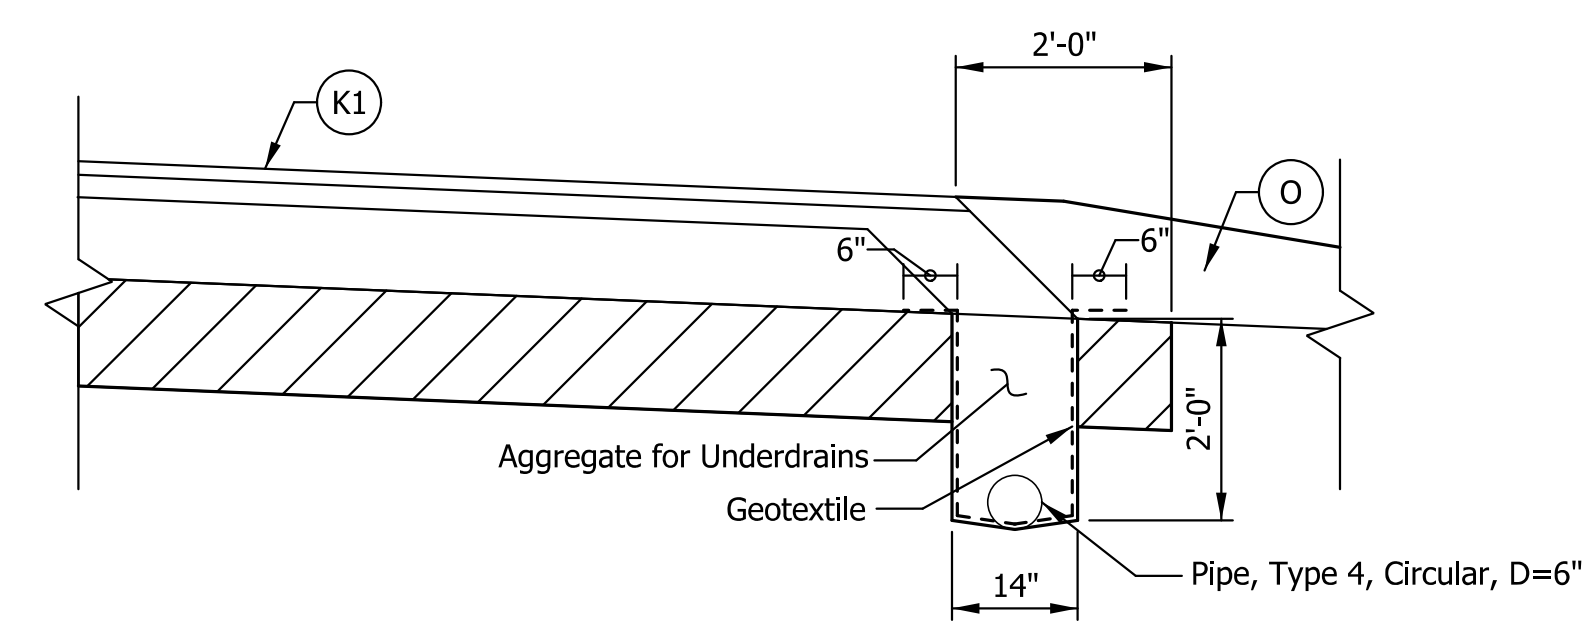


**UNDERDRAIN FOR HMA PAVEMENT**  
NOT TO SCALE

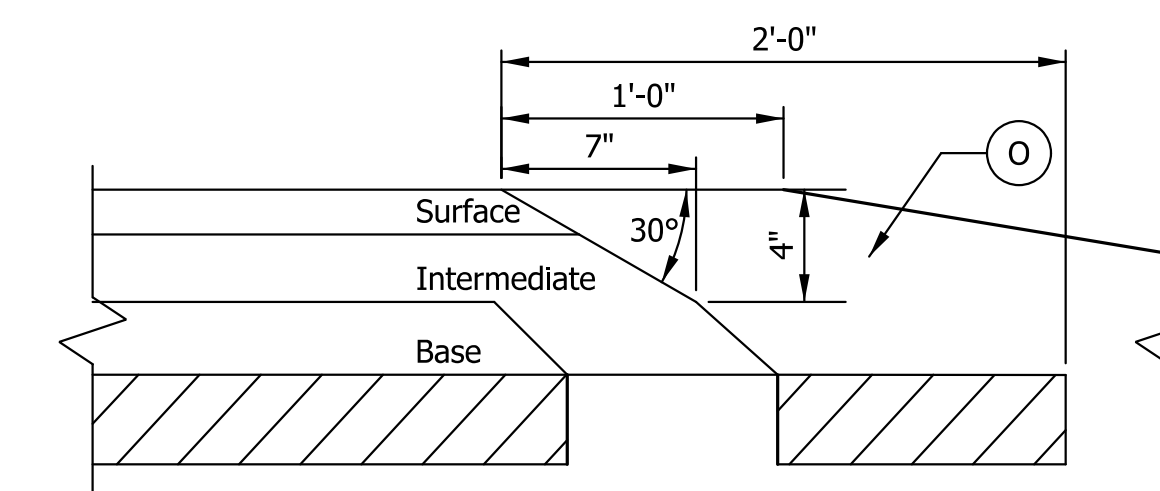

**SAFETY EDGE ON HMA PAVEMENT**  
NOT TO SCALE

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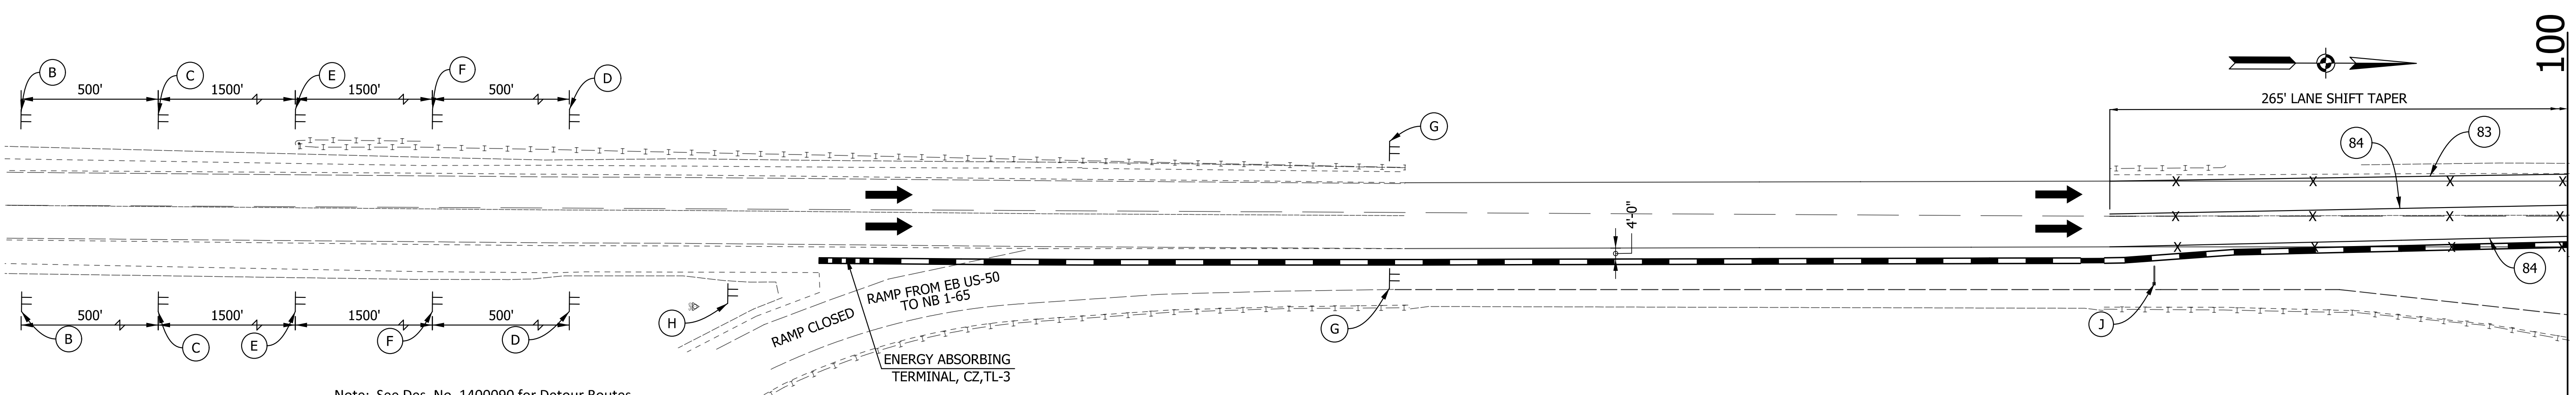


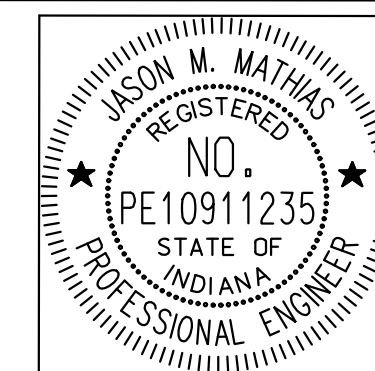RECOMMENDED FOR APPROVAL	<i>Jason Mathias</i>	10/25/2019
	DESIGN ENGINEER	DATE
DESIGNED: LEJ	DRAWN: LEJ	
CHECKED: JMM	CHECKED: JMM	

**INDIANA**  
**DEPARTMENT OF TRANSPORTATION**  
  
**TYPICAL SECTIONS**

HORIZONTAL SCALE	BRIDGE FILE	
N/A	N/A	
VERTICAL SCALE	DESIGNATION	
N/A	1500153	
SURVEY BOOK	DWG. NO.	SHEET NO.
	TS-01	3 of 18
CONTRACT	PROJECT	
R-37820	1500153	



MATCHLINE STA. 100+00



Note: See Des. No. 1400090 for Detour Routes for Closed Ramps.

MAINTENANCE OF TRAFFIC - SUMMARY OF QUANTITIES						
DESCRIPTION	SIGN TYPE	QUANTITIES		DESCRIPTION	PAY QUANTITY	
		1	2		1	2
ROAD CONSTRUCTION AHEAD (XW20-1)	A	2		TEMPORARY PAVEMENT MARKING, REMOVABLE, 4 IN. (YELLOW)		1094
ROAD CONSTRUCTION 1000' (XW20-1)	A	2		TEMPORARY PAVEMENT MARKING, REMOVABLE, 4 IN. (WHITE)		2188
DOUBLE REVERSE CURVE (2 LANES) (W24-1A)	A	2		TEMPORARY PAVEMENT MARKING, REMOVABLE, 4 IN. LINE, REMOVE		2462 LFT
END CONSTRUCTION (XG20-2)	A	2		TEMPORARY TRAFFIC BARRIER, TYPE 2		1290
WORKSITE ADDED PENALTY SIGN (XW2-6)	A	2		ENERGY ABSORBING TERMINAL, CZ, TL-3	1	1 EACH
EXIT CLOSED (XW106-1-A)	A	1				
EXIT CLOSED (E5-2A)	A	*				
TOTAL		11				
TOTAL CONSTRUCTION SIGN, A			11 EACH			
WORKSITE SPEED LIMIT SIGN ASSEMBLY			2 EACH			
REDUCED SPEED ADVANCE WARNING SIGN ASSEMBLY			2 EACH			


\* QUANTIFIED IN DES. NO. 1400090

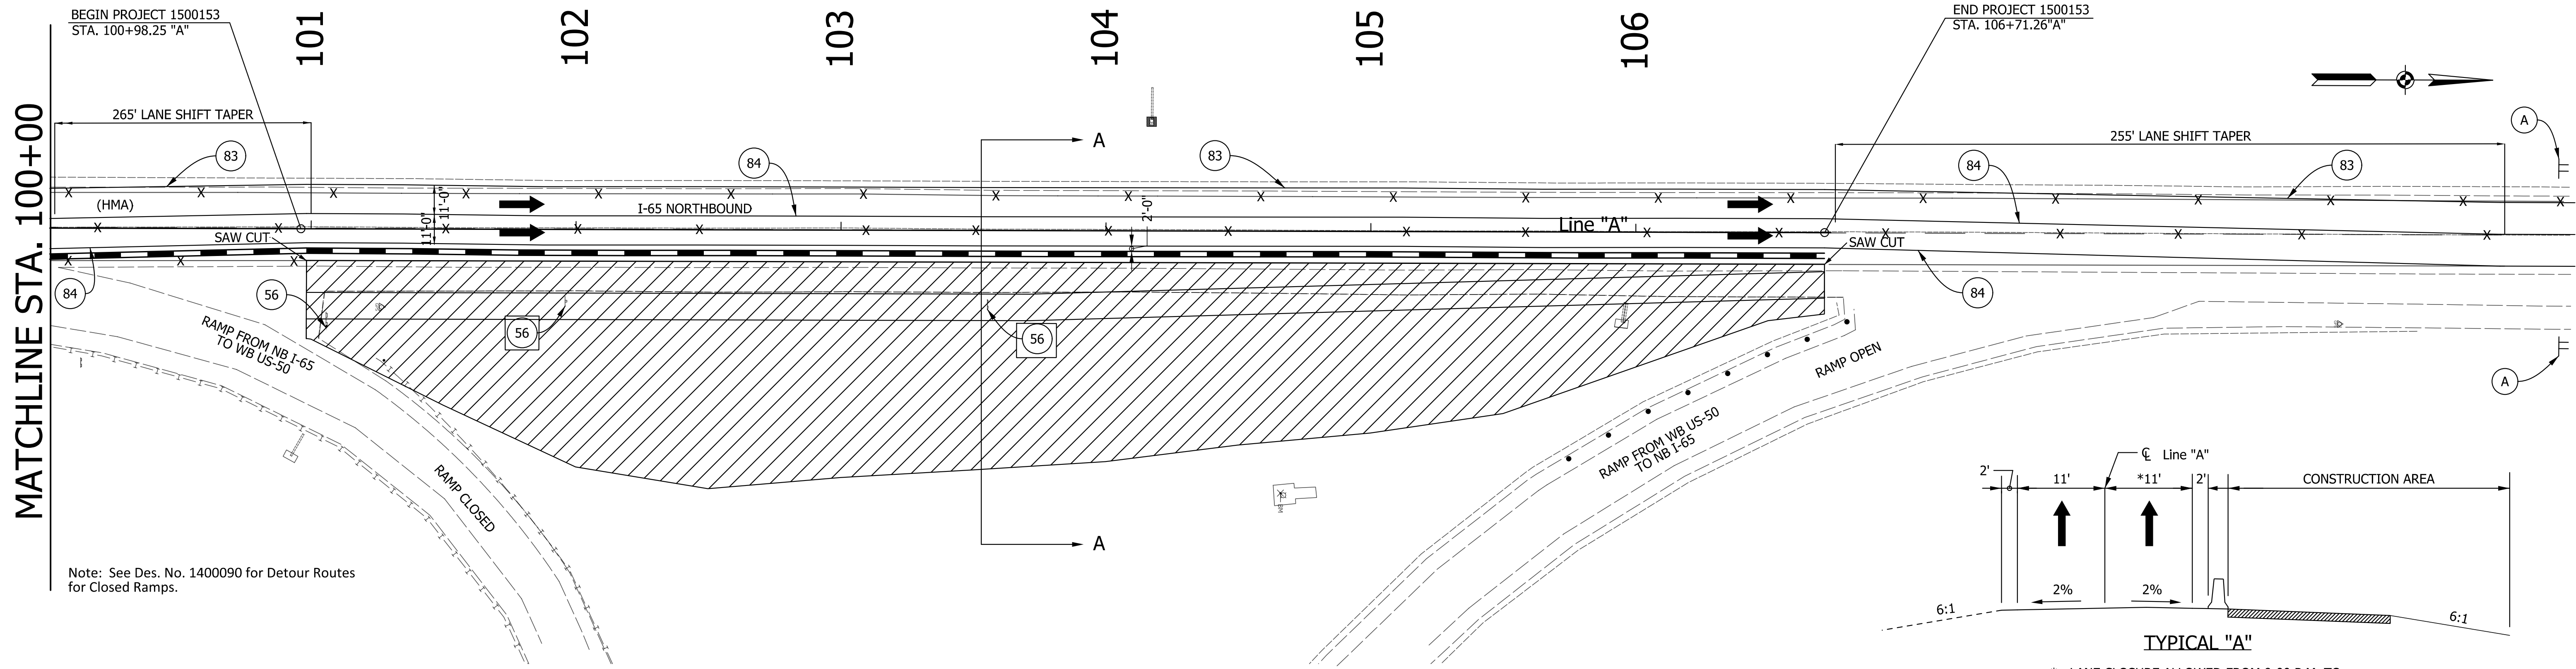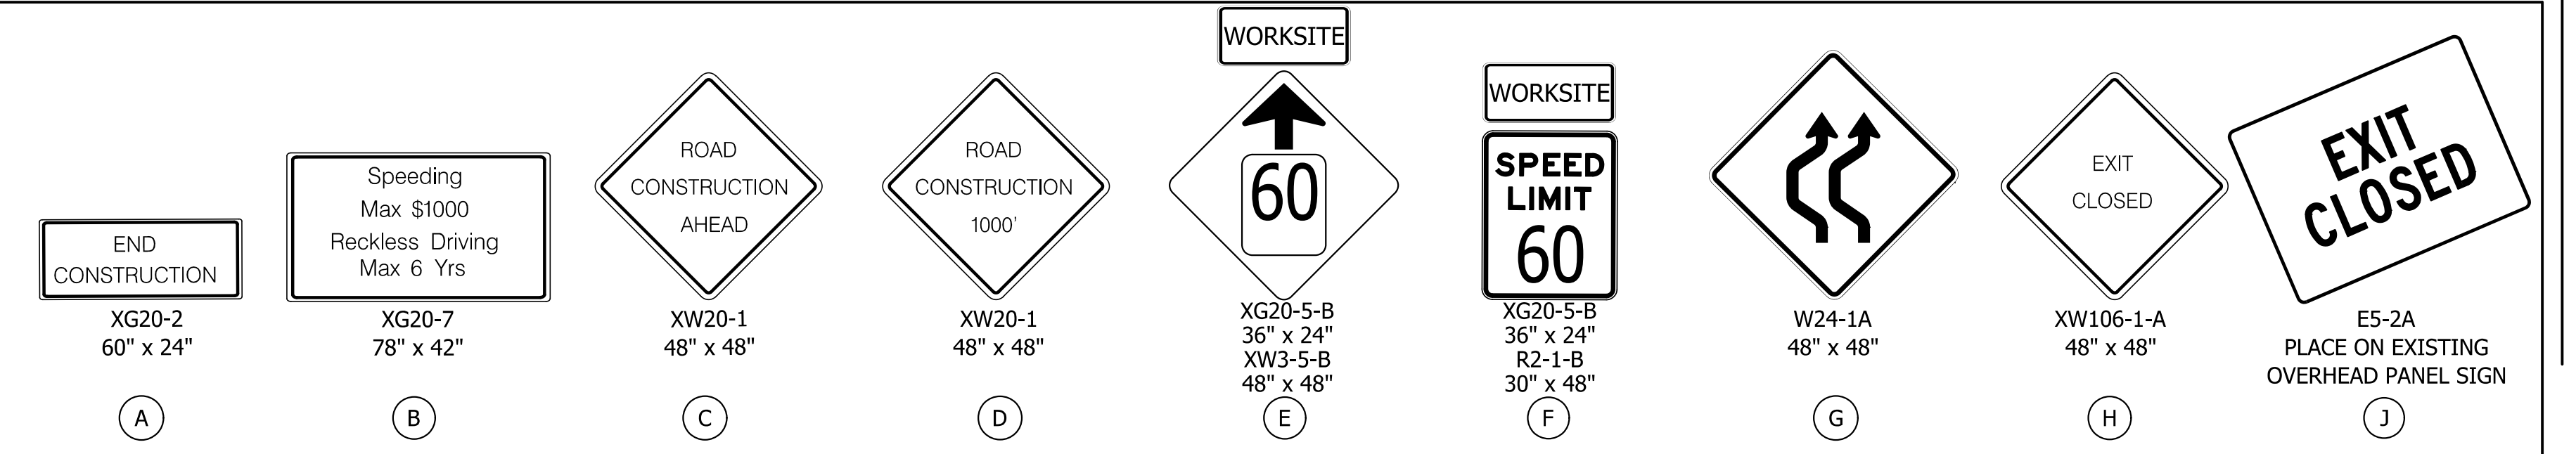

Note: See Des. No. 1400090 for Detour Routes for Closed Ramps.

\* LANE CLOSURE ALLOWED FROM 9:00 P.M. TO 6:00 A.M. ONLY. TWO NORTHBOUND 1-65 LANES MUST REMAIN OPEN AT ALL OTHER TIMES.

LEGEND	
(56)	REMOVE EXISTING SHEET SIGNS AND SUPPORTS
(83)	TEMP. PAVEMENT MARKING, REMOVABLE, YELLOW, 4"
(84)	TEMP. PAVEMENT MARKING, REMOVABLE, WHITE, 4"
T	CONSTRUCTION SIGN
	CONSTRUCTION AREA
	PAVEMENT MARKING REMOVAL
	DIRECTION OF TRAFFIC
	TEMPORARY CONCRETE BARRIER, TYPE 2
	DRUM

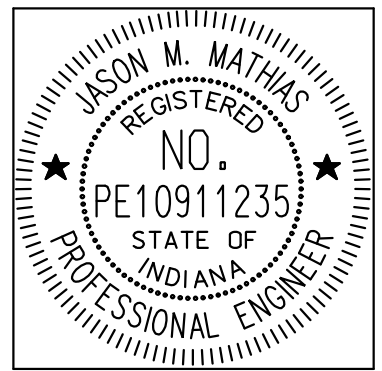


RECOMMENDED FOR APPROVAL	<i>Jason Mathias</i>	10/25/2019	
DESIGNED:	LEJ	DRAWN:	LEJ
CHECKED:	JMM	CHECKED:	JMM


INDIANA  
DEPARTMENT OF TRANSPORTATION  
MAINTENANCE OF TRAFFIC

HORIZONTAL SCALE	BRIDGE FILE	
1"=30'	N/A	
VERTICAL SCALE	DESIGNATION	
N/A	1500153	
SURVEY BOOK	DWG. NO.	SHEET NO.
	MT-01	4 of 18
CONTRACT	PROJECT	
R-37820	1500153	



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- LEGEND:**
- (K1) 165 #/SY OC/OA-HMA, 4, 76, SURFACE, 9.5 mm ON  
330 #/SY OC/OA-HMA, 4, 76, INTERMEDIATE, 19 mm ON  
385 #/SY OC/OA-HMA, 4, 64, BASE, 19 mm ON  
385 #/SY OC/OA-HMA, 4, 64, BASE, 19 mm ON  
385 #/SY OC/OA-HMA, 4, 64, BASE, 19 mm ON  
SUBGRADE TREATMENT, TYPE IC (12 IN. NO. 53 AGGREGATE)
  - 29 MULCHED SEEDING, U
  - 72 TO BE REMOVED

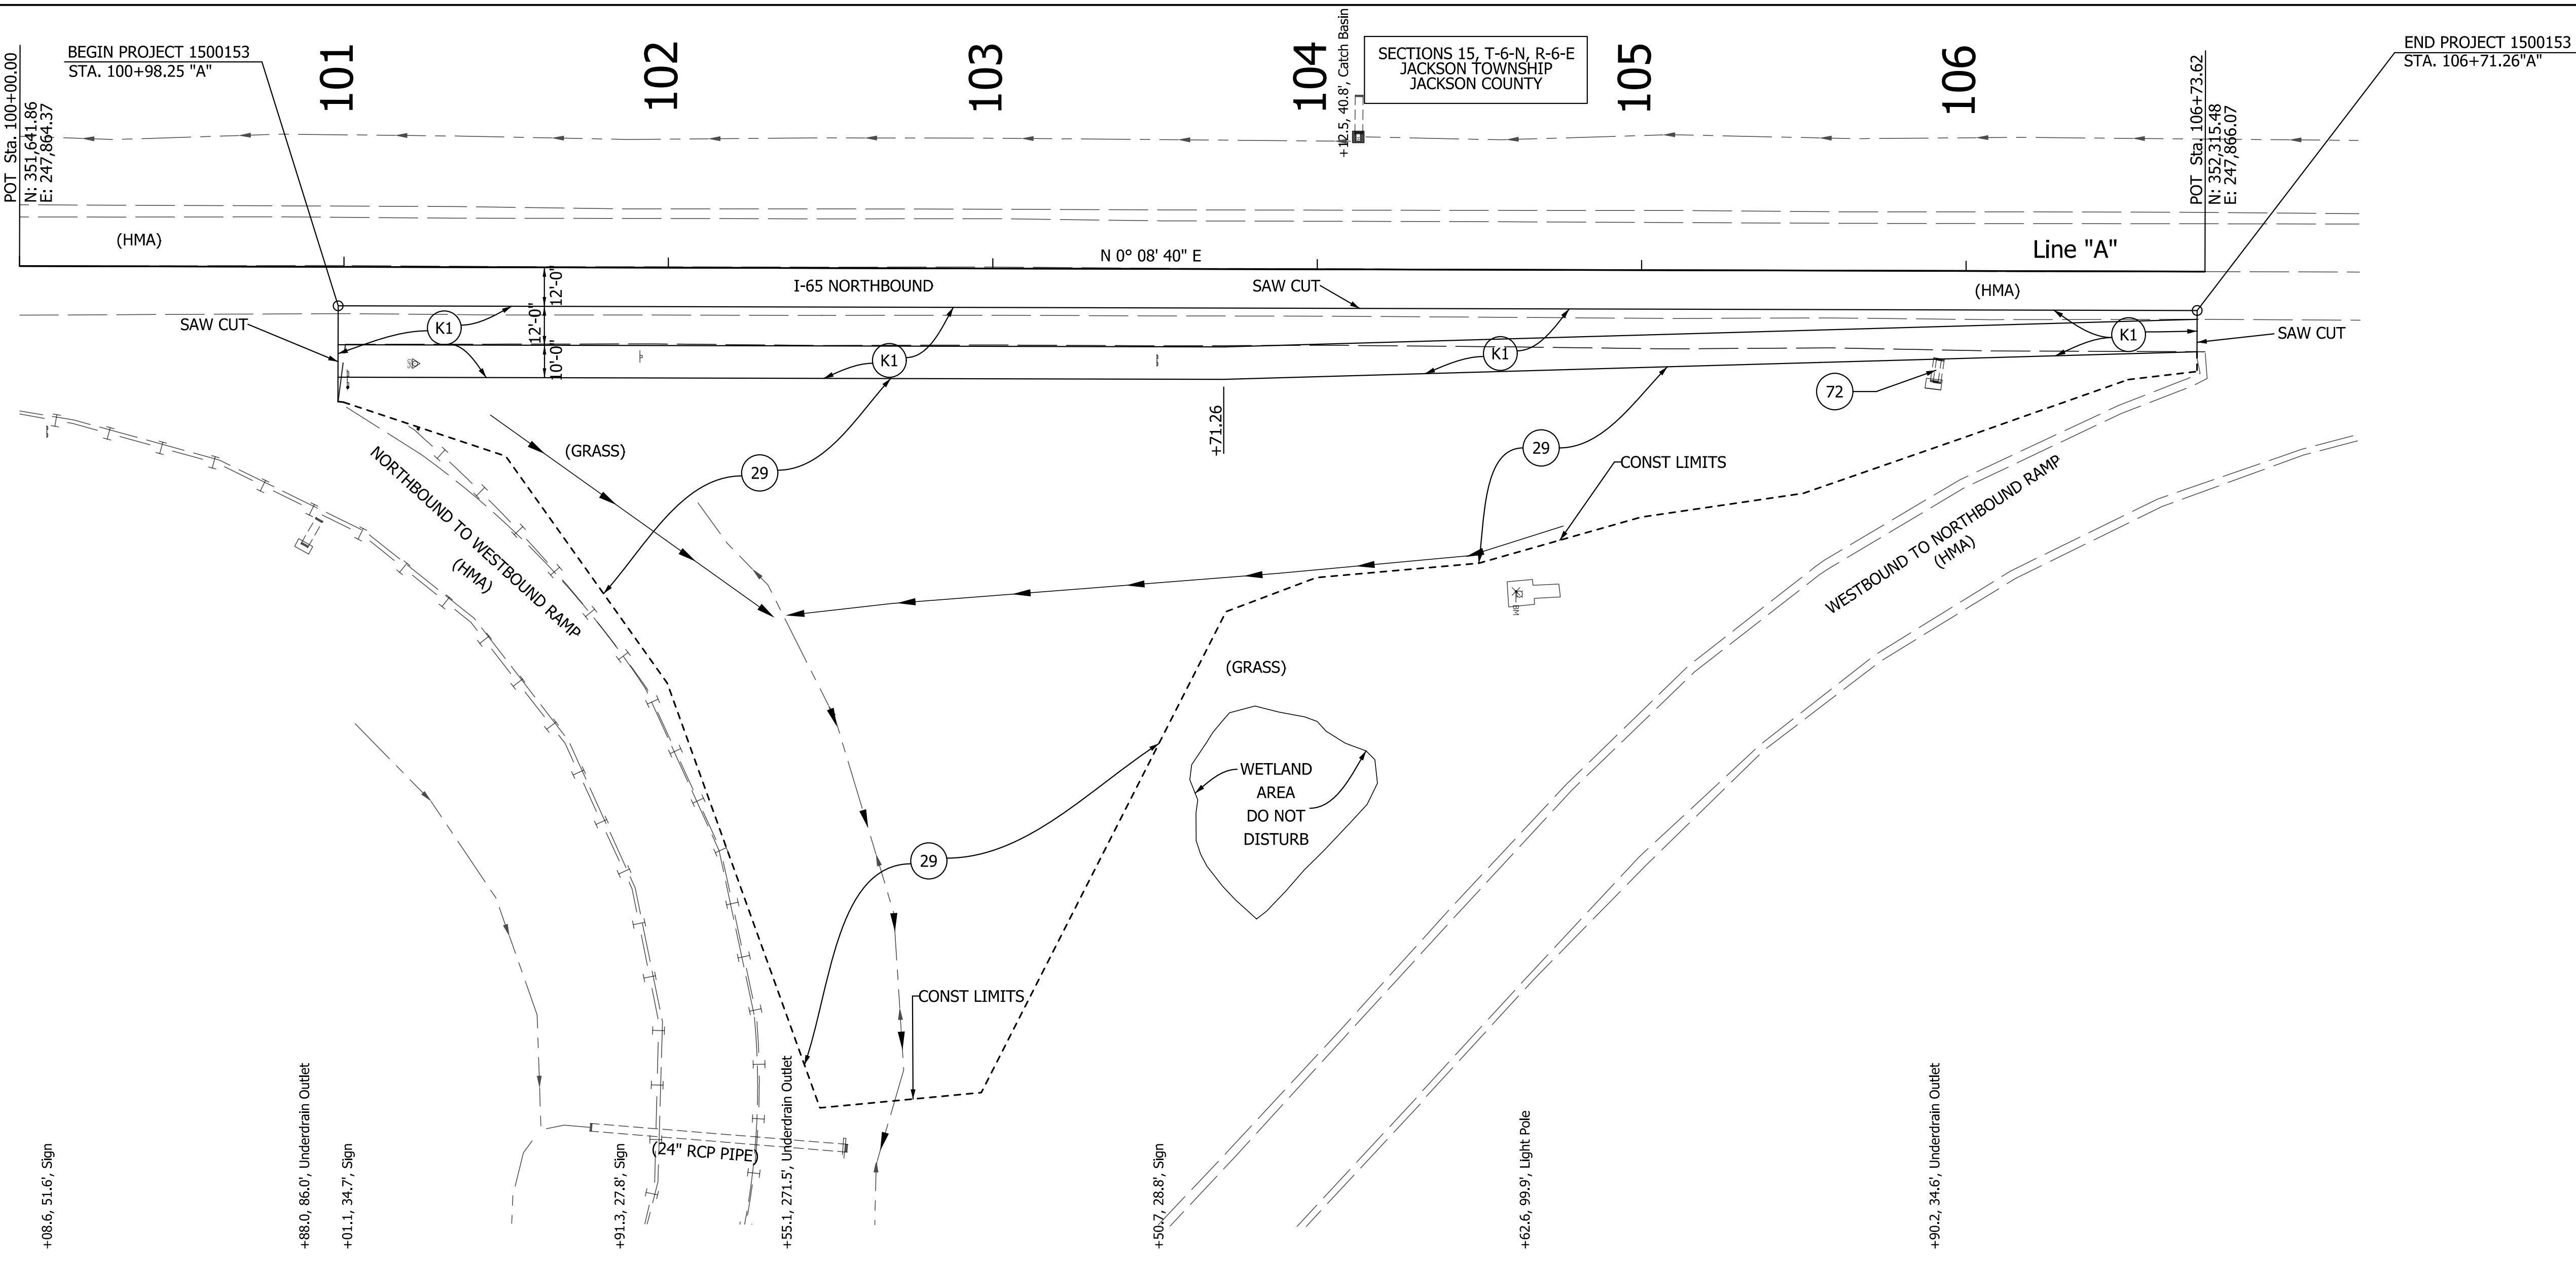

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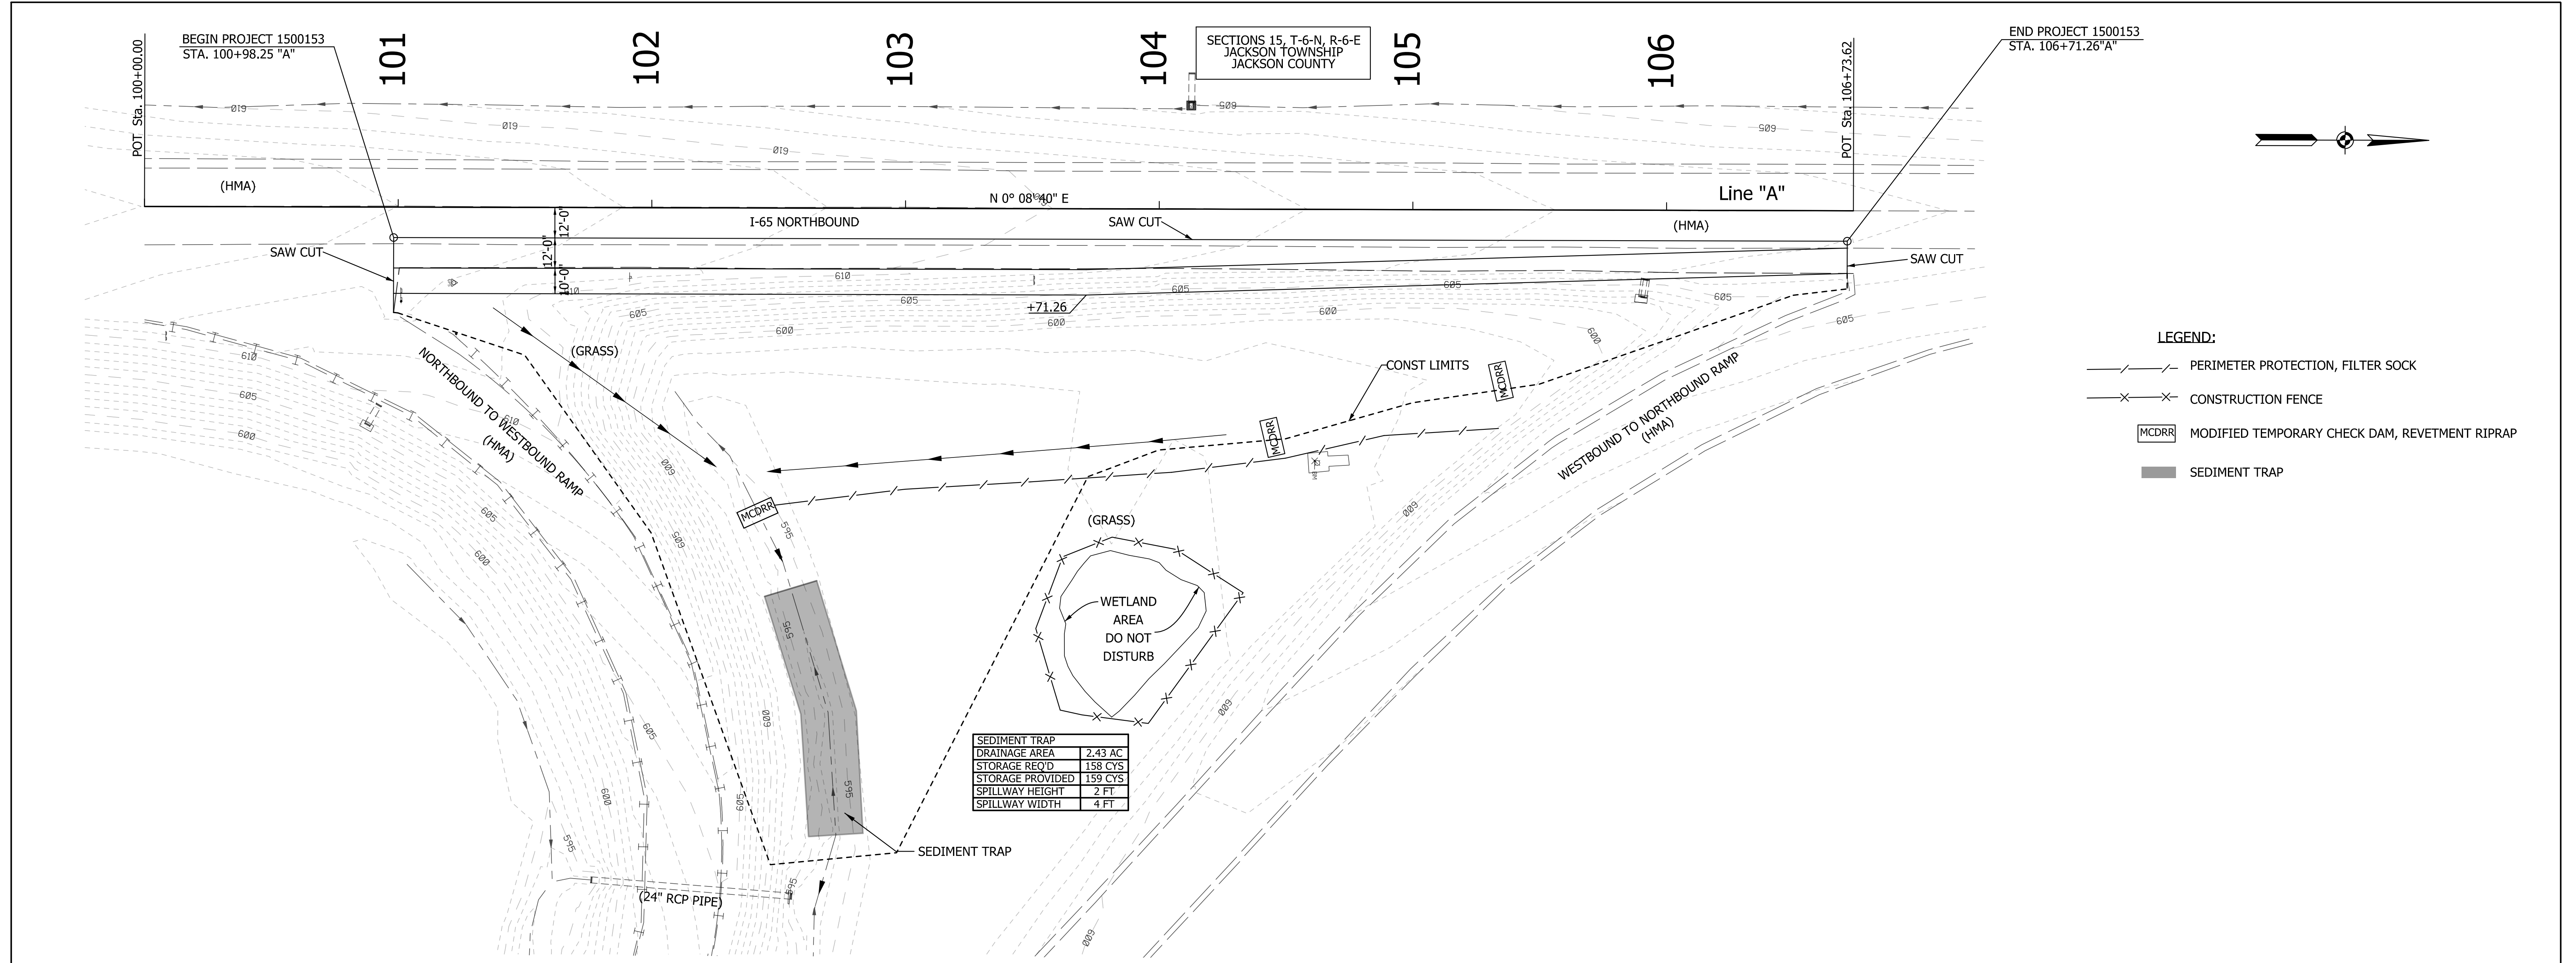
RECOMMENDED FOR APPROVAL  
*Jason Mathias*  
 DESIGN ENGINEER  
 DATE: 10/25/2019

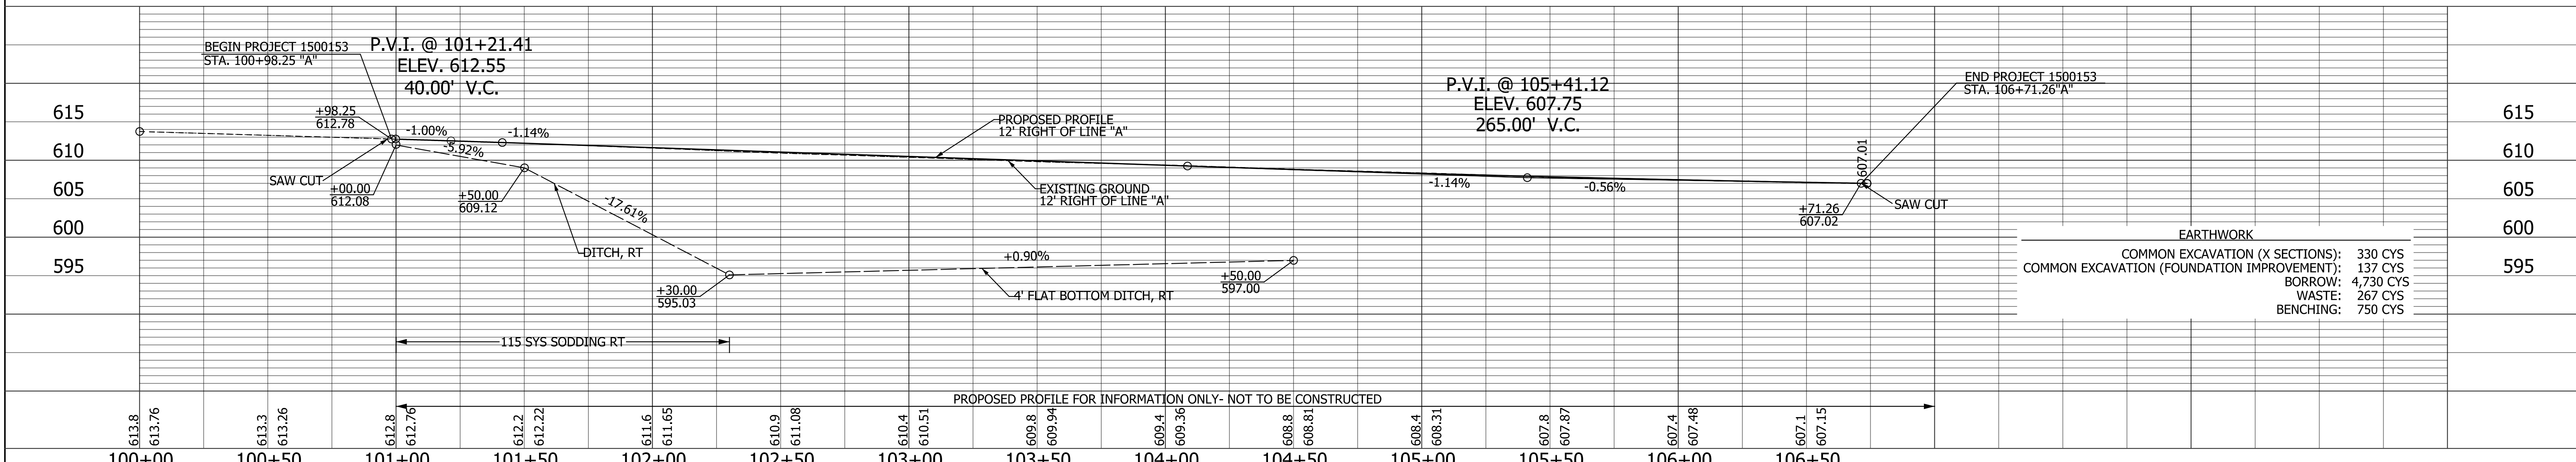DESIGNED: LEJ  
 DRAWN: LEJ  
 CHECKED: JMM  
 CHECKED: JMM

INDIANA  
 DEPARTMENT OF TRANSPORTATION


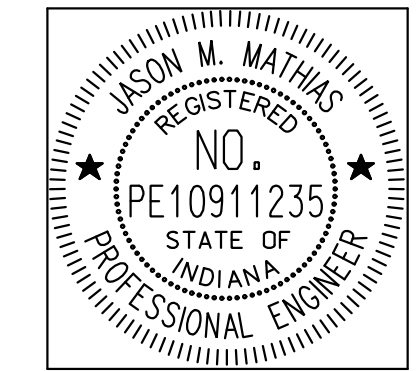
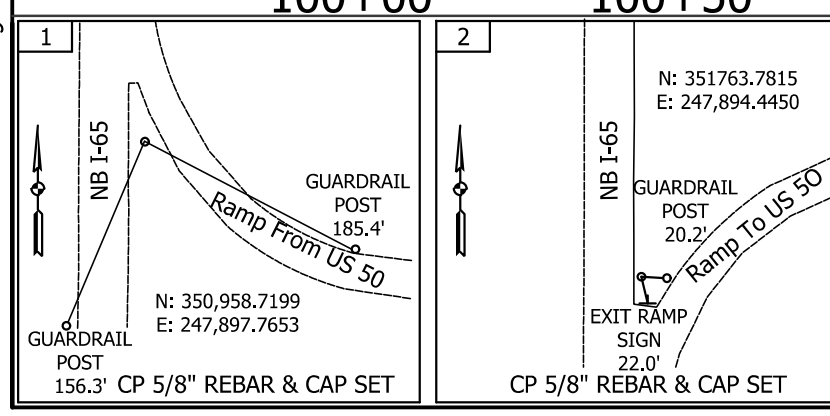
PLAN & PROFILE

HORIZONTAL SCALE 1"=30'	BRIDGE FILE N/A
VERTICAL SCALE 1"=10'	DESIGNATION 1500153
SURVEY BOOK R-37820	DWG. NO. PP-01
	SHEET NO. 5 of 18
	PROJECT 1500153



SEDIMENT TRAP	
DRAINAGE AREA	2.43 AC
STORAGE REQ'D	158 CYS
STORAGE PROVIDED	159 CYS
SPILLWAY HEIGHT	2 FT
SPILLWAY WIDTH	4 FT

- LEGEND:**
- PERIMETER PROTECTION, FILTER SOCK
  - CONSTRUCTION FENCE
  - MCDRR MODIFIED TEMPORARY CHECK DAM, REVETMENT RIPRAP
  - SEDIMENT TRAP

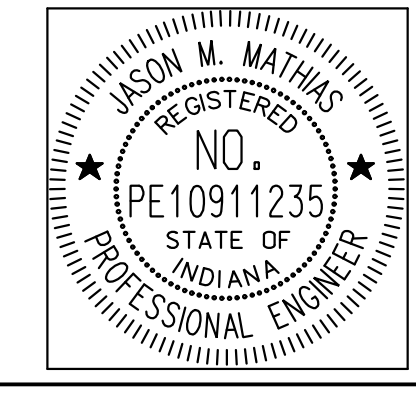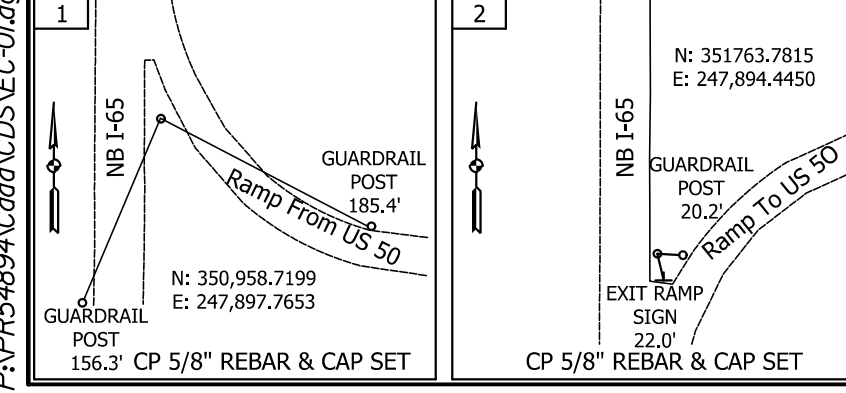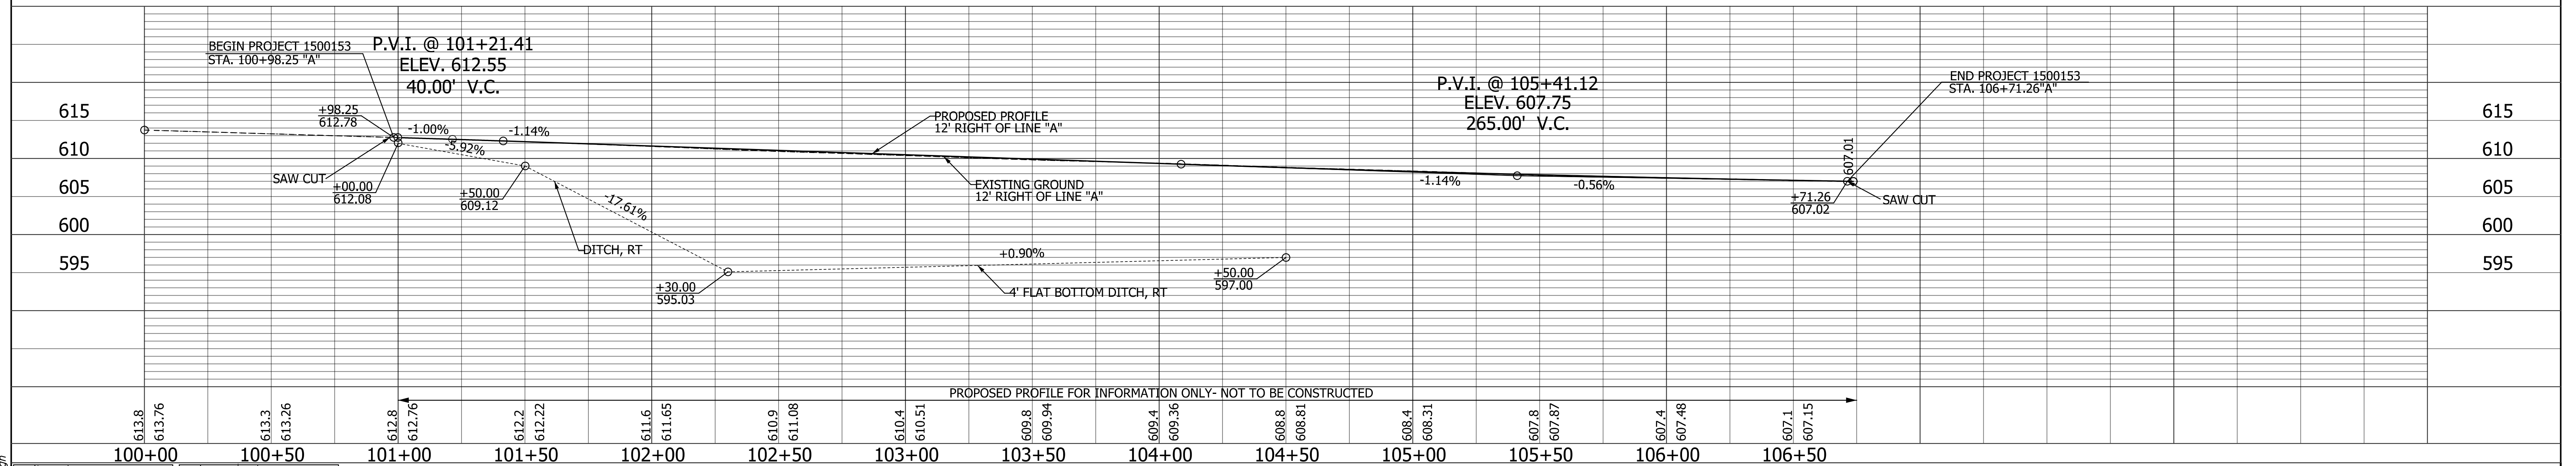



RECOMMENDED FOR APPROVAL	<i>Jason Mathias</i>	DESIGN ENGINEER	DATE
DESIGNED:	LEJ	DRAWN:	LEJ
CHECKED:	JMM	CHECKED:	JMM

**INDIANA**  
DEPARTMENT OF TRANSPORTATION

**EROSION CONTROL DETAILS**


HORIZONTAL SCALE	BRIDGE FILE	
1"=30'	N/A	
VERTICAL SCALE	DESIGNATION	
1"=10'	1500153	
SURVEY BOOK	DWG. NO.	SHEET NO.
	EC-01	6 of 18
CONTRACT	PROJECT	
R-37820	1500153	

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**LEGEND**

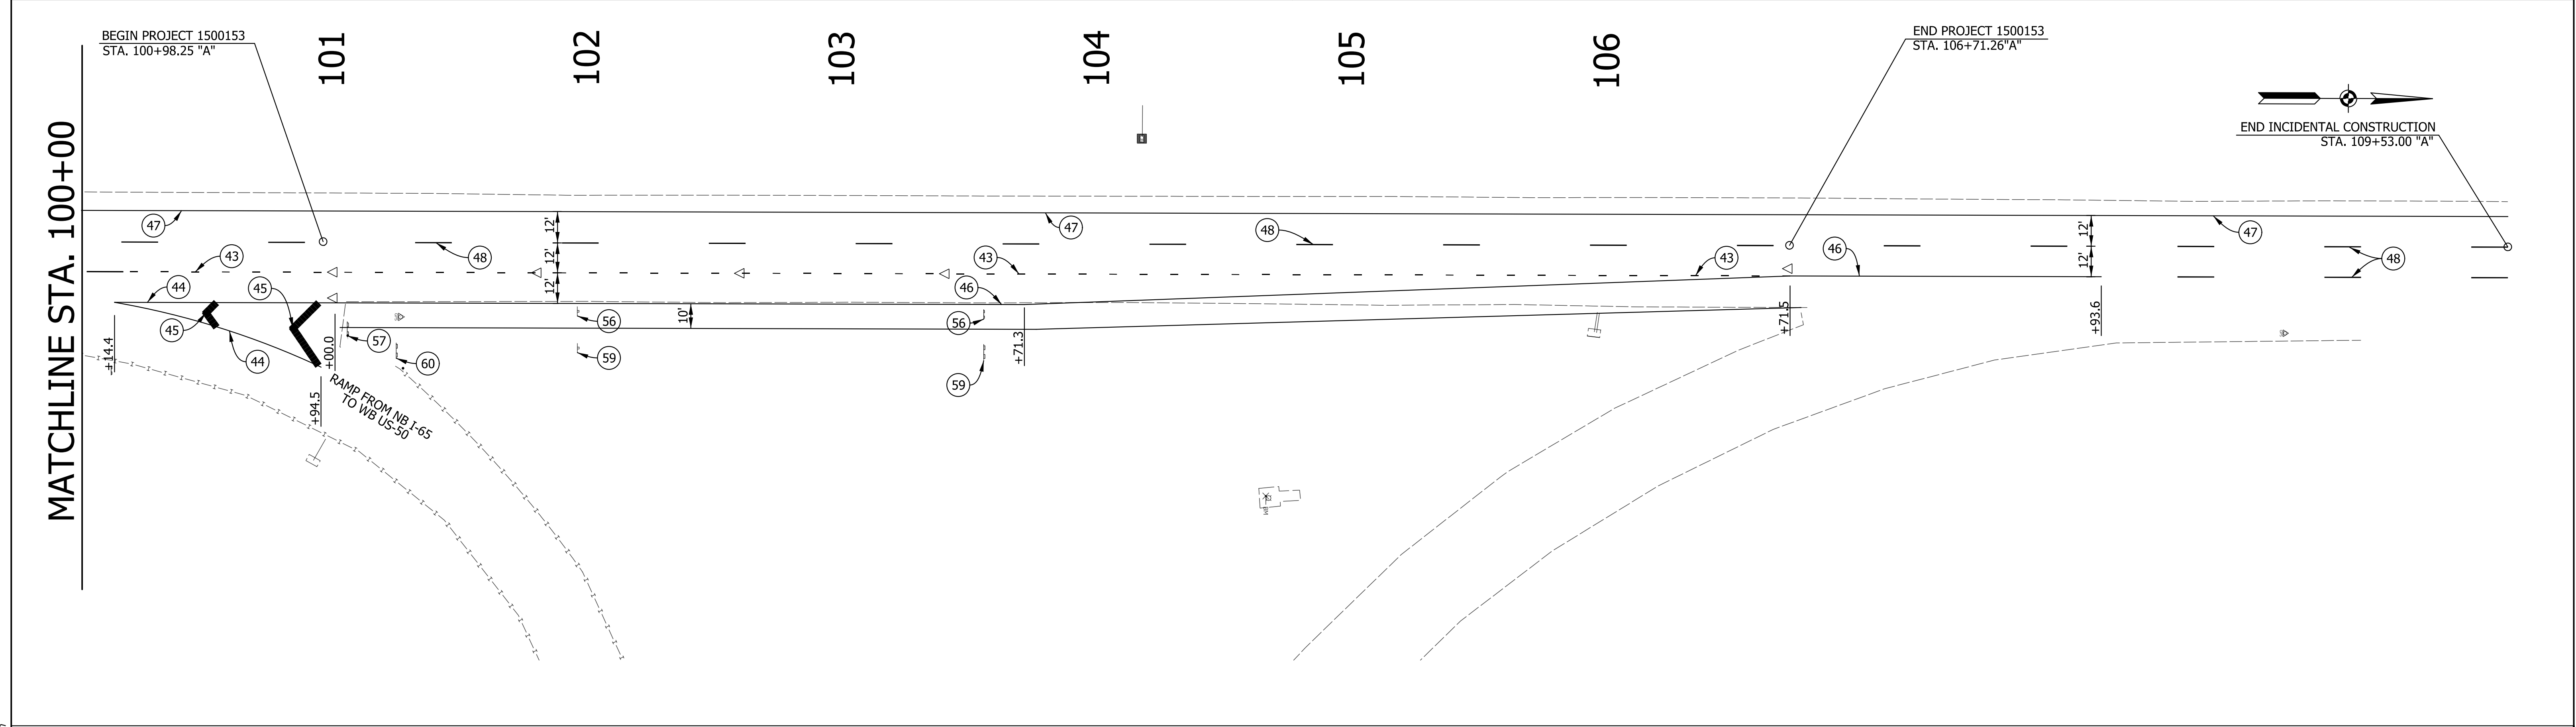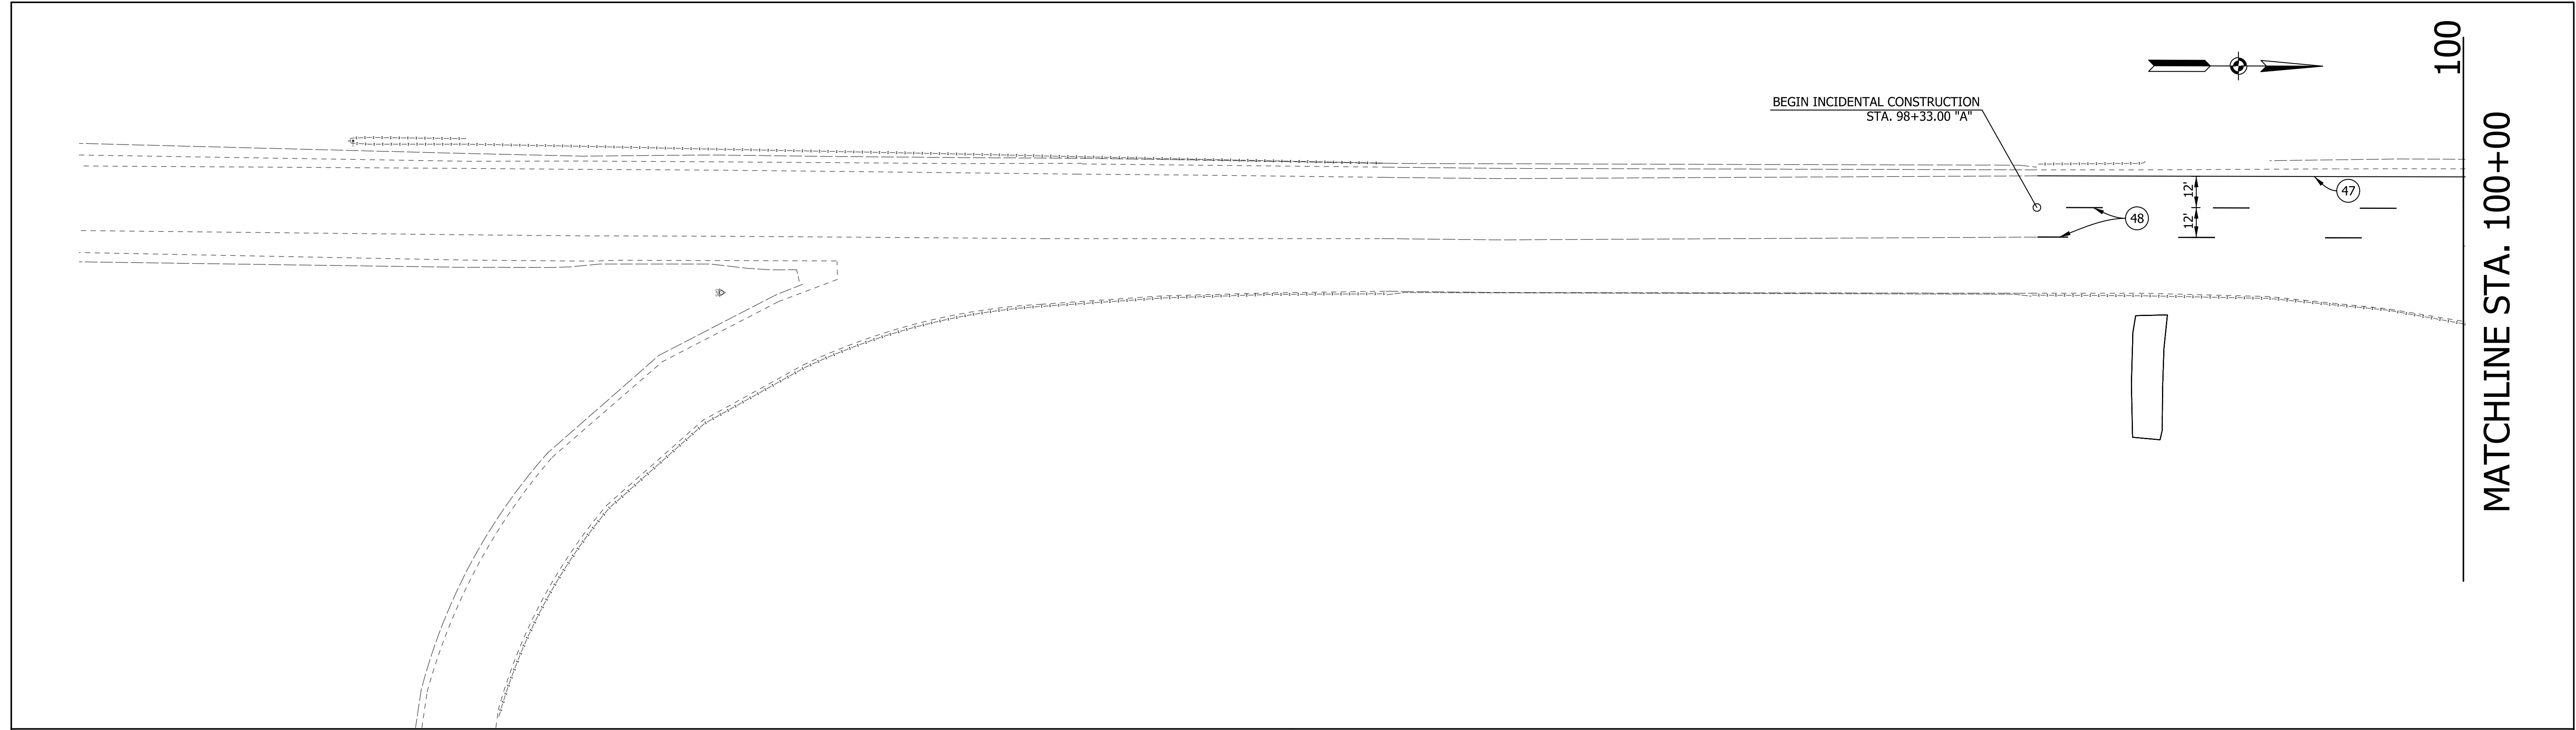- ① NO CHANGE REQUIRED TO EXISTING SIGNS AND SUPPORTS
- ⑩ EXISTING SHEET SIGN ON NEW SUPPORTS
- ④③ 4 IN., DOTTED WHITE, MULTI-COMPONENT 3' LINE, 9' SKIP
- ④④ 8 IN., SOLID, WHITE, MULTI-COMPONENT LINE
- ④⑤ 24 IN., WHITE TRANSVERSE LINE, THERMOPLASTIC
- ④⑥ 4 IN., SOLID, WHITE, MULTI-COMPONENT LINE
- ④⑦ 4 IN., SOLID, YELLOW, MULTI-COMPONENT LINE
- ④⑧ 5 IN., BROKEN WHITE, MULTI-COMPONENT LINE
- ⑤⑥ REMOVE EXISTING SHEET SIGN AND SUPPORTS
- ⑤⑦ REMOVE EXISTING GROUND MOUNTED PANEL SIGN, SUPPORTS AND FOUNDATIONS
- ⑤⑨ EXISTING SHEET SIGN ON NEW SUPPORTS
- ⑥⑩ EXISTING PANEL SIGN ON NEW SUPPORTS
- ◁ ONE-WAY WHITE RAISED PAVEMENT MARKER



RECOMMENDED FOR APPROVAL	<i>Jason Mathias</i>	DESIGN ENGINEER	10/25/2019	DATE
DESIGNED:	LEJ	DRAWN:	LEJ	
CHECKED:	JMM	CHECKED:	JMM	

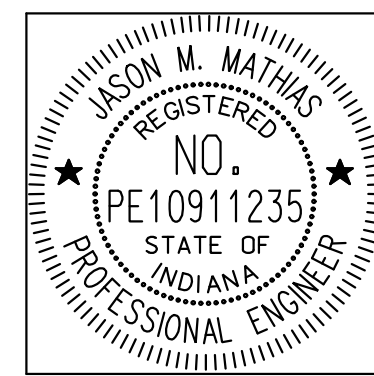INDIANA DEPARTMENT OF TRANSPORTATION	
SIGNING AND PAVEMENT MARKING PLAN	

HORIZONTAL SCALE	BRIDGE FILE	
1"=30'	N/A	
VERTICAL SCALE	DESIGNATION	
N/A	1500153	
SURVEY BOOK	DWG. NO.	SHEET NO.
	PM-01	7 of 18
CONTRACT	PROJECT	
R-37820	1500153	

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UNDERDRAIN TABLE																											
Underdrain Pipe Limits	UNDERDRAIN PIPE											OUTLET PIPE							OUTLET PROTECTORS				Remarks				
	Type 4 Pipe		Geotextile for Underdrains	Aggregate for Underdrains	HMA for Underdrains	Special Grade	Flow Line Elevation @ Underdrain Pipe Limit	Outlet Pipe Required	Connect Underdrain Pipe to Structure No.	Structure Invert Elevation	45 Degree Elbows Required (1 or 2)	6" Outlet Pipe	Outlet Station	Outlet Elevation	Outlet at Outlet Protector No.	Ditch Flow Line Elevation at Outlet Protector	Connect Outlet Pipe to Structure No.	Structure Invert Elevation	Structure Backfill	HMA for Underdrains	Outlet Protector No.	Outlet Protector Type 1 (EACH)		Location			
	4" LFT	6" LFT																						SYS	CYS	TONS	%
I-65 Line "A" Right of CL, Outside																											
100+98		302	198	25		608.85	N																				
104+00						605.49	Y			2	25	104+00	604.17								1.54	OL-01	1				X
104+00						605.49	N																				X
105+50		150	99	13		604.01	Y			2	25	105+50	602.73									OL-02	1				X
105+50						602.92	Y			2	25	105+50	602.73								3.28	OL-02					X
106+71		121	90	12	0.21%	603.25	N																				
<b>TOTAL</b>		<b>573</b>	<b>387</b>	<b>50</b>						<b>6</b>	<b>75</b>										<b>5</b>		<b>2</b>				


TEMPORARY EROSION CONTROL TABLE												
STATION	LOCATION			PERIMETER PROTECTION, FILTER SOCK	INLET PROTECTION	DITCH INLET PROTECTION	SEDIMENT TRAP	RIPRAP SPLASHPAD	CONSTRUCTION FENCE	TEMPORARY CHECK DAM, REVETMENT RIPRAP	MODIFIED TEMPORARY CHECK DAM, REVETMENT RIPRAP	FISH POOL
	LEFT	MEDIAN	RIGHT									
102+49 TO 105+34 "A"			X	285								
103+52 to 104+33 "A"			X					240				
102+41 "A"			X								6	
102+55 "A"			X				40					
104+43 "A"			X								6	
105+33 "A"			X								6	
SUB-TOTAL				285	0	0	40	0	240	0	18	0
<b>TOTAL</b>				<b>285</b>	<b>0</b>	<b>0</b>	<b>40</b>	<b>0</b>	<b>240</b>	<b>0</b>	<b>18</b>	<b>0</b>

SEEDING QUANTITIES			
Line "A"			
STATION	Length	Area	Mulched Seeding U
	LFT	SYS	SYS
100+98	573.0	5061.2	5061.2
106+71			
<b>TOTAL</b>			5062.0

Geotech Foundation Improvement Line "A"									
Station	Length (LFT)	Width (LFT)	Area (SFT)	Depth (FT)	Common Excavation (CYS)	Settlement Plate (EACH)	Geotextile for Subgrade Type 2A (SYS)	Compacted Aggregat No 5 (CYS)	Compacted Aggregate No 53 (CYS)
101+50		0							
102+00	50	36.69	917.25	2	6.79		10.19	5.10	1.70
102+50	50	56.56	2331.25	2	17.27		25.90	12.95	4.32
103+00	50	56.22	2819.50	2	20.89		31.33	15.66	5.22
103+50	50	51.22	2686.00	2	19.90	1.00	29.84	14.92	4.97
103+71	21	50.1	1077.03	2	7.98		11.97	5.98	1.99
104+00	29	46.69	1390.87	2	10.30		15.45	7.73	2.58
104+50	50	42.01	2217.50	2	16.43		24.64	12.32	4.11
105+00	50	36.67	1967.00	2	14.57		21.86	10.93	3.64
105+50	50	30.45	1678.00	2	12.43		18.64	9.32	3.11
106+00	50	12.29	1068.50	2	7.91		11.87	5.94	1.98
106+50	50	0	307.25	2	2.28		3.41	1.71	0.57
<b>Total</b>			<b>18461.00</b>		<b>137.00</b>	<b>1.00</b>	<b>206.00</b>	<b>103.00</b>	<b>35.00</b>

NOTE: IF YIELDING SUBGRADE CONDITIONS ARE OBSERVED, FOUNDATION SOIL IMPROVEMENT WILL BE NECESSARY. QUANTITIES SHOWN IN TABLE ANTICIPATE 10% OF EMBANKMENT AREA WILL REQUIRE FOUNDATION SOIL IMPROVEMENT.

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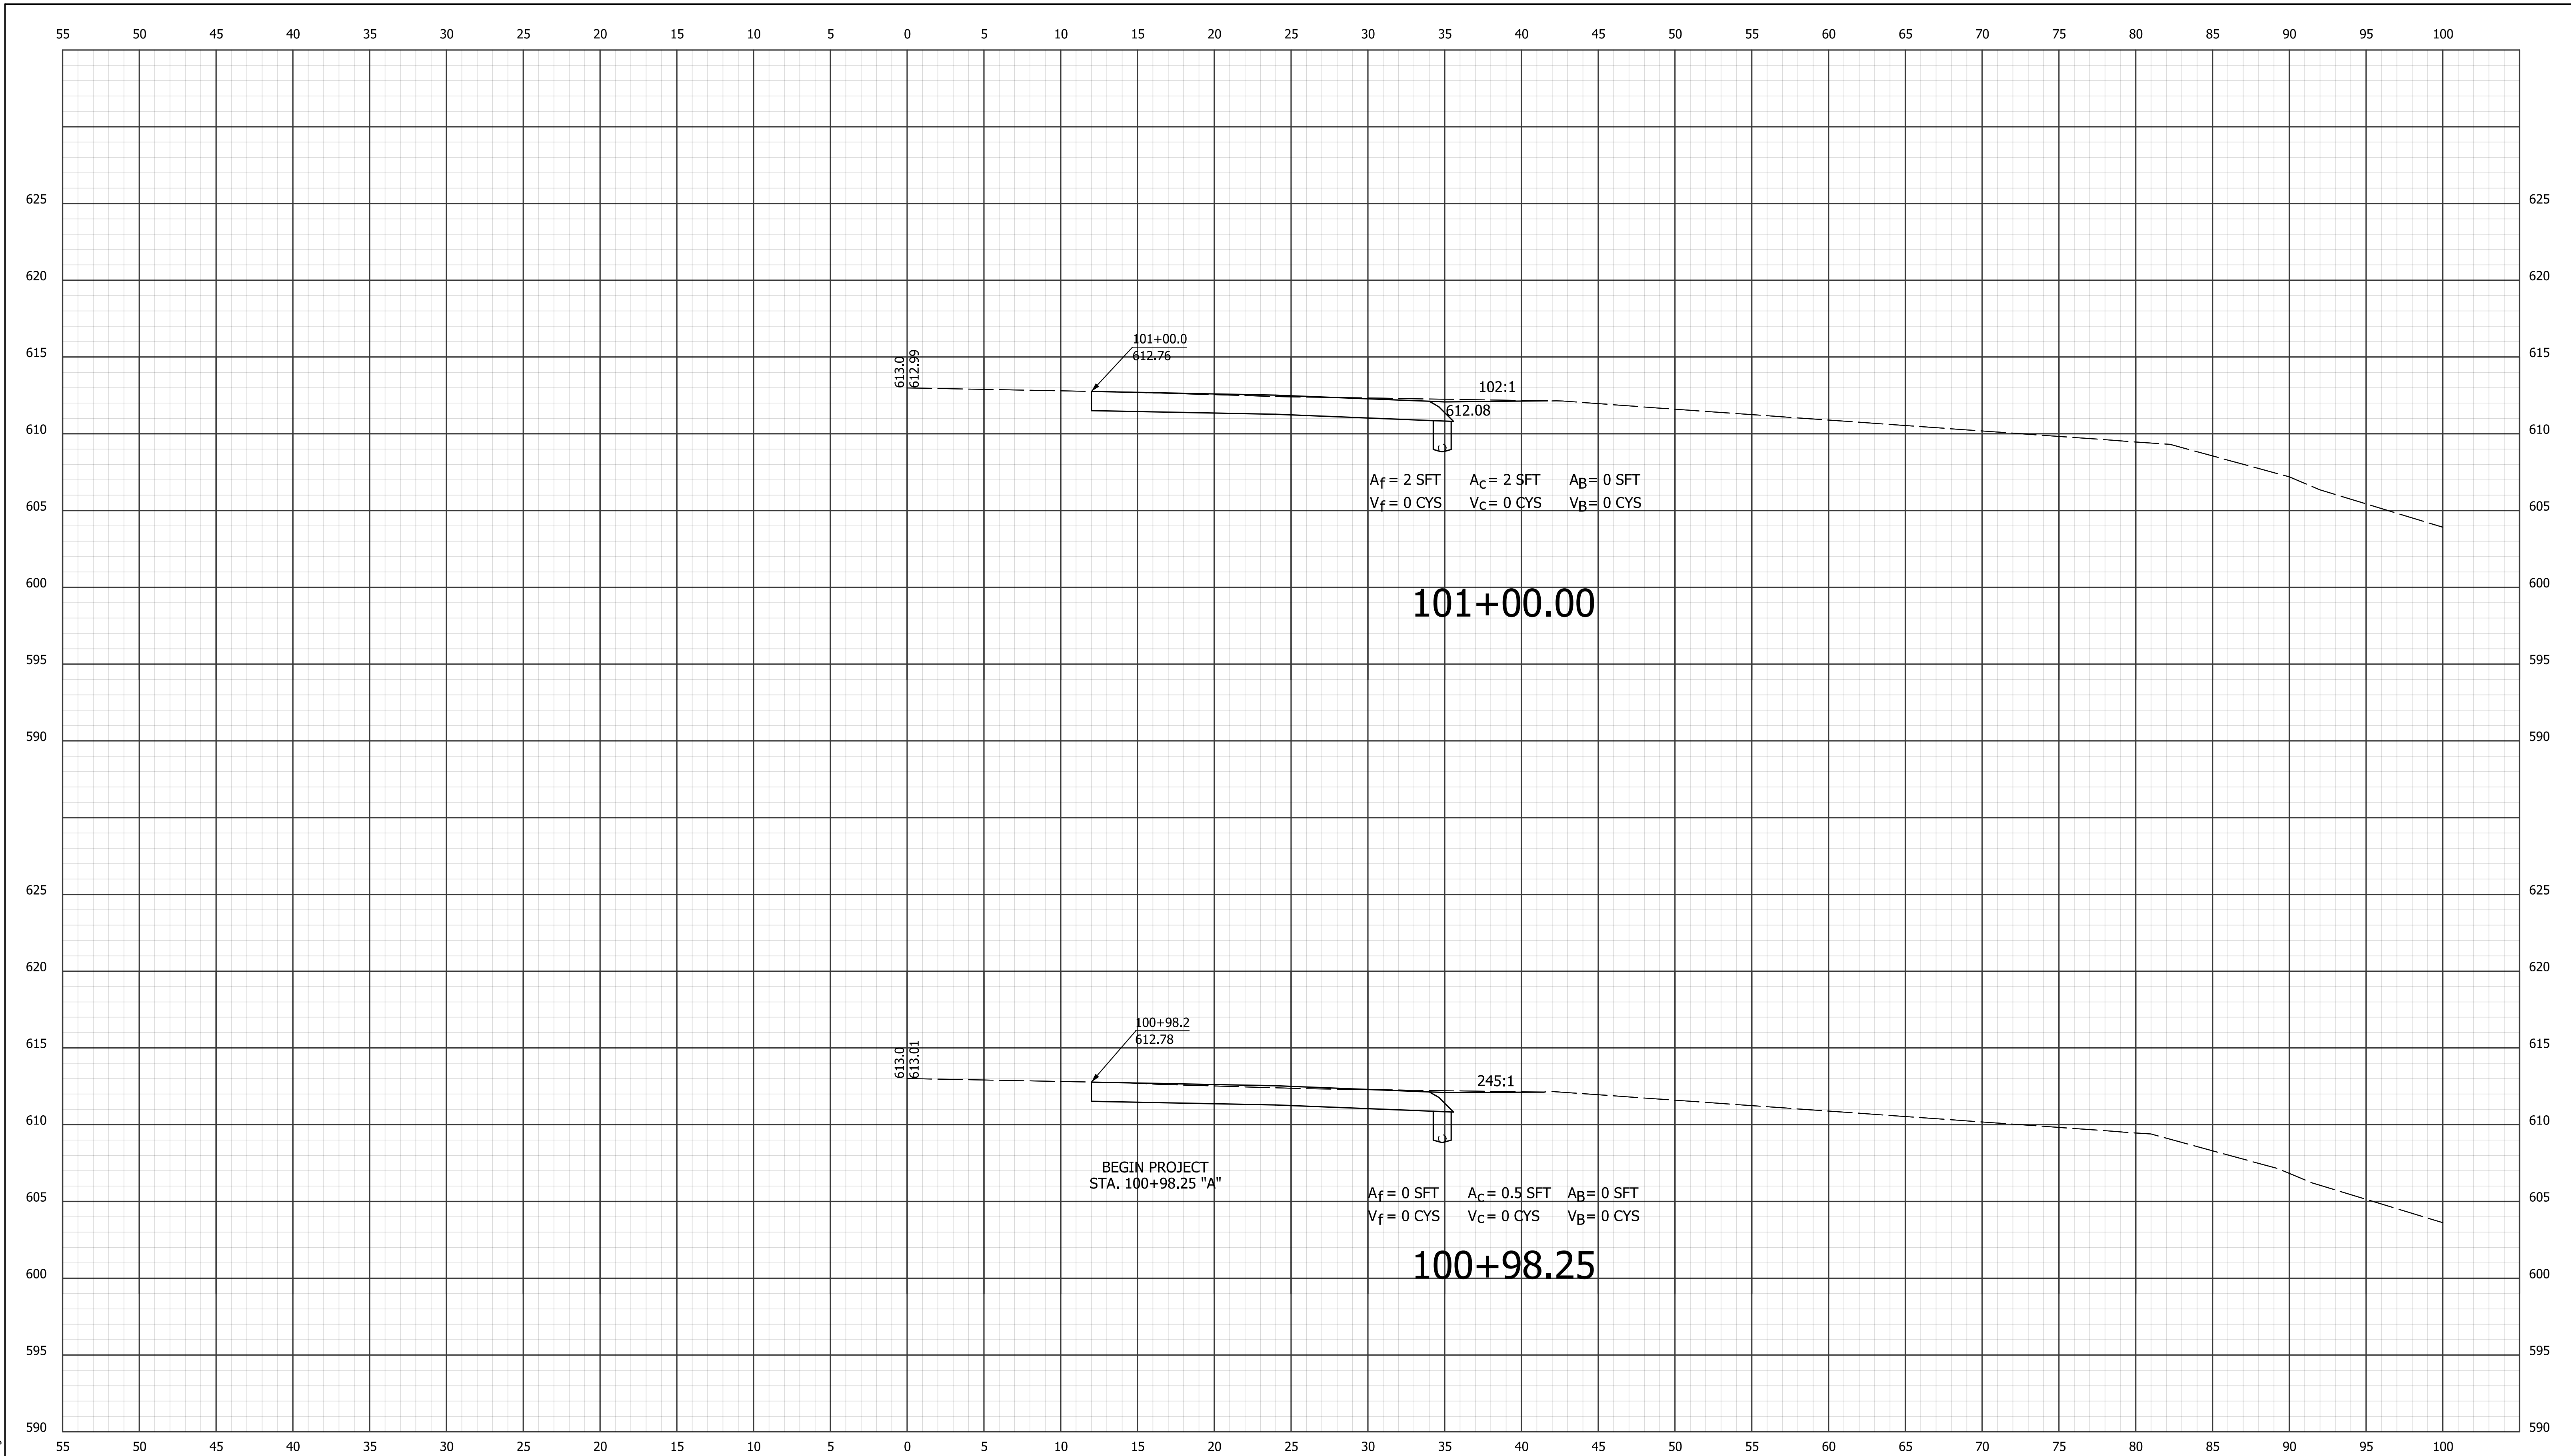


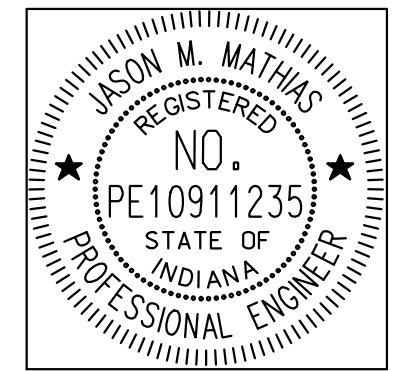RECOMMENDED FOR APPROVAL: *Jason Mathias*  
 DESIGN ENGINEER DATE: 10/25/2019  
 DESIGNED: LEJ DRAWN: LEJ  
 CHECKED: JMM CHECKED: JMM

INDIANA  
 DEPARTMENT OF TRANSPORTATION  
 MISCELLANEOUS TABLES

HORIZONTAL SCALE	BRIDGE FILE
N/A	N/A
VERTICAL SCALE	DESIGNATION
N/A	1500153
SURVEY BOOK	DWG. NO. SHEET NO.
	MS-01 9 of 18
CONTRACT	PROJECT
R-37820	1500153






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RECOMMENDED FOR APPROVAL _____		DESIGN ENGINEER _____		DATE _____	
DESIGNED: LEJ	DRAWN: LEJ				
CHECKED: JMM	CHECKED: JMM				

**INDIANA**  
**DEPARTMENT OF TRANSPORTATION**

**CROSS SECTIONS**  
**LINE "A"**  
**STA. 100+98.25 TO 101+00.00**

HORIZONTAL SCALE 1" = 5'		BRIDGE FILE N/A	
VERTICAL SCALE 1" = 5'		DESIGNATION 1500153	
SURVEY BOOK R-37820	DWG. NO. XS-1	SHEET NO. 11 of 18	
CONTRACT R-37820		PROJECT 1500153	

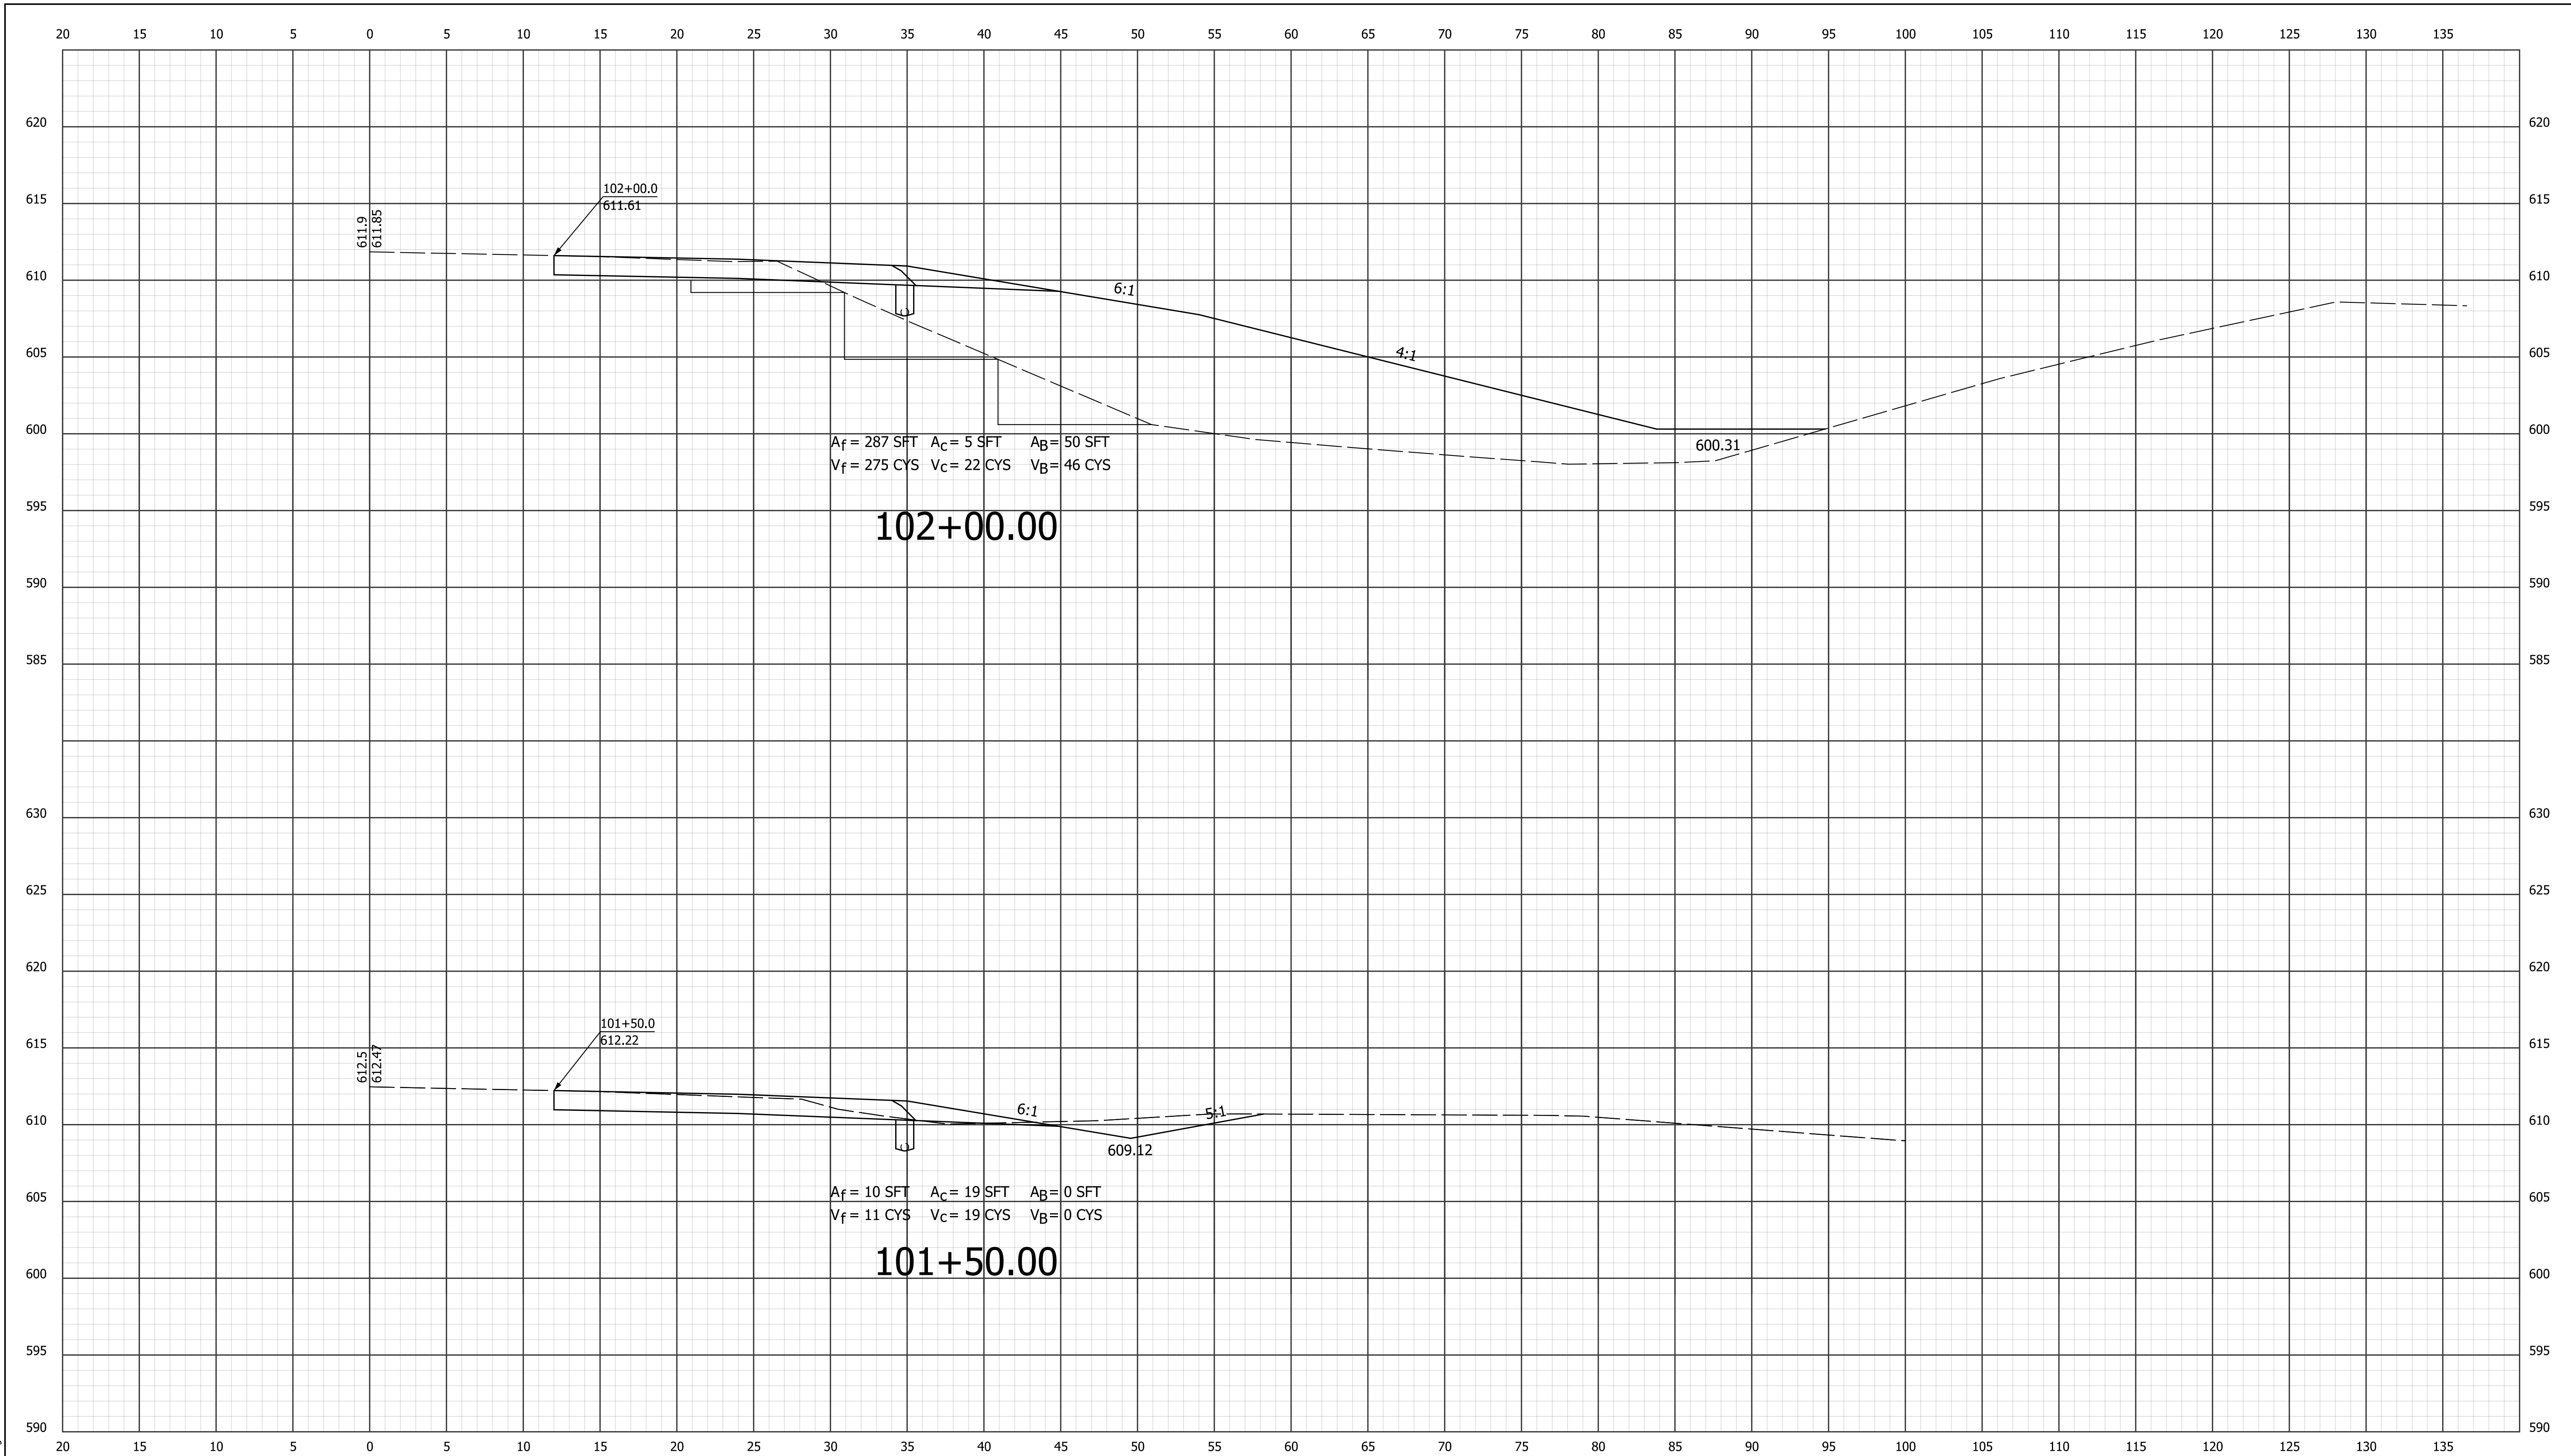


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RECOMMENDED FOR APPROVAL _____	
DESIGNED: LEJ	DRAWN: LEJ
CHECKED: JMM	CHECKED: JMM

**INDIANA**  
**DEPARTMENT OF TRANSPORTATION**

**CROSS SECTIONS**  
**LINE "A"**  
**STA. 101+50.00 TO 102+00.00**

HORIZONTAL SCALE	BRIDGE FILE	
1" = 5'	N/A	
VERTICAL SCALE	DESIGNATION	
1" = 5'	1500153	
SURVEY BOOK	DWG. NO.	SHEET NO.
	XS-2	12 of 18
CONTRACT	PROJECT	
R-37820	1500153	

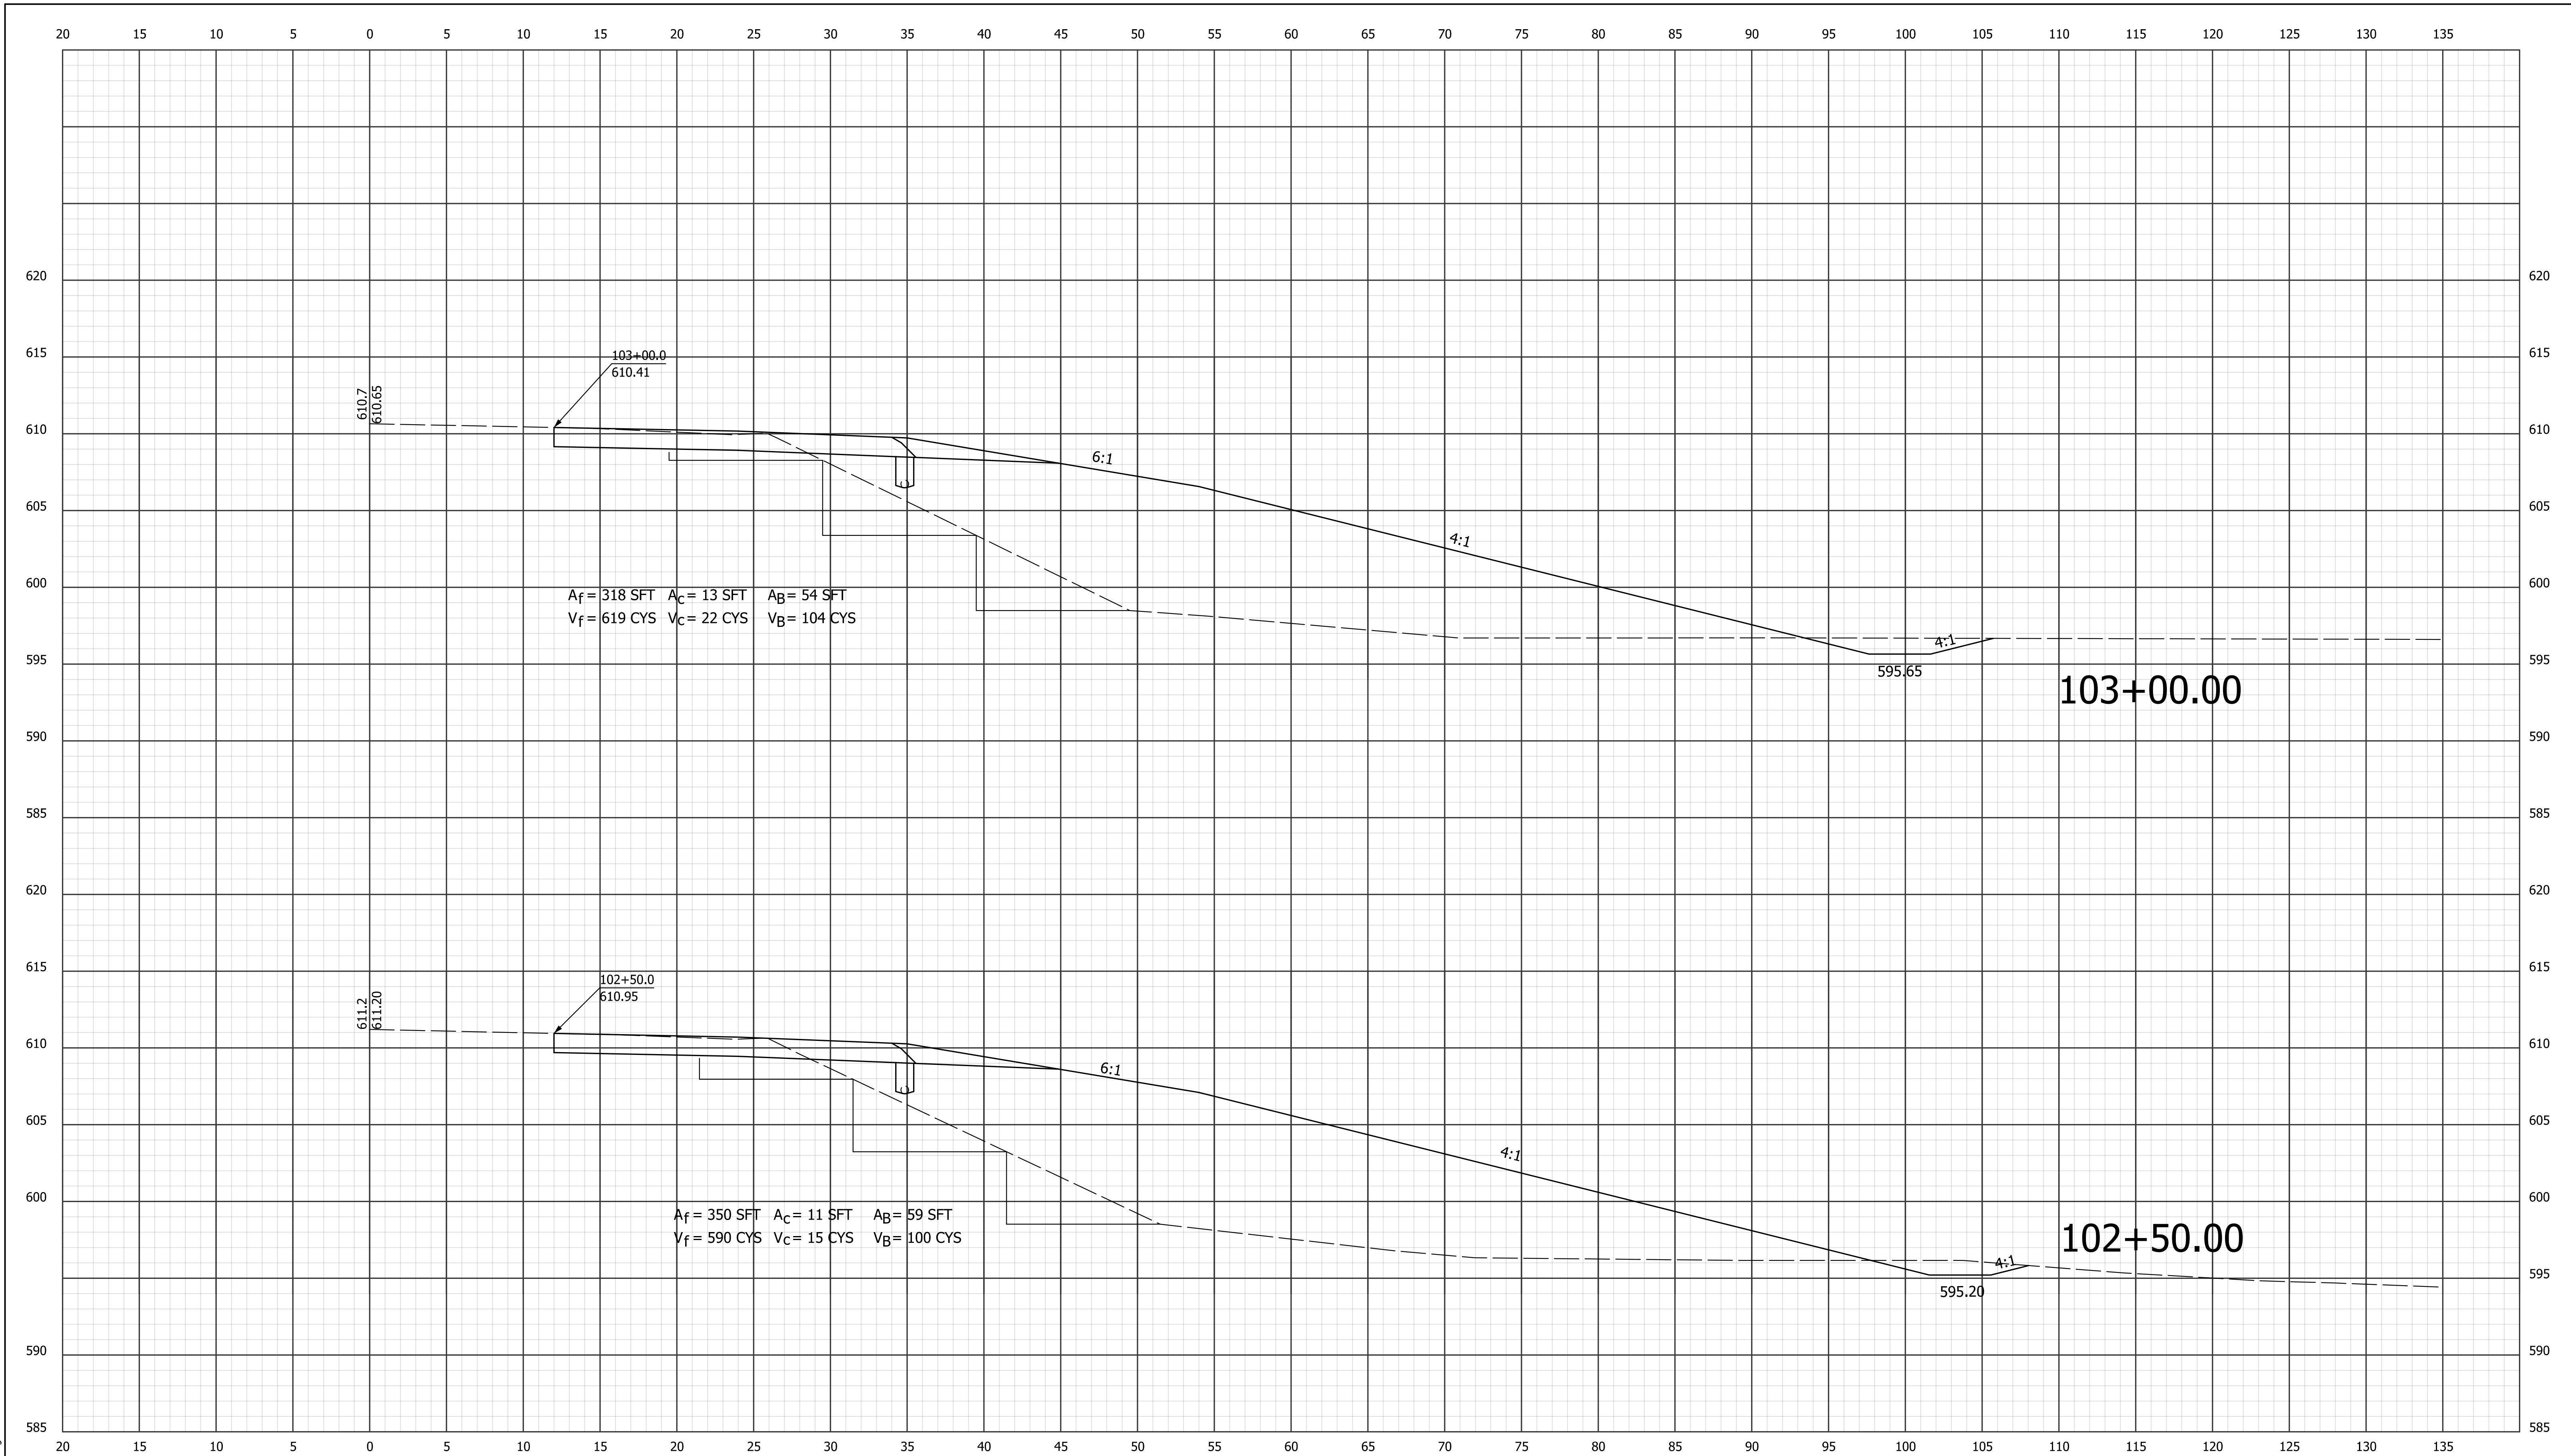


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RECOMMENDED FOR APPROVAL _____	
DESIGNED: LEJ	DRAWN: LEJ
CHECKED: JMM	CHECKED: JMM

**INDIANA**  
**DEPARTMENT OF TRANSPORTATION**

**CROSS SECTIONS**  
**LINE "A"**  
**STA. 102+50.00 TO 103+00.00**

HORIZONTAL SCALE 1" = 5'	BRIDGE FILE N/A	
VERTICAL SCALE 1" = 5'	DESIGNATION 1500153	
SURVEY BOOK	DWG. NO. XS-3	SHEET NO. 13 of 18
CONTRACT R-37820	PROJECT 1500153	

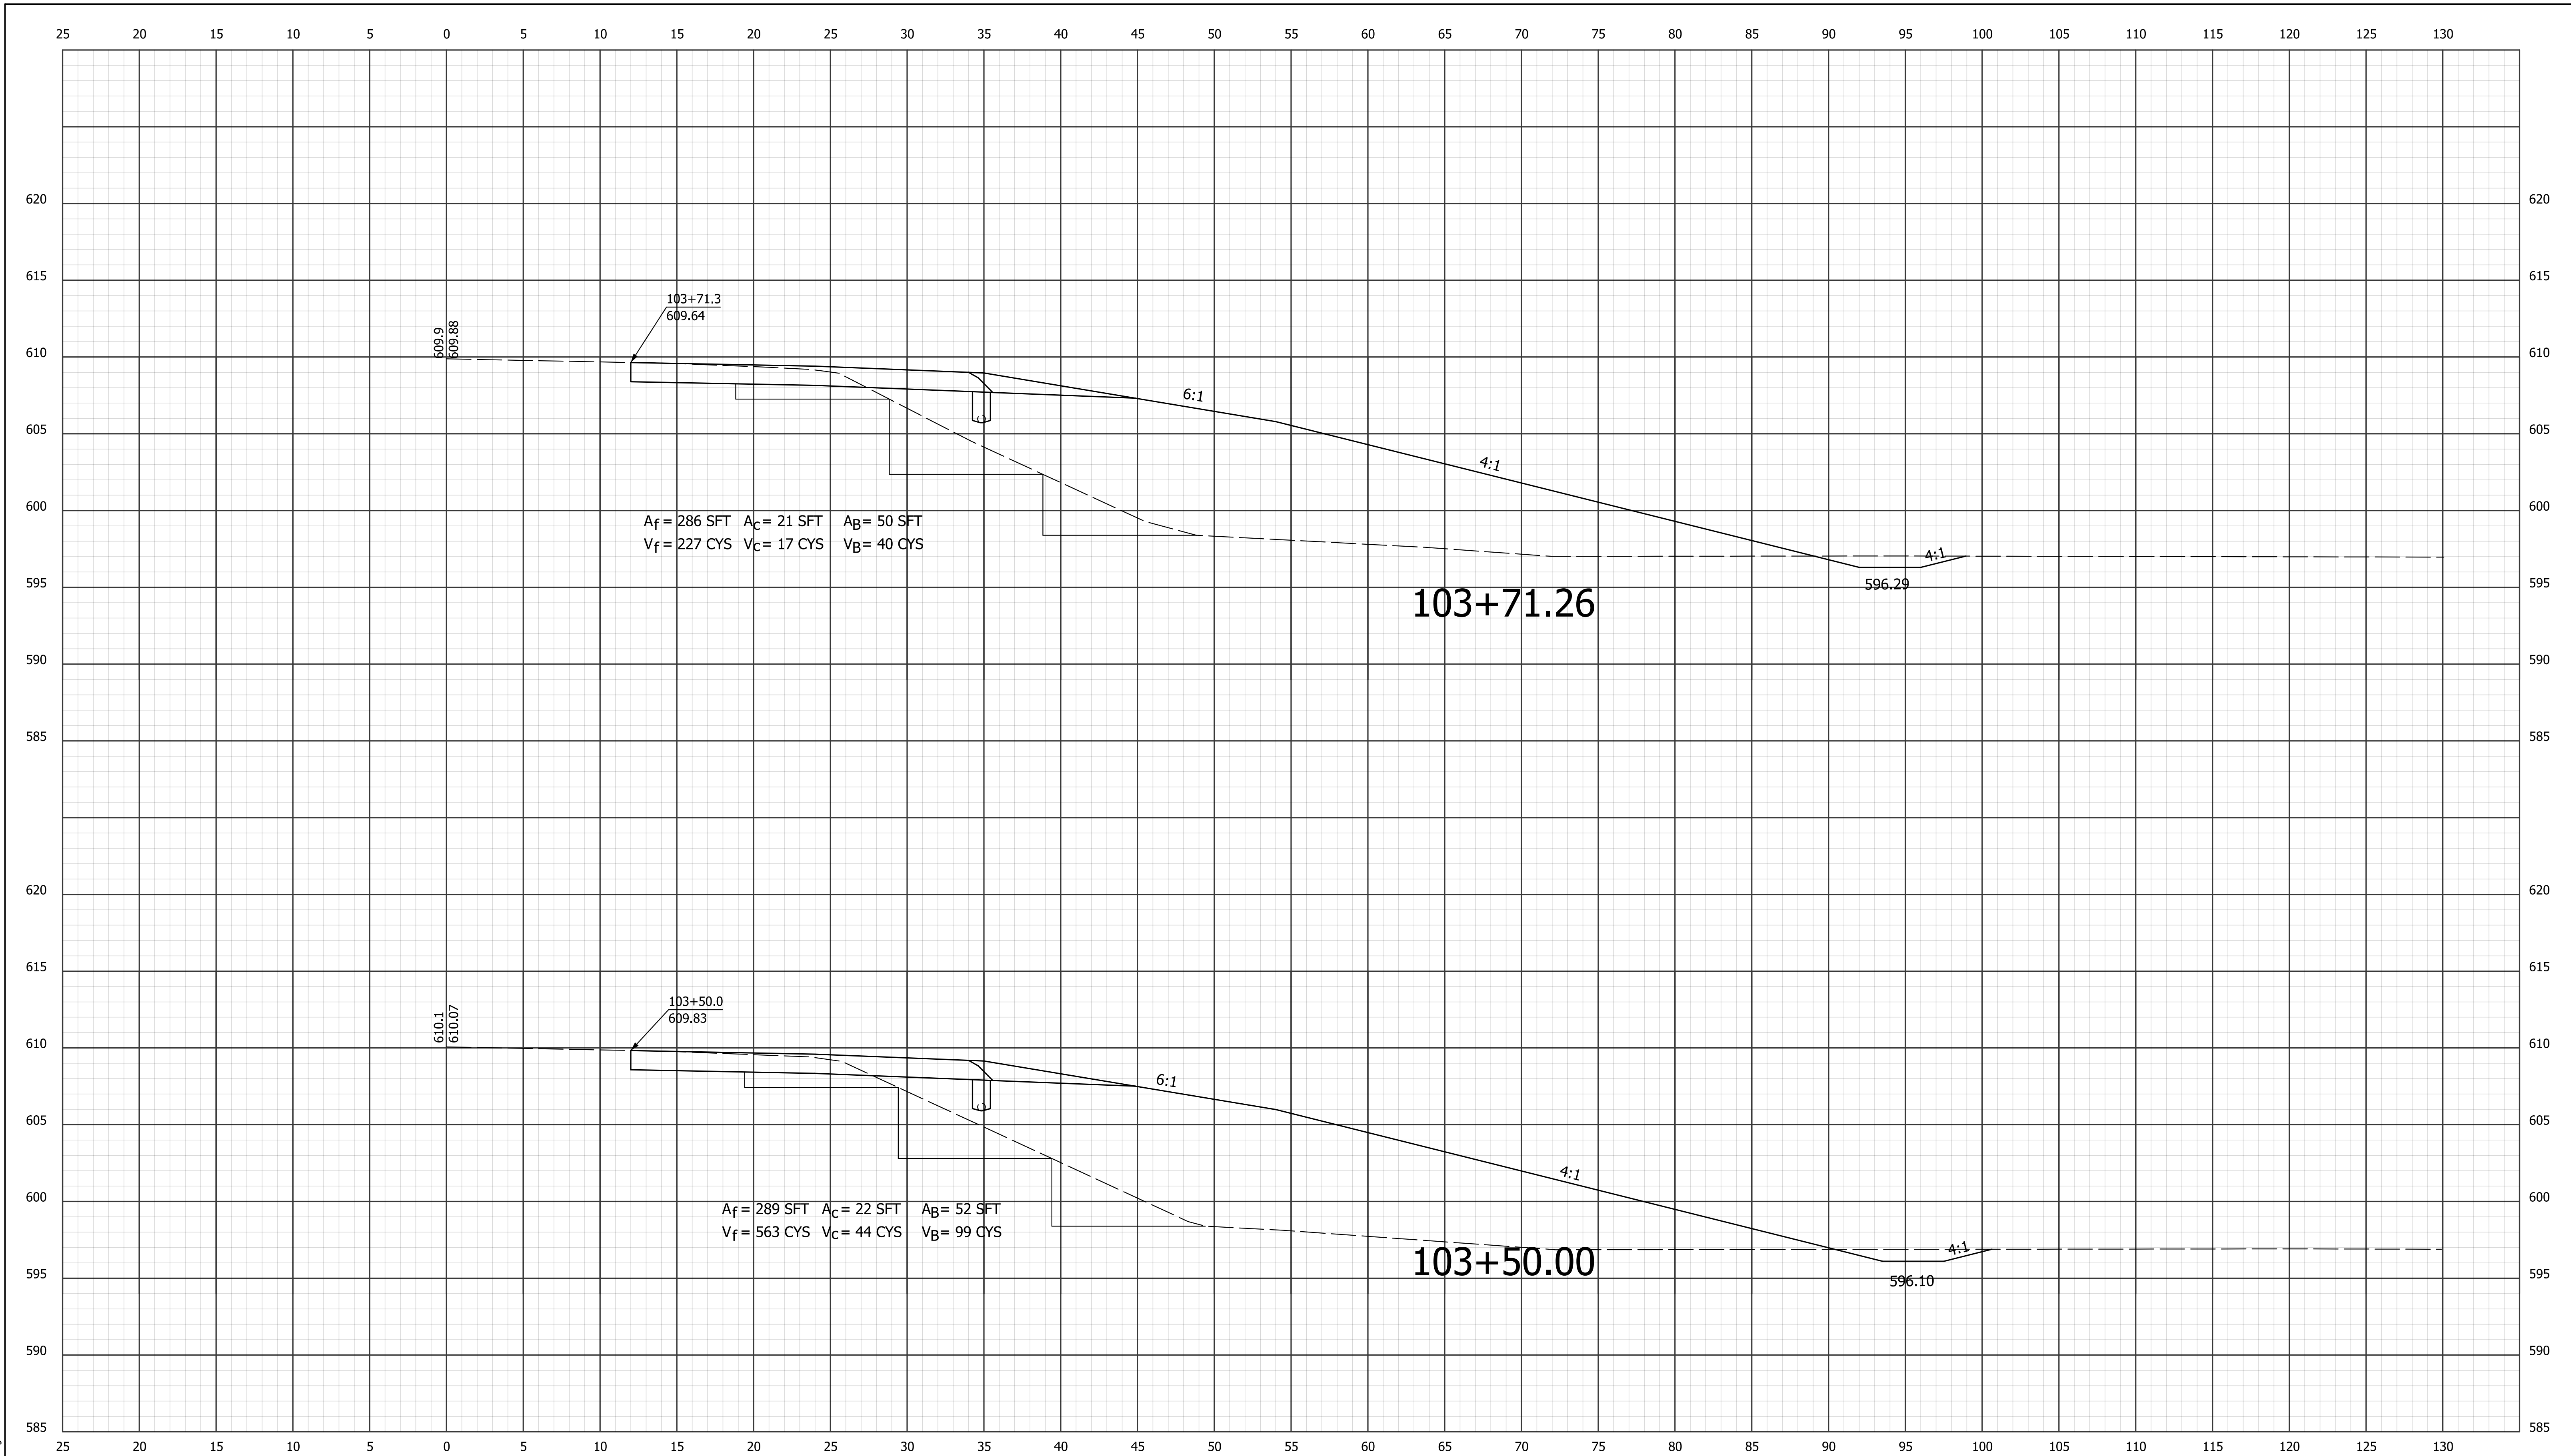


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RECOMMENDED FOR APPROVAL _____		DESIGN ENGINEER _____		DATE _____	
DESIGNED: LEJ	DRAWN: LEJ				
CHECKED: JMM	CHECKED: JMM				

**INDIANA**  
**DEPARTMENT OF TRANSPORTATION**

**CROSS SECTIONS**  
**LINE "A"**  
**STA. 103+50.00 TO 103+71.26**

HORIZONTAL SCALE		BRIDGE FILE	
1" = 5'		N/A	
VERTICAL SCALE		DESIGNATION	
1" = 5'		1500153	
SURVEY BOOK	DWG. NO.	SHEET NO.	
	XS-4	14 of 18	
CONTRACT	PROJECT		
R-37820	1500153		

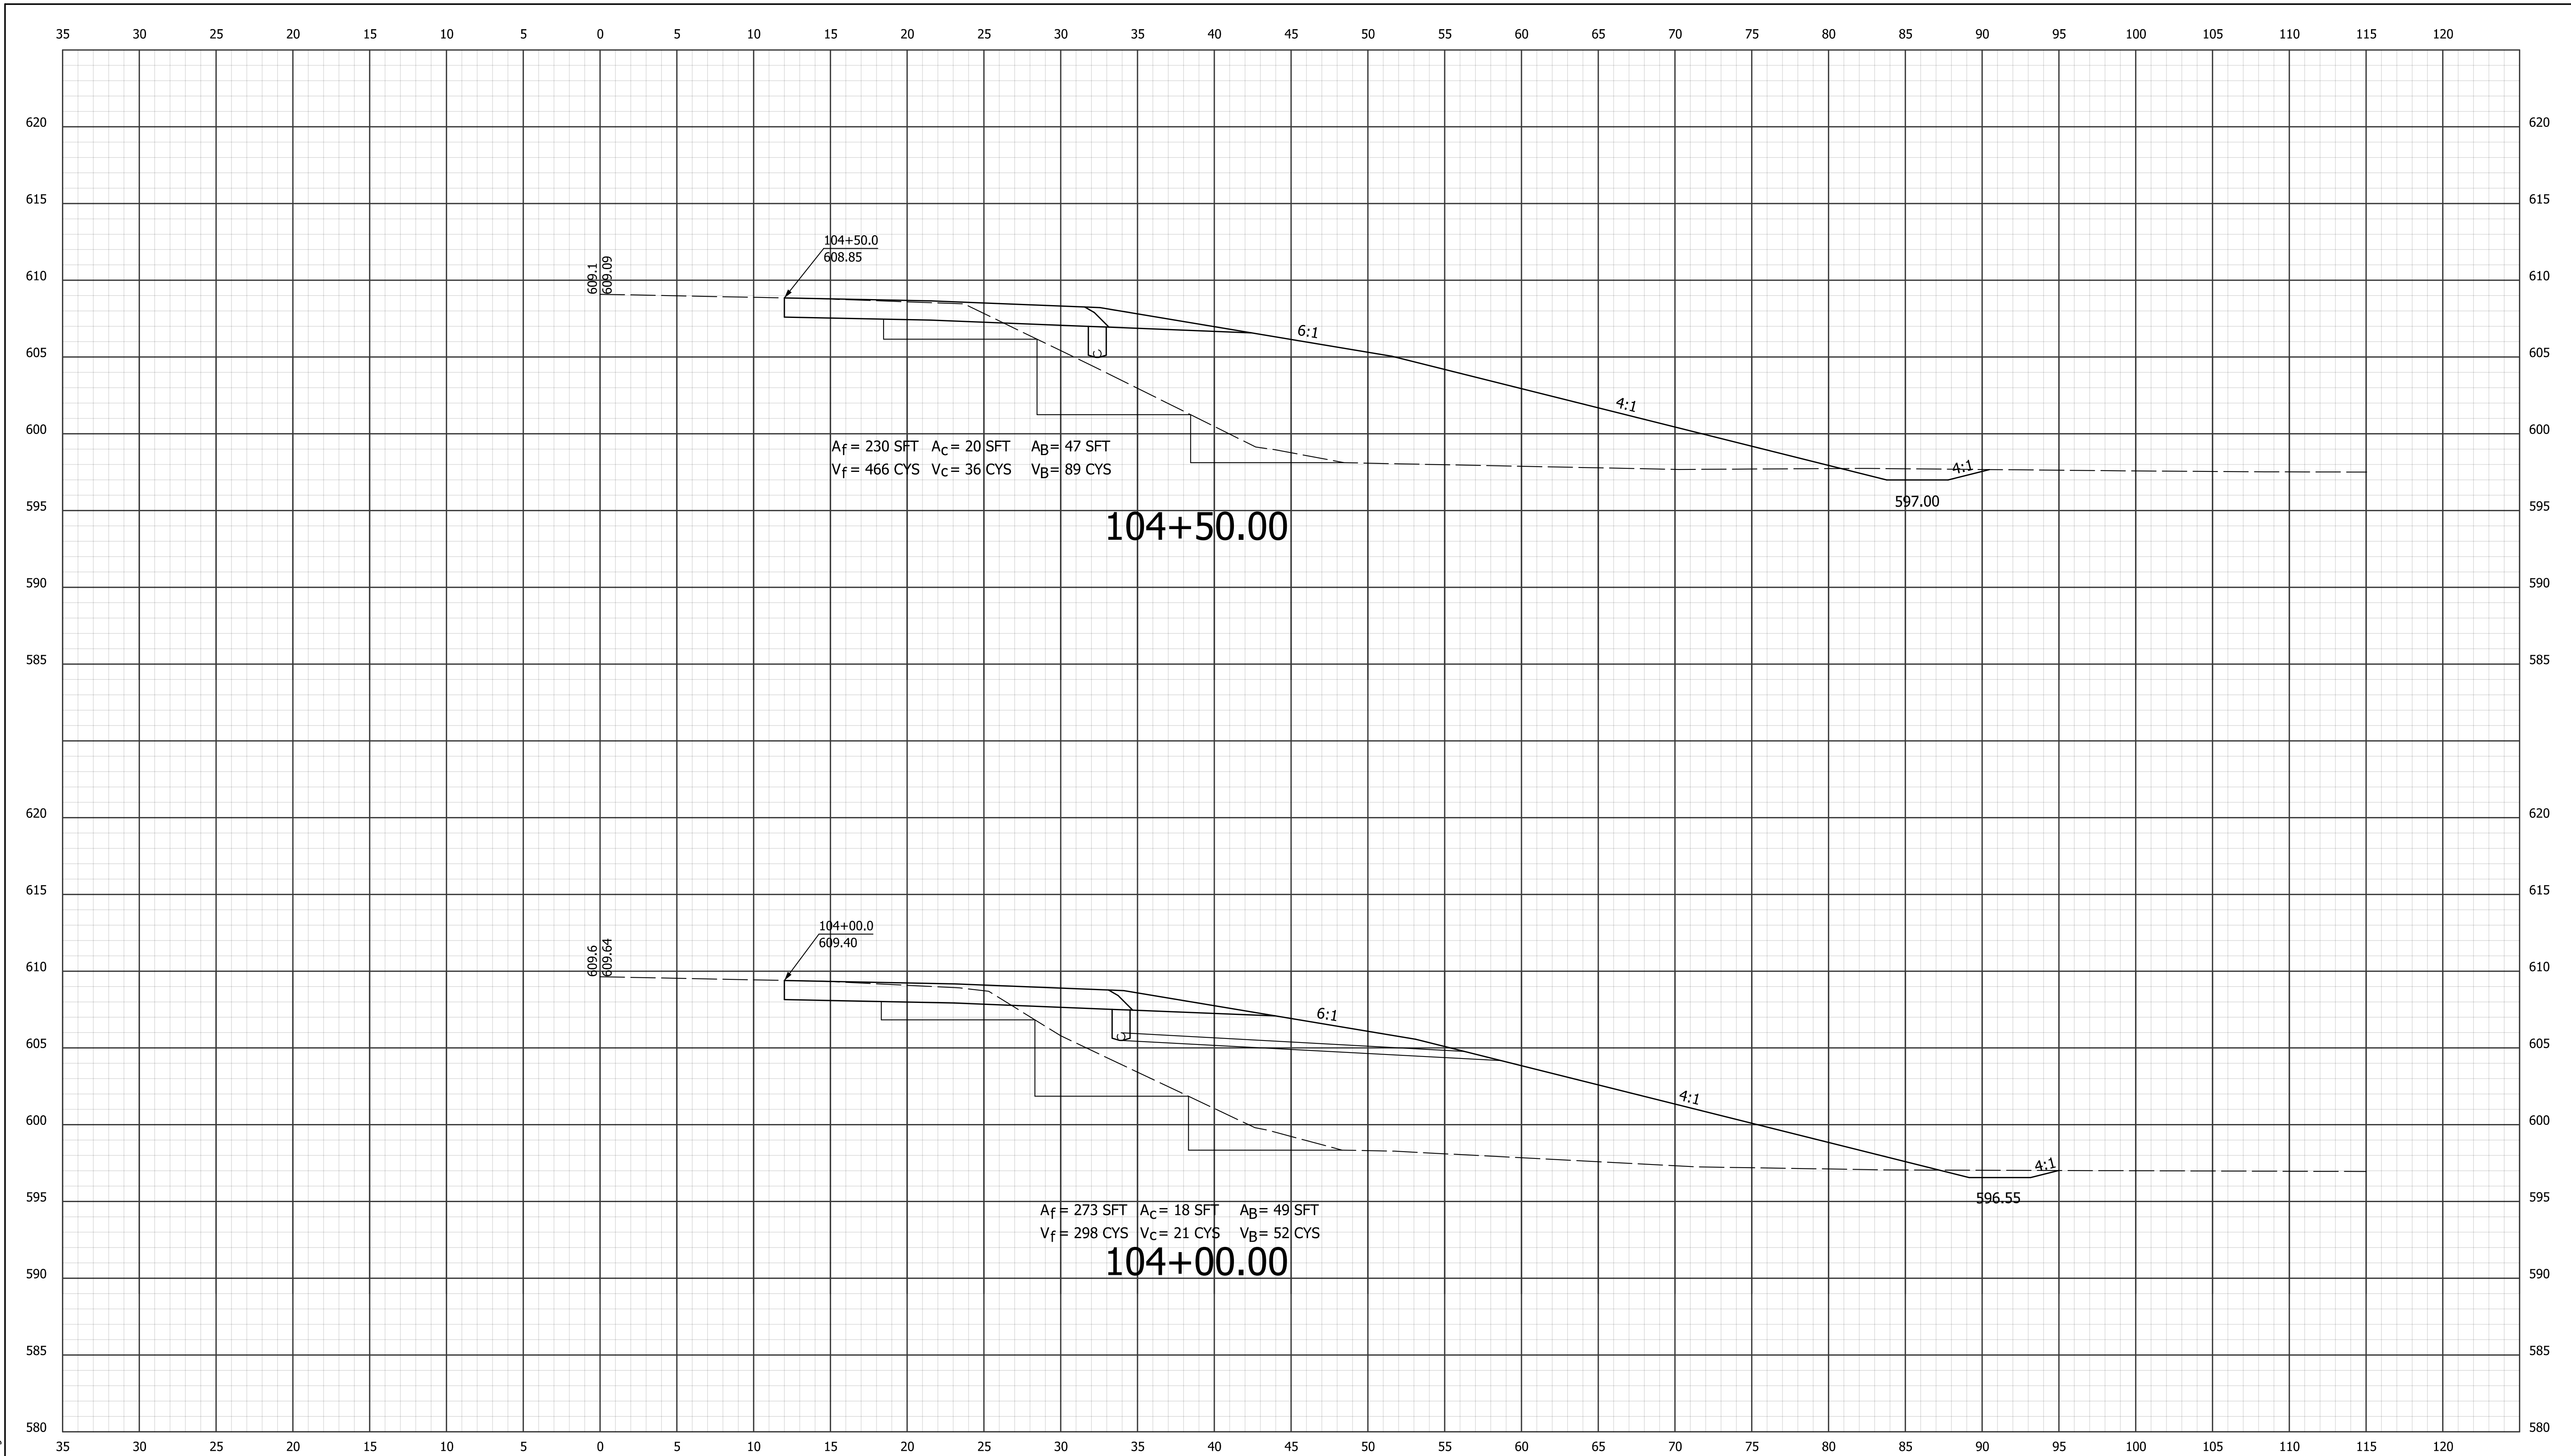


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RECOMMENDED FOR APPROVAL _____	
DESIGNED: LEJ	DRAWN: LEJ
CHECKED: JMM	CHECKED: JMM

**INDIANA**  
**DEPARTMENT OF TRANSPORTATION**  
**CROSS SECTIONS**  
**LINE "A"**  
**STA. 104+00.00 TO 104+50.00**

HORIZONTAL SCALE 1" = 5'	BRIDGE FILE N/A	
VERTICAL SCALE 1" = 5'	DESIGNATION 1500153	
SURVEY BOOK	DWG. NO. XS-5	SHEET NO. 15 of 18
CONTRACT R-37820	PROJECT 1500153	

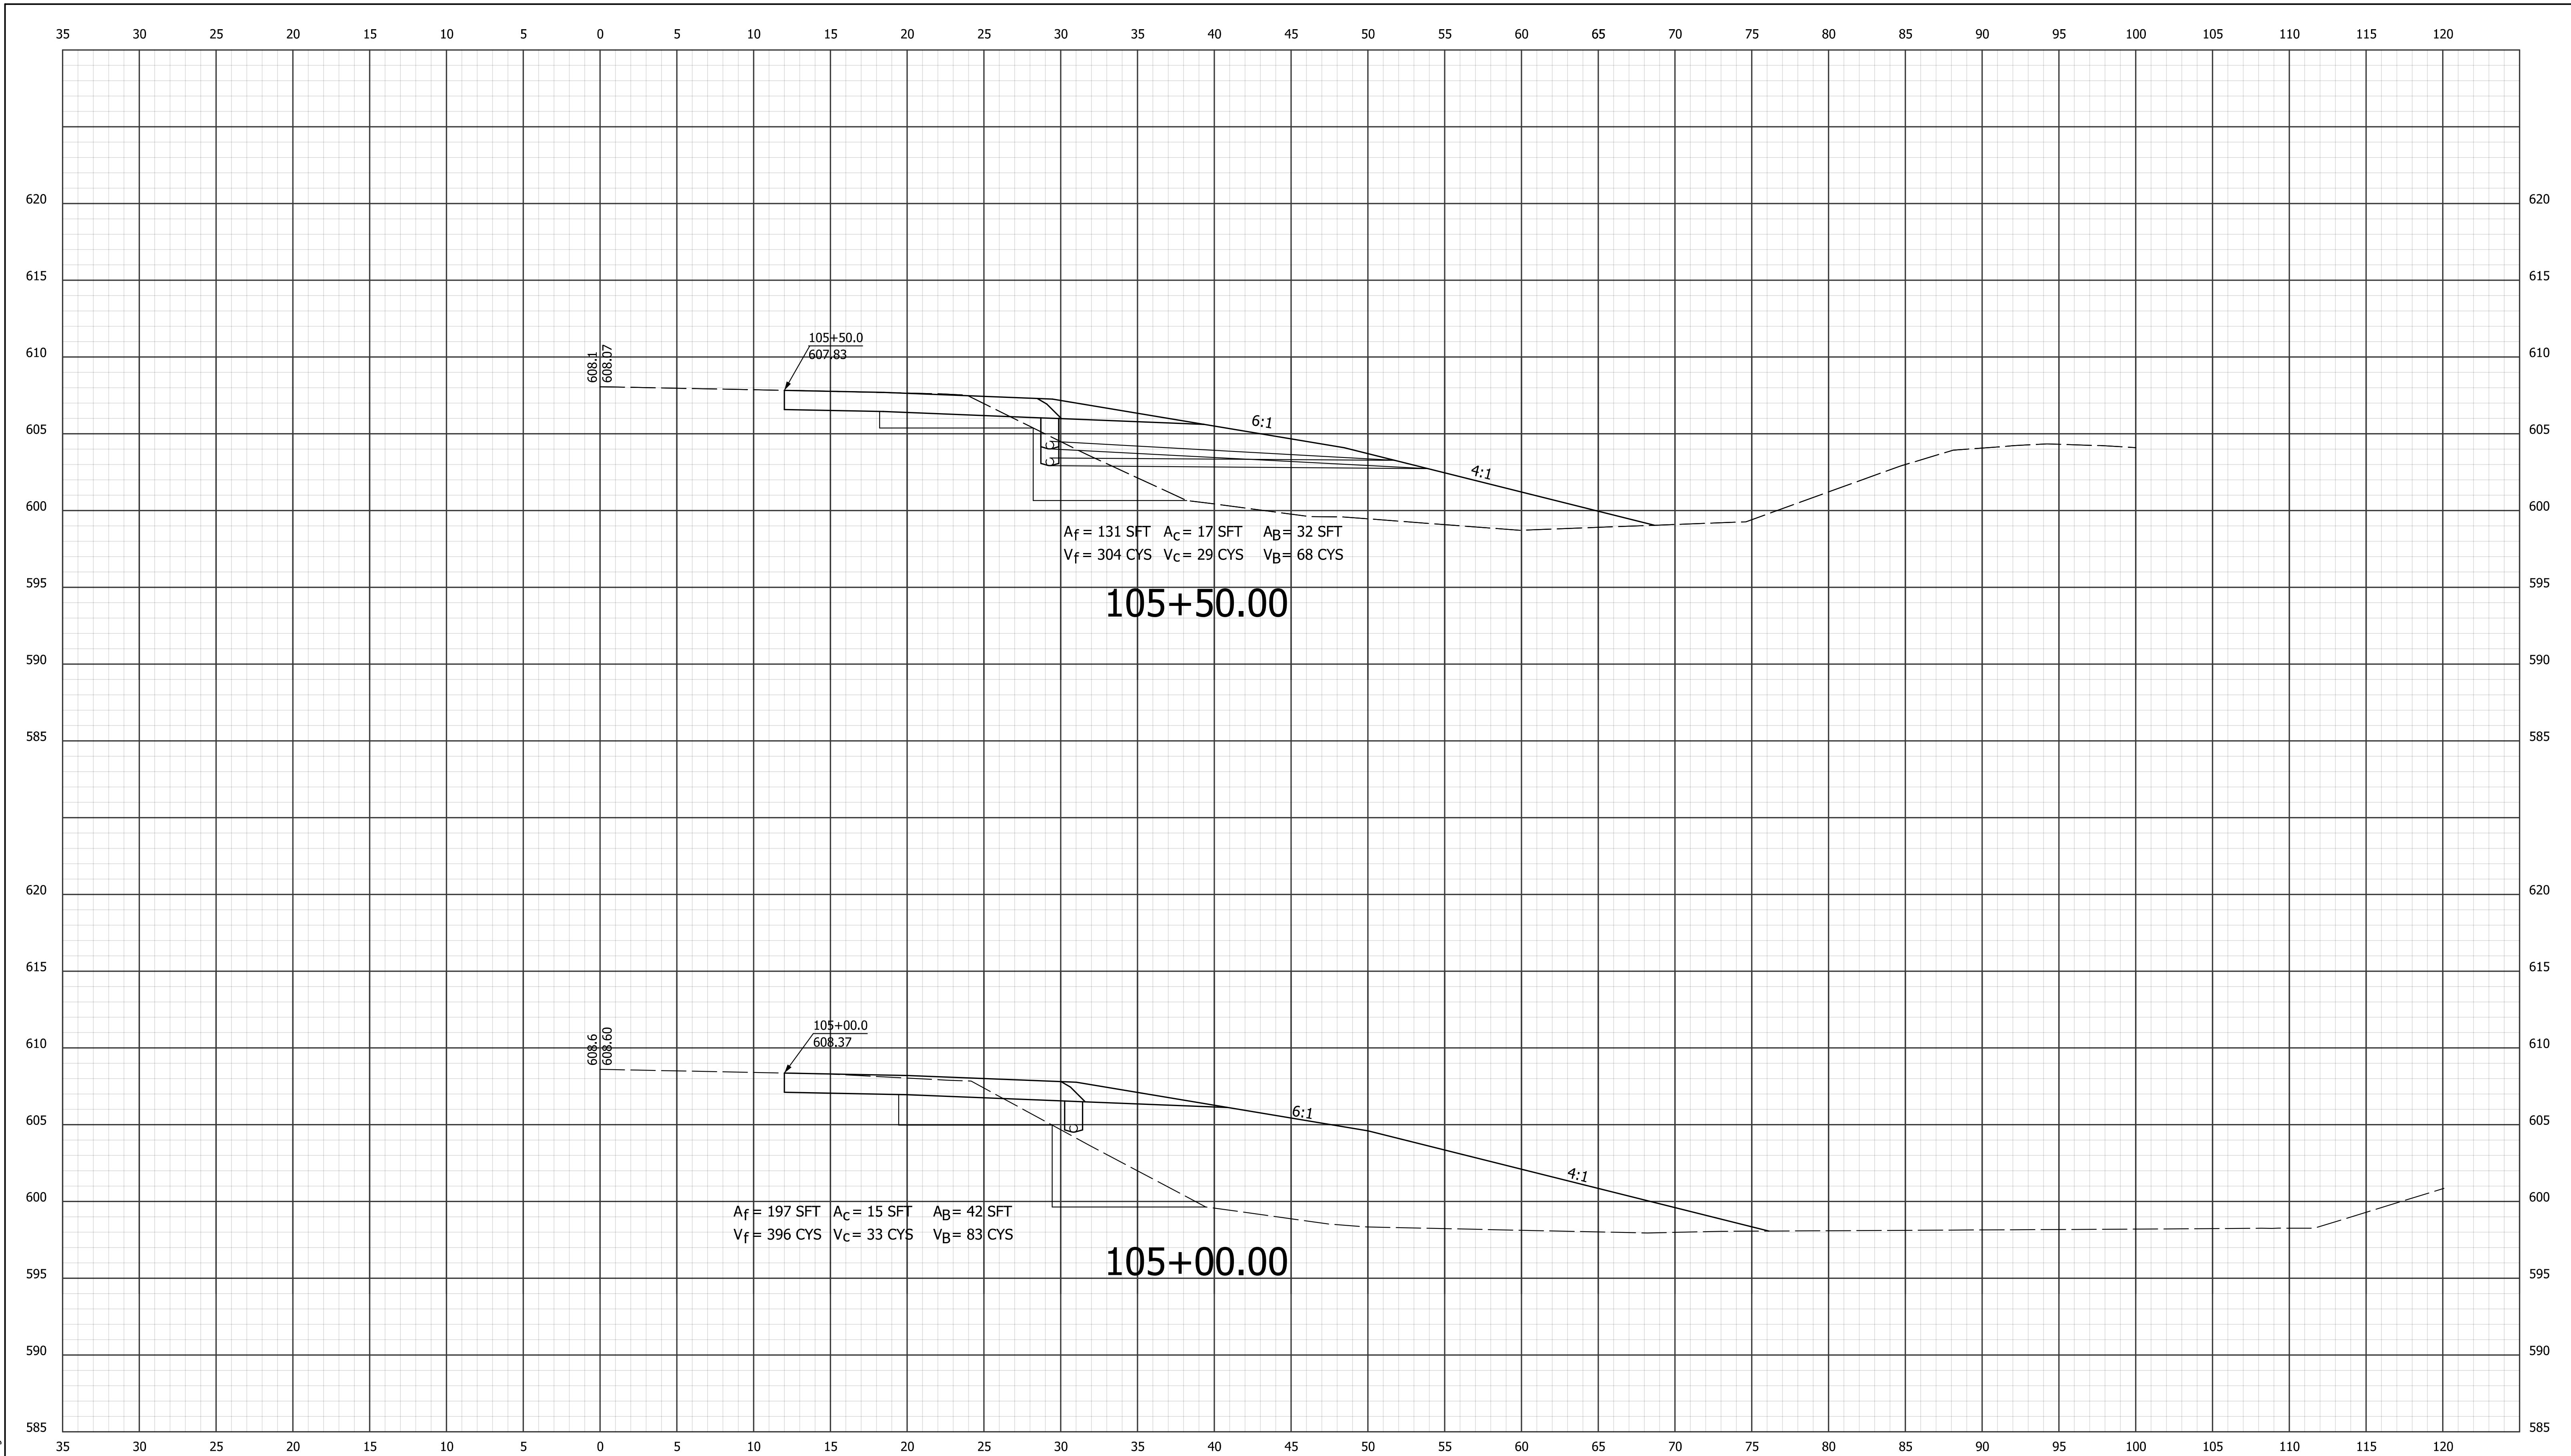

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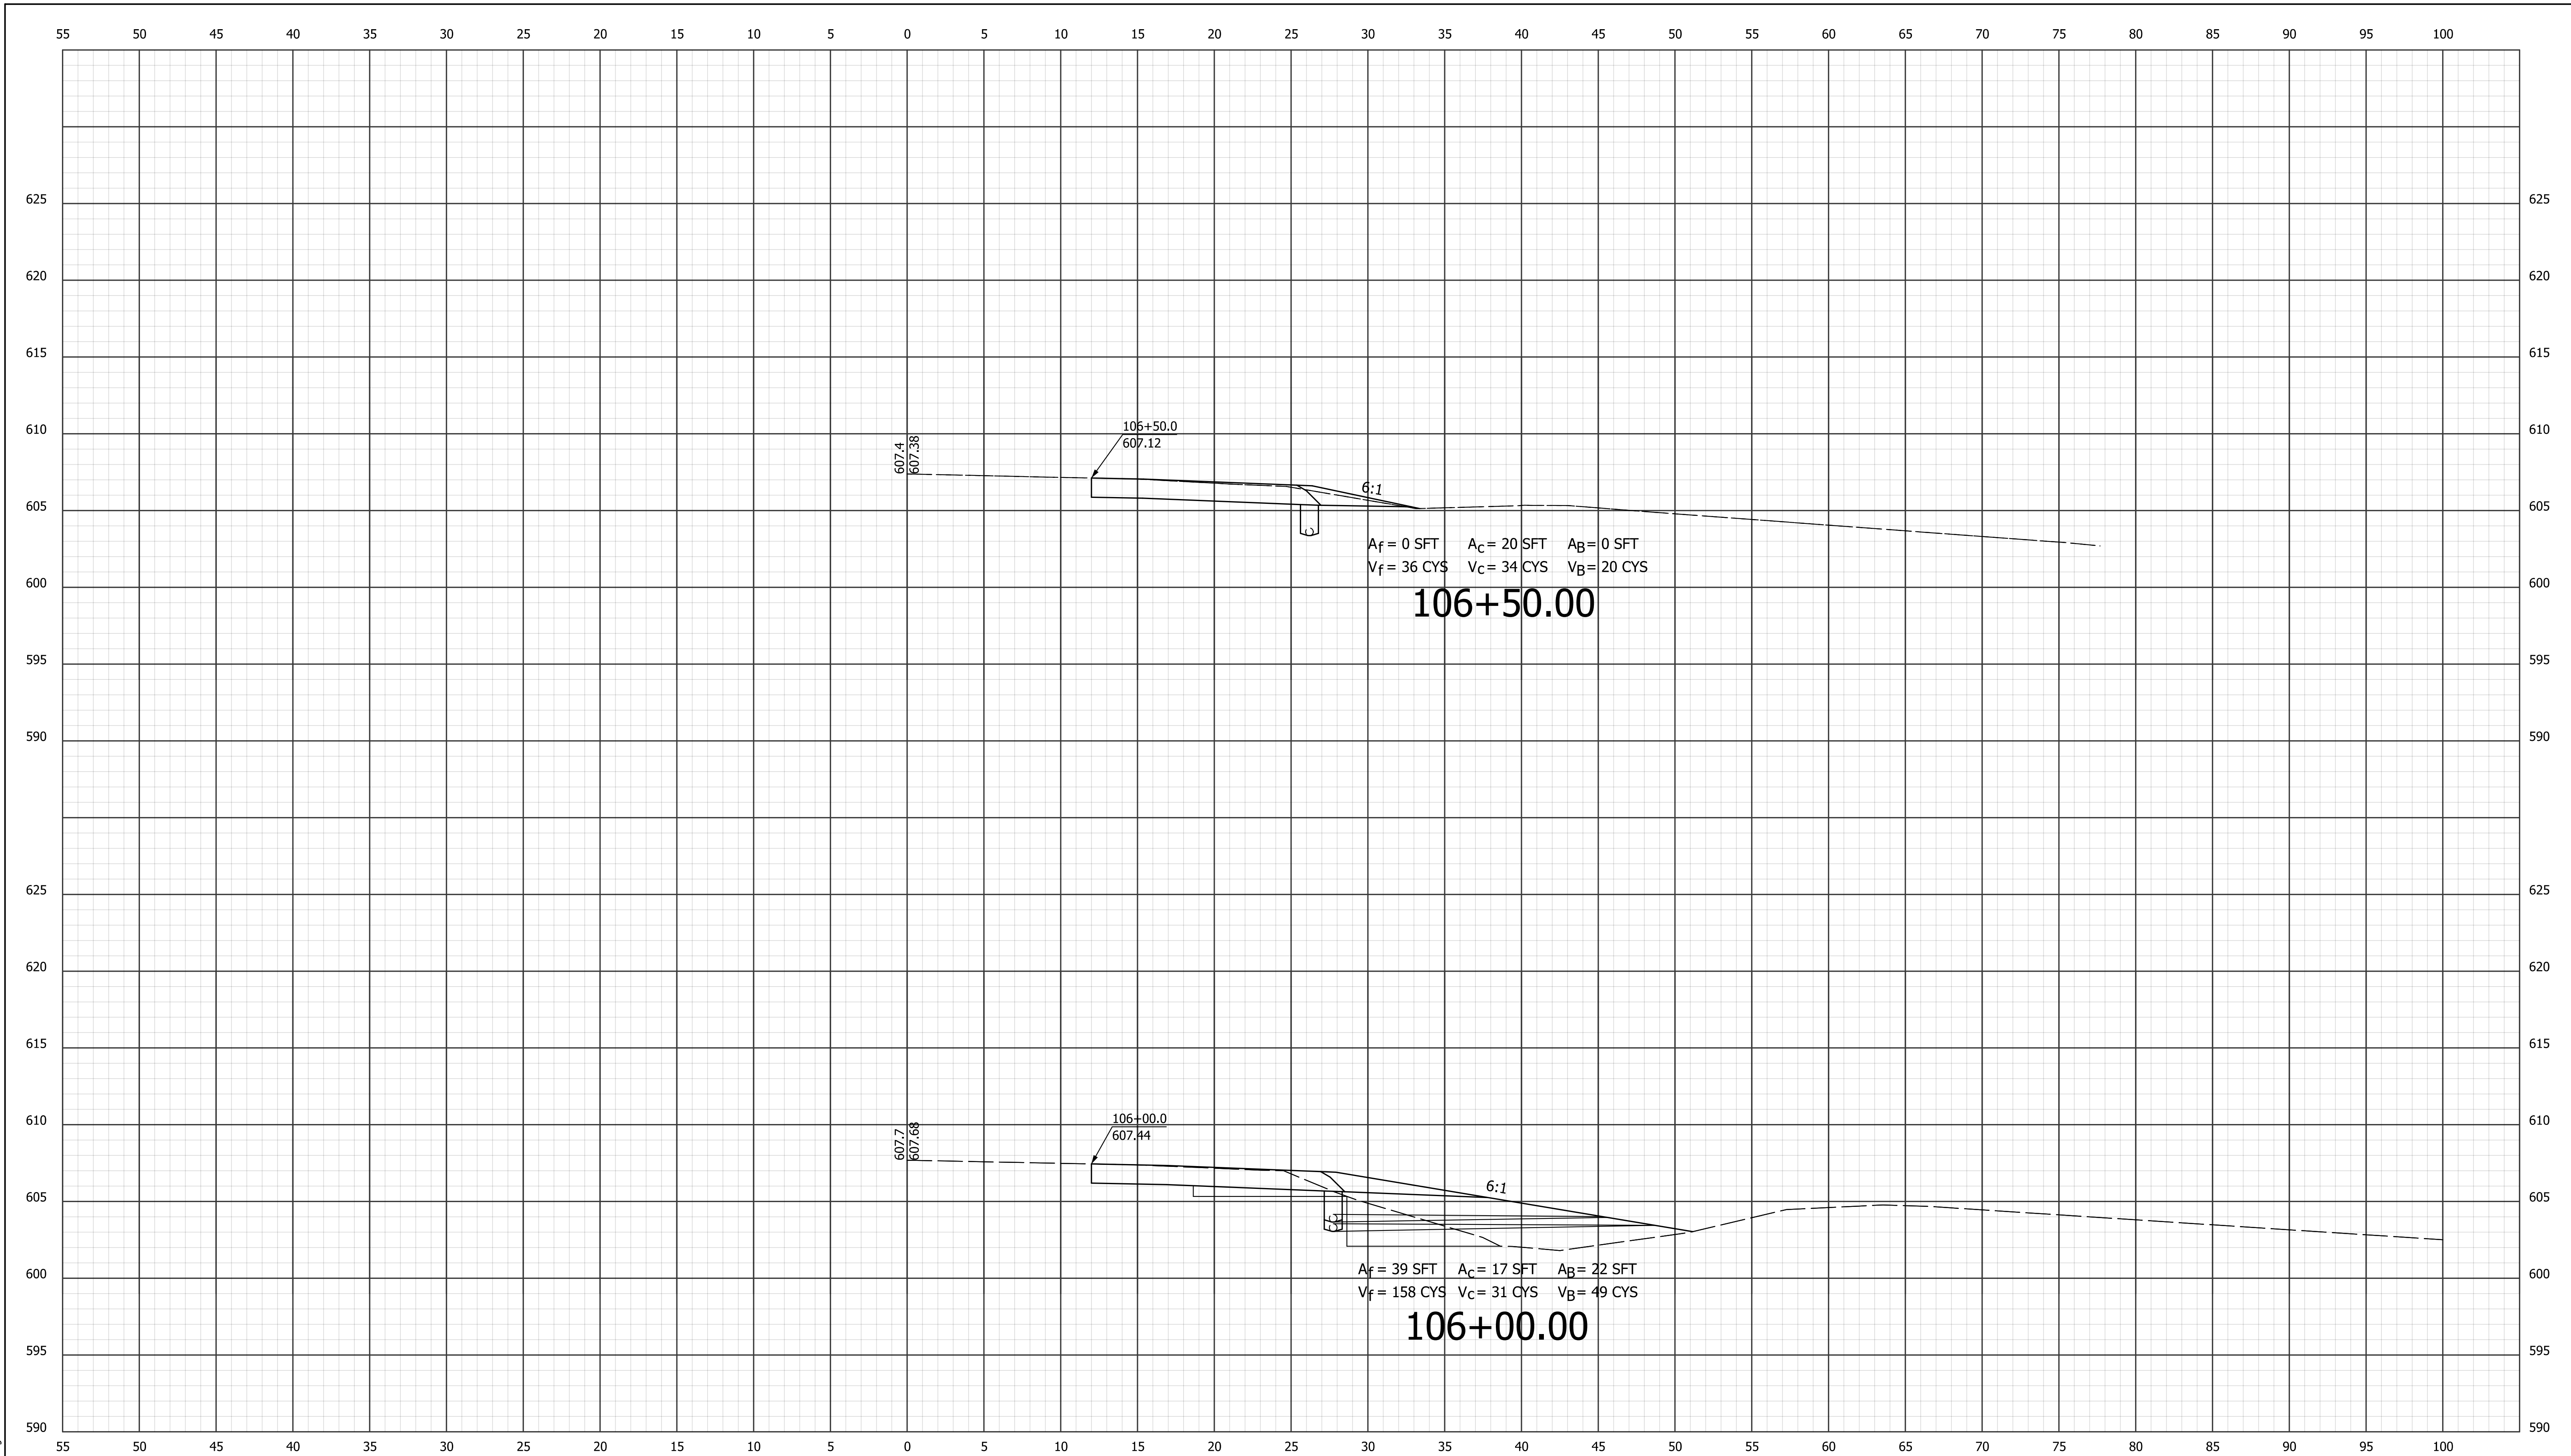
RECOMMENDED FOR APPROVAL		DESIGN ENGINEER	DATE
DESIGNED: LEJ	DRAWN: LEJ		
CHECKED: JMM	CHECKED: JMM		

**INDIANA**  
**DEPARTMENT OF TRANSPORTATION**

**CROSS SECTIONS**  
**LINE "A"**  
**STA. 105+00.00 TO 105+50.00**

HORIZONTAL SCALE	BRIDGE FILE	
1" = 5'	N/A	
VERTICAL SCALE	DESIGNATION	
1" = 5'	1500153	
SURVEY BOOK	DWG. NO.	SHEET NO.
	XS-6	16 of 18
CONTRACT	PROJECT	
R-37820	1500153	





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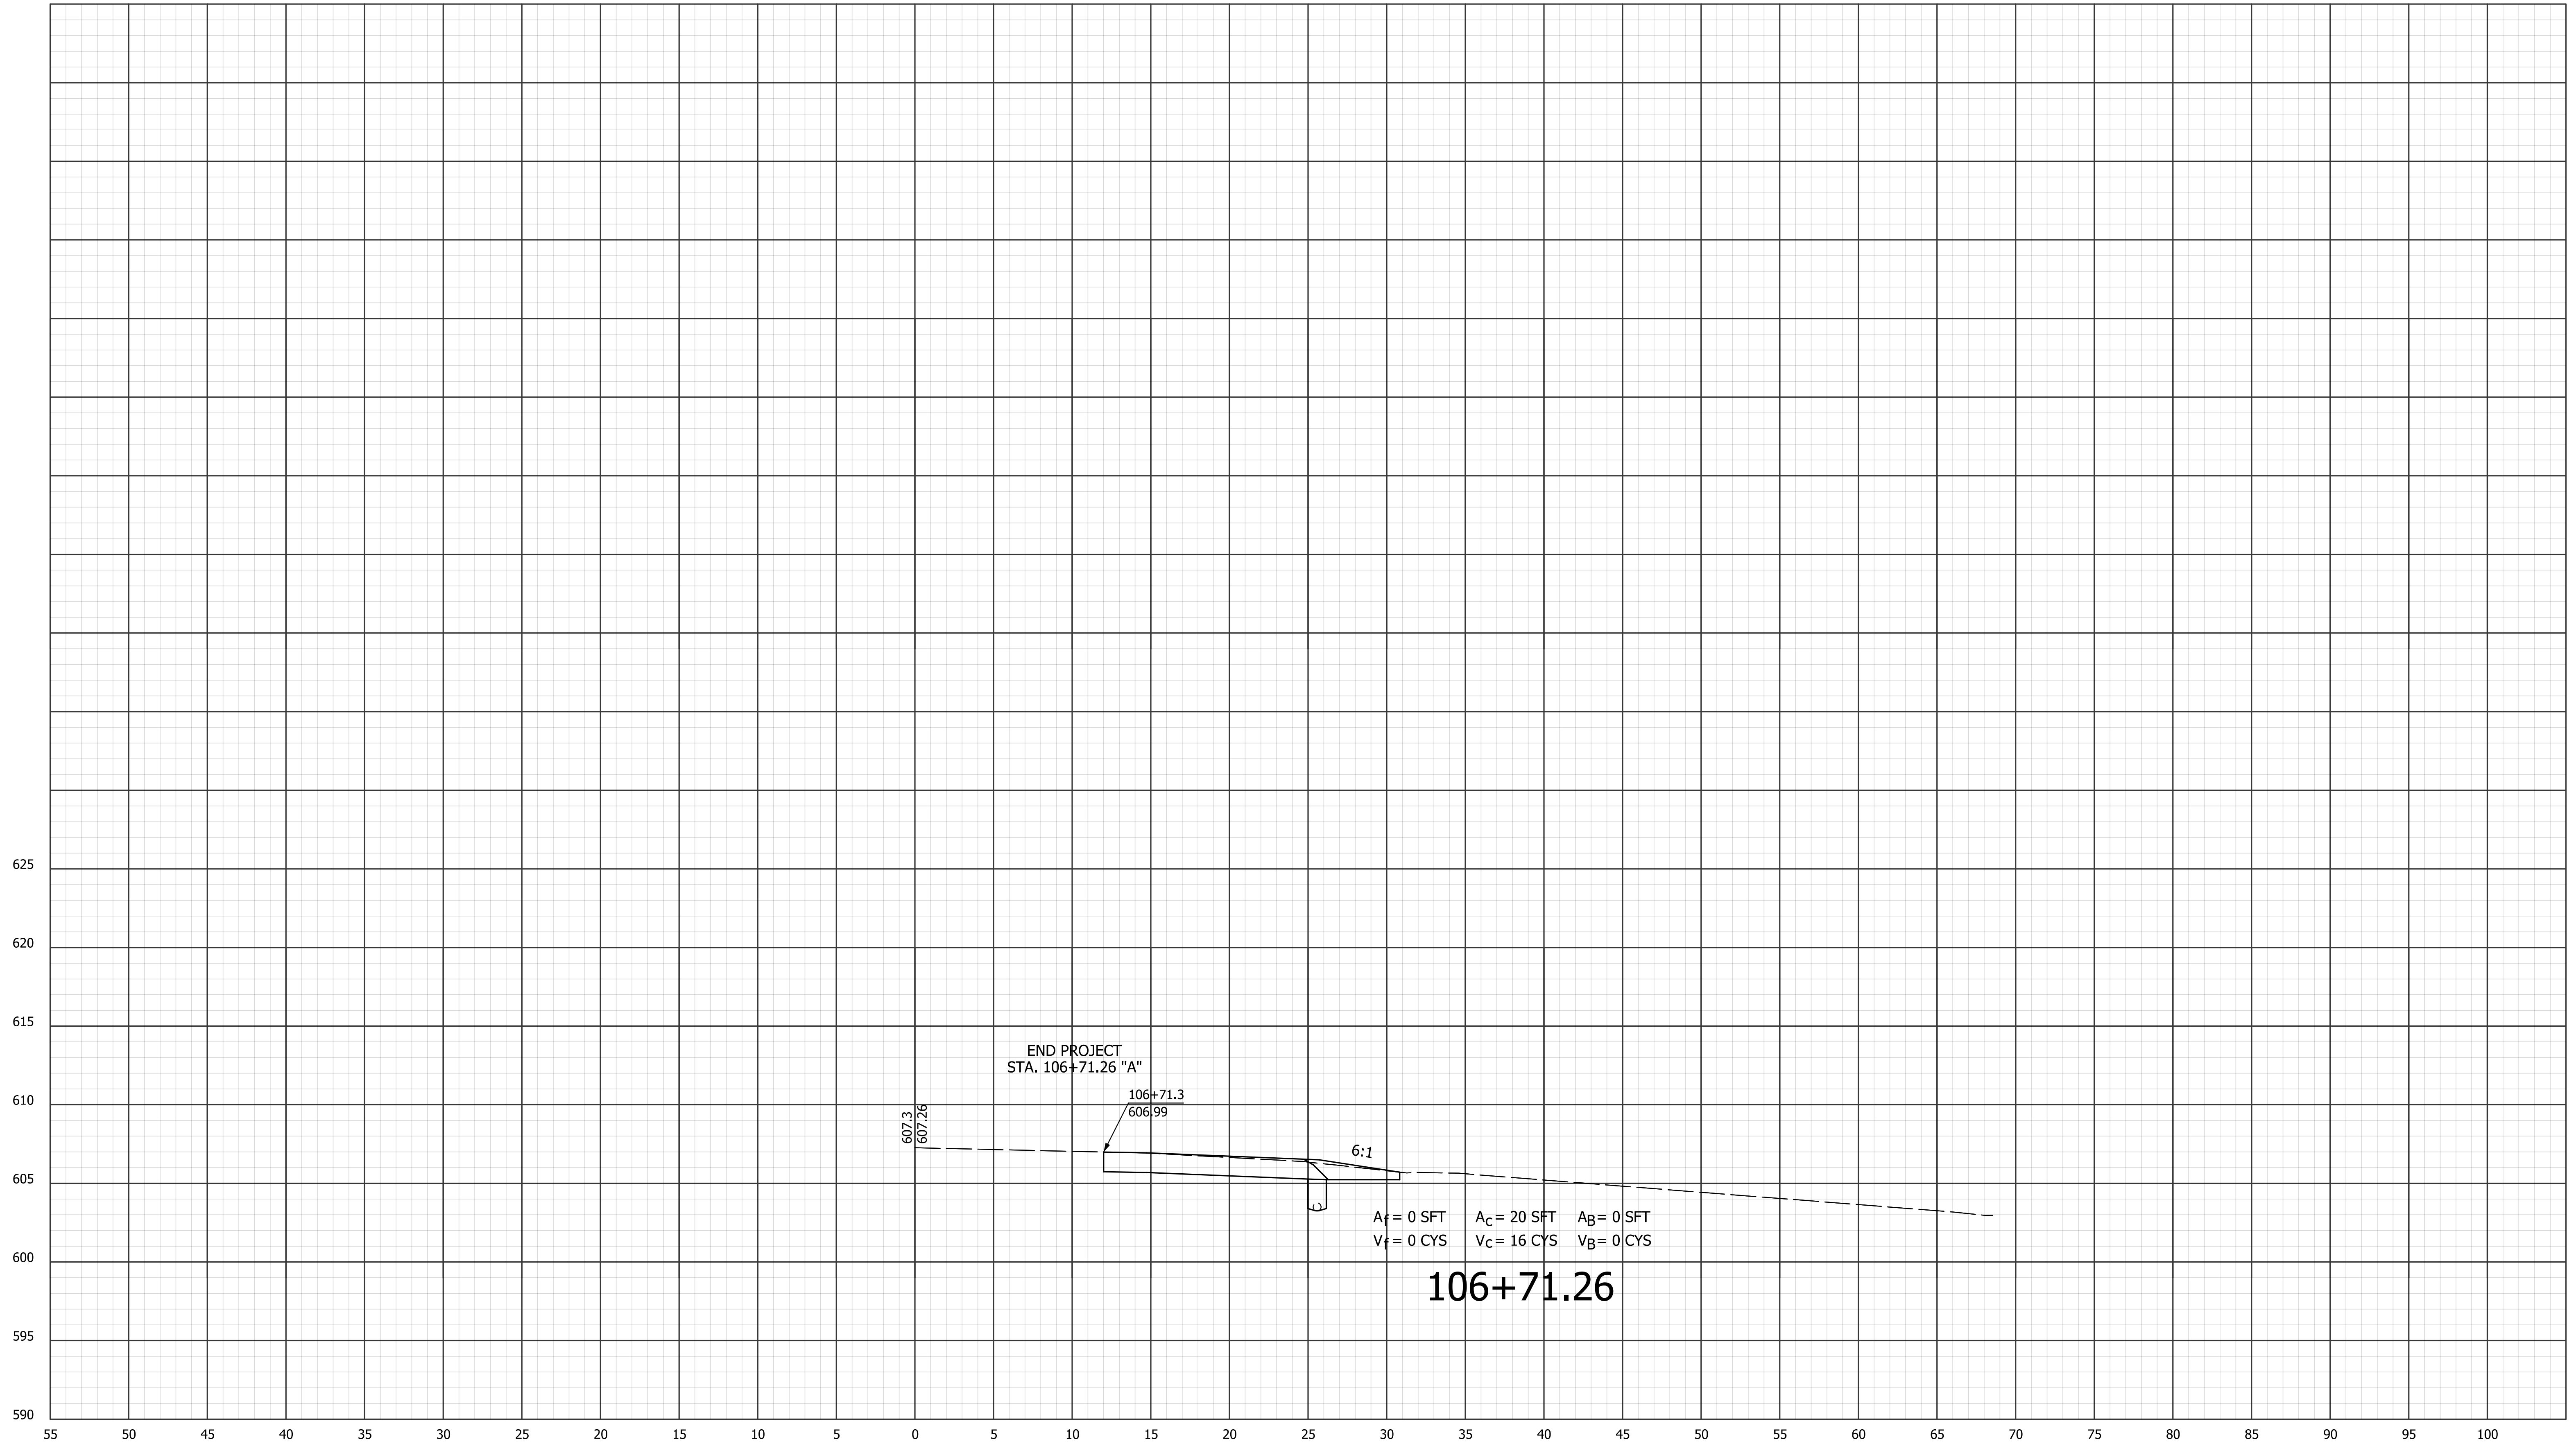
RECOMMENDED FOR APPROVAL _____	
DESIGNED: LEJ	DRAWN: LEJ
CHECKED: JMM	CHECKED: JMM

**INDIANA**  
**DEPARTMENT OF TRANSPORTATION**

**CROSS SECTIONS**  
**LINE "A"**  
**STA. 106+00.00 TO 106+50.00**

HORIZONTAL SCALE 1" = 5'	BRIDGE FILE N/A	
VERTICAL SCALE 1" = 5'	DESIGNATION 1500153	
SURVEY BOOK	DWG. NO. XS-7	SHEET NO. 17 of 18
CONTRACT R-37820	PROJECT 1500153	

55 50 45 40 35 30 25 20 15 10 5 0 5 10 15 20 25 30 35 40 45 50 55 60 65 70 75 80 85 90 95 100



END PROJECT  
STA. 106+71.26 "A"

A<sub>f</sub> = 0 SFT    A<sub>c</sub> = 20 SFT    A<sub>b</sub> = 0 SFT  
V<sub>f</sub> = 0 CYS    V<sub>c</sub> = 16 CYS    V<sub>b</sub> = 0 CYS

106+71.26

10/25/2019 8:17:07 AM  
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RECOMMENDED FOR APPROVAL _____		DESIGN ENGINEER _____		DATE _____	
DESIGNED: LEJ	DRAWN: LEJ				
CHECKED: JMM	CHECKED: JMM				

**INDIANA**  
**DEPARTMENT OF TRANSPORTATION**

**CROSS SECTIONS**  
**LINE "A"**  
**STA. 106+71.26 TO 106+71.26**

HORIZONTAL SCALE 1" = 5'	BRIDGE FILE N/A	
VERTICAL SCALE 1" = 5'	DESIGNATION 1500153	
SURVEY BOOK	DWG. NO. XS-8	SHEET NO. 18 of 18
CONTRACT R-37820	PROJECT 1500153	