

R/W INDEX

SHEET NO.	DESIGNATION	X-REFERENCE SHEET NO'S	DATE ADOPTED 'A' or LATEST REVISION 'R'
1	TITLE SHEET		
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97	PLAN & PROFILE (LINE "S-1-B" - RIDDLE ROAD)	10, 43, 111	
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106	PLAN & PROFILE (ACCESS RD. NO. 2)	62, 63, 69, 70	
107	PLAN & PROFILE (ACCESS RD. NO. 3)	67, 68	
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133-149	AERIAL MOSAIC		
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RIGHT OF WAY PLANS

STATE OF INDIANA

CODE NO. 0855

FEDERAL ROAD DIVISION NO.	STATE	PROJ. NO.	FISCAL YEAR	SHEET NO.	TOTAL SHEETS
4	IND.	I-64-3(33)86	1967	1	

REVISIONS - CONTINUED		
SHEET NO.	DATE	REVISED
38, 39, 74, 139, 146	6-12-72	CEMETERY LOCATIONS
67, 69, 70, 71, 107, 144	6-5-73	OWNER'S NAME FOR PARCEL 46
1A, 1B & 1C	6-5-73	NEW PARCEL LISTING 7th & 8th Lim. Parcel 64A
37, 39, 41, 54, 60, 62	12-18-75	TRANSFER OF EXCESS LAND TO
64, 70-76, 87-89	12-18-75	DEPT. OF NATURAL RESOURCES

DESIGN DATA	
A.D.T. (1965)	8115 V.P.D.
A.D.T. (1985) PROJECTED	16,769 V.P.D.
D.H.V. (1975)	2222 V.P.D.
DIRECTIONAL DISTRIBUTION	52%
TRUCKS	D.H.V. 10% A.D.T. 20%
DESIGN SPEED	70 M.P.H.
ACCESS CONTROL	FULL

PLAN AND PROFILE OF PROPOSED STATE HIGHWAY

PROJECT NO. I-64-3(33)86 R/W


(30)86 P.E.

(38)86-8(40)93 GRADING

(39)86-8(41)93 PAVING

BEGINNING AT A POINT APPROXIMATELY 9897 FEET EAST AND 444.4 FEET SOUTH OF THE NORTHWEST CORNER OF SECTION 26, T3S, R1W, CRAWFORD COUNTY AND RUNNING IN AN EASTERLY DIRECTION A DISTANCE OF 89,978.41 FEET TO A POINT ON THE EAST SECTION LINE AND 1634.8 FEET SOUTH OF THE NORTHEAST CORNER OF SECTION 20, T3S, R3E, HARRISON COUNTY, ALL IN THE STATE OF INDIANA.

THESE PLANS PREPARED BY
FINK, ROBERTS & PETRIE, Inc.
CONSULTING ENGINEERS
INDIANAPOLIS, INDIANA
CERTIFIED BY *Maurice E. Craig* DATE 12-27-66

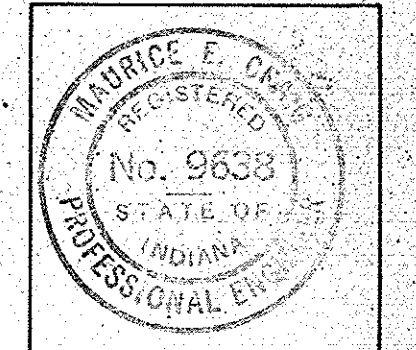

REVISIONS		
SHEET NO.	DATE	REVISED
44, 47 & 49	11/24/67	R/W REV.
50	11/24/67	R/W REV.
71, 76, 77 & 78	11/24/67	R/W REV.
81, 87 & 89	11/24/67	R/W REV.
95, 96, 97 & 99	11/24/67	R/W REV.
100, 101, 103	11/24/67	R/W REV.
105, 108, 111	11/24/67	R/W REV.
131	11/24/67	R/W REV.
99	3/12/68	R/W REV.
49, 54	10-22-68	TEMP R/W BOUNDING REV.
9	10-22-68	BEARING EQUATION

R/W PLANS FOR THIS PROJECT INCLUDE R/W FOR SEPARATE CONTRACT STRUCTURES



STRUCTURE NO.	PROJECT NO.
2 I-64-87-5680	I-64-3(14)87
11 I-64-100-5688	I-64-3(17)100

STRUCTURES NO. 1, 3, 4, 5, 6, 7, 8, 9, 10 & 10A TO BE BUILT IN COMBINATION WITH ROAD PROJECTS

REVISION		
SHEET NO.	DATE	REVISED
45, 46, 47	11-18-68	#
40 & 41	4-14-69	PARCEL 72 ADDED
41, 43, 95, 111	10-1-69	EXCESS LAND ELIMINATED
59, 60, 61, 62	10-9-69	PARCEL 37A ADDED
44, 45, 46, 61, 62	11-10-69	PARCEL NO. 10 NAME CHANGE
18, 32, 53, 54, 60, 142, 143	4-8-71	OWNER'S 36 OWNER'S 25
25, 31, 44, 111, 140	4-14-71	ADDED A.R. #1 & DETAILS

STATE HIGHWAY DEPARTMENT OF INDIANA
STANDARD SPECIFICATIONS DATED 1963
TO BE USED WITH THESE PLANS.

BEGIN PROJ. I-64-3(33)86 R/W
~~(30)86 P.E.~~
~~(38)86 GRADING~~
~~(39)86 PAVING~~
STA. 2463+00.00 LINE "A" Ahead
STA. 2463+22.00 LINE "AL" Ahead
END PROJ. I-64-2(10)73 R/W
~~(5)73 P.E.~~
~~(22)82 GRADING~~
~~(26)73 PAVING~~
STA. 2463+00.00 LINE "A" Back
STA. 2463+22.00 LINE "AL" Back

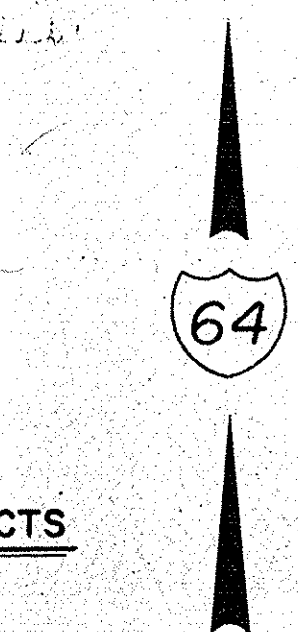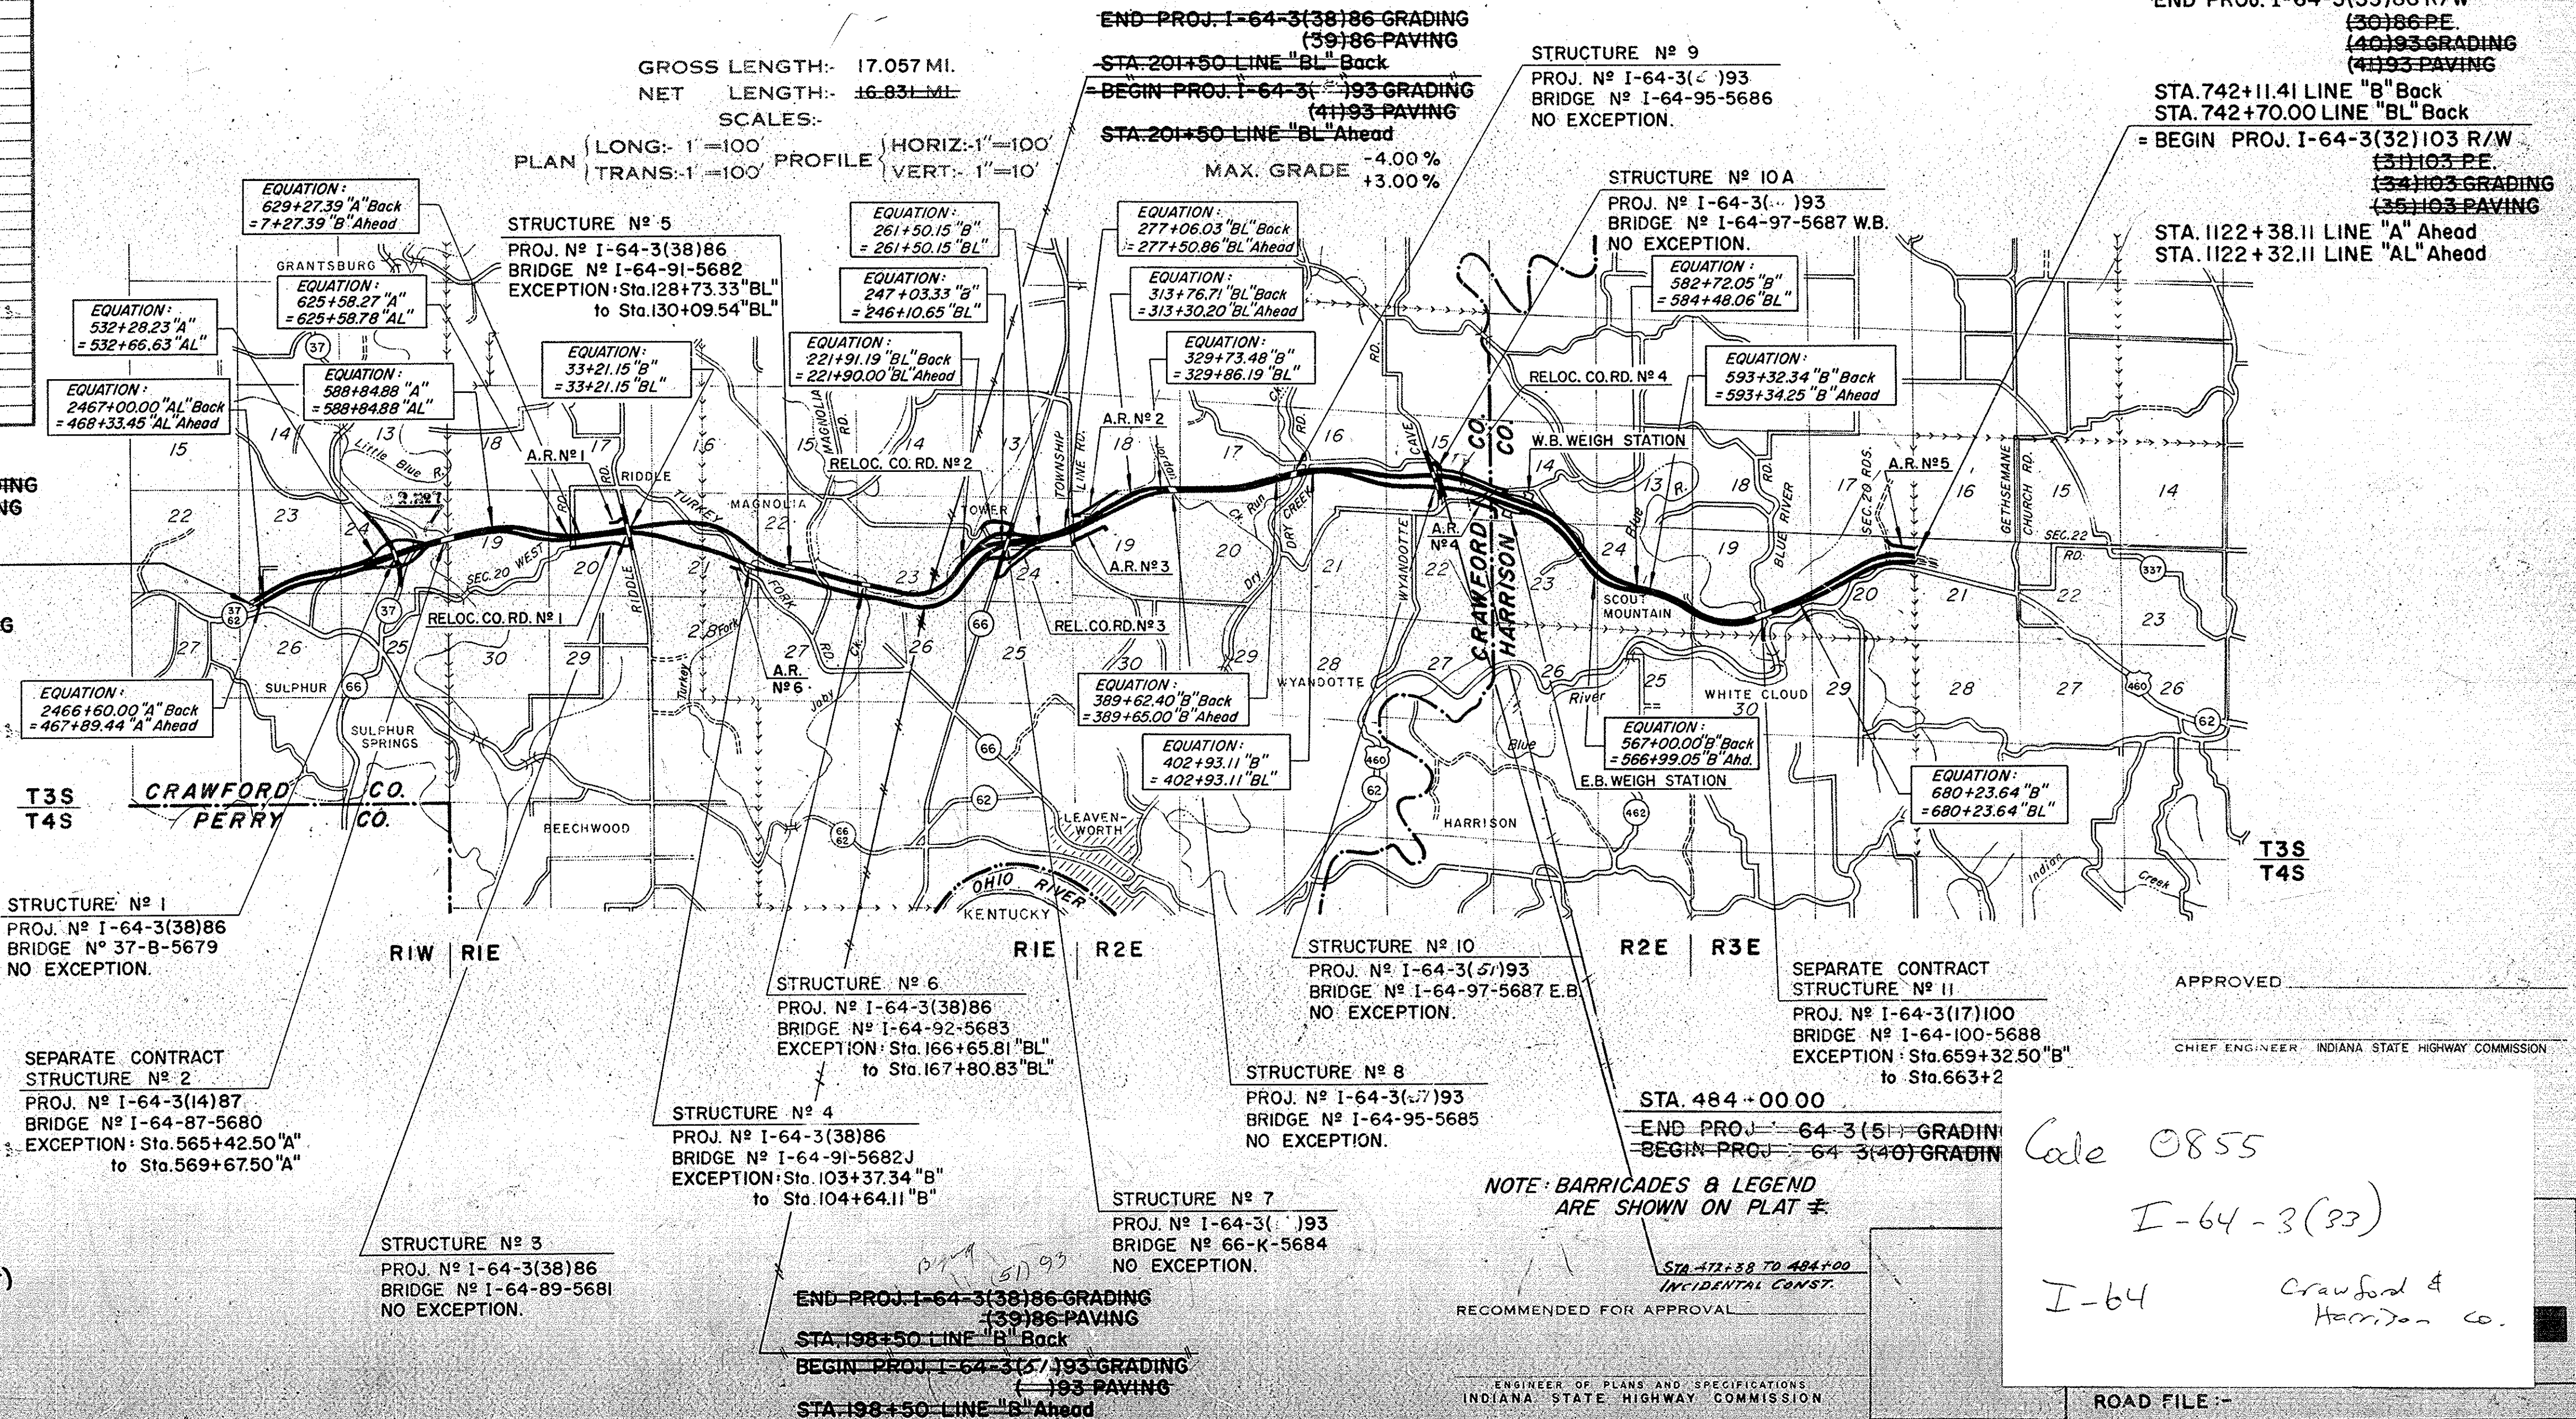

(REVISIONS CONT. ABOVE RIGHT)

NOTE: BARRICADES & LEGEND ARE SHOWN ON PLAT #

APPROVED _____
CHIEF ENGINEER - INDIANA STATE HIGHWAY COMMISSION
Cole 0855
I-64-3(33)
I-64 Crawford & Harrison Co.

PROJECT NO.	LINE	SHEET NO.	TOTAL SHEETS	FILE
I-64-3(33)86	2-4-3	1		

RIGHT OF WAY PLANS

STATE OF INDIANA

INDIANA STATE HIGHWAY COMMISSION

FEDERAL ROAD REGION NO.	STATE	PROJECT NO.	FISCAL YEAR	SHEET NO.	TOTAL SHEETS
4	IND.	I-64-3(33)93	1970	1A	517



PLAN AND PROFILE OF PROPOSED STATE HIGHWAY

PROJECT NO. I-64-3 (30)86 P.E.
(33)86 R/W
(51)93 GRADING
(46)86 UTILITY

BEGINNING AT A POINT ON THE SOUTH SEC. LINE AND APPROX. 1790.0' WEST OF THE SOUTHEAST CORNER OF SEC. 23, T3S, R1E AND RUNNING IN AN EASTERLY DIRECTION A DISTANCE OF APPROX. 28,358.85' TO A POINT APPROX. 1600' WEST OF CRAWFORD AND HARRISON COUNTY LINE AND APPROX. 1675' NORTH OF SOUTH SEC. LINE OF SEC. 15 R.2E. T3S ALL IN CRAWFORD COUNTY

NOTE: These Plans have been revised Nov. 1960 to include the Special Criteria of "Highway Design and Operational Practices Related to Highway Safety" dated February, 1967.

DESIGN DATA	
A.D.T. (1969)	6446 V.P.D.
A.D.T. (1989) PROJECTED	12,183 V.P.D.
D.H.V. (1989)	1584 V.P.H.
DIRECTIONAL DISTRIBUTION	51 %
TRUCKS D.H.V. 10% A.D.T. 20%	
DESIGN SPEED	70 M.P.H.
ACCESS CONTROL	FULL

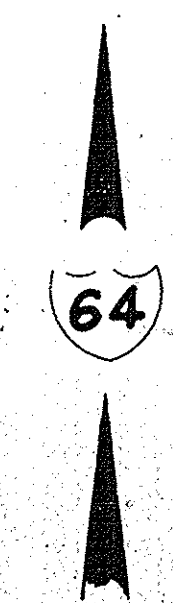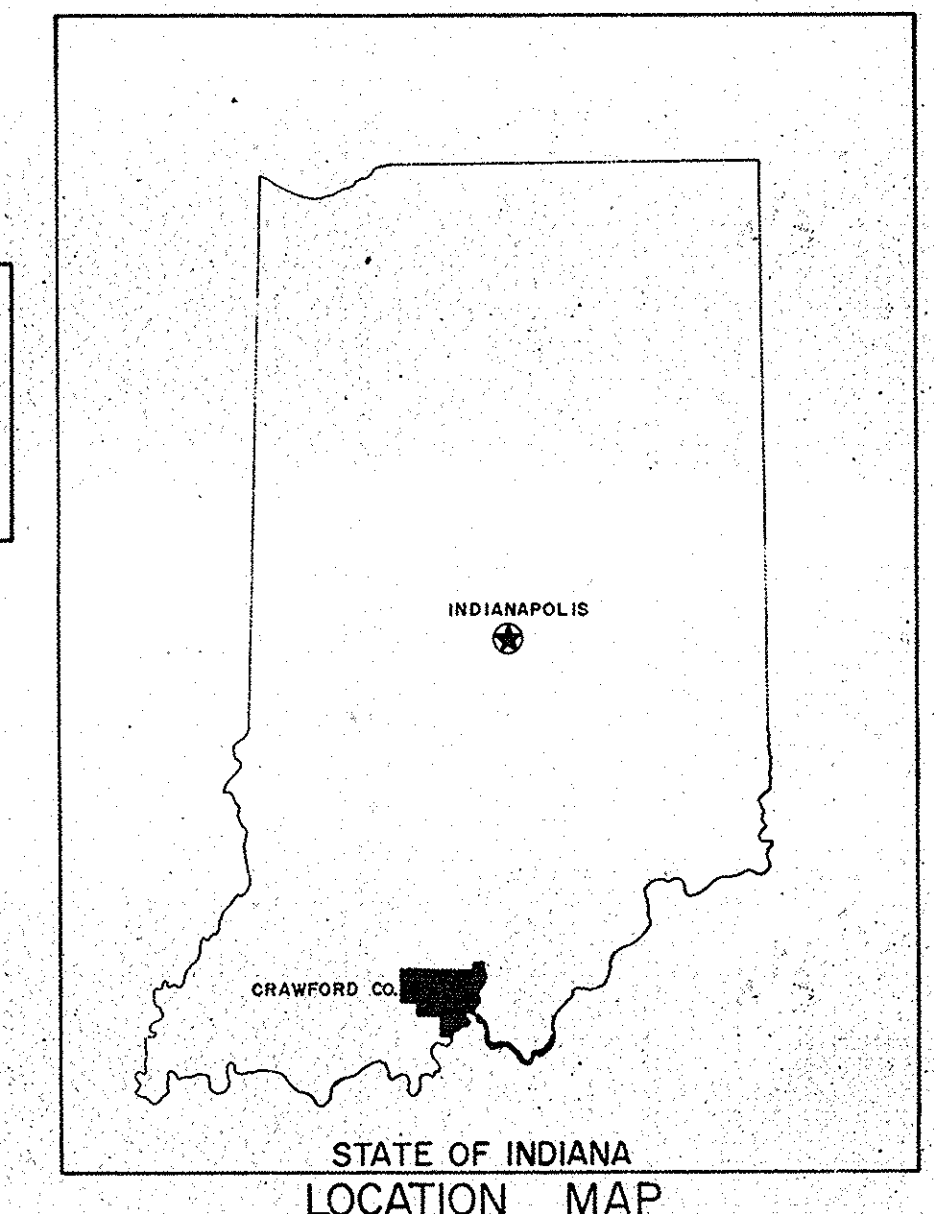


GROSS LENGTH: 5.370 MI.
NET LENGTH: 5.370 MI.
SCALES:-
PLAN { LONG: 1"=100' } PROFILE { HORIZ: 1"=100'
 TRANS: 1"=100' } VERT: 1"=10'

NOTE: BARRICADES & SIGNS ARE SHOWN ON PLAT NO.1

R/W PLANS FOR THIS PROJECT INCLUDES R/W FOR STRUCTURES

SCALE: 1"=2000'

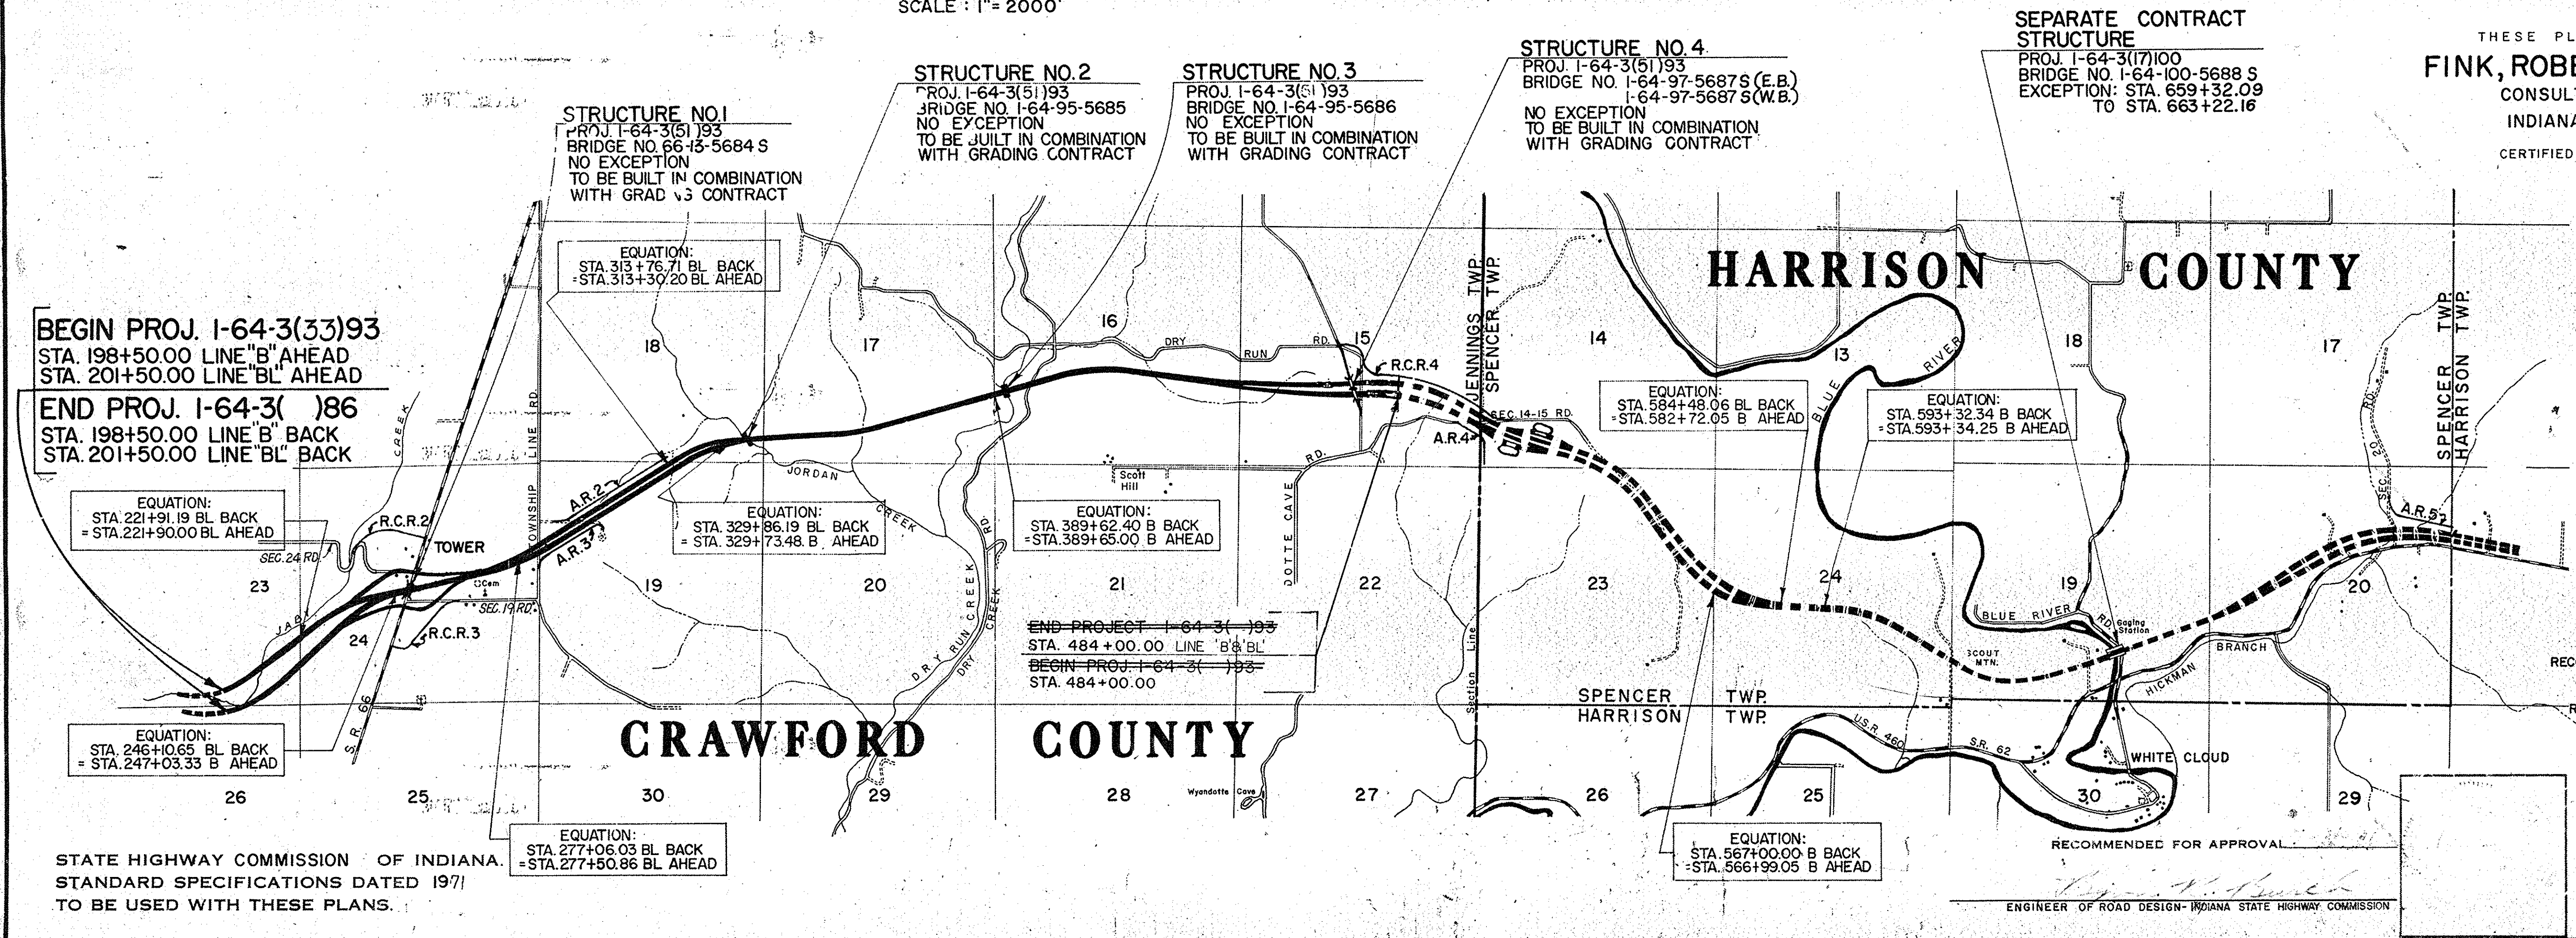

THESE PLANS PREPARED BY
FINK, ROBERTS & PETRIE, Inc.
CONSULTING ENGINEERS
INDIANAPOLIS, INDIANA
CERTIFIED BY *Maurice Craig* DATE 12-15-67

APPROVED: *[Signature]* 5-12-1971
CHIEF ENGINEER-INDIANA STATE HIGHWAY COMMISSION

RECOMMENDED FOR APPROVAL: *[Signature]* DATE 5-11-71
ASSISTANT ROAD DESIGN ENGINEER

RECOMMENDED FOR APPROVAL: *[Signature]* DATE 5-11-71
SENIOR DESIGNER

FEDERAL HIGHWAY ADMINISTRATION
DEPARTMENT OF TRANSPORTATION

APPROVED: _____
DIVISION ENGINEER / DATE

STATE HIGHWAY COMMISSION OF INDIANA.
STANDARD SPECIFICATIONS DATED 1971
TO BE USED WITH THESE PLANS.

PROJECT NO.	LINE	SHEET NO.	TOTAL SHEETS	FILE
I-64-3(33)93		1	517	

FEDERAL ROAD REGION NO.	STATE	PROJECT NO.	FISCAL YEAR	SHEET NO.	TOTAL SHEETS
4	IND.	I-64-3(33)98	1970	18	324

RIGHT OF WAY PLANS

STATE OF INDIANA

INDIANA STATE HIGHWAY COMMISSION


PLAN AND PROFILE OF PROPOSED STATE HIGHWAY

PROJECT NO. I-64-3(33)86 P.E. (46)86 UTILITY
 (30)86 R/W (40)90 GRADING

BEGINNING AT A POINT APPROX. 1600' WEST OF CRAWFORD AND HARRISON COUNTY LINE AND APPROX. 1675' NORTH OF SOUTH SEC. LINE OF SEC. 15 R2E, T3S AND RUNNING IN AN EASTERLY DIRECTION A DISTANCE OF APPROX. 25,927.27' TO A POINT ON THE EAST SEC. LINE AND APPROX. 1619.8' SOUTH OF THE NORTHEAST CORNER OF SEC. 20, T3S, R3E. SAID LINE LIES IN CRAWFORD AND HARRISON COUNTIES, STATE OF INDIANA.

NOTE: These Plans have been Revised Nov. 1969 to include the Special Criteria of "Highway Design and Operational Practices Related to Highway Safety" dated February, 1967.

DESIGN DATA	
A.D.T. (1969)	6446 V.P.D.
A.D.T. (1989) PROJECTED	12,183 V.P.D.
D.H.V. (1989)	1584 V.P.H.
DIRECTIONAL DISTRIBUTION	51 %
TRUCKS D.H.V. 10% A.D.T. 20%	
DESIGN SPEED	70 M.P.H.
ACCESS CONTROL	FULL

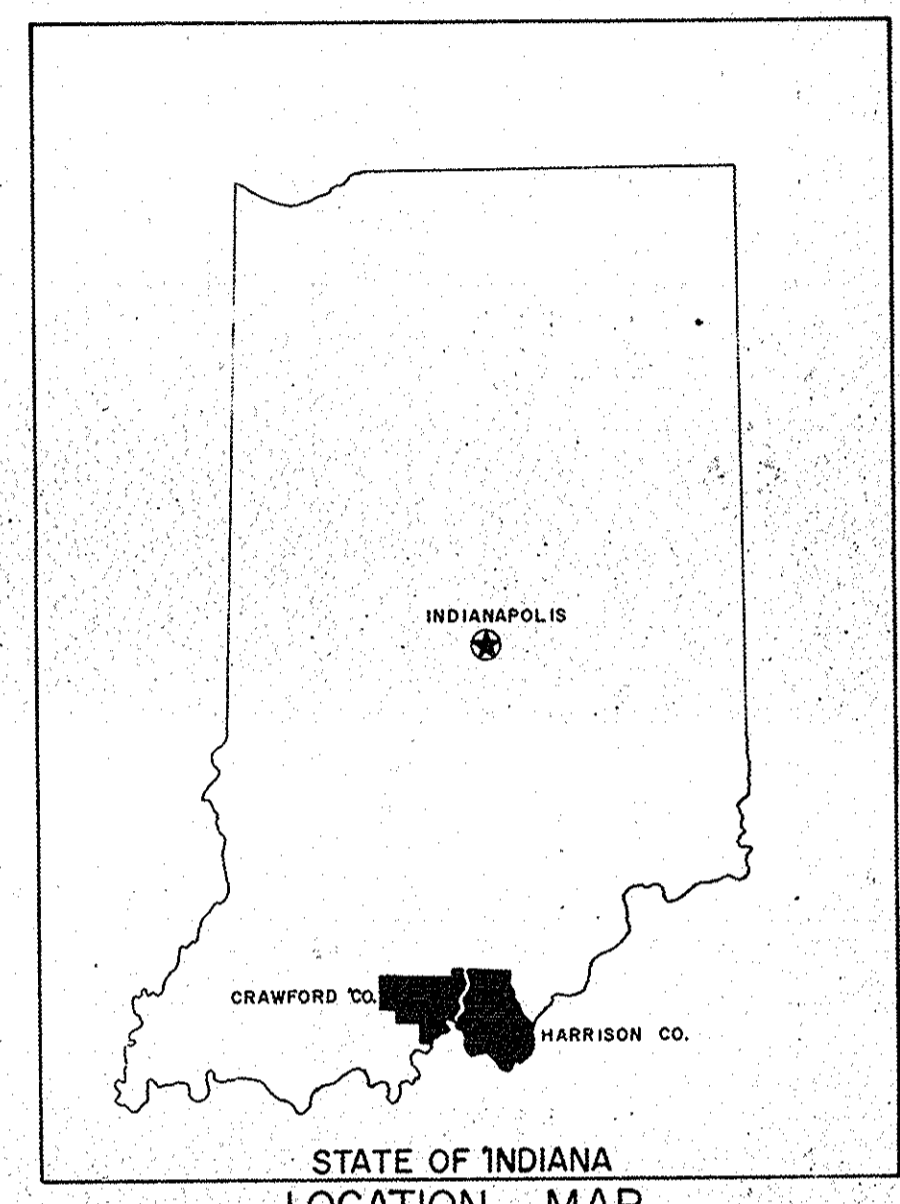

GROSS LENGTH: 4.910 MI.
 NET LENGTH: 4.836 MI.
 SCALES:-
 PLAN { LONG:- 1"=100' PROFILE { HORIZ:-1"=100'
 { TRANS:-1"=100' { VERT:- 1"=10'

MAX. GRADE -4.00%
 +3.00%



NOTE: BARRICADES & SIGNS ARE SHOWN ON PLAT NO. 1

R/W PLANS FOR THIS PROJECT INCLUDES R/W FOR THE SEPARATE CONTRACT STRUCTURE

SCALE: 1"=2000'

SEPARATE CONTRACT STRUCTURE NO. 1
 PROJ. I-64-3(17)100
 BRIDGE NO. I-64-100-5688 S
 EXCEPTION: STA. 659+32.09 TO STA. 663+22.16

THESE PLANS PREPARED BY
FINK, ROBERTS & PETRIE, Inc.
 CONSULTING ENGINEERS
 INDIANAPOLIS, INDIANA
 CERTIFIED BY *Maurice Craig* DATE 12-15-67

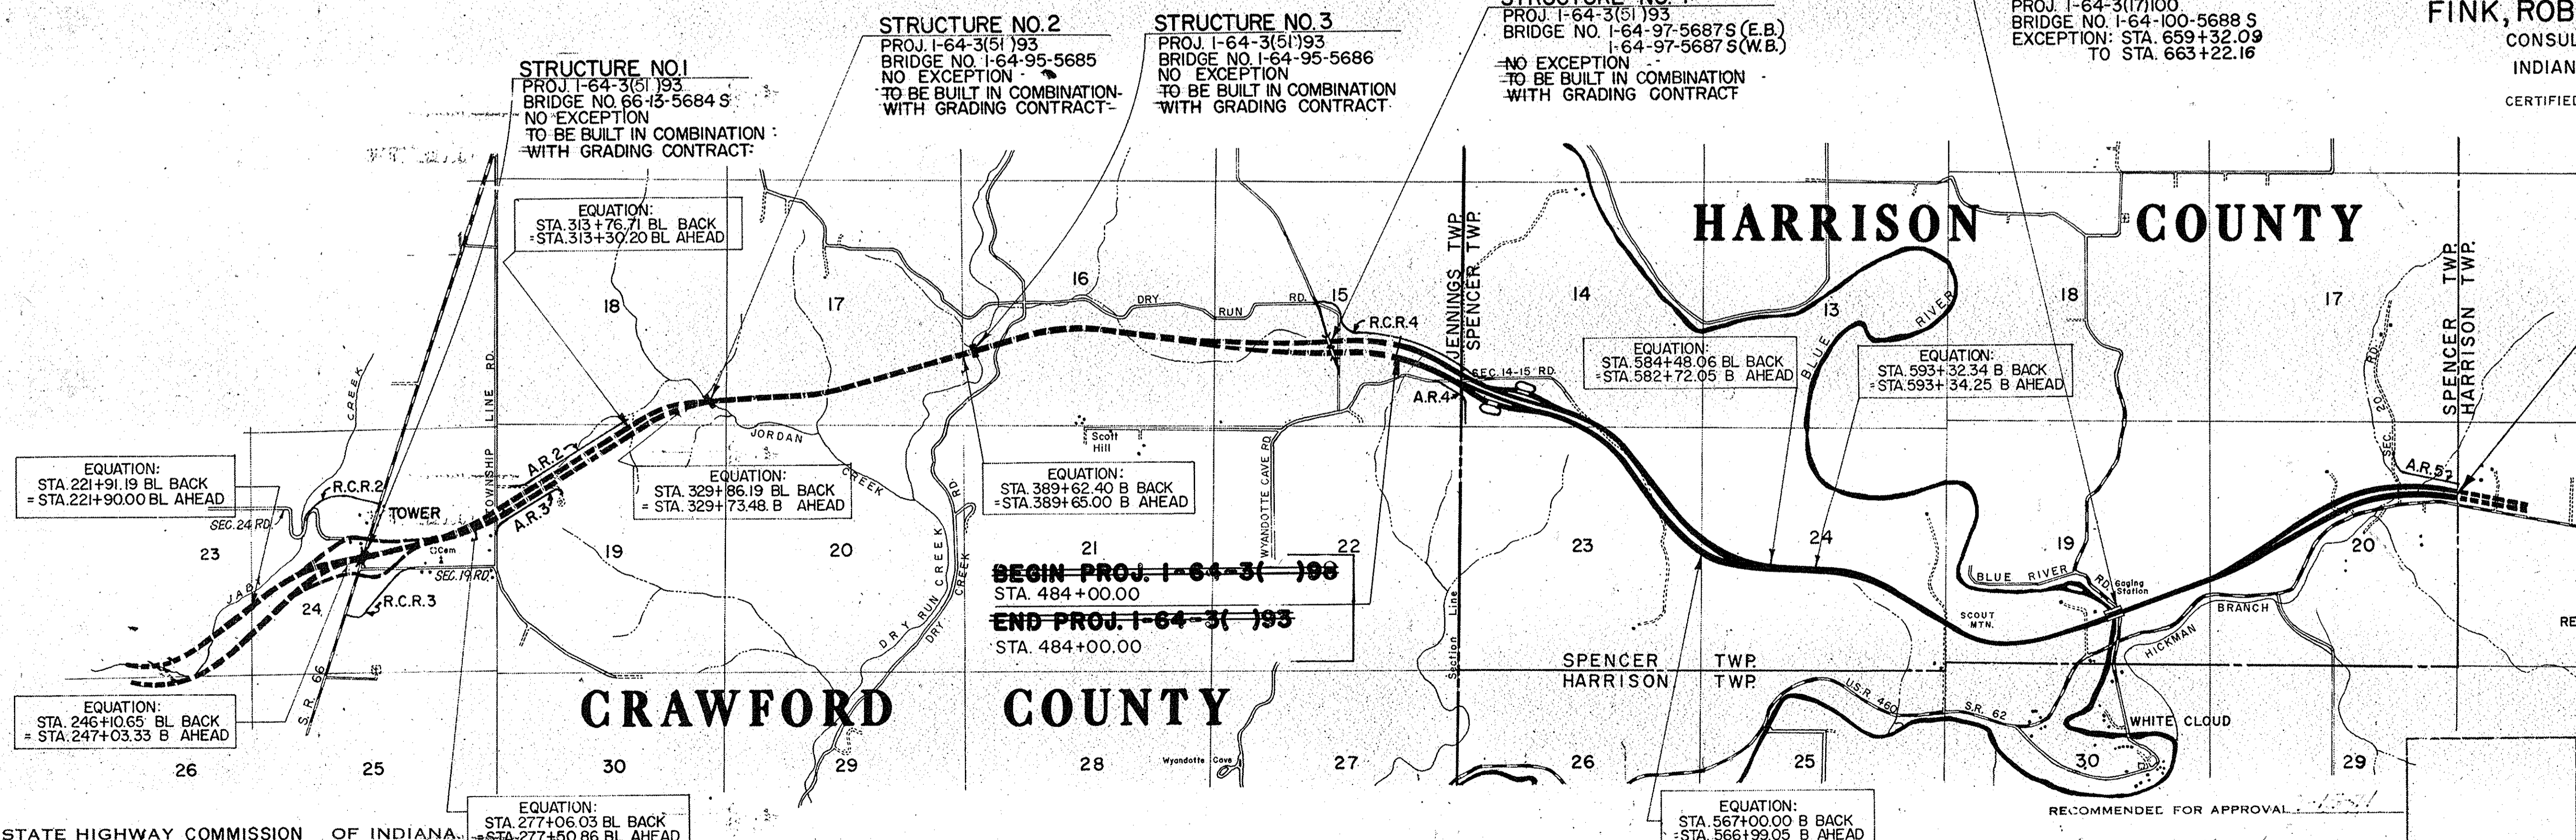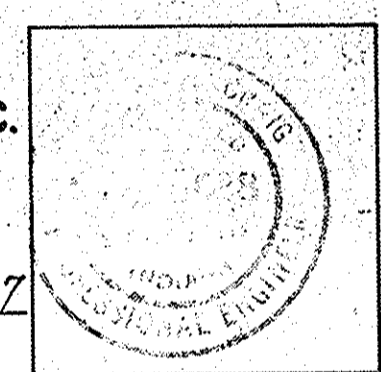

END PROJ. I-64-3(33)98
 STA. 742+11.41 LINE "B" BACK
 STA. 742+70.00 LINE "BL" BACK
 BEGIN PROJ. I-64-3(10)103
 STA. 1122+38.11 LINE "A" AHEAD
 STA. 1122+32.11 LINE "AL" AHEAD

APPROVED *3-13-1971*
W. W. Stewart
 CHIEF ENGINEER - INDIANA STATE HIGHWAY COMMISSION

RECOMMENDED FOR APPROVAL *W. W. Stewart* DATE 3-15-71
 ASSISTANT ROAD DESIGN ENGINEER
 RECOMMENDED FOR APPROVAL _____ DATE _____
 SENIOR DESIGNER

FEDERAL HIGHWAY ADMINISTRATION
 DEPARTMENT OF TRANSPORTATION
 APPROVED _____
 DIVISION ENGINEER DATE _____
 ROAD FILE :-

STATE HIGHWAY COMMISSION OF INDIANA
 STANDARD SPECIFICATIONS DATED 1969
 TO BE USED WITH THESE PLANS.

PROJECT NO.	LINE	SHEET NO.	TOTAL SHEETS	FILE
I-64-3(33)98		18	324	

ROAD I-64 COUNTY-CRAMFORD + HARRISON PROJECT I-64-3(33)86 L.A. CODE 0855 DATE 06/05/73

PARCEL LISTING FOR LAND ACQUISITION INDIANA STATE HIGHWAY COMMISSION

PARCEL NUMBER	GRANTOR	CENTER LINE	FROM APPROX STR.	PLAN SHEET	BRIDGE	TOTAL AREA	R/W EXISTING	NATURE OF TITLE ACQUIRED	RESIDUE AREA	BLDG.
1	TIMBERLAKE, ESTELLA A	A	468	471	37+38+39	10.000AC	0.197AC	FS 9.803AC	A= 24.366AC B= 6.677AC	
2	ARMSTRONG, OSCAR ET UX. A	A	468	496	38+39+40	191.898AC	1.674AC	FS 159.221AC		
2A		A	495	496	40+41			SP EASMT RTS		
3	RAINEY, GEORGE S ET UX. A	A	495	497	40+41	1.560AC	0.072AC	FS 1.107AC	A= 0.361AC	
4	SMITH, MABEL ET AL. A	A	496	510	40+41	150.500AC	1.056AC	FS 18.589AC	A= 0.209AC B= 8.151AC C= 95.173AC	
4A		A	502	510	40			FS 3.843AC		
4B		A	529	539	42+43+111			FS 25.479AC		
5	SCHULZ, WAYNE ET UX. A	A	510	535	40+42+111	205.499AC	0.848AC	FS 28.246AC	A=173.462AC B= 1.240AC C= 0.500AC	
5A		A	510	515	41			FS 1.203AC		
6	DRAPER, FLOYD ET UX. A	A	539	554	95+96+111	121.500AC	4.368AC	FS 47.443AC	A= 14.518AC B= 37.076AC C= 8.427AC D= 3.759AC E= 3.453AC	
6A		A	550	552	44+111			TE 0.198AC		
6B		SSR37A	27	36	95			FS 1.753AC		
6C		A	553	554	44+111			FS 0.702AC		
6D		SSR37A	27	36	95			TE 0.944AC		
7	ARMSTRONG, ALVA ET UX. SSR37A	A	55	71	42+96+111	140.000AC	2.940AC	FS 11.012AC	A= 8.910AC B= 1.092AC C= 37.127AC D= 0.459AC E= 78.586AC	
8	SMITH, JOHN A	A	553	555	44+111	* 184.833AC	0.907AC	FS 1.245AC	A= 73.555AC B= 0.412AC C= 80.261AC	
8A		A	553	579	44+45+111			FS 28.433AC		
8B		A	553	556	44+111			TE 0.516AC		
9	BARKER, JAMES H. ET UX. A	A	567	578	44+45	* 83.000AC		FS 11.383AC	A= 71.617AC	
10	LUTZ, JESSE E. ET UX. A	A	578	589	44+45+46	73.820AC		FS 17.936AC	A= 55.884AC	
11	JONES, JAMES E. ET UX. A	A	578	589	44+45	40.417AC		FS 2.911AC	A= 37.506AC	
12	HIGHELL, MADGE A	A	590	602	45+46	80.000AC		FS 26.889AC	A= 53.111AC	
13	REYNOLDS, SHELIA MAE A	A	602	629	46+47+48	60.000AC	0.558AC	FS 38.381AC	A= 21.061AC	
14	FRANK WRIGHT, ESTATE A	A	624	625	47	40.000AC	1.360AC	FS 0.339AC	A= 13.811AC B= 24.276AC	
14A		A	626	627	47+100			FS 0.214AC		
15	GOLDMAN, LLOYD ET UX. B	B	8	16	47+48+100	83.000AC	2.366AC	FS 11.275AC	A= 1.467AC B= 49.008AC C= 16.864AC	
16	BOWE, DENNISE H. B	B	14	16	47+100	30.000AC	0.010AC	FS 0.116AC	A= 29.874AC	
16A		B	14	16	47+100			TE 0.050AC		
17	EDWARDS, PAUL ET UX. B	B	15	27	47+48+49	166.000AC	1.807AC	FS 14.994AC	A= 17.034AC B= 12.275AC C= 65.450AC D= 0.425AC E= 94.847AC	
17A		S118	53	59	97			FS 0.523AC		
17B		B	27	28	49+50			TE 0.160AC		
17C		S118	57	59	97			FS 0.092AC		
17D		B	59	63	51			FS 0.551AC		
18	SCHULTZ, HUBERT ET UX. B	B	15	18	47+100	50.000AC		FS 1.160AC	A= 48.840AC	
18A		B	15	17	47+100			TE 0.410AC		
19	FATRIDGE, REVA C. B	B	27	33	49+50+97	49.314AC	1.013AC	FS 8.977AC	A= 39.324AC	
20	RITCHIE, GRESHAM ET UX. B	B	33	63	51+52+97	139.000AC	2.849AC	FS 57.411AC	A= 56.253AC B= 13.152AC C= 4.244AC D= 0.924AC	
20A		S118	45	47	97			TE 0.120AC		
21	TONEY, ROY J. B	B	60	63	52	40.000AC	1.123AC	FS 0.434AC	A= 20.996AC B= 17.447AC	
22	CRECELIOUS, DARRIN ET UX. B	B	63	82	51+52+53	136.000AC	0.239AC	FS 35.253AC	A= 100.508AC	
23	LYNTON, W. + SHAW, S. T. B	B	62	63	52	123.883AC	0.796AC	FS 0.056AC	A= 103.189AC	
23A		B	63	80	52+54			FS 19.842AC		
23B		B	62	80	52+54			SP CONTR. SALE		
24	LINTON, W. L. JR. ET UX. B	B	78	90	52+54	25.000AC	0.327AC	FS 11.236AC	A= 13.437AC	
25	ODLE, CHESTER B	B	82	92	53+54	20.000AC	0.472AC	FS 10.136AC	A= 9.013AC	
25A		B	86	89	53+54			FS 0.379AC		
25B		B	92	93	53			TE 0.067AC		
26	SUMMERS, HERBERT ET UX. B	B	90	109	53+56	101.000AC	0.992AC	FS 84.943AC	A= 10.197AC B= 4.008AC	
26A		B	92	95	53			FS 0.225AC		
27	SCHNYDER, MARSHALL J. B	B	105	109	53+55+56	60.000AC	0.696AC	FS 5.759AC	A= 2.663AC B= 50.883AC	
28	HUBBARD, RALPH E. ET UX. B	B	109	117	53+54+55	277.000AC	0.731AC	FS 10.305AC	A= 265.964AC	
29	HENDERSON, LESTER ET UX. B	B	109	136	55+56	117.967AC	0.771AC	FS 47.807AC	A= 25.847AC B= 0.559AC C= 42.430AC D= 0.328AC	
29A		B	136	136	55+56			FS 0.225AC		
30	GRANT, ALLEN ET UX. B	B	136	149	55+57+58	88.000AC	1.767AC	FS 4.056AC	A= 46.088AC B= 1.256AC C= 0.256AC D= 4.040AC	
30A		B	136	159	55+56+57			FS 20.246AC		
30B		B	160	164	57+58			FS 0.714AC		
31	ALLEN, LORENA M. B	B	152	166	57	134.000AC	0.403AC	FS 3.897AC	A= 129.700AC	
32	UNKNOWN B	B	66	86	53+54	9.366AC	0.775AC	FS 8.591AC		
33	MCCORMICK, BEATRICE B	B	164	170	57+58	96.000AC	0.193AC	FS 1.330AC	A= 94.477AC	
34	DEPT OF CONSV., ST OF IND B	B	158	176	57+58+59	UNKNOWN	UNKNOWN	FS 26.448AC	UNKNOWN	
34A		B	295	323	67+68+69			FS 41.168AC		
34B		B	349	388	71+72			FS 42.450AC		
34C		B	307	308	70+106			TE 0.133AC		
34D		S128	53	61	67+99			FS 1.135AC		
34E		S128	34	40	59+103			FS 0.890AC		
34F		S128	34	40	99+103			FS 0.725AC		
34G		B	526	570	82+83+84			FS 25.176AC		
34H		B	518	556	81+82+83			TE 0.191AC		
34J		B	503	504	108+131			FS 1.371AC		
34K		B	553	563	83+84			FS 56.206AC		
34L		B	556	609	85+86+87			TE 0.855AC		
34M		B	583	586	85			FS 1.488AC		
34N		B	593	607	85+87					

PARCEL NUMBER	GRANTOR	CENTER LINE	FROM APPROX STA.	TO APPROX STA.	PLAN SHEET	BRIDGE	TOTAL AREA	R/N EXISTING	NATURE OF TITLE ACQUIRED	RESIDUE BLDG. AREA
35	HOUSE, MELVIN	B	293	295	67+68		0.500AC	0.053AC	FS 0.447AC	
36	TAYLOR, EDWARD P. ET UX.	BL	178	191	59+60		14.300AC		FS 14.300AC	
37	PARKHILL, JEWEL ET AL.	B	178	206	59+60+61		82.000AC		FS 62.619AC A= 19.381AC	
37A		B	178	206	59+60+61				SP CONTR. SALE	
38	EATON, ALICE	B	205	242	61+63+120		159.000AC	1.076AC	FS 71.482AC A= 86.444AC	
38A		B	228	231	63				TE 0.459AC	
39	BREEDEN, RUSSELL ET UX.	B	204	210	61		118.000AC	2.272AC	FS 2.767AC A= 99.983AC B= 12.978AC	
40	MELCOM, GUY ET AL.	BL	215	224	62+63+64		85.000AC		FS 3.636AC A= 81.364AC	
41	ARNENOFF, MARG. ET AL.	B	235	250	64+65+66		26.000AC	0.517AC	FS 16.710AC A= 7.671AC B= 1.102AC	
42	CONDOR, HERDIS ET AL.	SSR668	37	46	98+101+120		99.000AC	3.196AC	FS 4.411AC A= 19.925AC B= 1.988AC C= 4.170AC D= 28.118AC	
42A		RCR2	15	16	101				FS 0.045AC	
42B		SSR668	39	42	98+120				TE 0.378AC	
43	THE TONER ORCHARDS, INC.	B	250	282	67+68+120		412.340AC	7.307AC	FS 29.177AC A=168.274AC B= 12.518AC C= 2.054AC D= 0.951AC E= 0.677AC F=129.008AC G= 21.045AC	
43		SSR668	40	45	98+120				TE 0.871AC	
43A		NER	15	18	98+120				TE 0.502AC	
43B		B	282	291	67+68+106				FS 11.034AC	
43C		BL	285	307	67+68+106				FS 10.780AC	
43D		SSR668	52	63	98+102+120		62.000AC	1.076AC	FS 7.672AC A= 5.399AC B= 47.863AC	
44		SSR668	55	59	98+102+120				TE 0.626AC	
45	COLLINS, HERMAN E. ET UX.	B	273	279	67+68		13.050AC	0.567AC	FS 1.521AC A= 10.962AC	
46	HOUSE, ANNA	B	293	295	67		170.500AC	0.127AC	FS 0.203AC A=140.563AC	
46A		B	295	296	67+107				FS 0.084AC	
46B		B	323	334	69+70+71				FS 29.523AC	
47	MCCLINTOCK, J. A. ET UX.	B	333	349	71		49.000AC		FS 49.000AC	
47A		B	333	349	71				SP RESERV. RTS	
48	SHAFFER, CLEVE ET UX.	B	375	390	72+73		80.000AC	0.375AC	FS 6.975AC A= 71.273AC B= 1.577AC	
49	WILLIAMS, GERALD ET AL.	B	389	445	72+73+75		160.000AC	4.476AC	FS 155.524AC	
49A	ELIMINATED 5/27/69									
50	SCHOTTER, J. LEO ET AL.	B	445	473	77+78+103		170.000AC	3.554AC	FS 49.124AC A= 20.056AC B= 85.669AC C= 2.054AC D= 1.544AC E= 7.787AC	
50A		S12B	42	45	103				FS 0.308AC	
50B		S12B	40	43	98+103				FS 0.770AC	
51	COX, LUCILLE	B	473	486	79+80+103		40.000AC	0.482AC	FS 23.915AC A= 13.531AC B= 2.072AC	
52	PARCEL 52 ON PROJEC I-64-3(33) AND PARCEL 42 ON PROJECT I-64-2(110) COVER THE SAME LAND, WITH ACQUISITION THEREOF ENTIRELY UNDER SAID PROJECT I-64-2(110)									
53	MELONE, WILLIAM T. ET AL.	S12B	54	61	99		9.477AC	0.696AC	FS 0.869AC A= 7.912AC	
54	PEASE, MOET ET UX.	B	485	500	79+80+131		80.000AC	0.930AC	FS 24.588AC A= 22.736AC B= 1.100AC C= 29.150AC	
54A		BL	598	599	80+104+131				TE 0.057AC	
54B		B	498	503	108+131				FS 0.682AC	
55	COX, RHODA	BL	500	509	79+80+131		97.000AC	1.298AC	FS 4.804AC A= 4.346AC B= 9.221AC C= 1.579AC D= 1.359AC	
55A		B	502	527	80+81+131				FS 31.504AC	
56	NO PARCEL 56									
57	JAMES, WILLIAM B.	B	594	605	39+148		44.525AC		FS 37.000AC A= 4.288AC B= 1.992AC	
58	ROTHROCK, ELMER T. ET AL.	B	605	615	39+148		39.000AC		FS 39.000AC	
59	ROTHROCK, RHEA PATE	B	607	621	87		40.000AC	2.728AC	FS 37.272AC	
60	MYERS, R. ROBINSON, D.	B	610	624	87		40.000AC	0.464AC	FS 7.791AC A= 31.745AC	
60A		B	610	624	87				SP CONTR. SALE	
61	WISEMAN, L.J. ESTATE OF	B	623	641	87+88		142.600AC	4.032AC	FS 42.919AC A= 84.159AC B= 9.739AC C= 1.579AC D= 0.172AC	
62	HAGNER, WALTER	B	639	665	88		26.500AC	0.152AC	FS 26.348AC	
63	LOUDEN, LELAH B.	B	639	654	88		22.850AC	0.375AC	FS 13.434AC A= 9.041AC	
64	ROTHROCK, FRANK P.	B	656	661	88+89		3.250AC		FS 3.250AC	
64A	ELIMINATED 06/05/73									
65	ROTHROCK, ROBERT V.	B	655	661	88+89		9.750AC	2.424AC	FS 4.550AC A= 2.776AC	
66	SMOOTS, RICHARD ET UX.	B	663	684	89+90		115.055AC	7.052AC	FS 17.125AC A= 41.400AC B= 9.256AC C= 39.412AC D= 0.514AC E= 0.254AC	
67	PITMAN, CHARLES M.	B	683	699	89+91+92		80.000AC	3.072AC	FS 16.166AC A= 8.287AC B= 9.100AC C= 42.528AC	
68	CRAIG, CLARENCE ET UX.	BL	696	700	92		110.000AC		FS 0.795AC A=109.205AC	
69	WOODRIDGE, FERN SCOTT	B	698	715	91+92		59.962AC	2.334AC	FS 19.212AC A= 21.578AC B= 11.983AC C= 0.855AC	
70	SAUERHEBER, V.E. ET UX.	BL	715	729	91+94+109		42.173AC	1.757AC	FS 18.066AC A= 22.350AC	
71	PARCEL 71 ON PROJECT I-64-3(33) AND PARCEL 2 ON PROJECT I-64-3(32) COVER THE SAME LAND, WITH ACQUISITION THEREOF ENTIRELY UNDER SAID PROJECT I-64-3(33)									
72	SMITH, WILLIAM, JR. ET UX	A	496	499	40+41		2.000AC	0.184AC	FS 0.254AC A= 0.264AC B= 1.258AC	

LIST OF EXCESS LANDS TO BE ACQUIRED AND A SEGREGATION BY PROJECTS OF RIGHT OF WAY AREAS AND EXCESS LANDS TO BE ACQUIRED FOR MORE PROJECTS OF THE SAME PROJECT NUMBER AND PARTICIPATING RATIO


PARCEL NUMBER	EXCESS TYPE OF LAND TO BE ACQUIRED	PROJECT
1	EXCESS 9.803AC	9.803AC
2	EXCESS 118.650AC	118.650AC
5	EXCESS 1.287AC	1.287AC
26	EXCESS 38.638AC	38.638AC
37	EXCESS 19.998AC	19.998AC
38	EXCESS 9.364AC	9.364AC
46	EXCESS 14.296AC	14.296AC
47	EXCESS 29.361AC	29.361AC
49	EXCESS 87.824AC	87.824AC
57	EXCESS 37.000AC	37.000AC
58	EXCESS 39.000AC	39.000AC

PARCEL TYPE OF LAND TO BE PROJECT PROJECT
 NUMERAL TAKING ACQUIRED 1-64-3(33)

59	EXCESS	25.515AC	25.515AC
61	EXCESS	20.565AC	20.565AC
62	EXCESS	19.153AC	19.153AC
64	EXCESS	1.739AC	1.739AC

* (ASTERISK) IN THE BRIDGE COLUMN INDICATES THE PARCEL IS PARTIALLY OR COMPLETELY WITHIN THE LIMITS OF A BRIDGE PROJECT.
 * (ASTERISK) IN THE BLDG. COLUMN INDICATES A BUILDING IS PARTIALLY OR COMPLETELY WITHIN THE LIMITS OF THE R/W REQUIRED.

EASMT RTS = CLEARANCE OF PRIVATE EASEMENT WHICH ENCUMBERS THE TAKING
 CONTR. SALE = RELEASE OF CONTRACT INTEREST
 SP = SPECIAL INSTRUMENT FOR CLEARING SPECIAL INTERESTS (CC DEED, SPECIAL R/W GRANT, RELEASE OF LEASEHOLD, ETC.)
 TS = TEMPORARY TITLE
 TE = TEMPORARY R/W

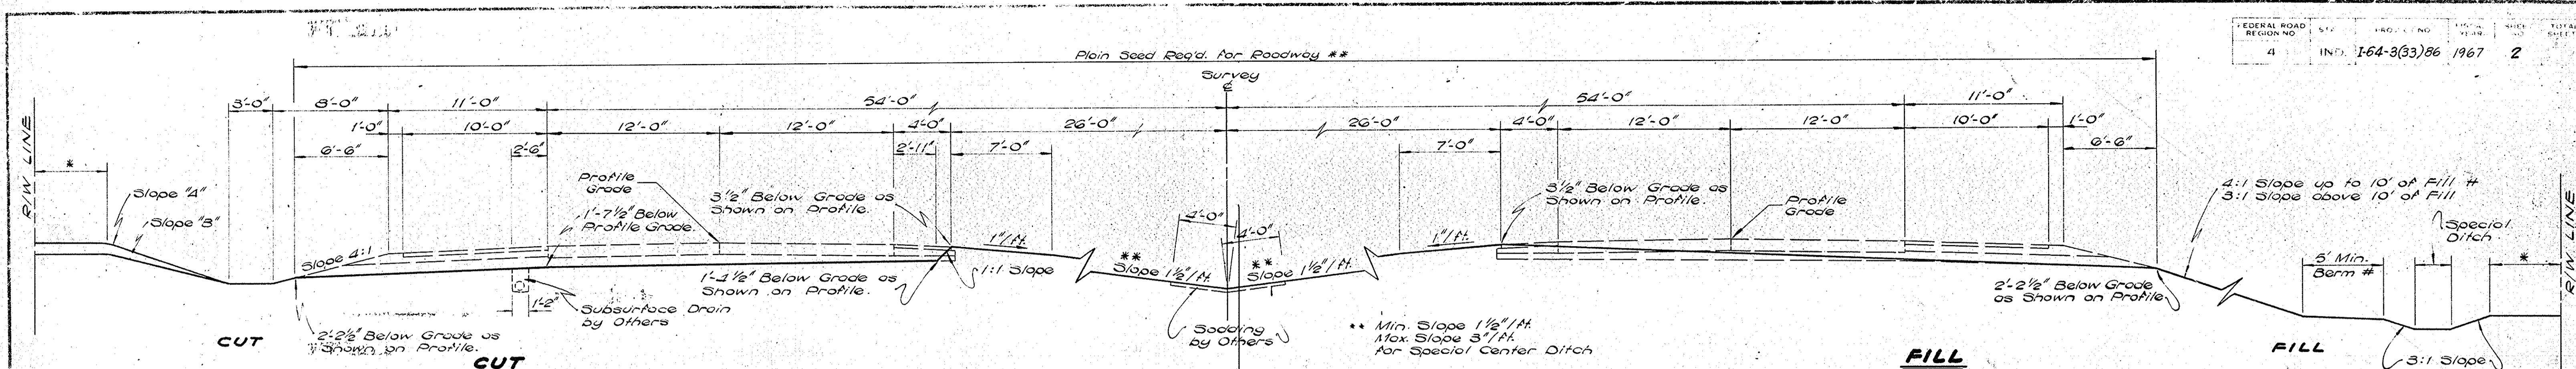


TYPICAL SECTION ON TANGENTS OR CURVES OF 0°-15° OR LESS
60' MEDIAN ①

CUT
 WESTBOUND ②
 EASTBOUND (REVERSED) ③

FILL
 EASTBOUND ④
 WESTBOUND (REVERSED) ⑤


Fill to be Difference in Elevation Between Shoulder Point and Toe of Slope.
 # Berm is not to be used with 4:1 Slope.
 * Minimum Desirable Distance 20' for 130' R/W (200' R/W Total)
 ** Plain Seeding Req'd. - 140#/Acre Agricultural Rye.

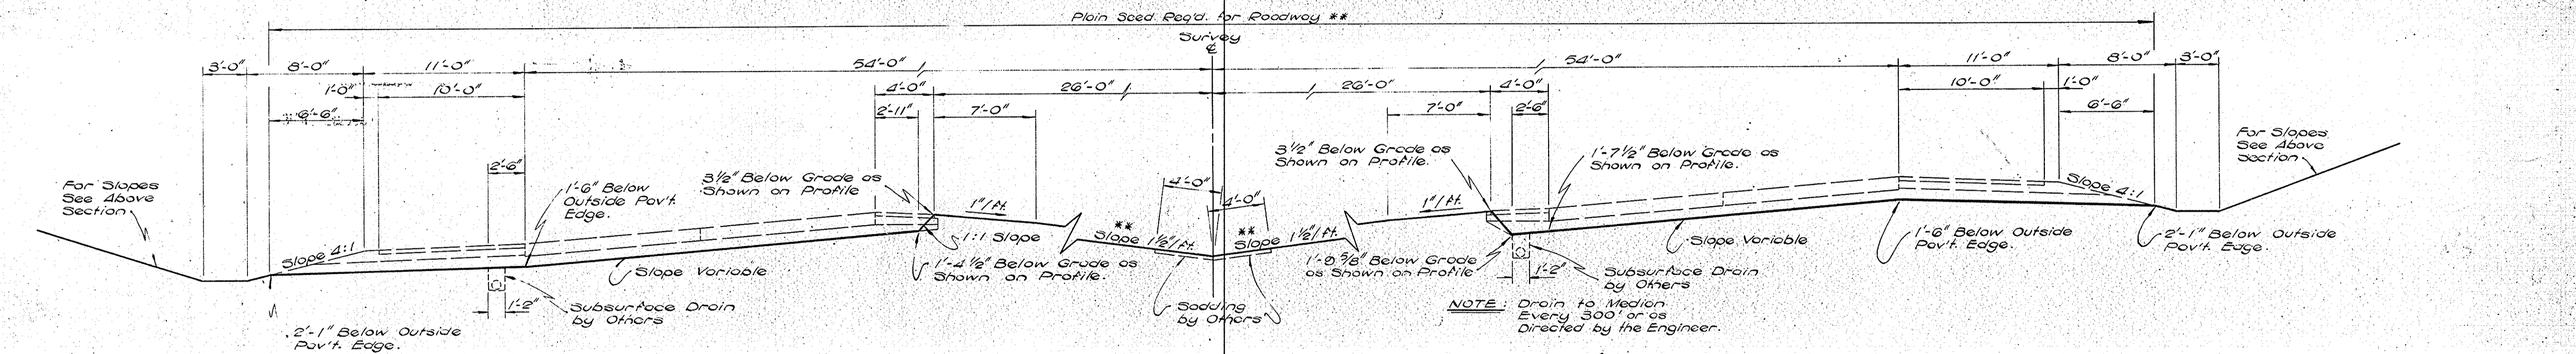

CUT TYPICAL SECTION FOR CURVES MORE THAN 0°-15°
60' MEDIAN ①
 (CURVES TO RIGHT REVERSED)

WESTBOUND CURVE LT. ⑥
 EASTBOUND CURVE RT. (REVERSED) ⑦

EASTBOUND CURVE LT. ⑧
 WESTBOUND CURVE RT. (REVERSED) ⑨

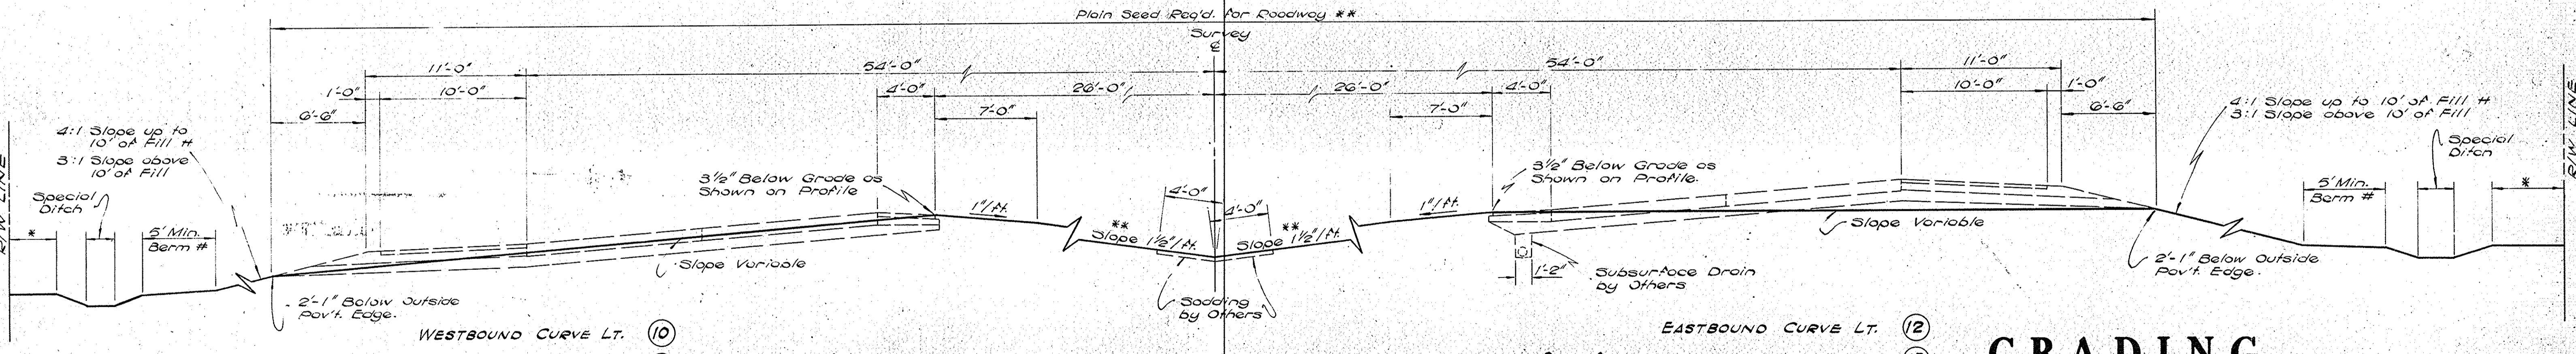

FILL TYPICAL SECTION FOR CURVES MORE THAN 0°-15°
60' MEDIAN ①
 (CURVES TO RIGHT REVERSED)


WESTBOUND CURVE LT. ⑩
 EASTBOUND CURVE RT. (REVERSED) ⑪

EASTBOUND CURVE LT. ⑫
 WESTBOUND CURVE RT. (REVERSED) ⑬





GRADING TYPICAL CROSS SECTIONS

SCALE: 3/16" = 1'-0"

SUBMITTED FOR APPROVAL

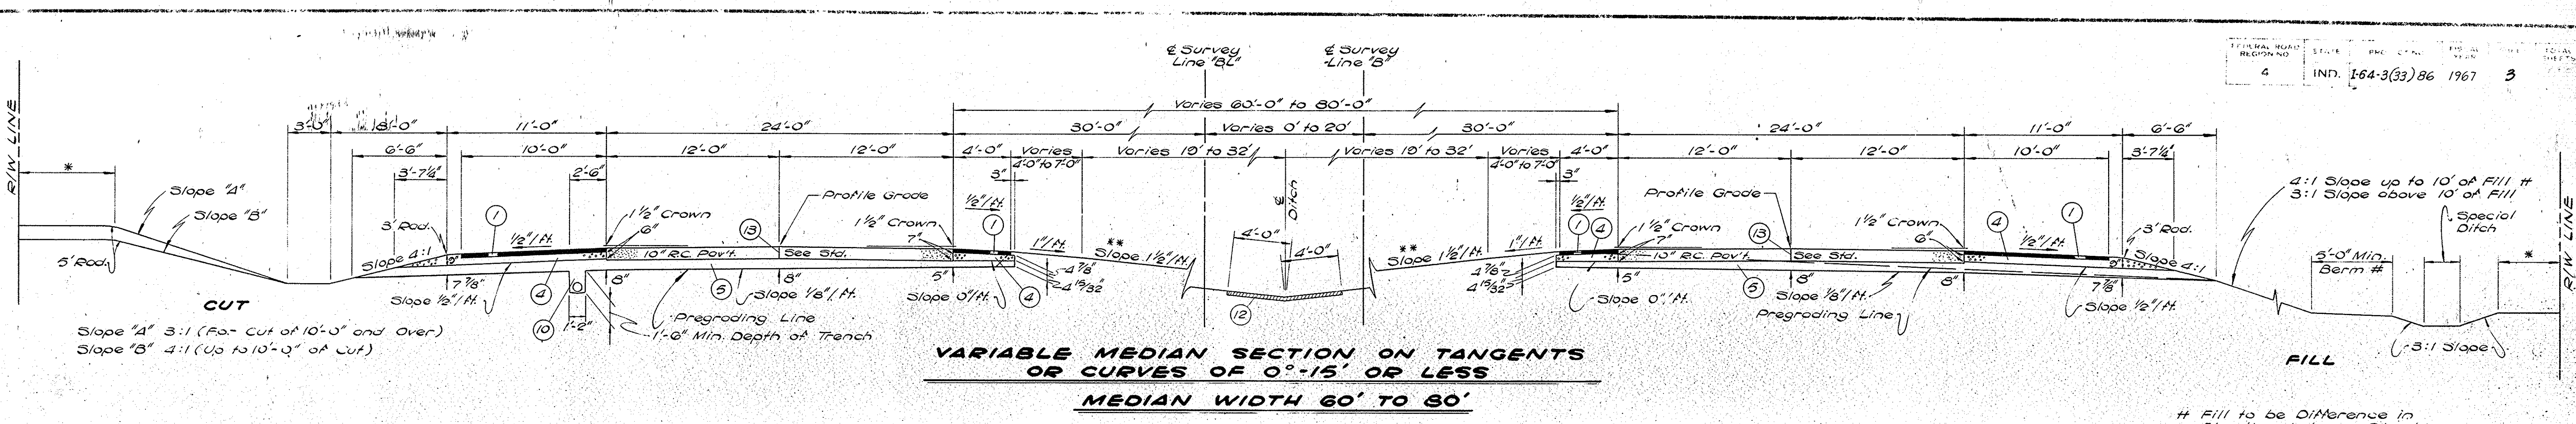

Fill to be Difference in Elevation between Shoulder Point and Toe of Slope.
 # Berm is not to be used with 4:1 Slope.
 * Minimum Desirable Distance 20' for 130' R/W (260' R/W Total).
 ** Min. Slope 1/2"/ft. Max. Slope 3"/ft. for Special Center Ditch.

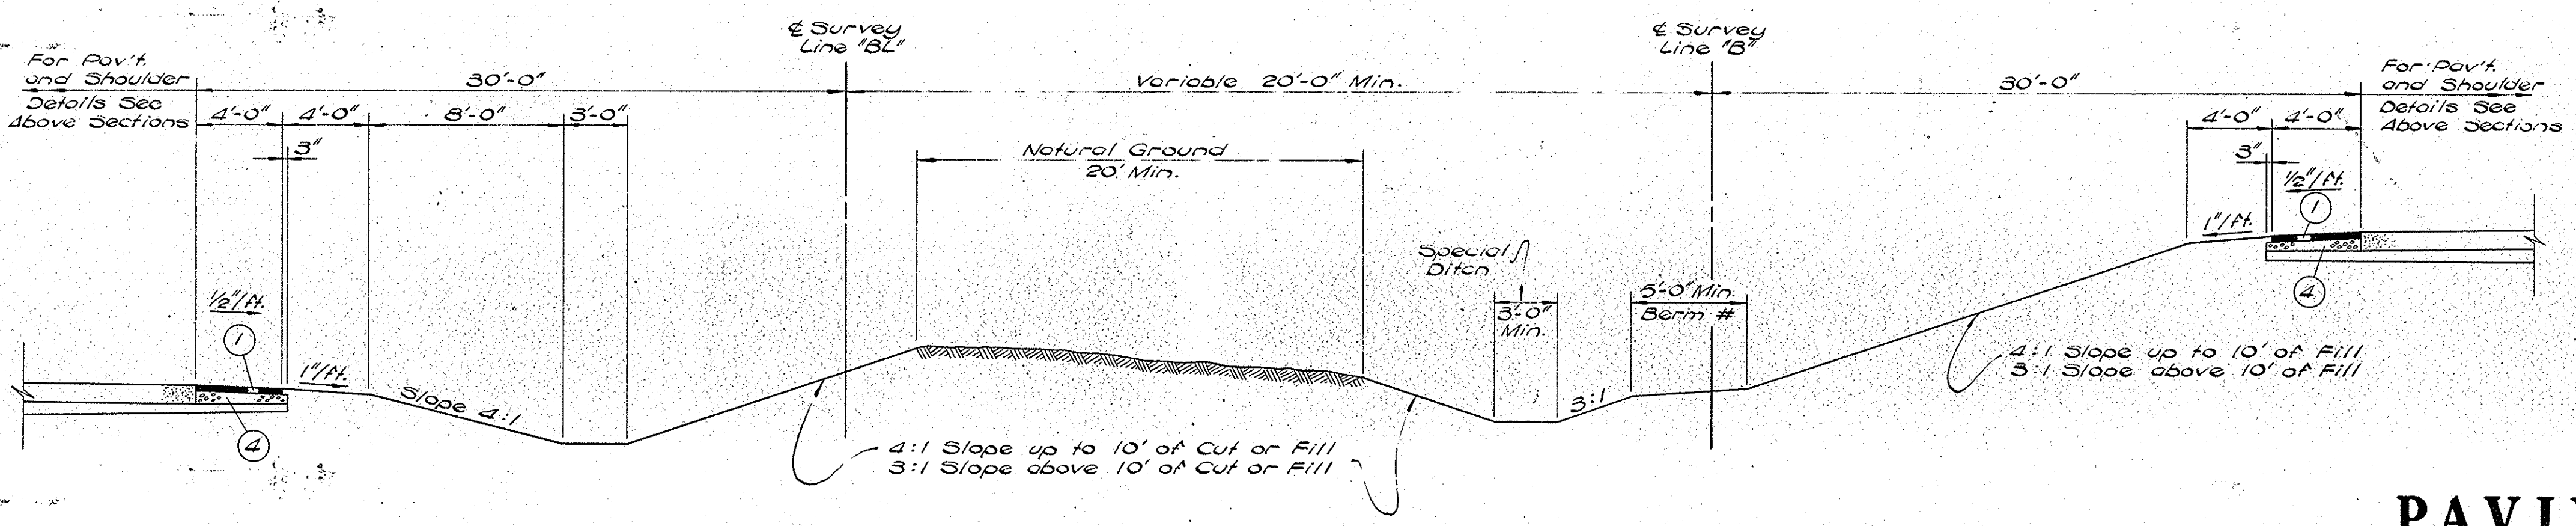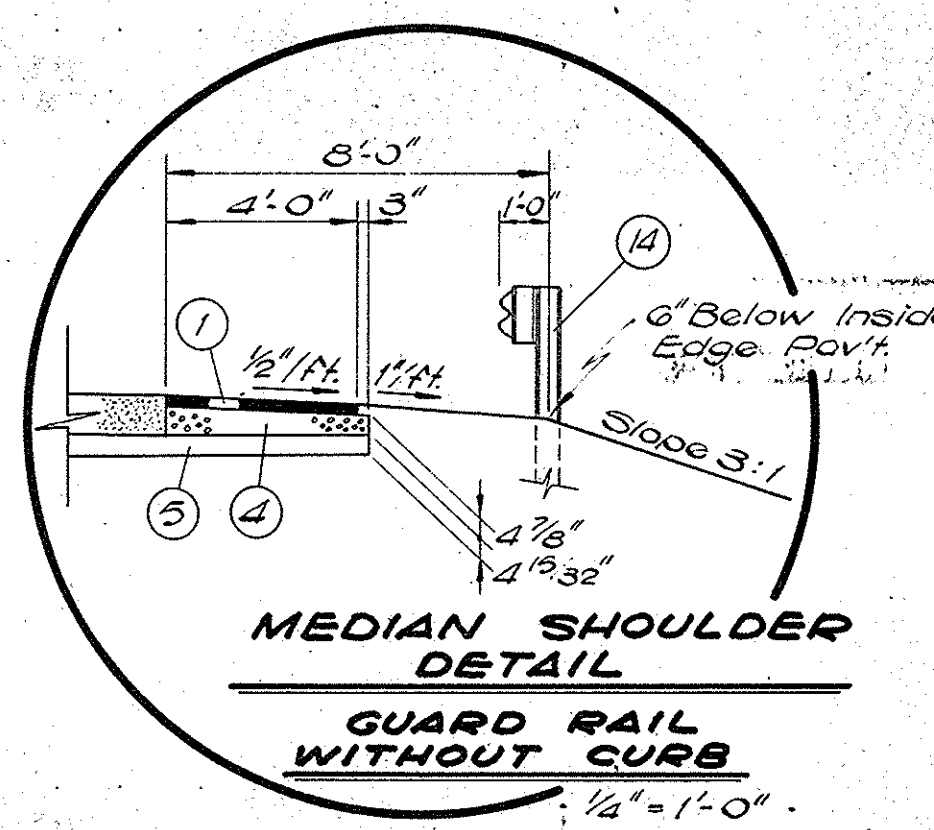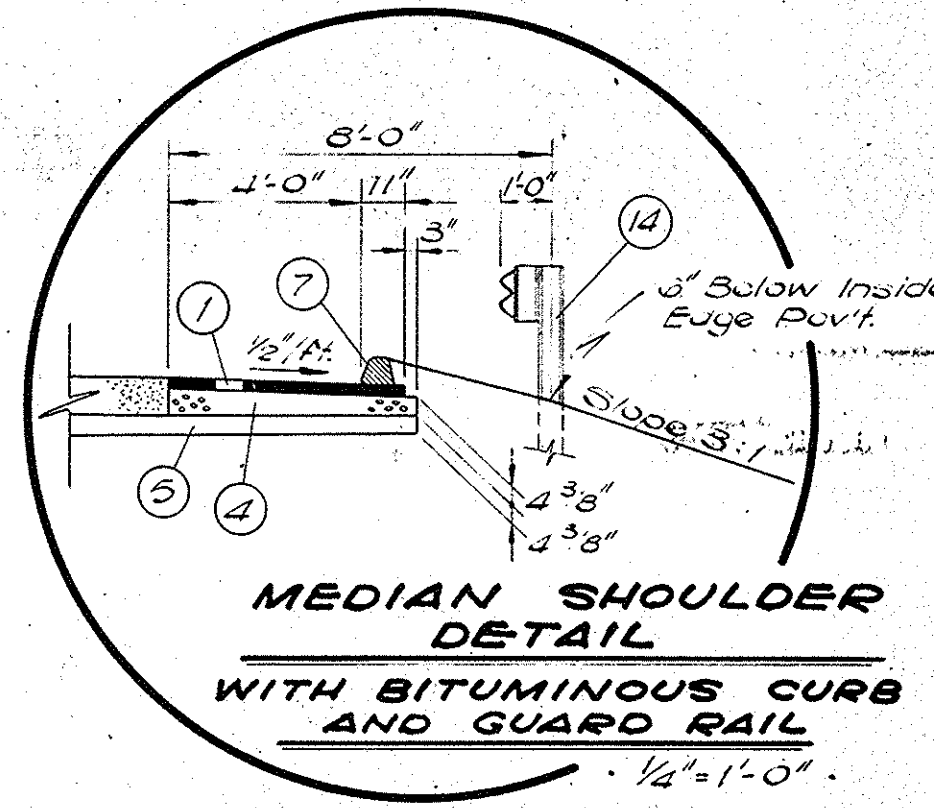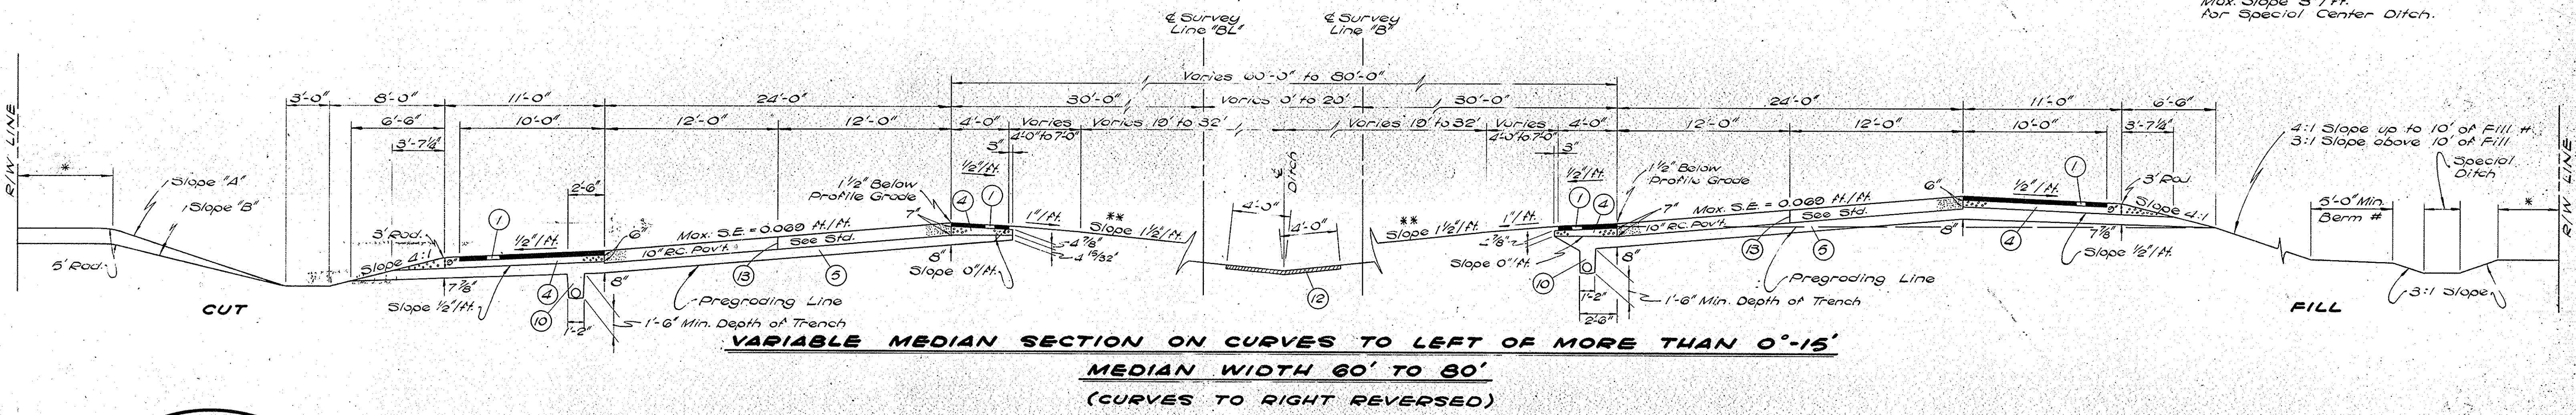


- LEGEND**
- (1) 3" Bituminous Shoulder
 - (4) Type "D" Compacted Aggregate Base
 - (5) Subbase Type II
 - (7) Bituminous Curb
 - (10) Subsurface Drain - See Misc. Std. Sheet "N"
 - (12) Sodding
 - (13) Longitudinal Joint
 - (14) Straight Beam Guard Rail


PAVING TYPICAL CROSS SECTIONS

SCALE: 3/16" = 1'-0"


SUBMITTED FOR APPROVAL

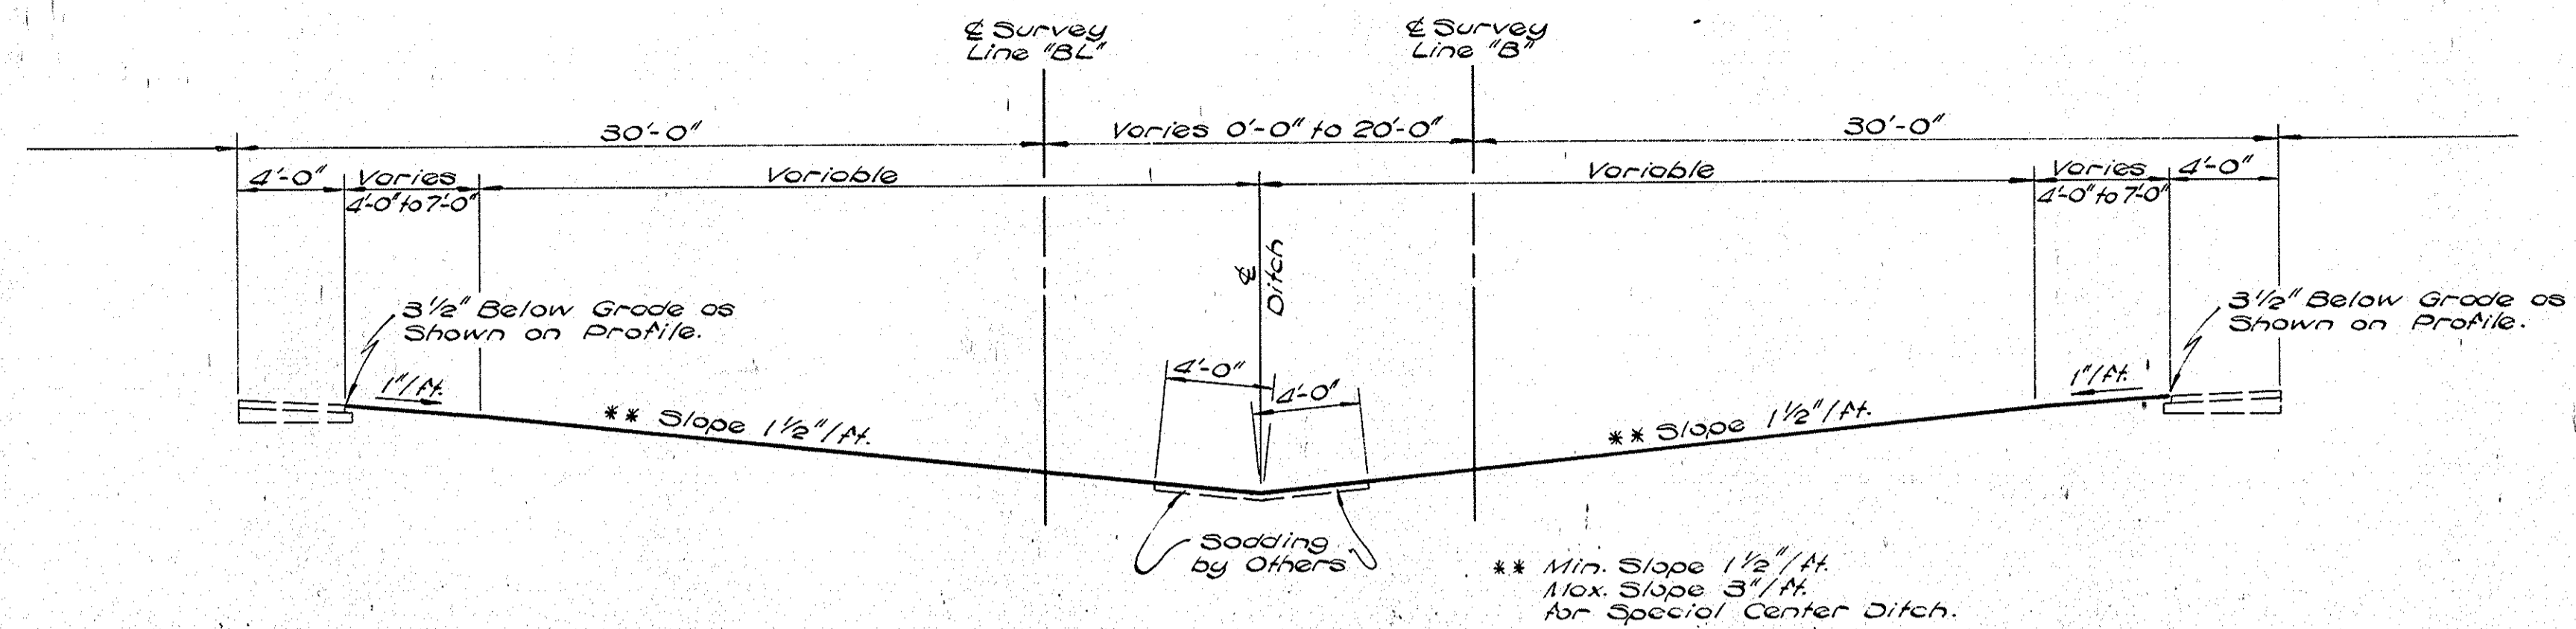

MEDIAN SECTION IN CUT OR FILL
MEDIAN WIDTH 60' TO 80' (14)

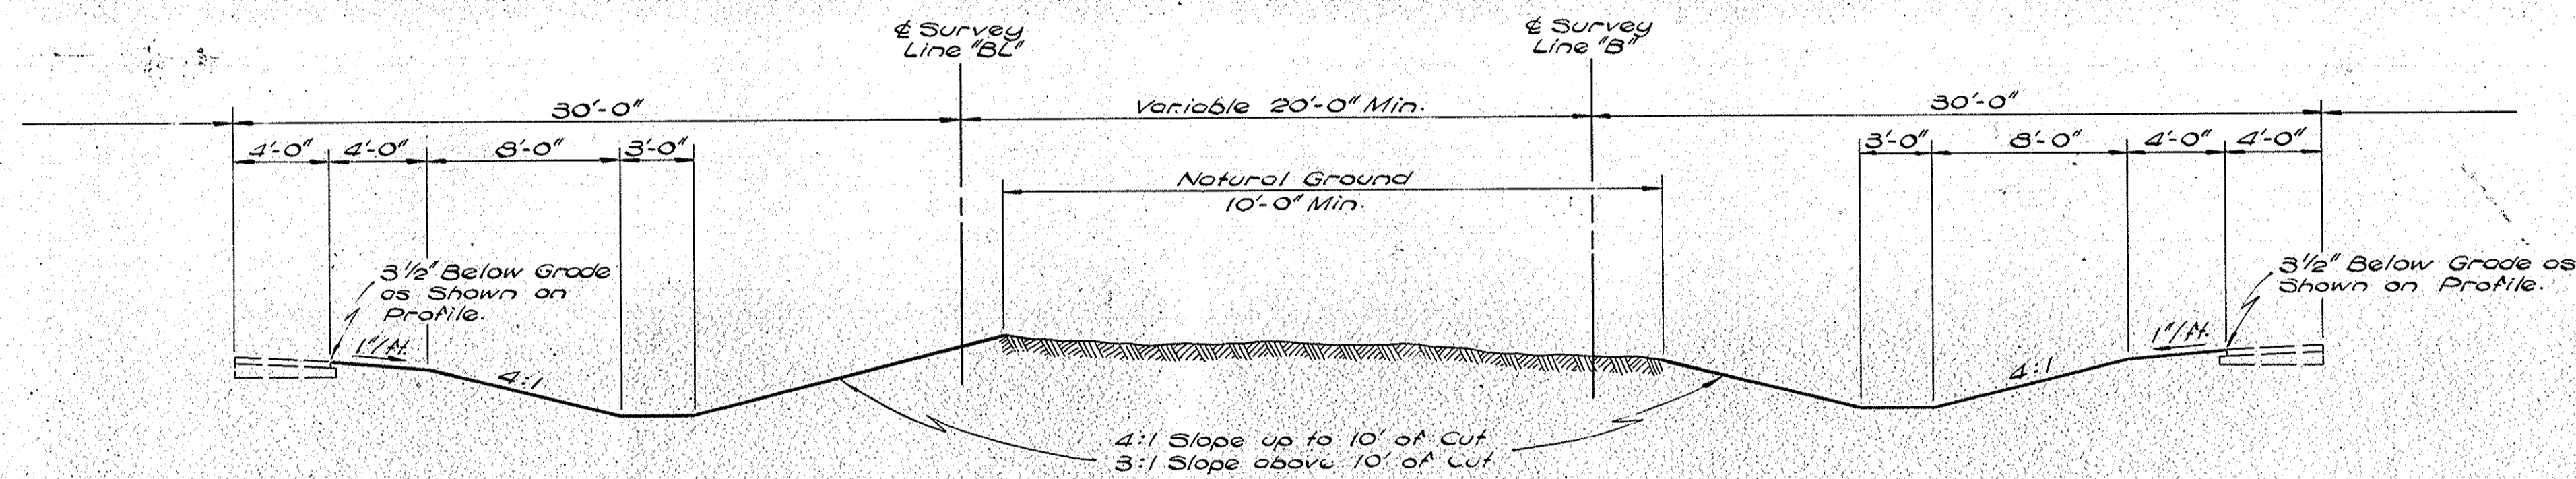

MEDIAN SECTION IN CUT
MEDIAN WIDTH OVER 80'




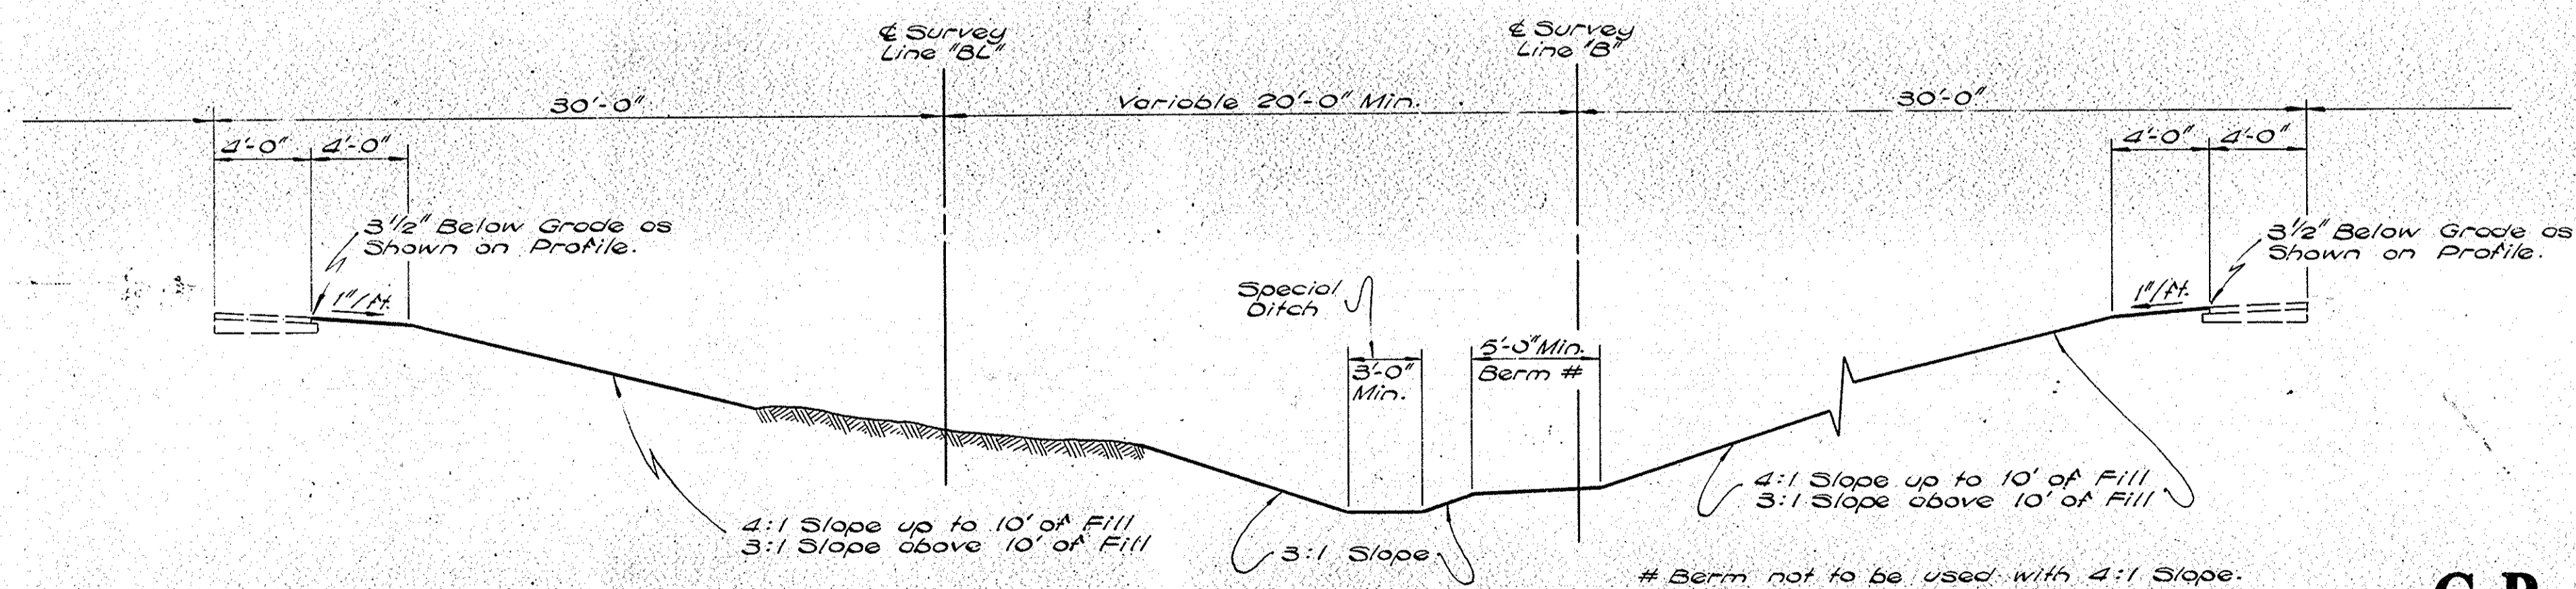


MEDIAN SECTION IN FILL
WHERE SLOPES DO NOT INTERSECT

GRADING TYPICAL CROSS SECTIONS

SCALE: 3/16" = 1'-0"


SUBMITTED FOR APPROVAL

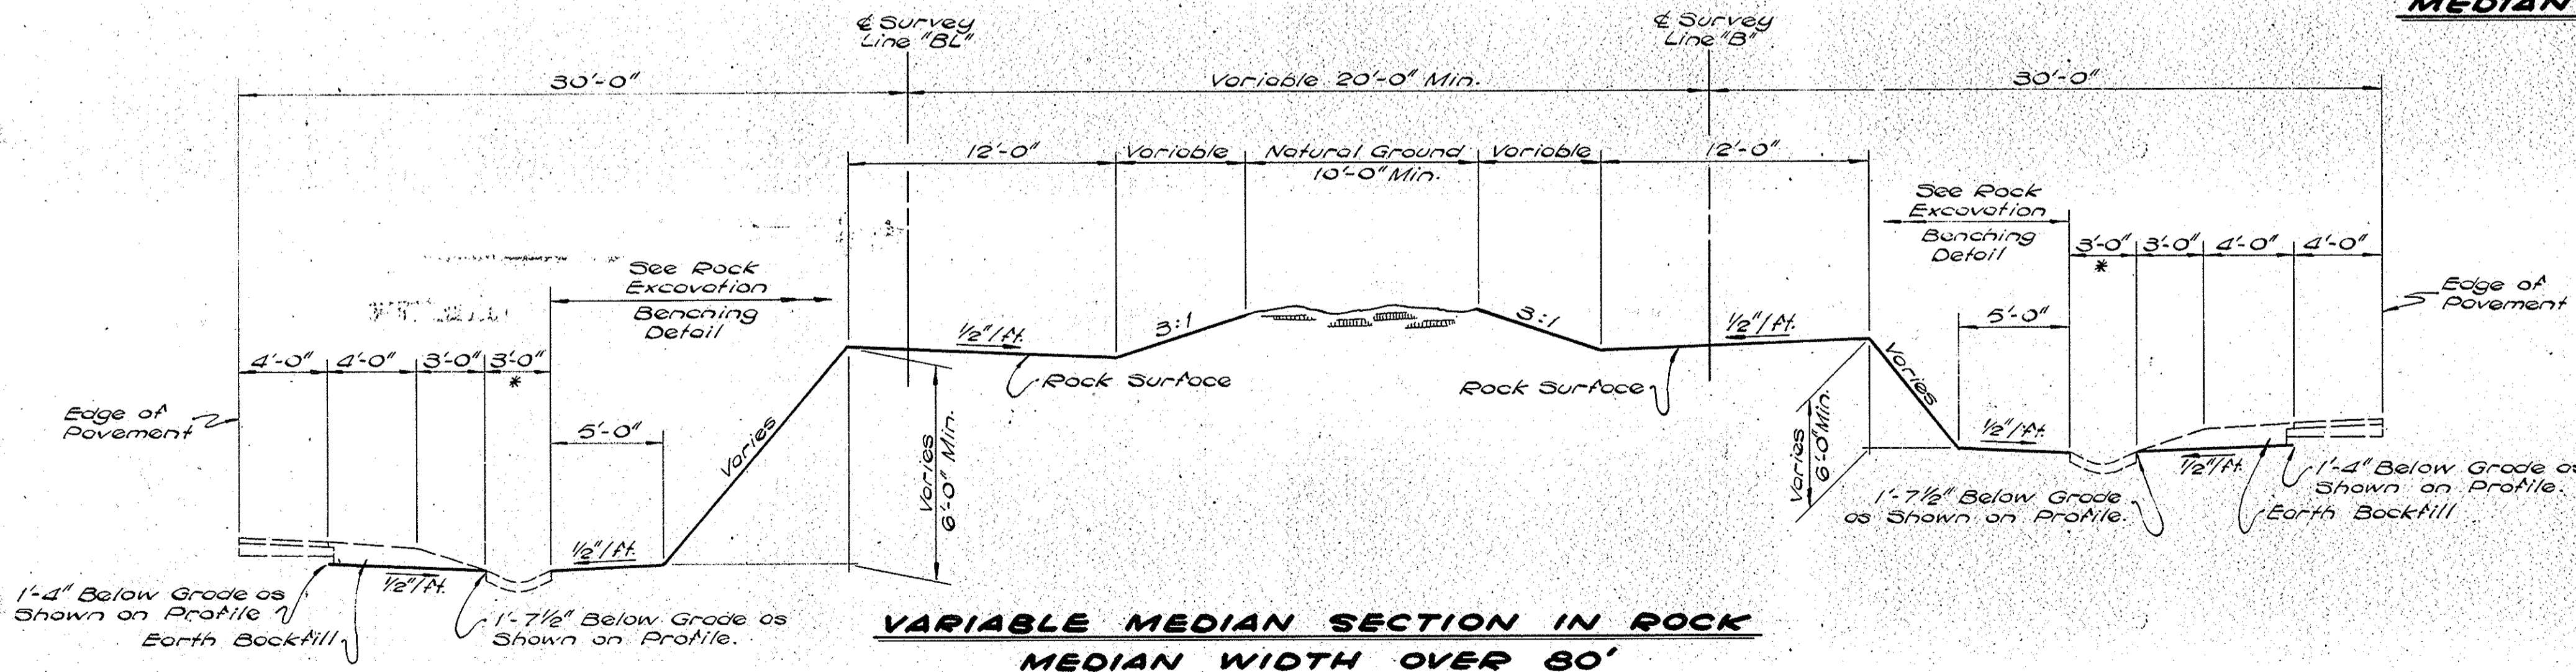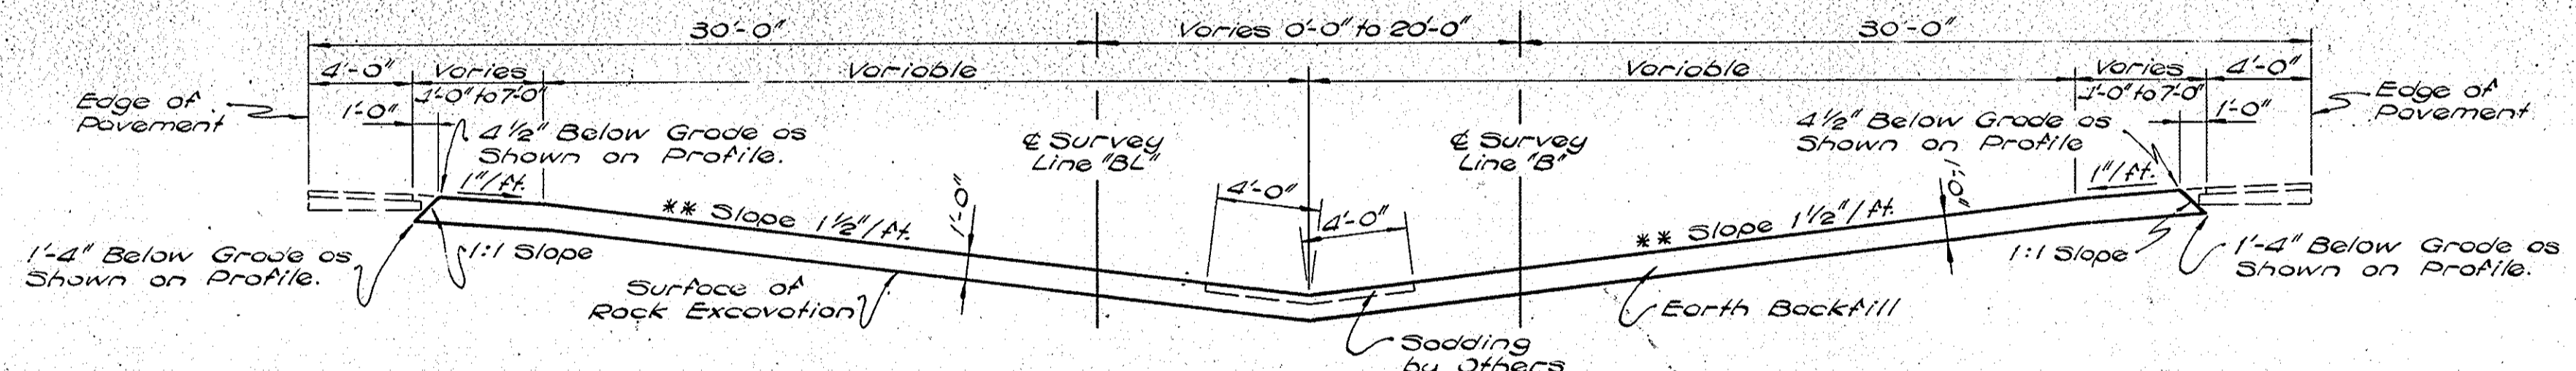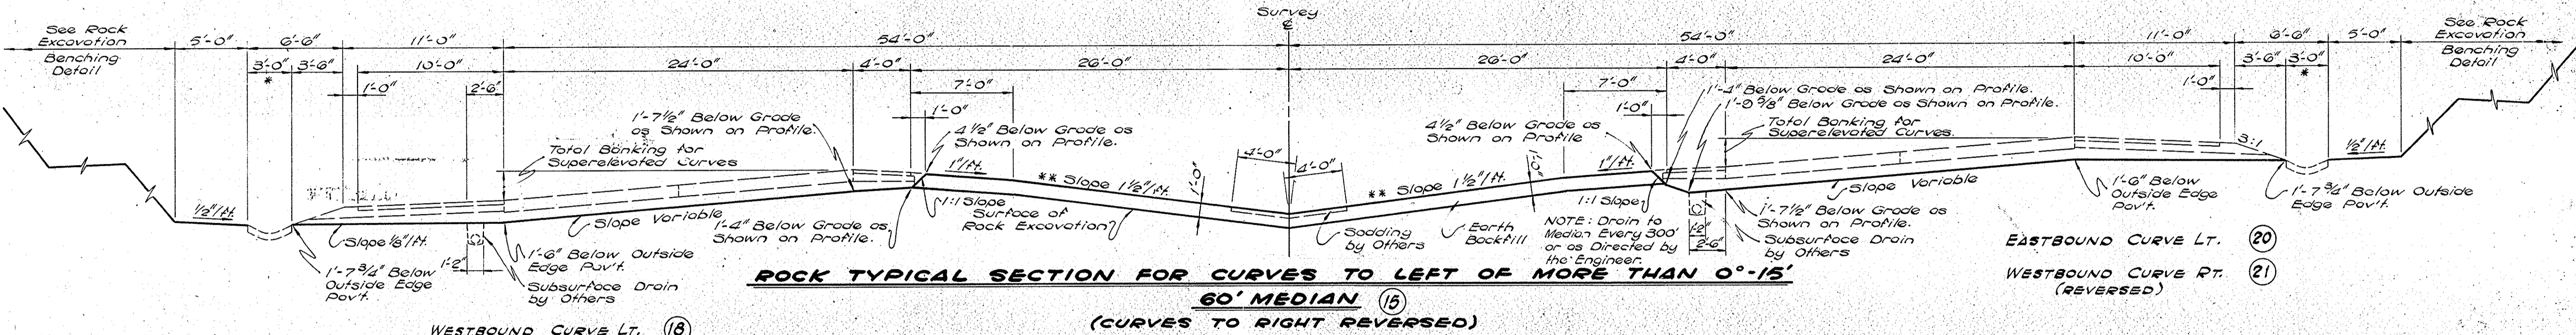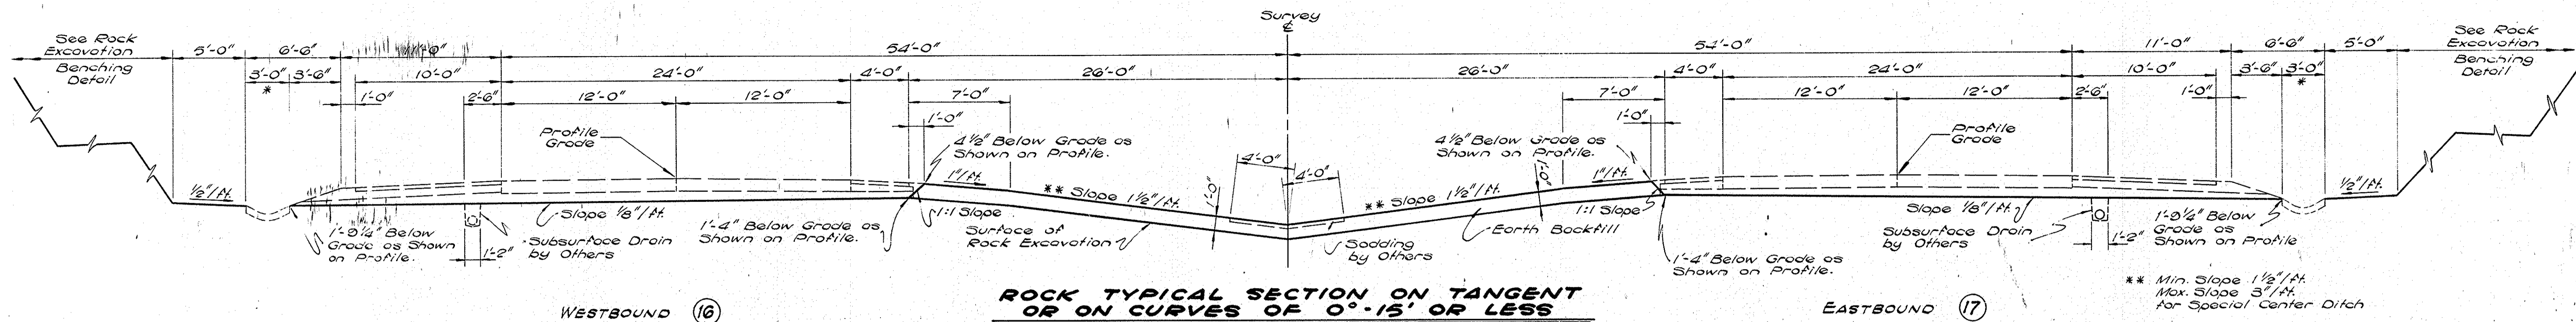




GRADING TYPICAL CROSS SECTIONS

SCALE: 3/16" = 1'-0"

SUBMITTED FOR APPROVAL

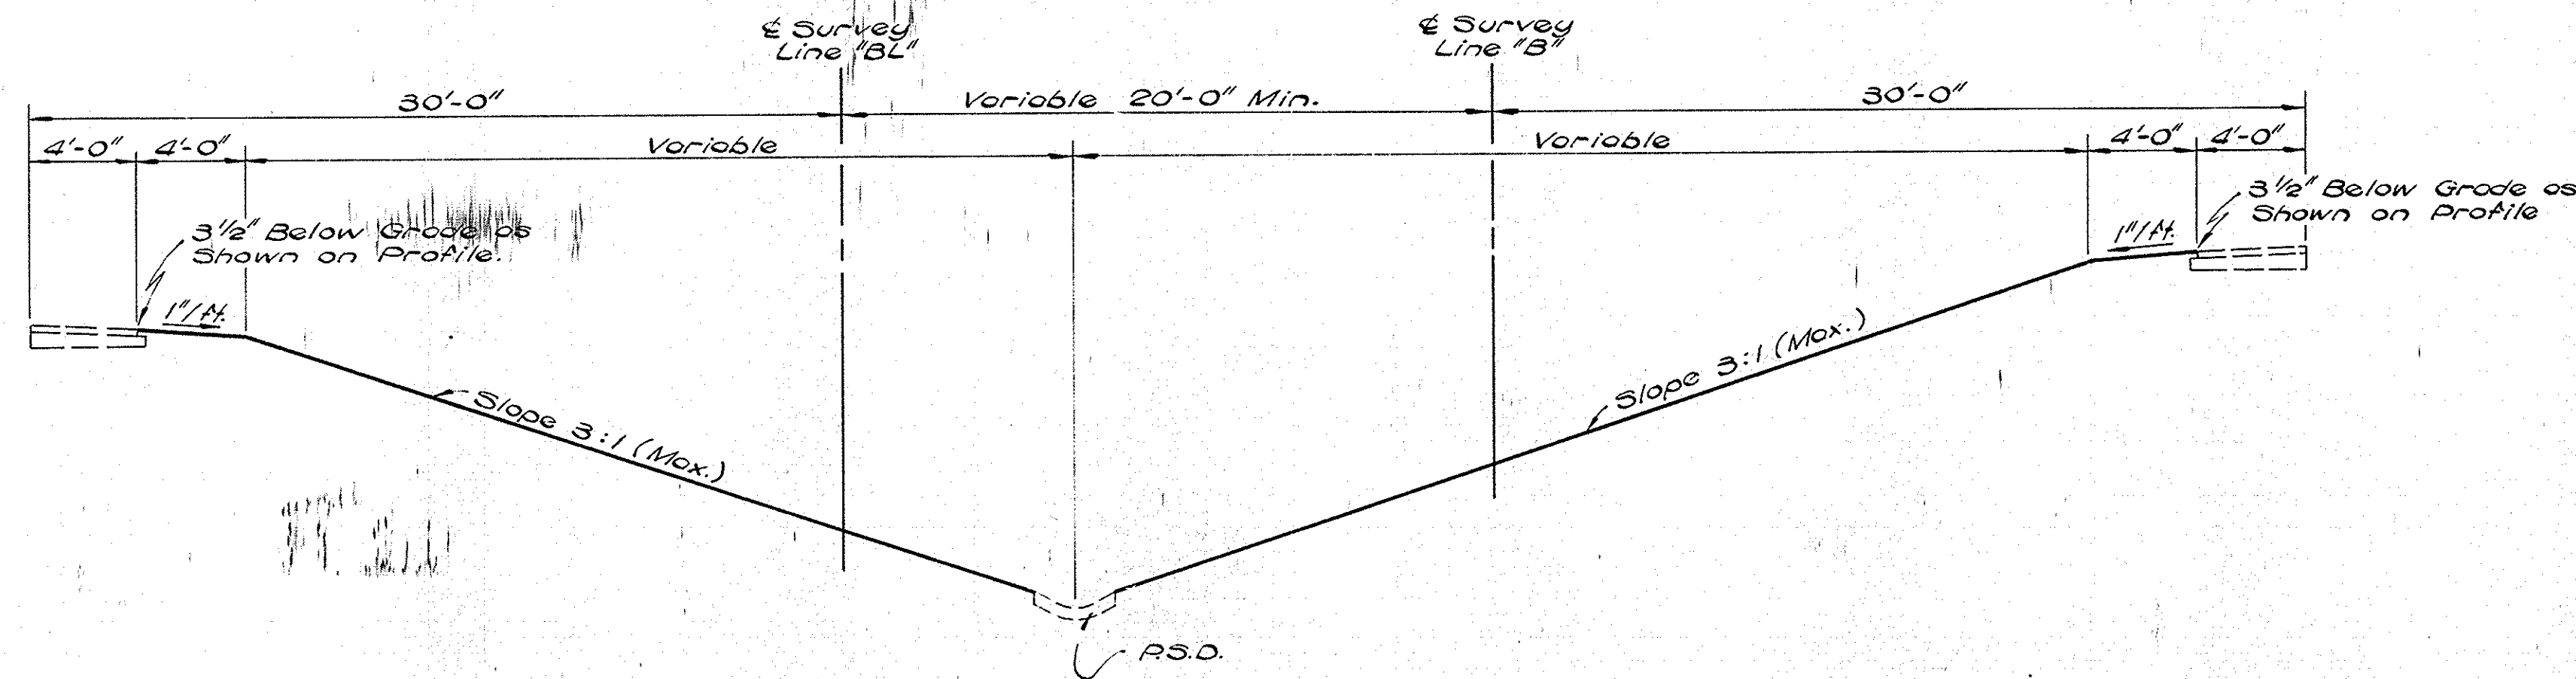

**MEDIAN SECTION IN FILL
WHERE SLOPES INTERSECT**

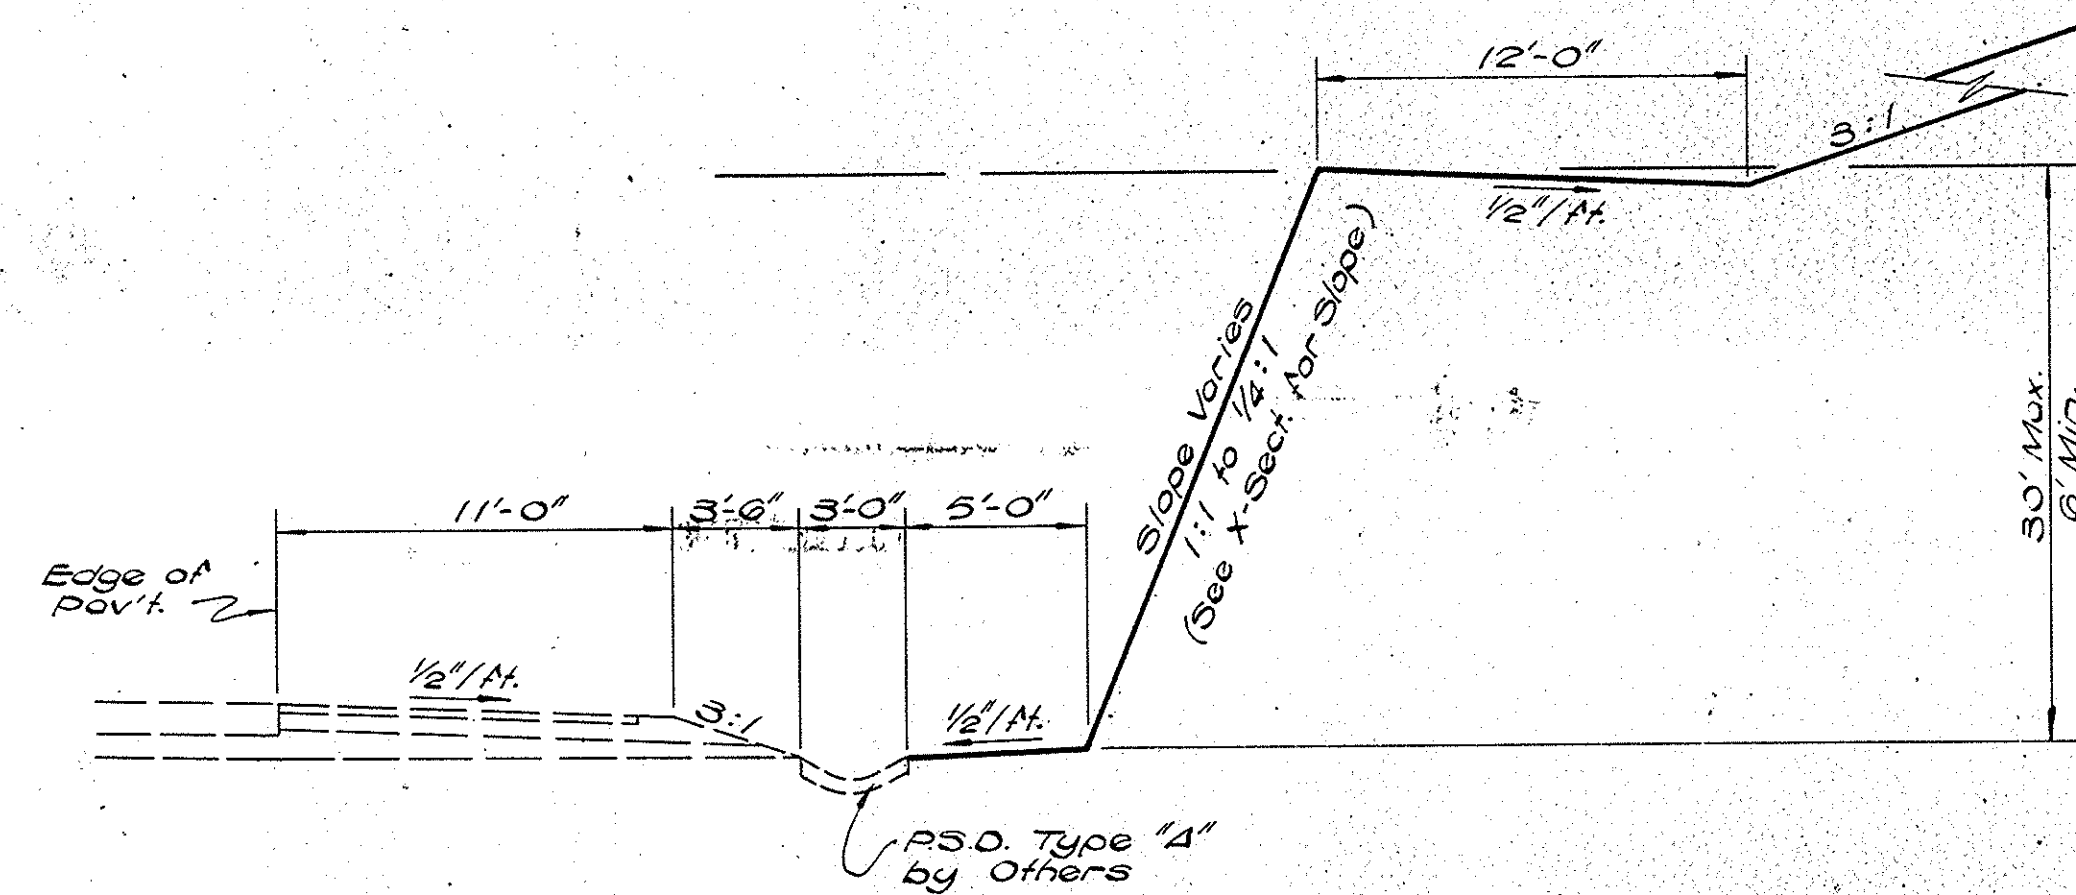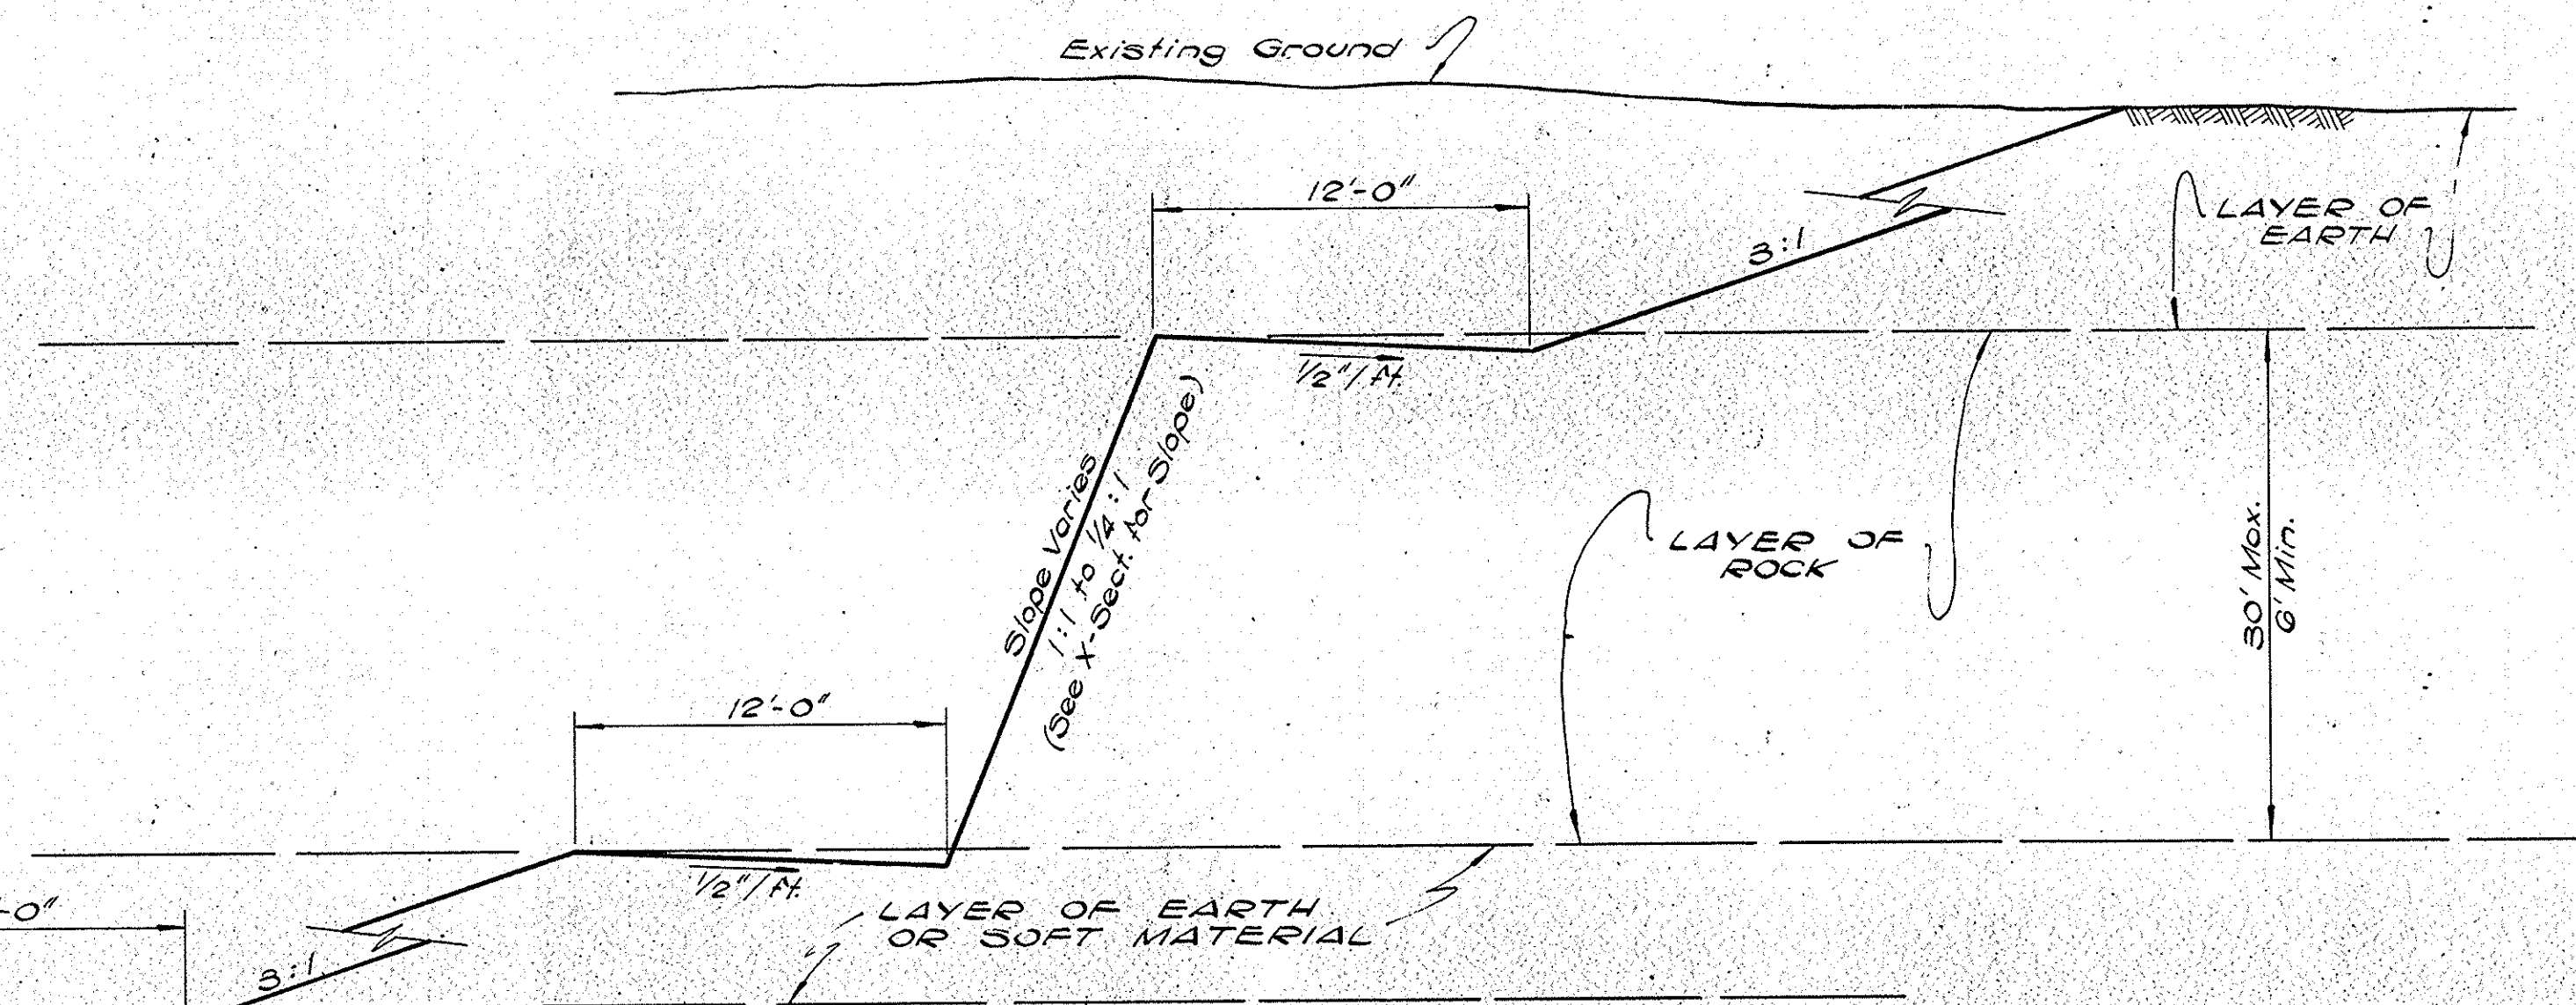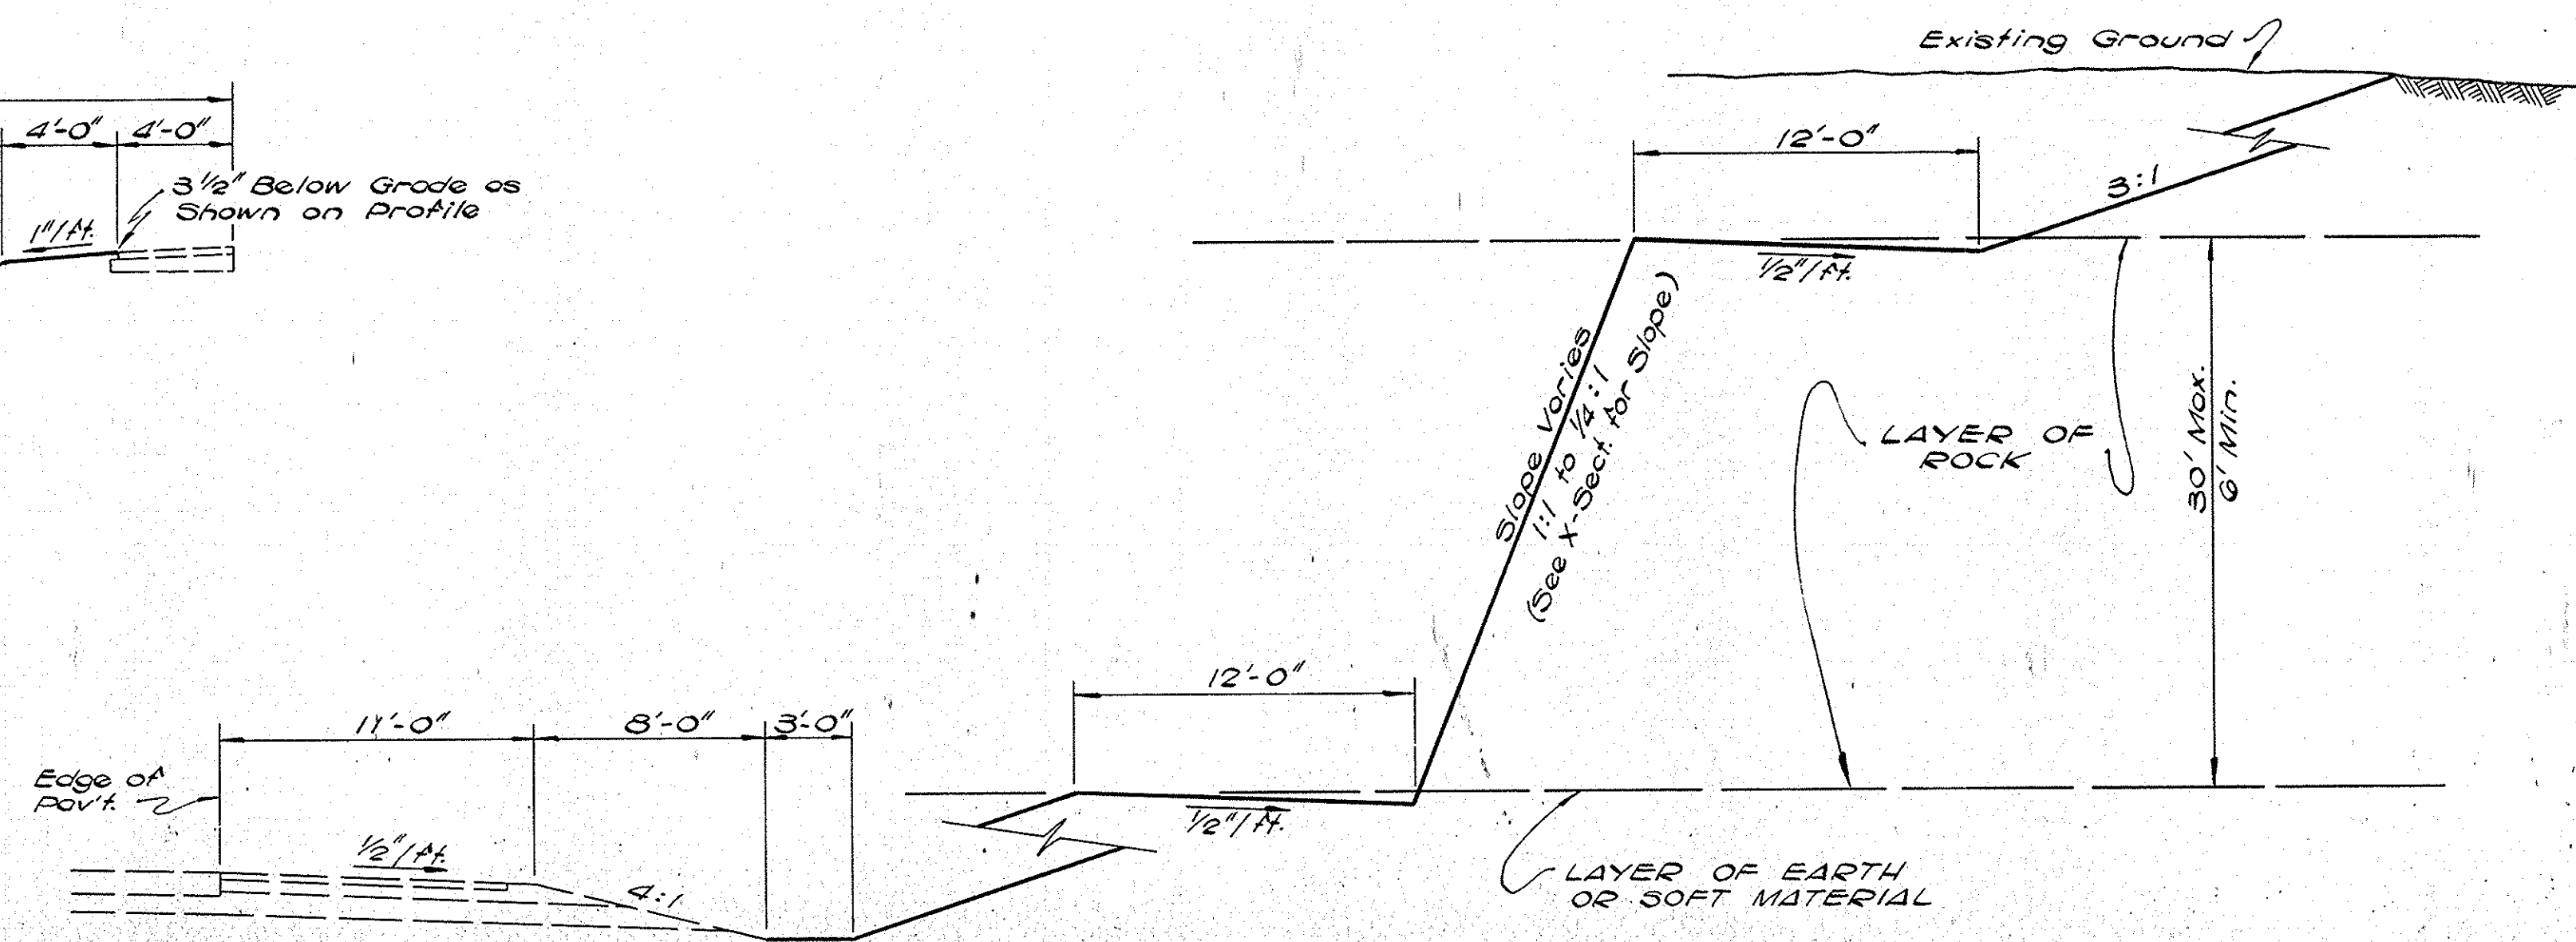



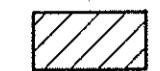



GRADING TYPICAL CROSS SECTIONS


SCALE: 3/16" = 1'-0"

SUBMITTED FOR APPROVAL

ENGINEER OF ROAD DESIGN, IND. STATE HIGHWAY COMMISSION

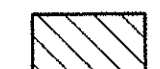
LEGEND

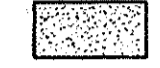-  Rock Cut
 -  Earth Cut
 -  Rock Fill
 -  Earth Backfill
 -  #7 Aggregate
 -  #14 Sand
- Pay Item: Aggregate for Subsurface Drain.

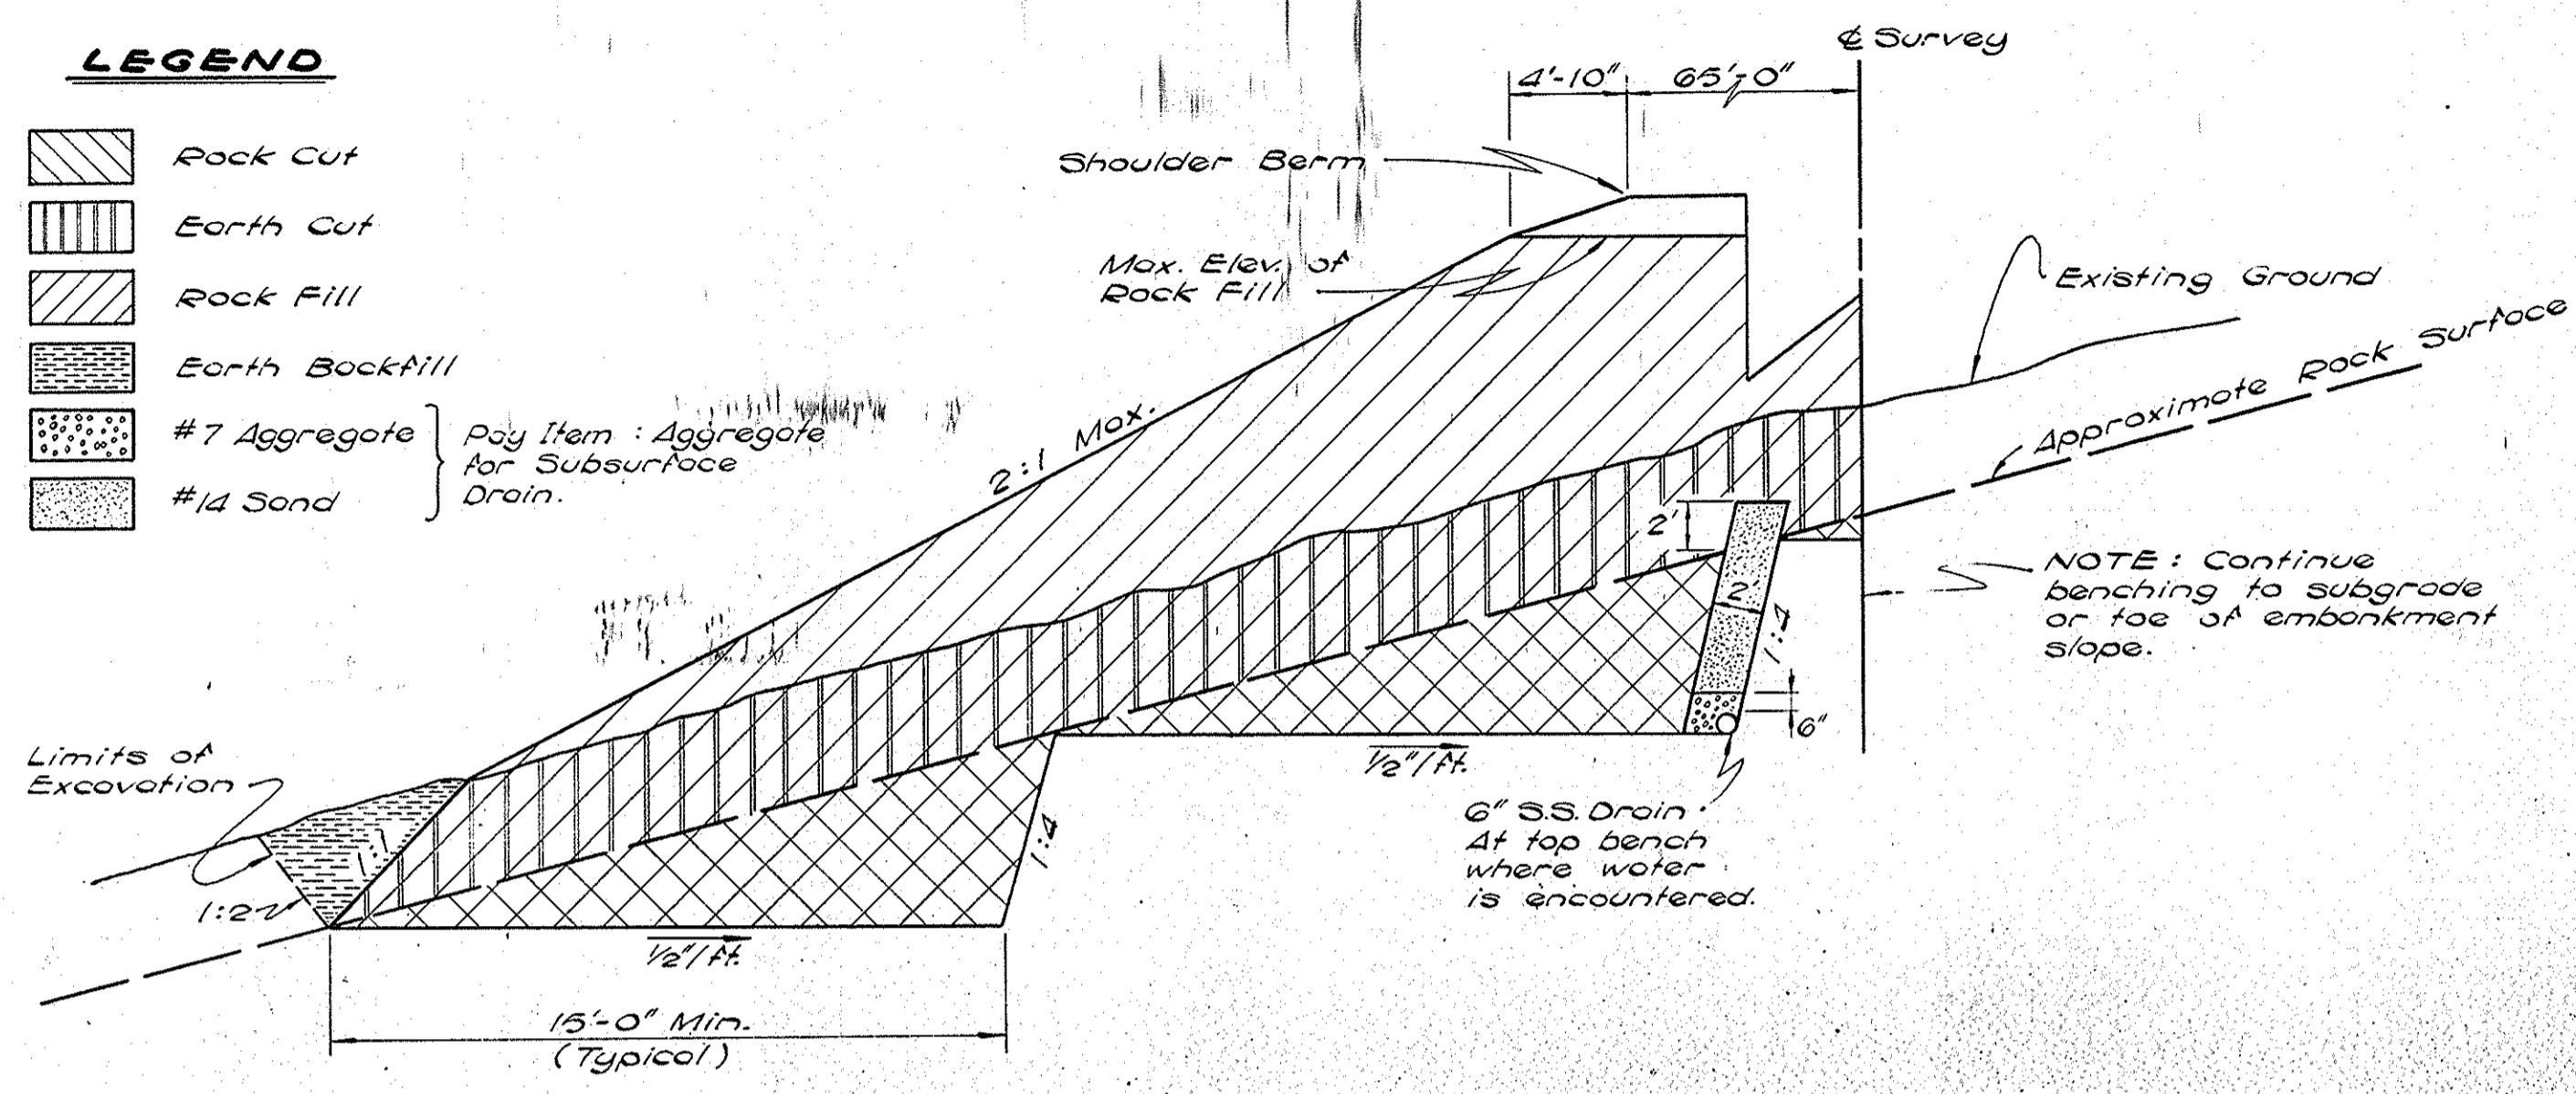


ROCK BENCH AND ROCK FILL BUTTRESS DETAIL FOR EMBANKMENT ON SIDHILL LOCATIONS

NOTE: Rock back slopes may vary from 1/4:1 to 1:1 as directed by the Engineer after rock is exposed. See Cross Sections for Design Slopes.

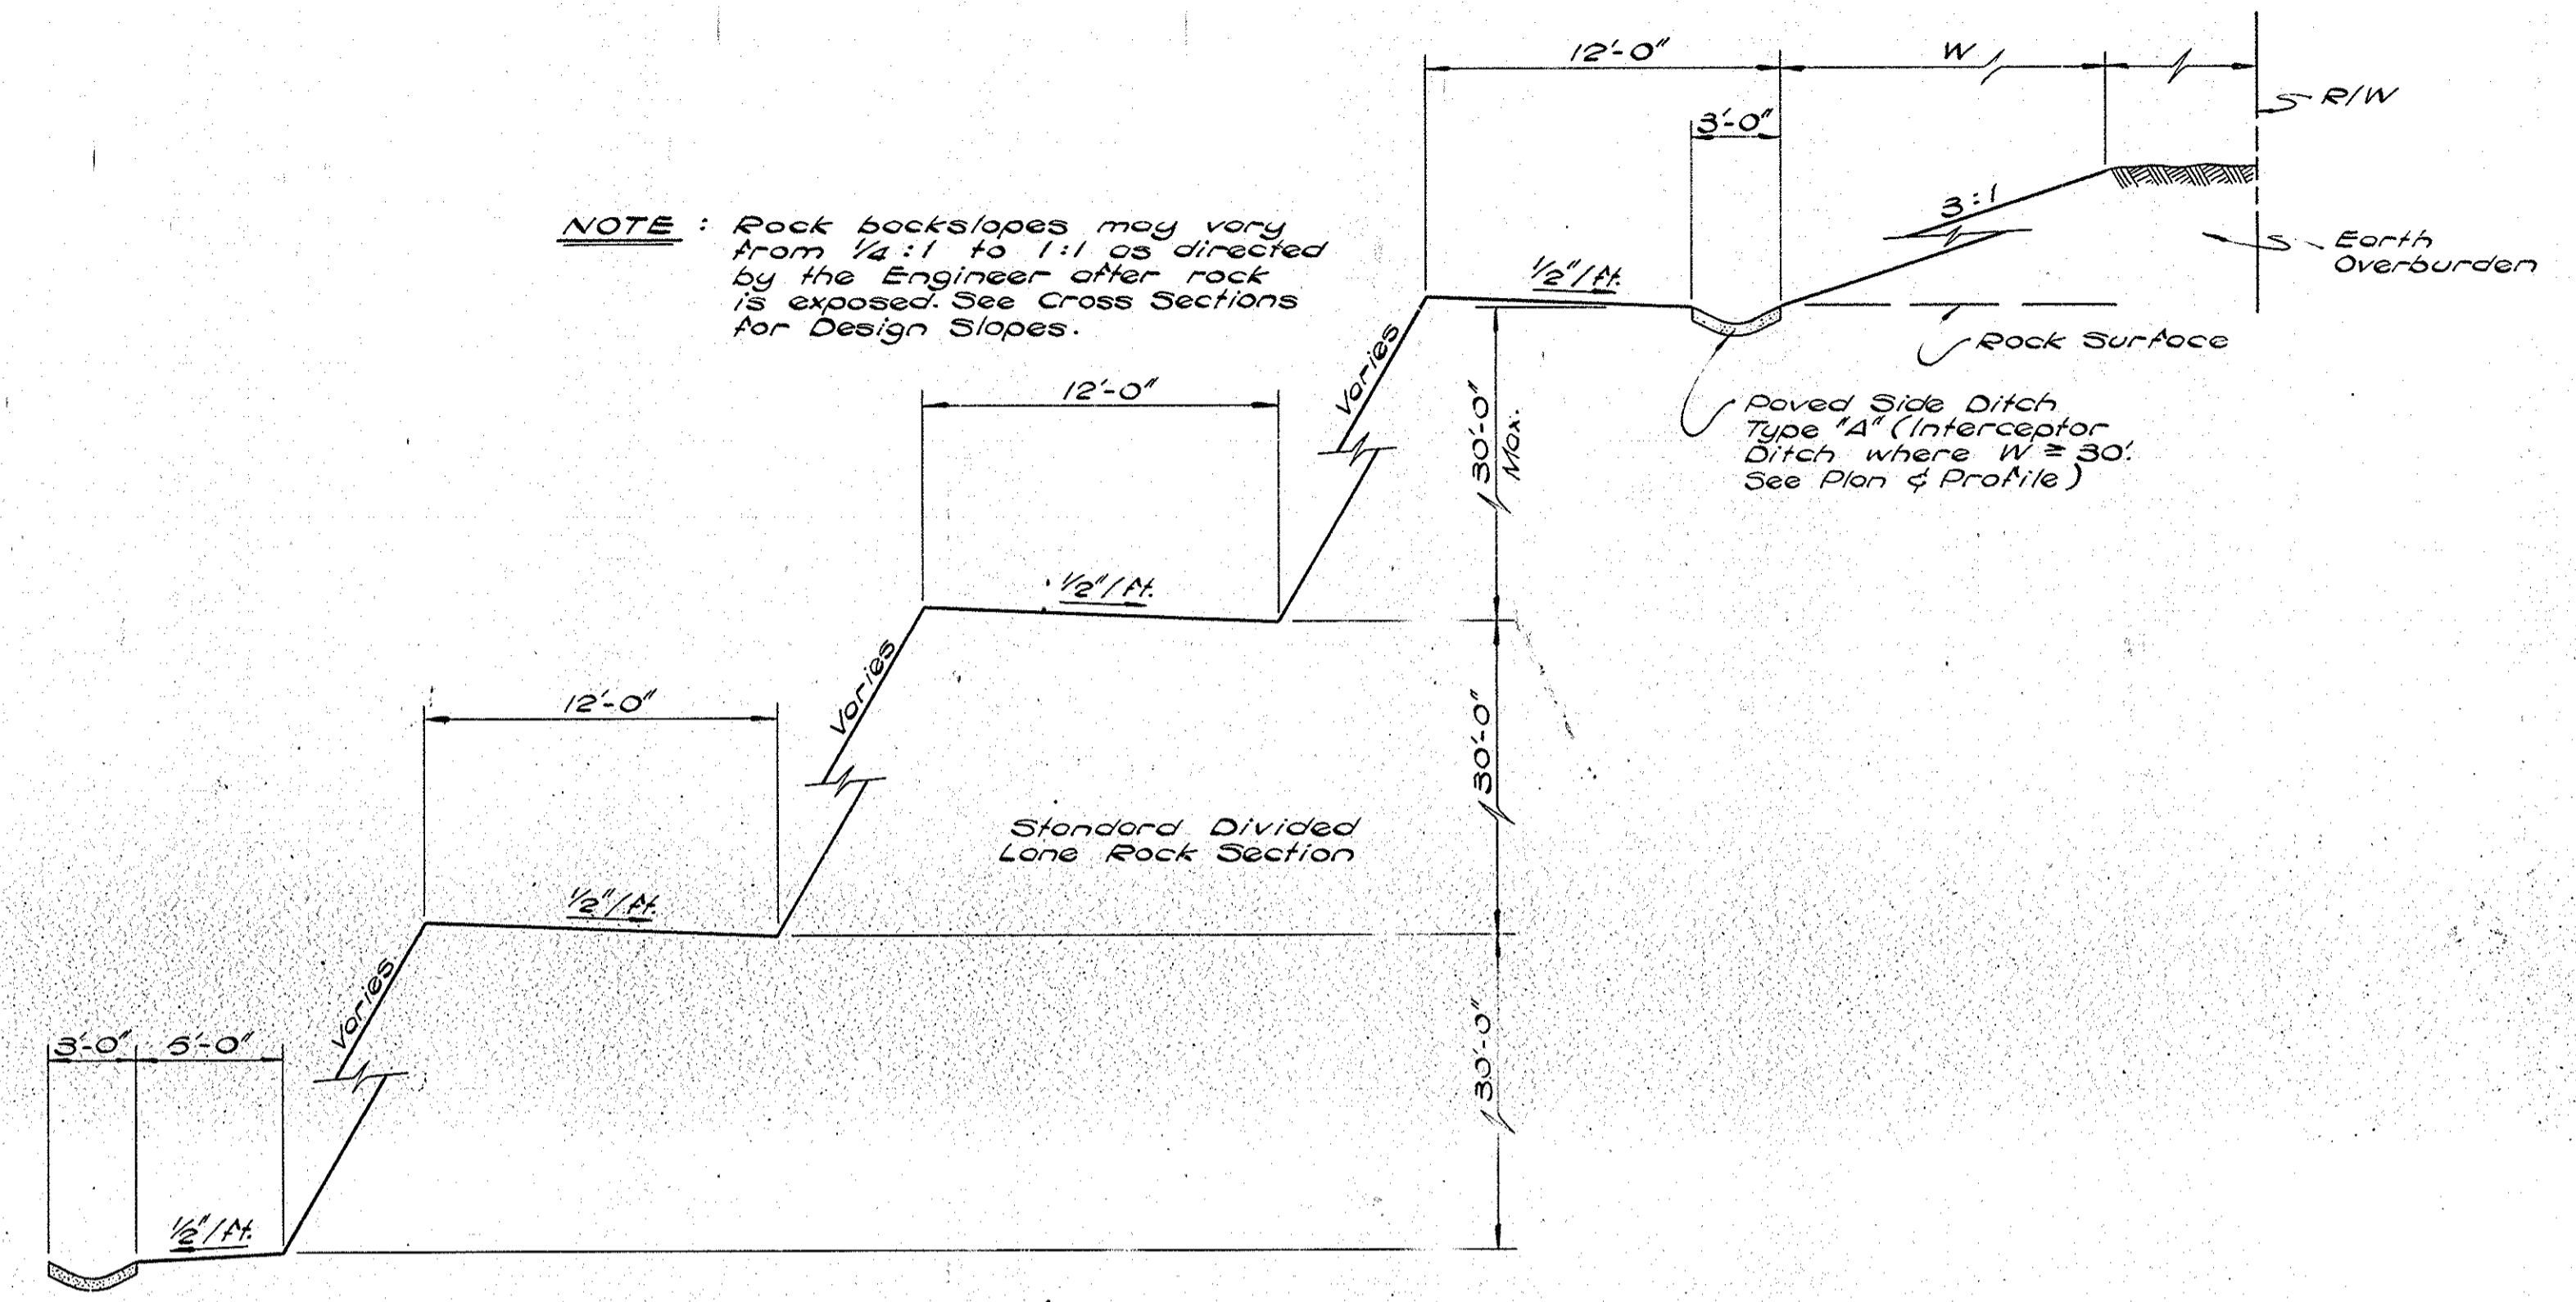



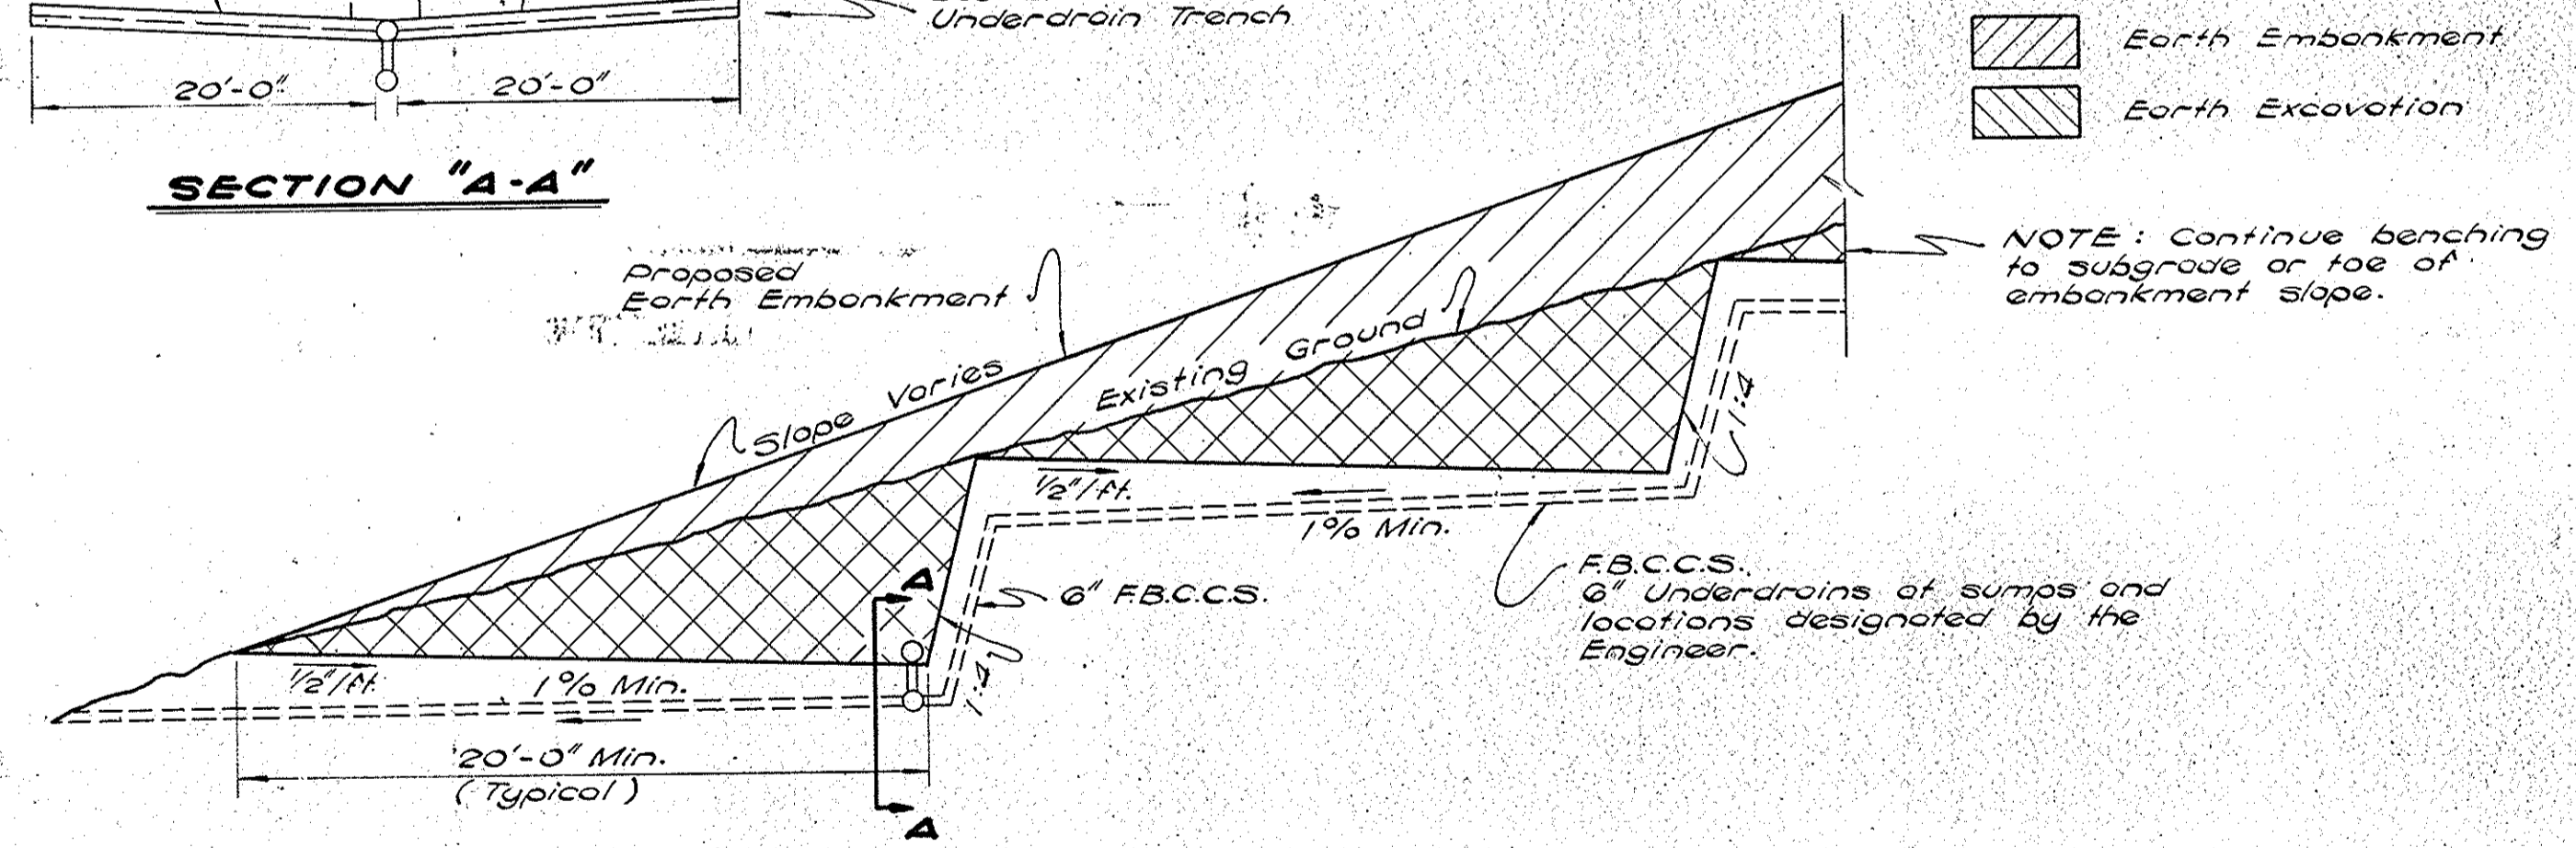
ROCK EXCAVATION MULTIPLE BENCHING DETAIL

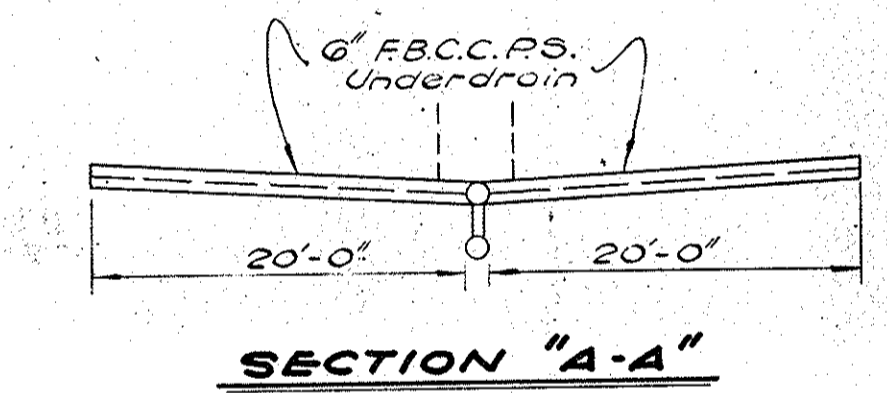


SECTION "A-A"

LEGEND

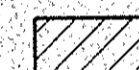-  Earth Embankment
-  Earth Excavation



EARTH BENCH DRAINAGE DETAIL FOR EMBANKMENT ON SIDHILL LOCATIONS

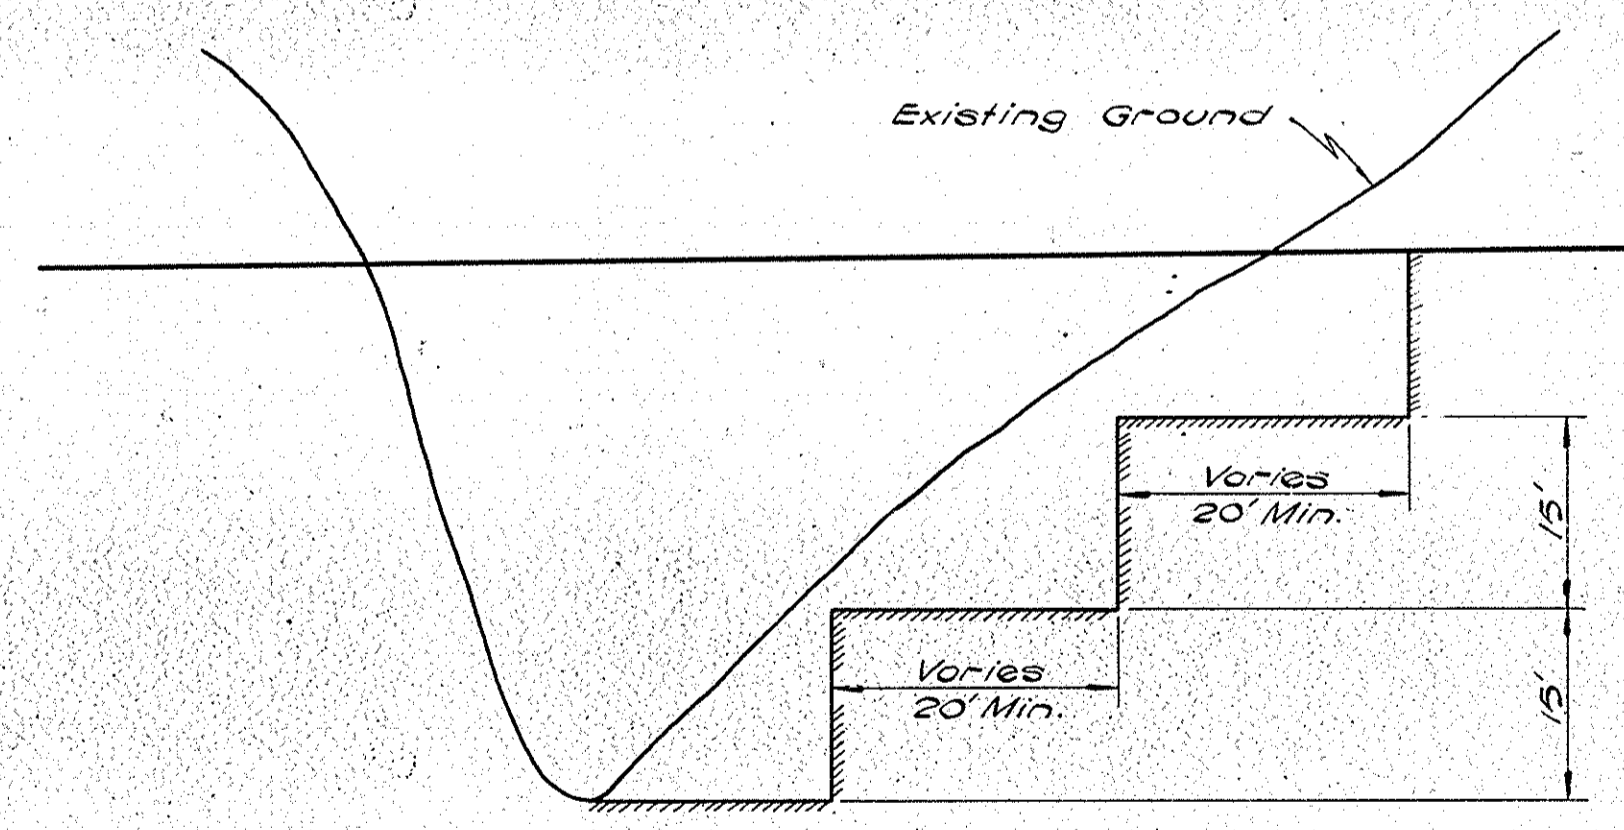

TYPICAL TRANSVERSE BENCHING DETAIL


GRADING TYPICAL CROSS SECTIONS

SCALE: None

SUBMITTED FOR APPROVAL _____


ENGINEER OF ROAD DESIGN INDIANA STATE HIGHWAY COMMISSION

FEDERAL ROAD REGION NO.	STATE	PROJECT NO.	FISCAL YEAR	SHEET NO.	TOTAL SHEETS
4	IND.	I-64-3(33)86	1967	10	

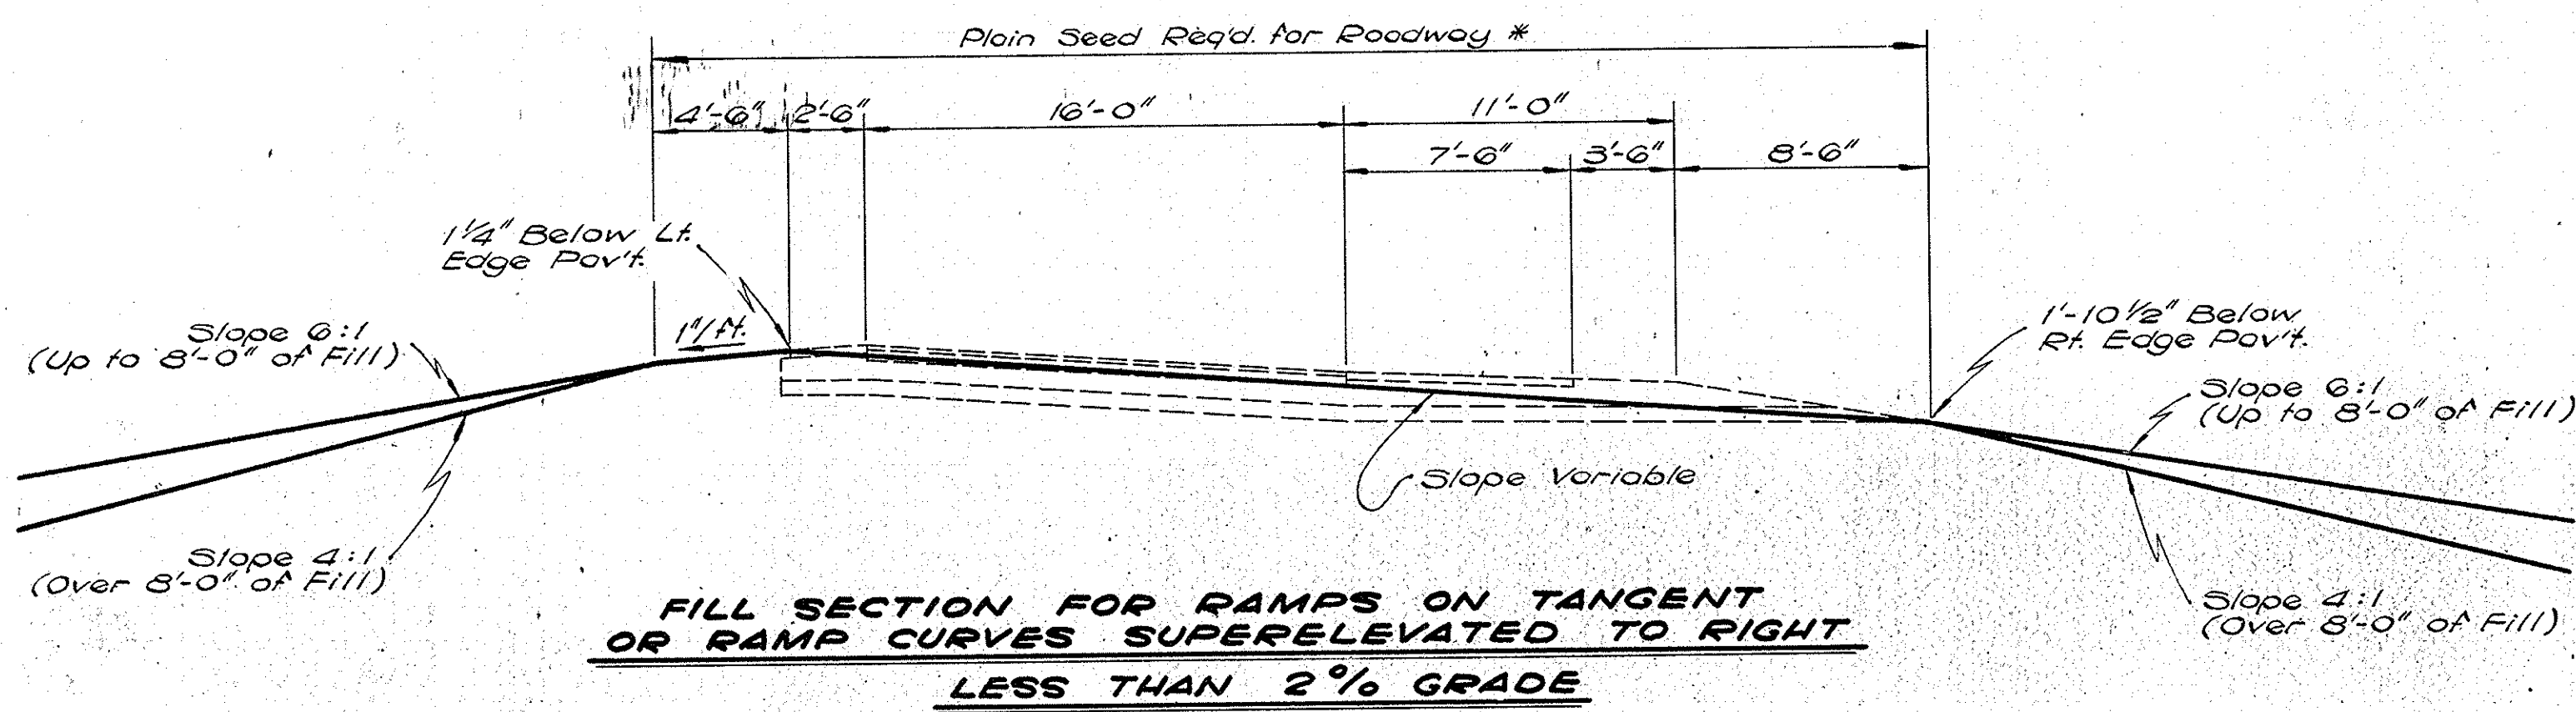

**FILL SECTION FOR RAMP CURVES SUPERELEVATED TO RIGHT
LESS THAN 2% GRADE**


Sta. 11+01.14 to Sta. 13+00 NER
 Sta. 14+00 to Sta. 15+79.92 SER
 Sta. 12+00 to Sta. 17+80 SWR

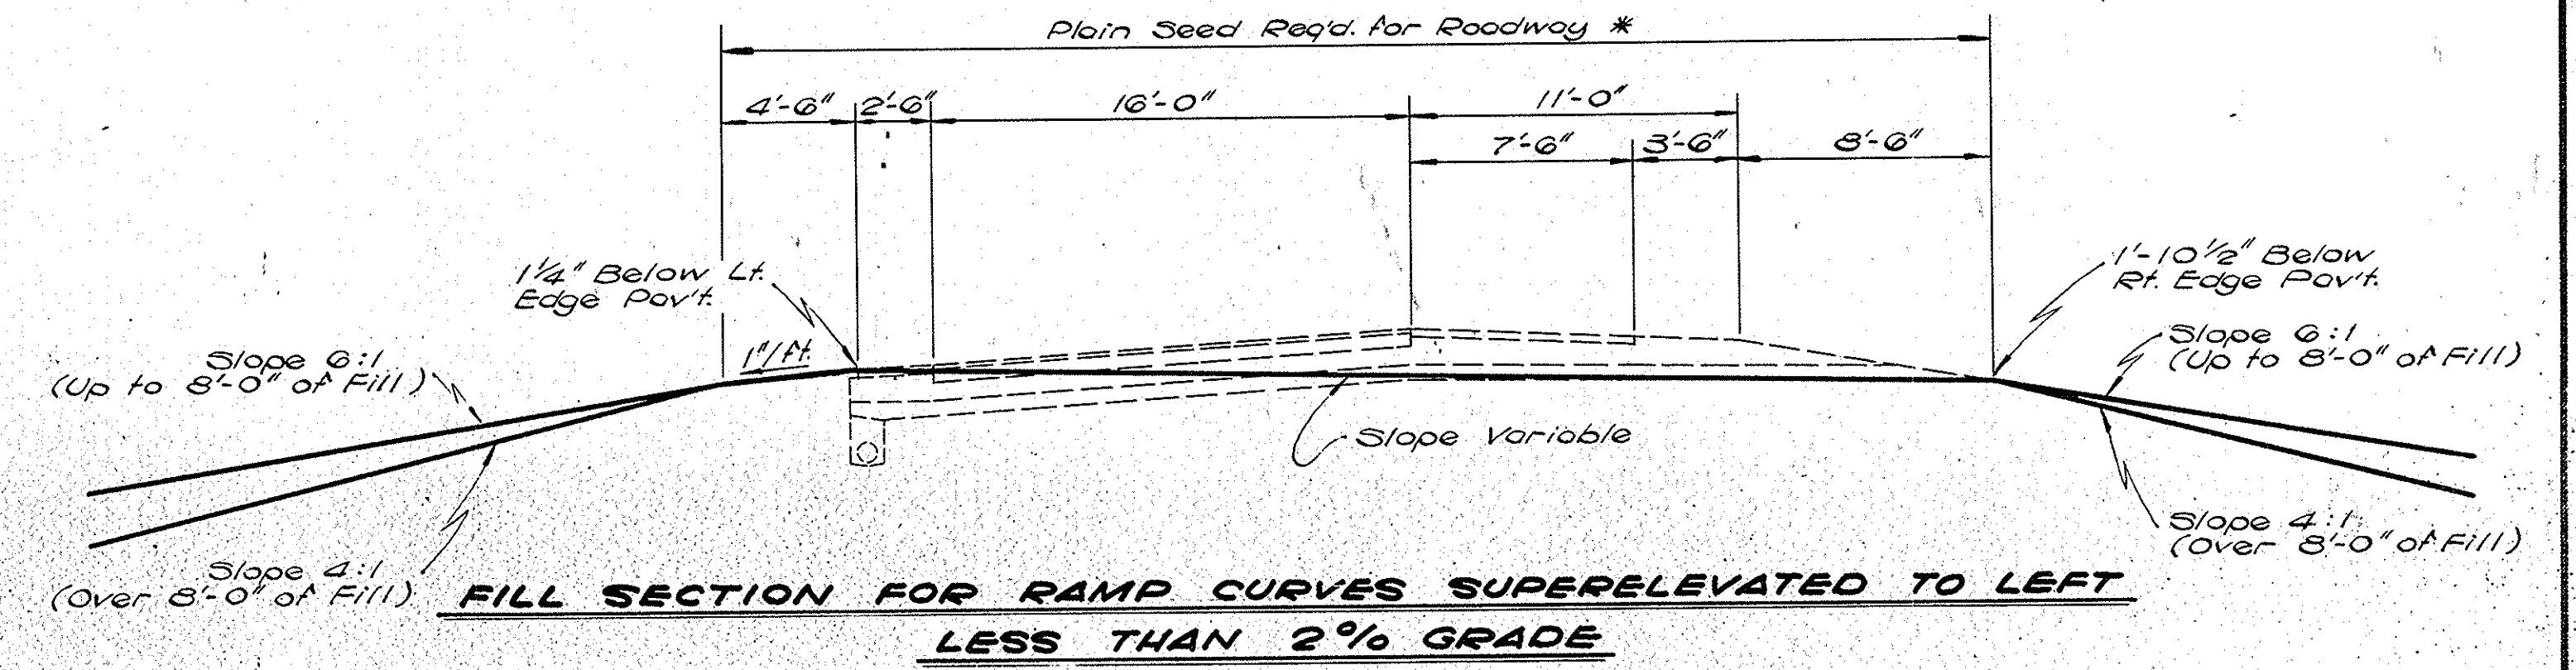

**FILL SECTION FOR RAMP CURVES SUPERELEVATED TO LEFT
LESS THAN 2% GRADE**


Sta. 17+80 to Sta. 20+77.55 SWR

* Plain Seeding Req'd. - 120 #/acre
 = Agricultural Rye

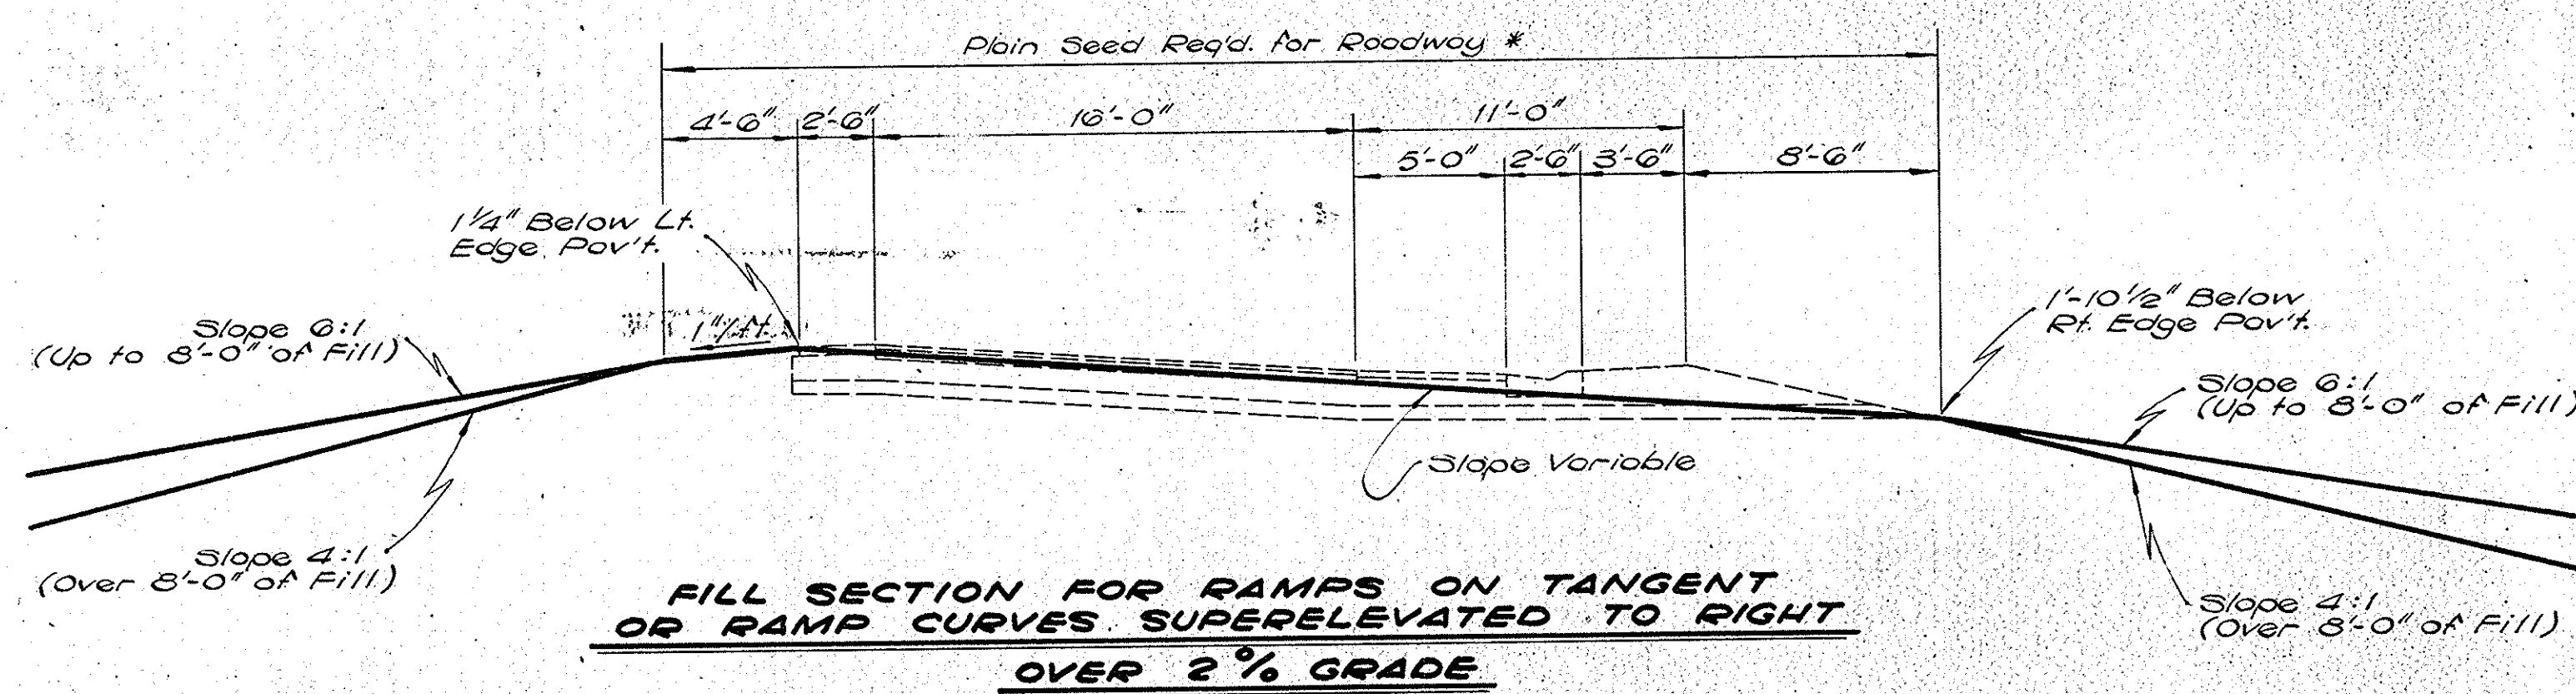

**FILL SECTION FOR RAMP CURVES SUPERELEVATED TO RIGHT
OVER 2% GRADE**

Sta. 13+00 to 20+65 NER
 Sta. 13+50 to 14+00 SER
 Sta. 527+30 Line 'A' to Sta. 9+04.08 SWR
 Sta. 9+04.08 to 12+00 SWR

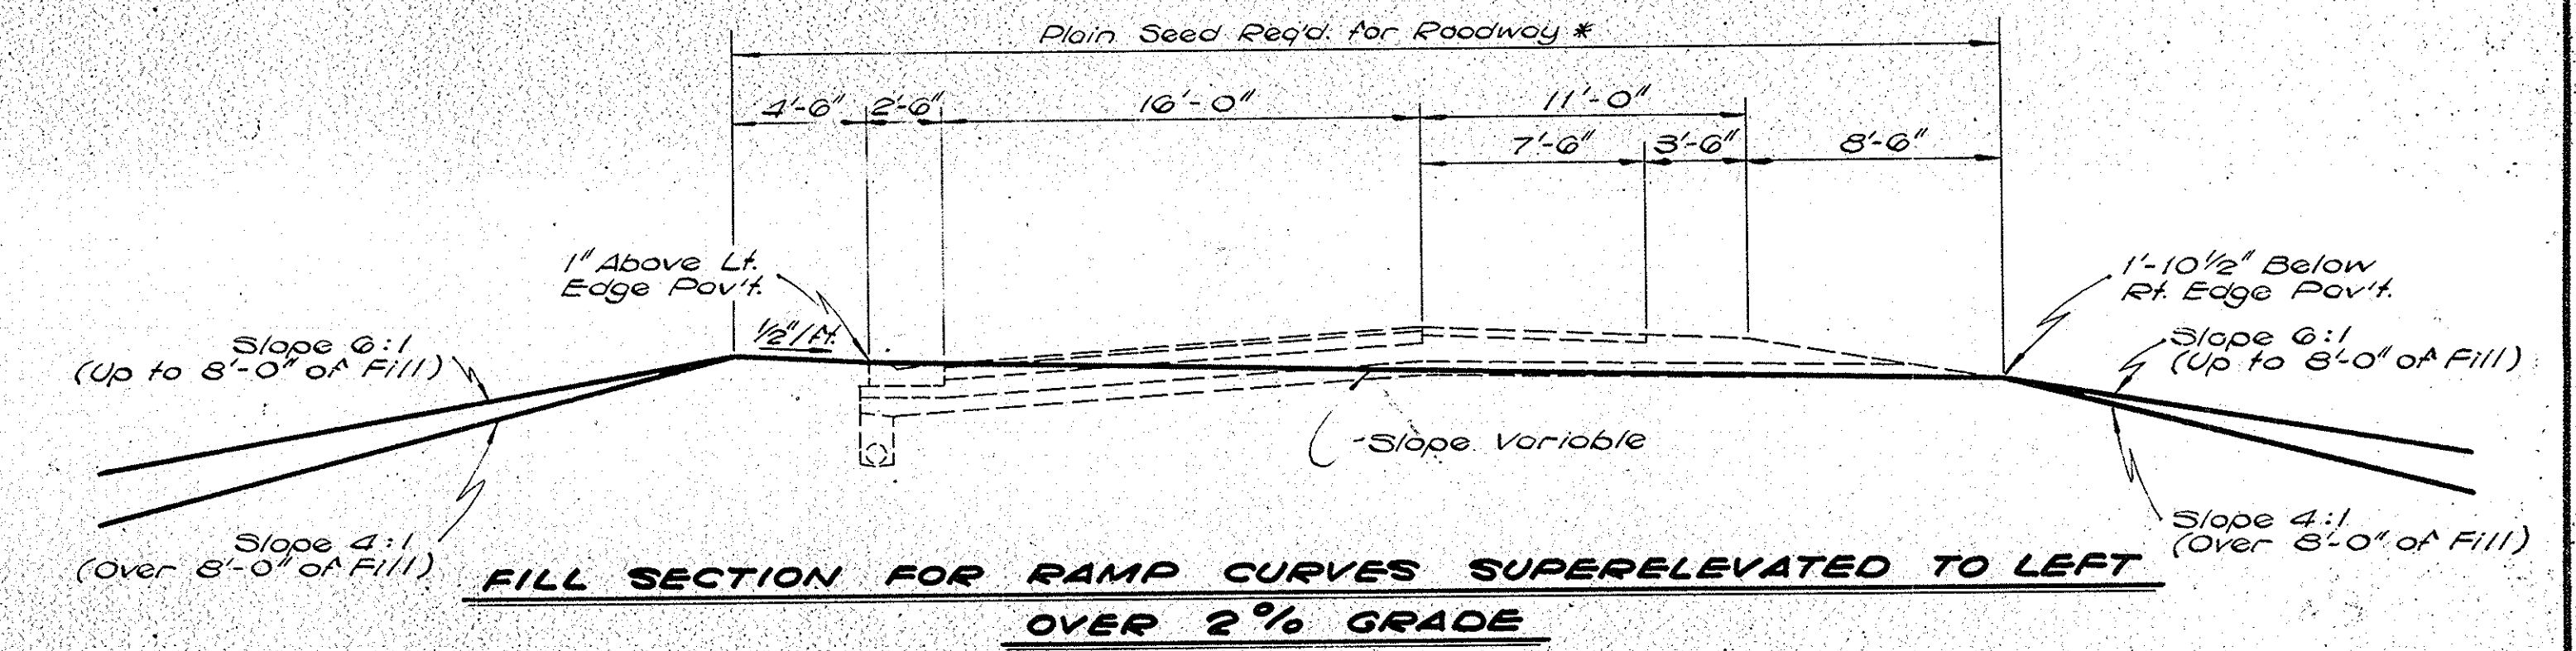

**FILL SECTION FOR RAMP CURVES SUPERELEVATED TO LEFT
OVER 2% GRADE**

Sta. 20+65 to Sta. 21+30 NER

S.R. 37 INTERCHANGE GRADING TYPICAL CROSS SECTIONS








SCALE: 3/16" = 1'-0"

SUBMITTED FOR APPROVAL _____

ENGINEER OF ROAD DESIGN, INDIANA STATE HIGHWAY COMMISSION

PROJECT NO.	LINE	SHEET NO.	TOTAL SHEETS	FILE
I-64-3(33)86		10		

FEDERAL ROAD REGION NO.	STATE	PROJECT NO.	FISCAL YEAR	SHEET NO.	TOTAL SHEETS
4	IND.	I-64-3(33)86	1967	11	

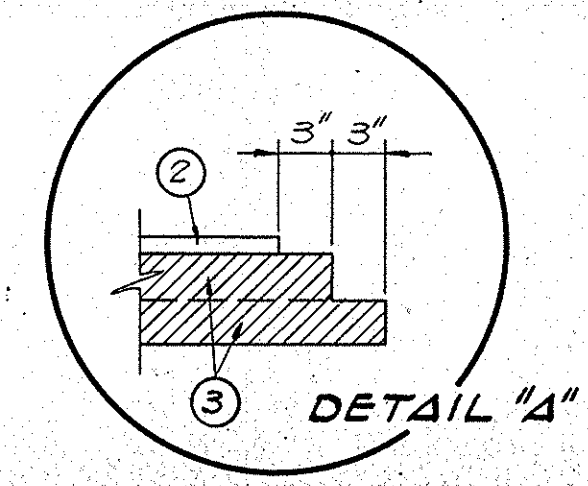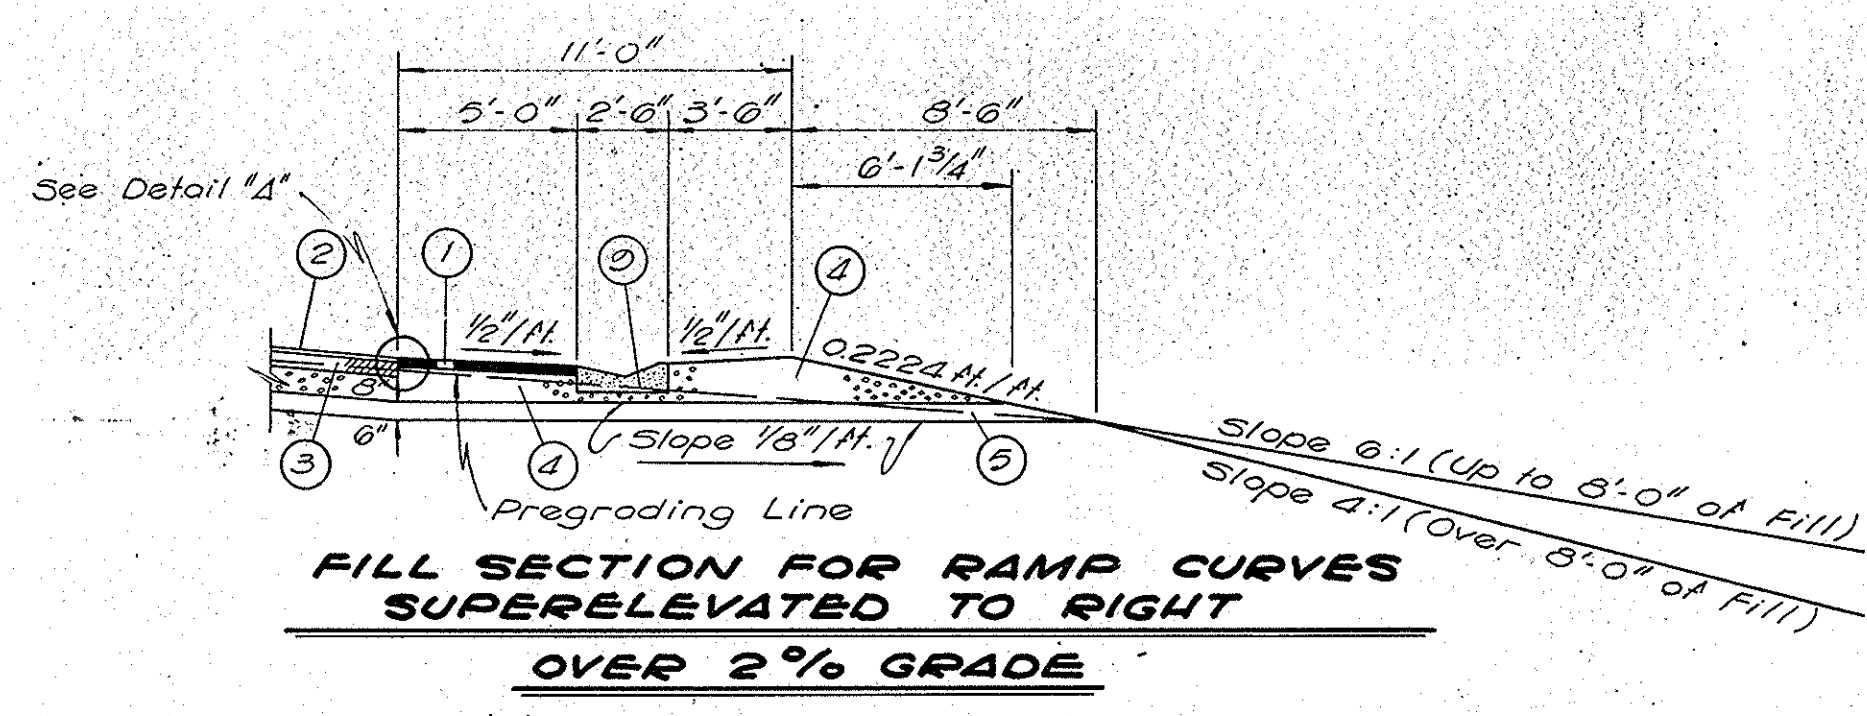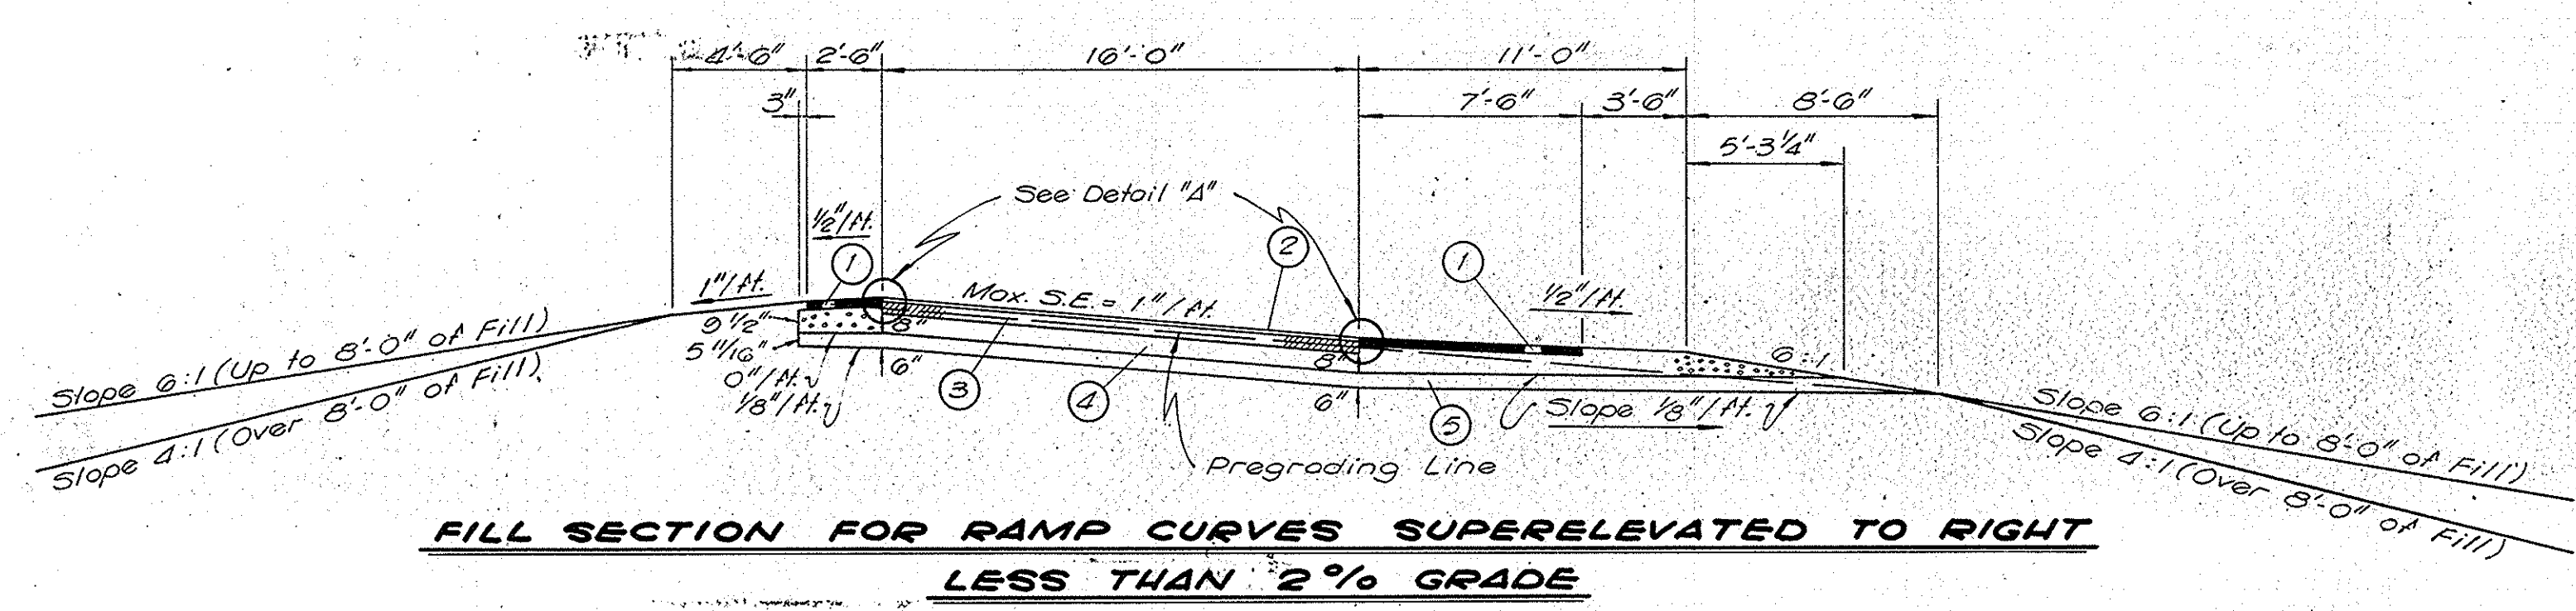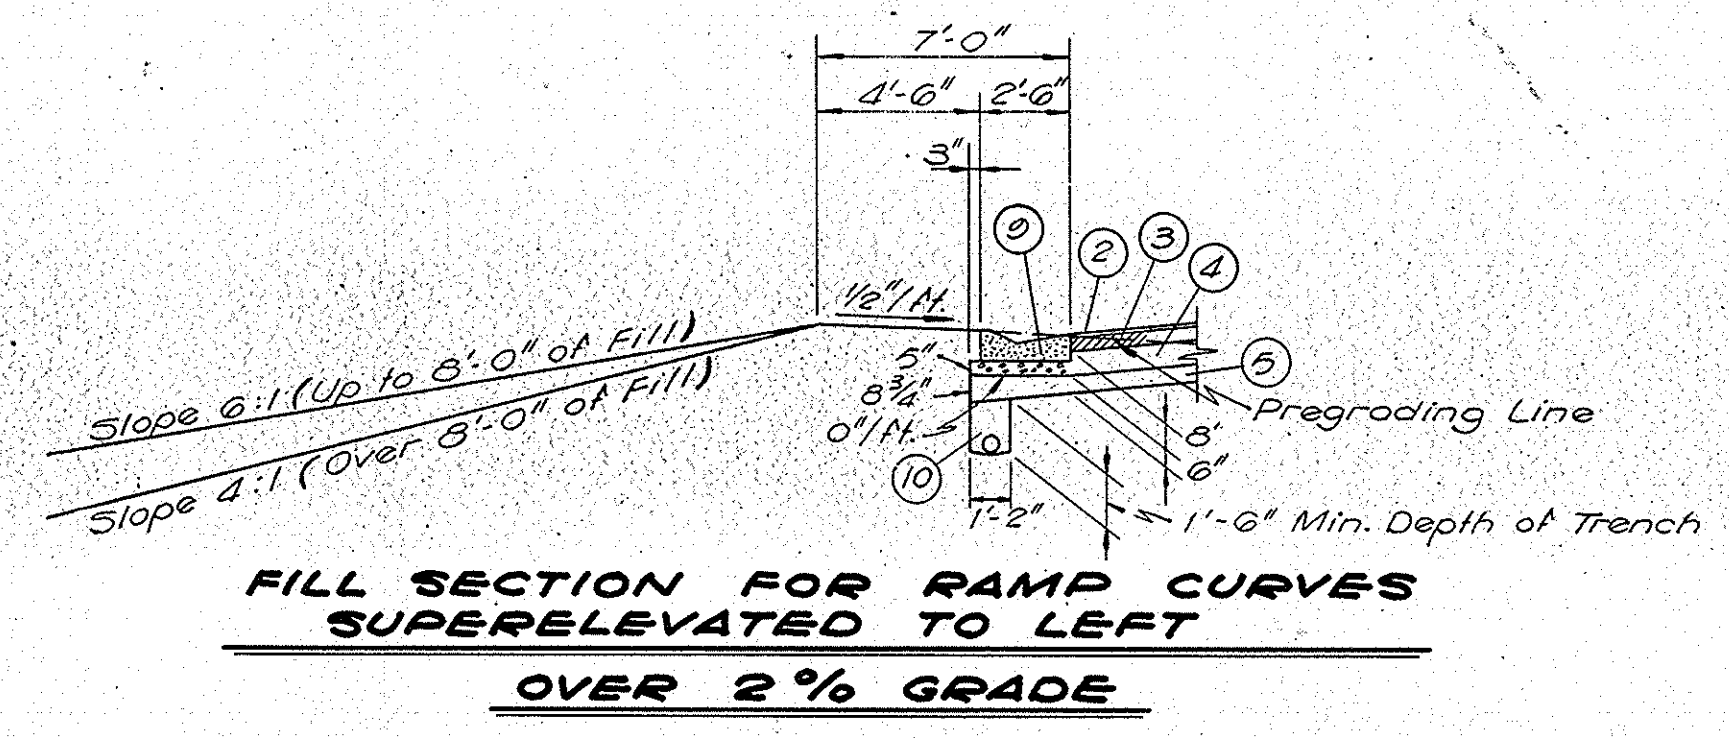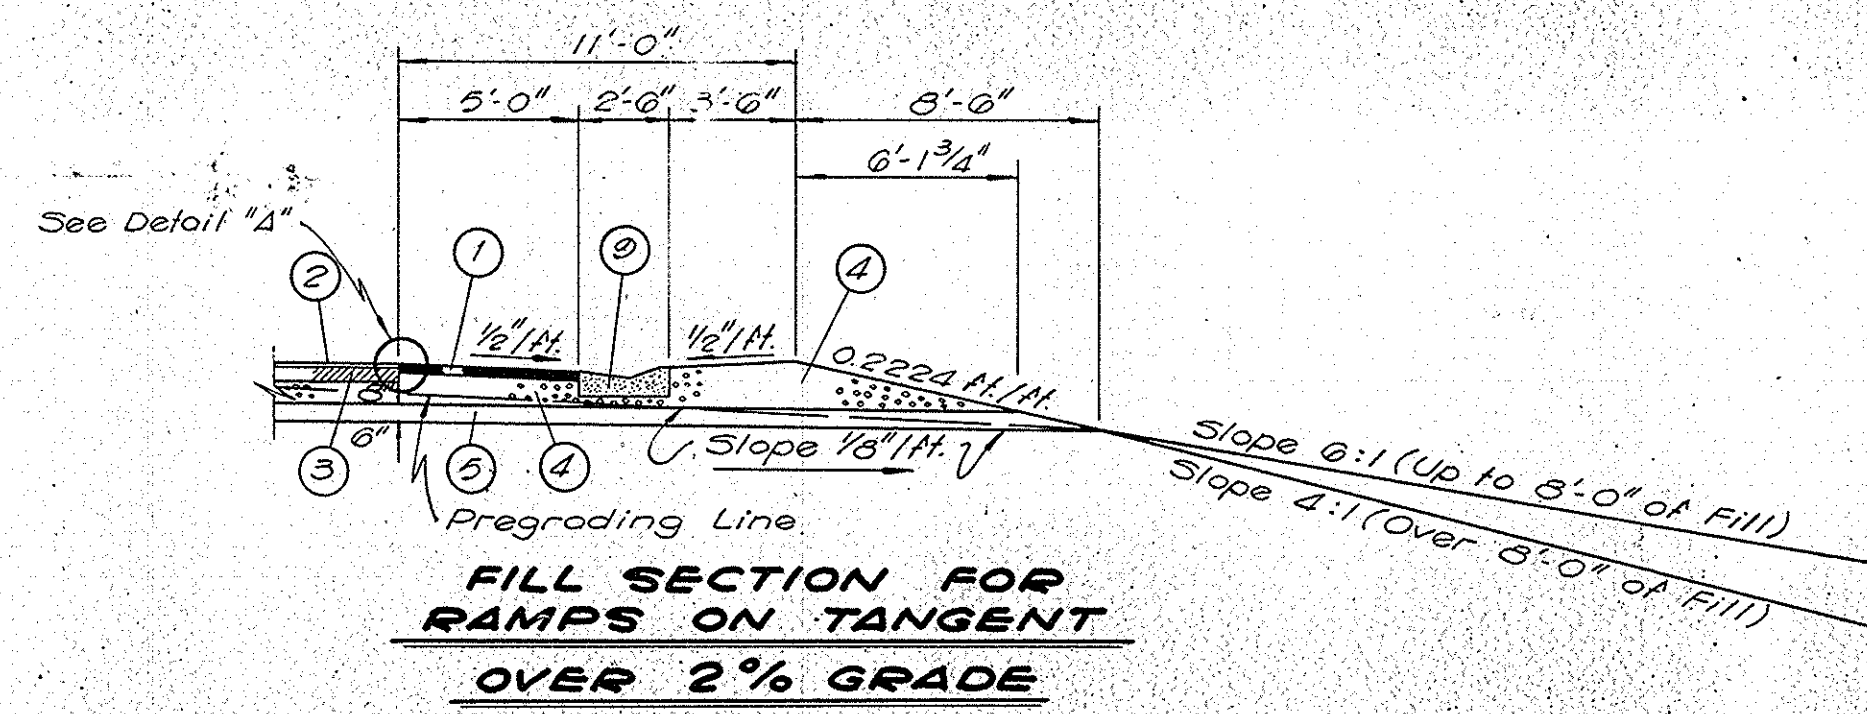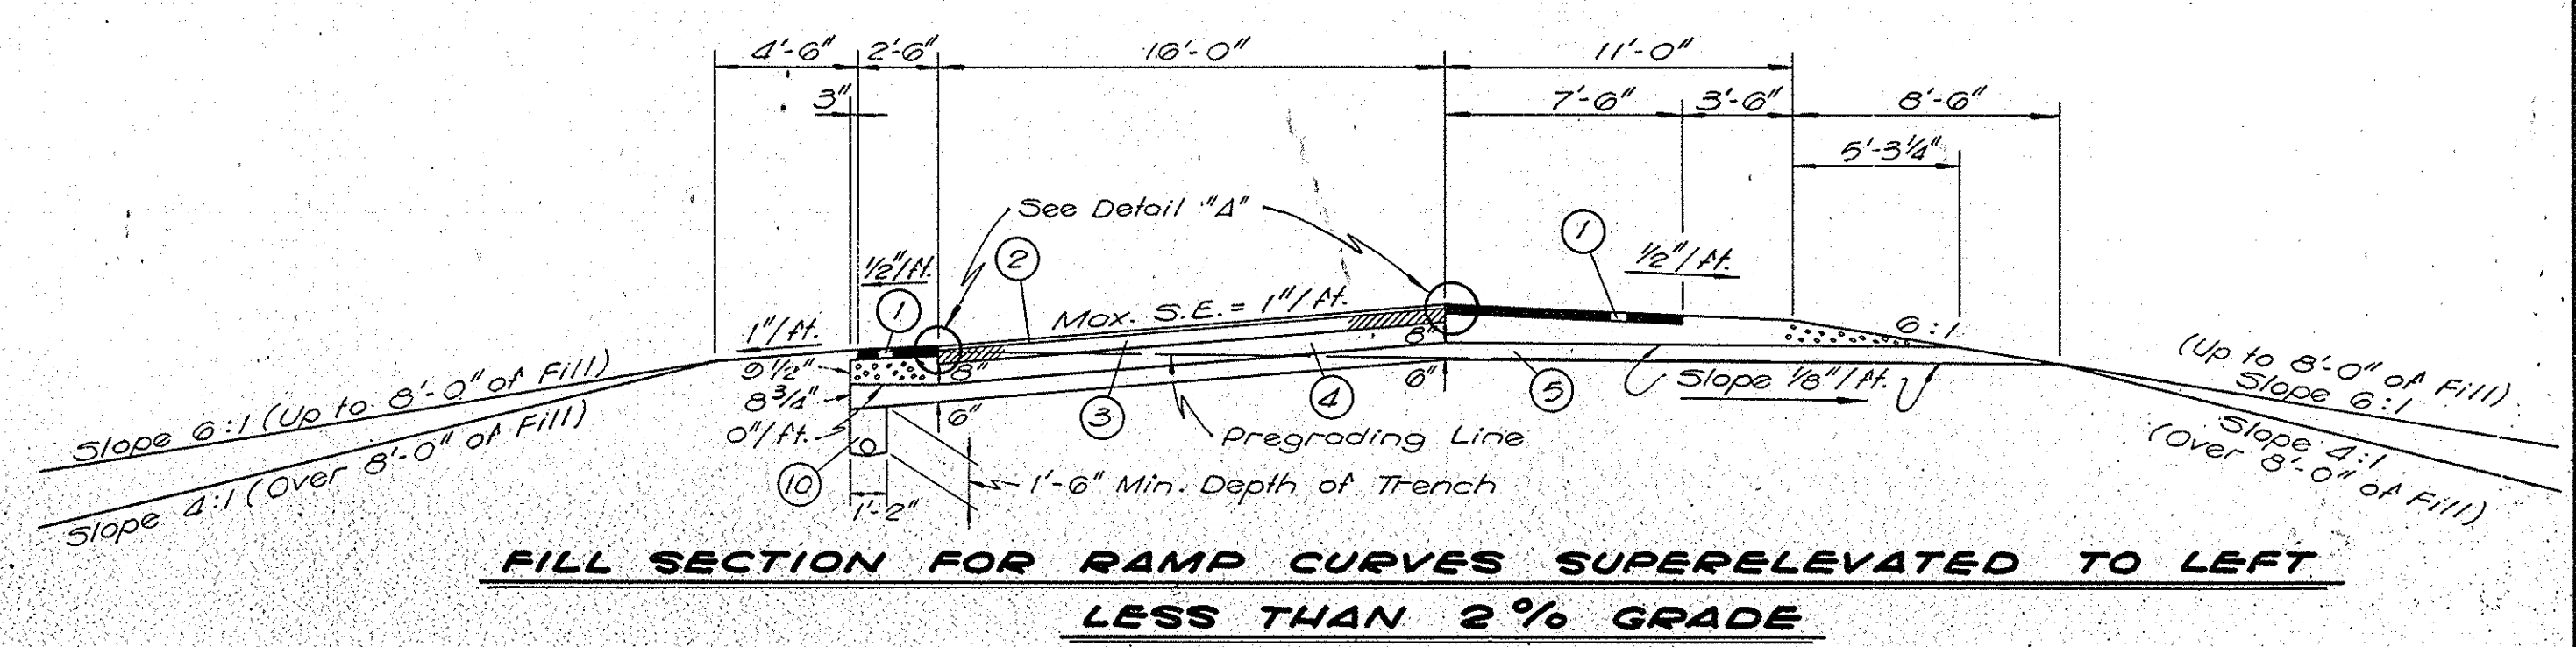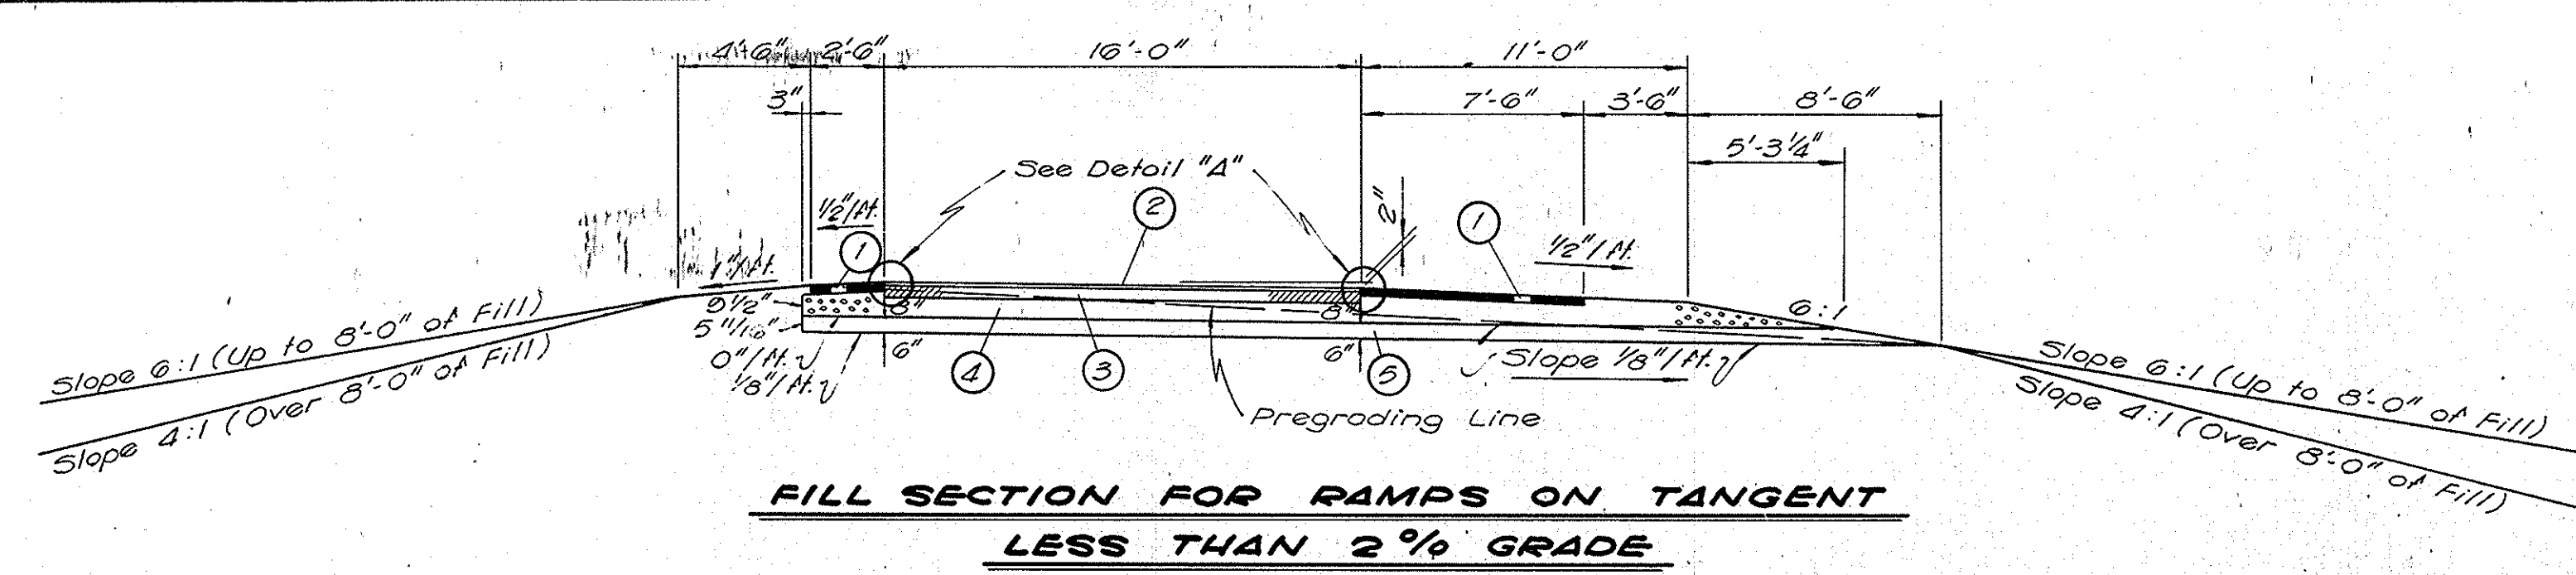

- LEGEND**
- ① 3" Bituminous Shoulder
 - ② 90# SYD H.A.E. Surface Type III / H.A.C. Surface Type "B" (* Bitum. Surface)
 - ③ 570#/SYD Hot Asphaltic Concrete Base (* Bituminous Base)
 - ④ Type "D" Compacted Aggregate Base
 - ⑤ Subbase Type II
 - ⑥ Paved Side Ditch Type "A"
 - ⑦ Standard Lip Gutter
 - ⑧ Subsurface Drain - See Misc. Std. Sheet "N"
- * Indicates Pay Item

PAVING S.R. 37 INTERCHANGE TYPICAL CROSS SECTIONS


SCALE: 3/16" = 1'-0"

RECOMMENDED FOR APPROVAL _____


ENGINEER OF ROAD DESIGN, INDIANA STATE HIGHWAY COMMISSION

PROJECT NO.	LINE	SHEET NO.	TOTAL SHEETS	FILE
I-64-3(33)86		11		

FEDERAL ROAD REGION NO.	STATE	PROJECT NO.	FISCAL YEAR	SHEET NO.	TOTAL SHEETS
4	IND.	I-64-3(33)86	1967	12	

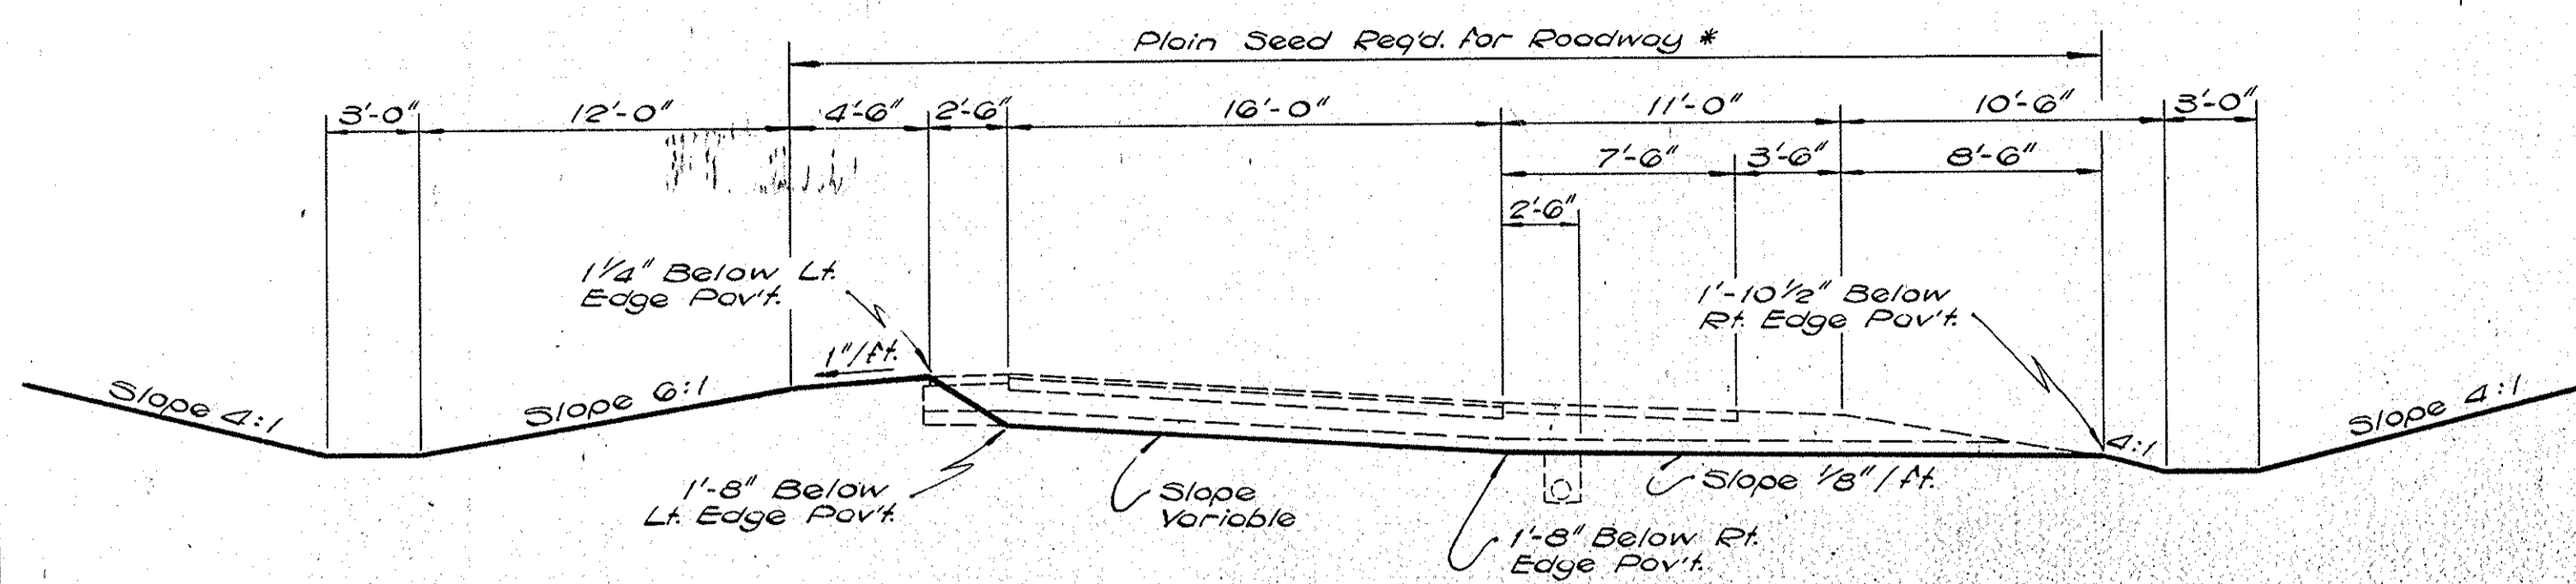


CUT SECTION FOR RAMPS ON TANGENT OR RAMP CURVES SUPERELEVATED TO RIGHT LESS THAN 2% GRADE

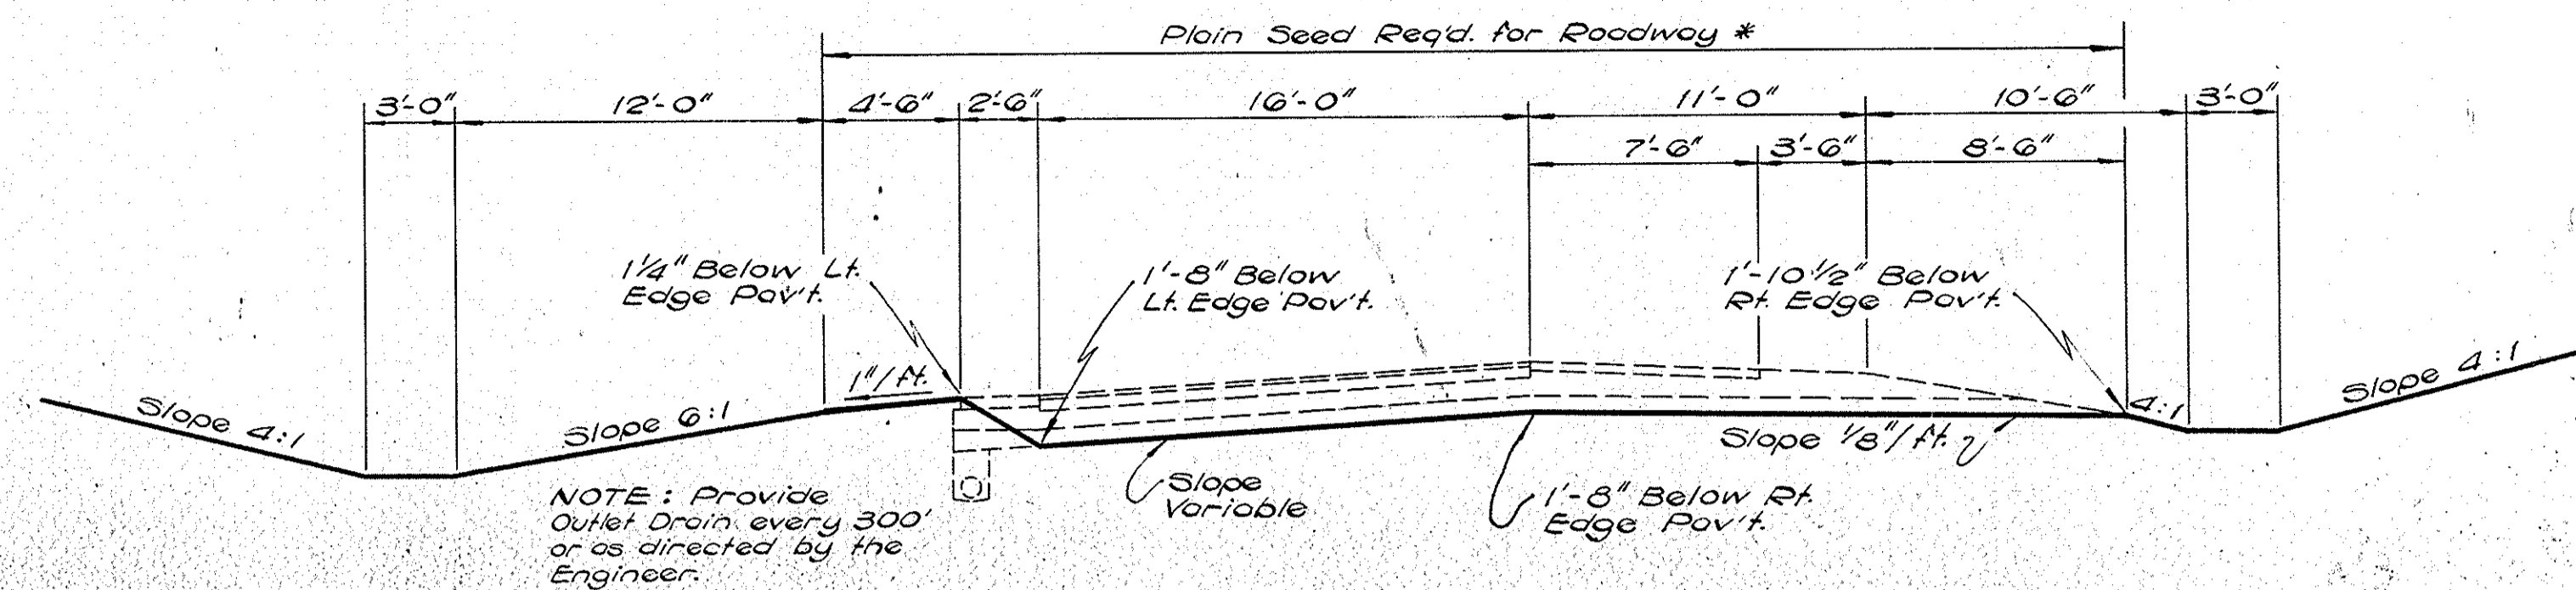


CUT SECTION FOR RAMP CURVES SUPERELEVATED TO LEFT LESS THAN 2% GRADE

* Plain Seeding Req'd. - 140#/Acre
Agricultural Rye.

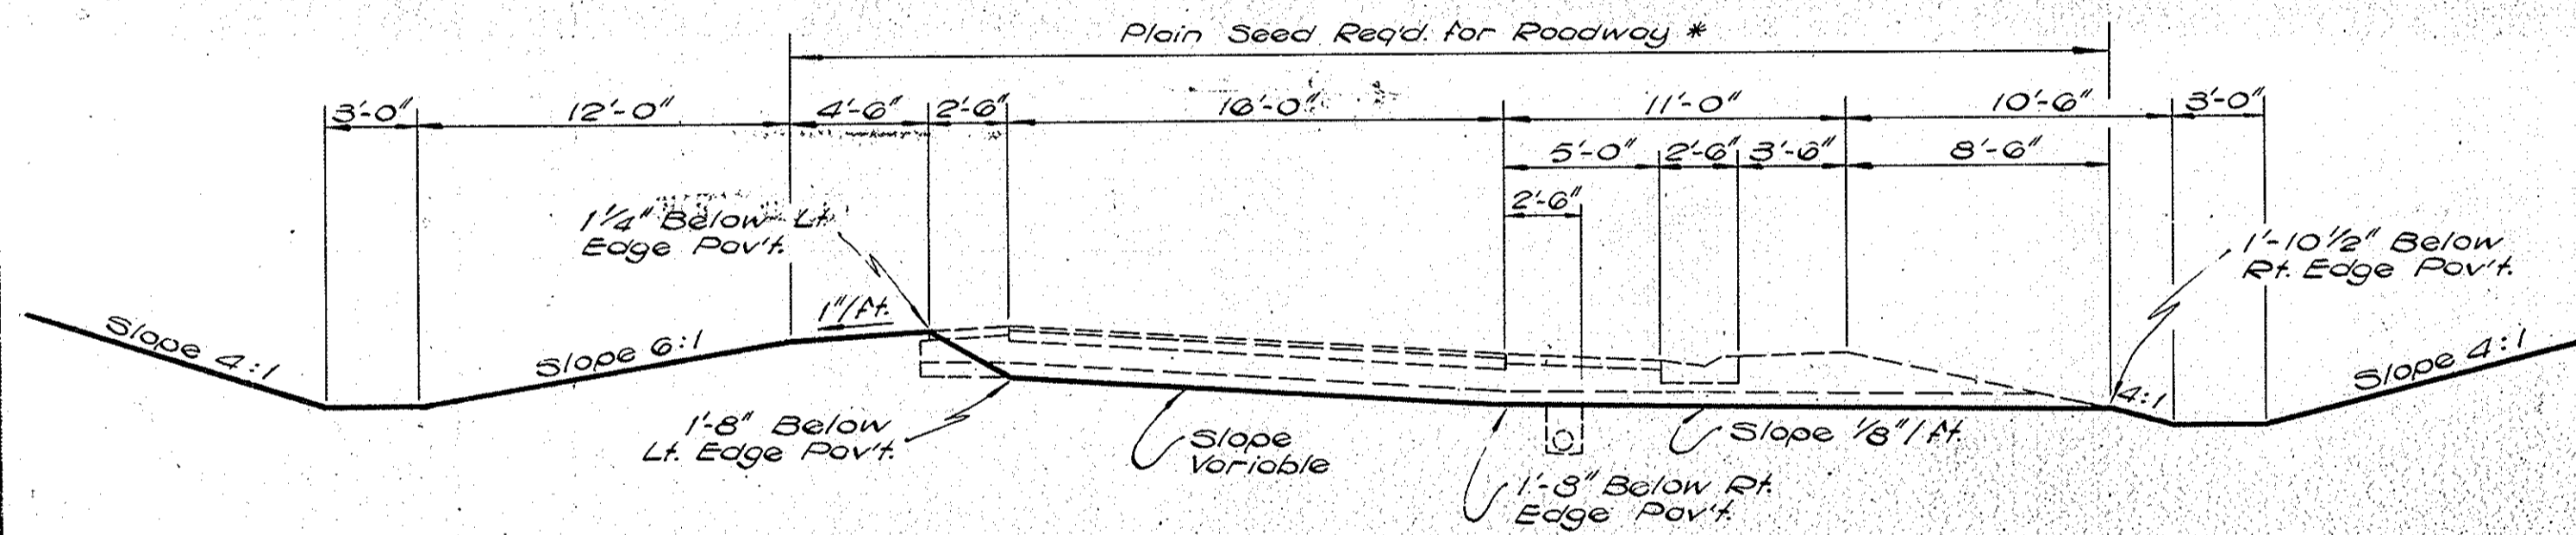

CUT SECTION FOR RAMPS ON TANGENT OR RAMP CURVES SUPERELEVATED TO RIGHT OVER 2% GRADE

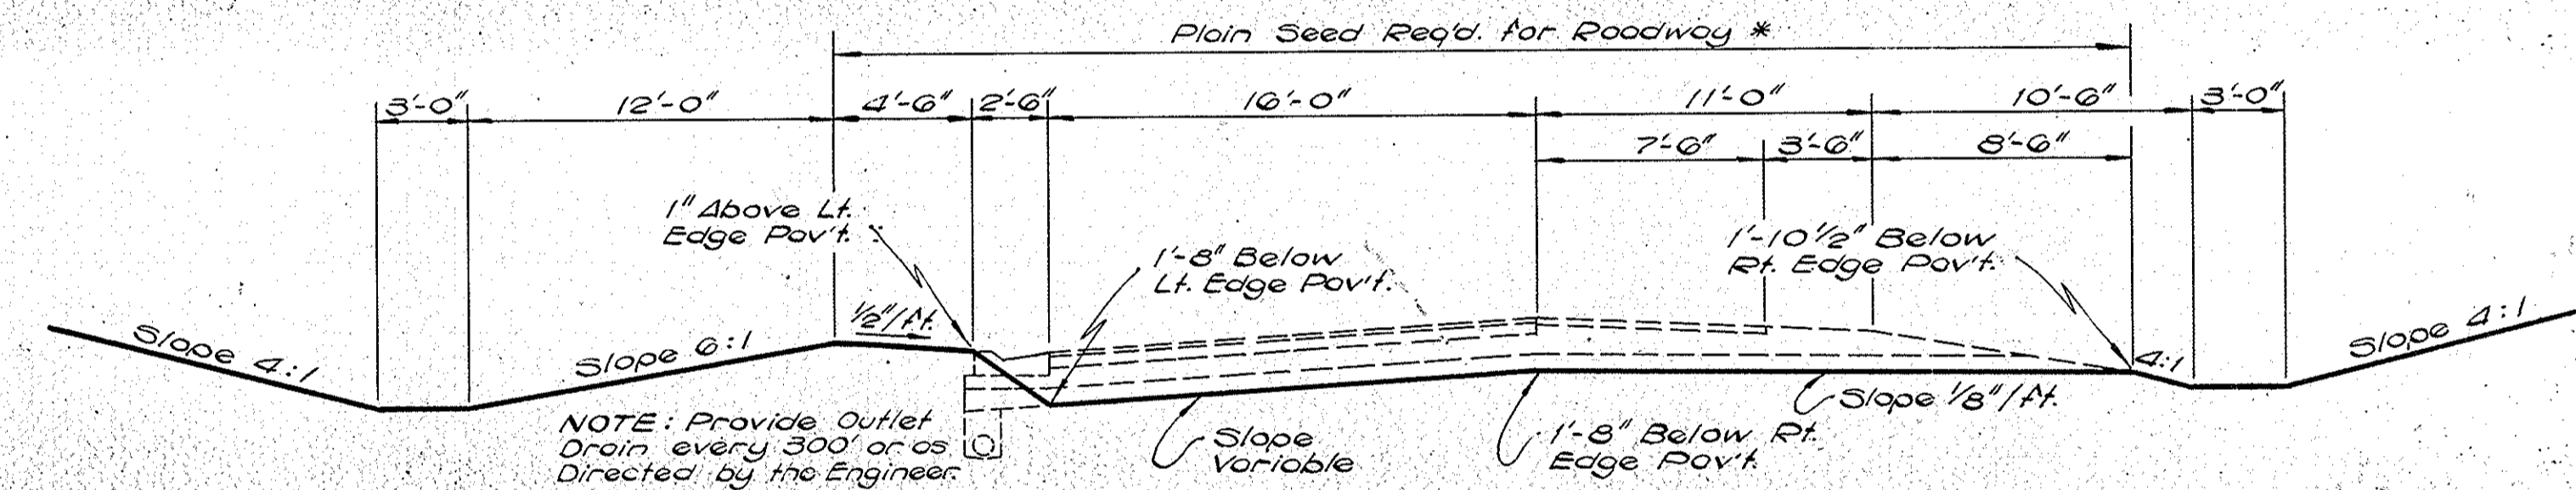

CUT SECTION FOR RAMP CURVES SUPERELEVATED TO LEFT OVER 2% GRADE

S.R. 37 INTERCHANGE GRADING TYPICAL CROSS SECTIONS


SCALE: 3/16" = 1'-0"

SUBMITTED FOR APPROVAL _____


ENGINEER OF ROAD DESIGN: INDIANA STATE HIGHWAY COMMISSION

PROJECT NO.	LINE	SHEET NO.	TOTAL SHEETS	FILE
I-64-3(33)86		12		


FEDERAL ROAD REGION NO.	STATE	PROJECT NO.	FISCAL YEAR	SHEET NO.	TOTAL SHEETS
4	IND.	I-64-3(33)86	1967	13	

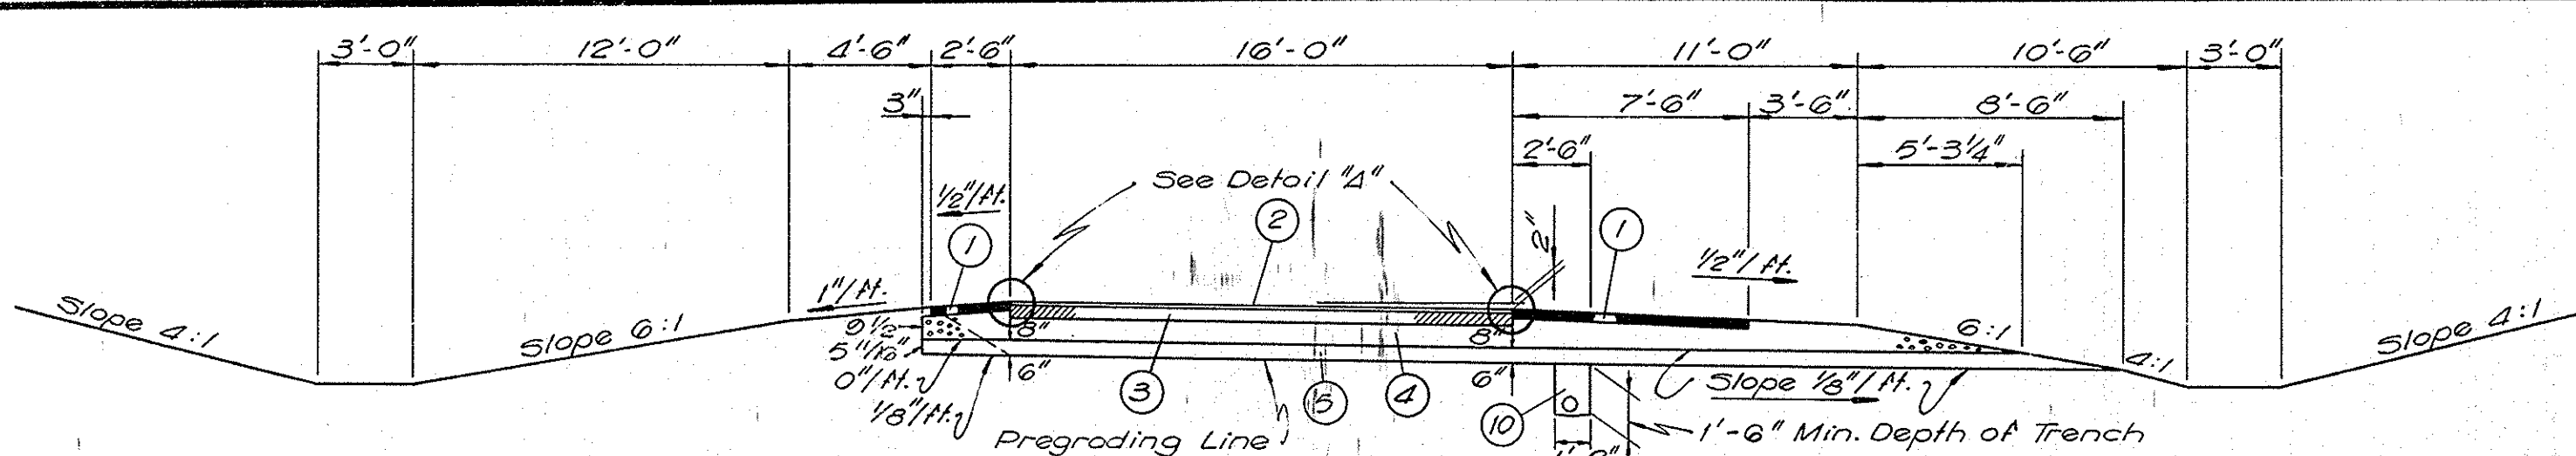


**CUT SECTION FOR RAMPS ON TANGENT
LESS THAN 2% GRADE**

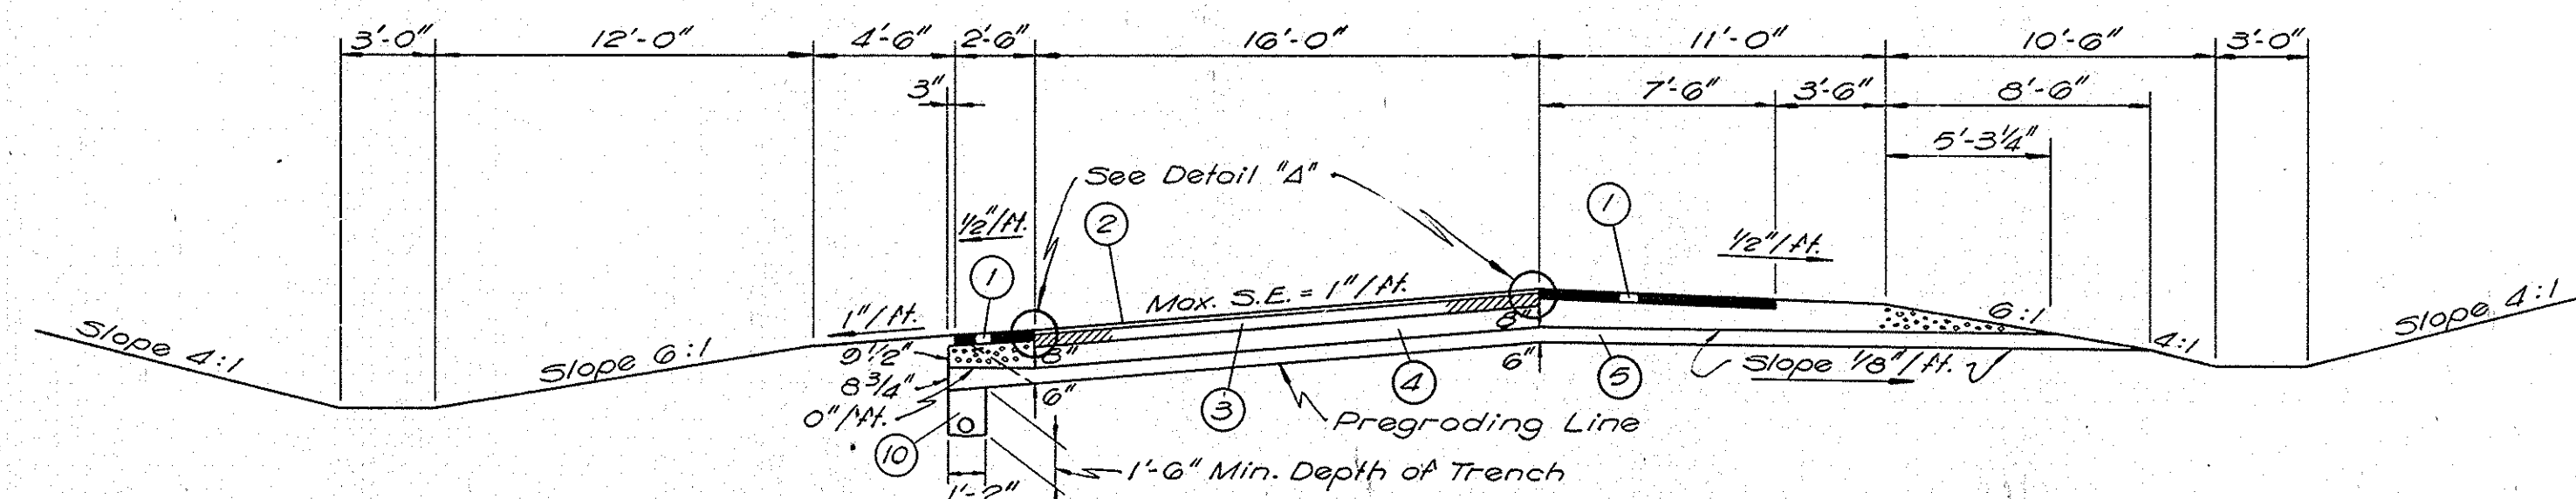


**CUT SECTION FOR RAMP CURVES SUPERELEVATED TO LEFT
LESS THAN 2% GRADE**

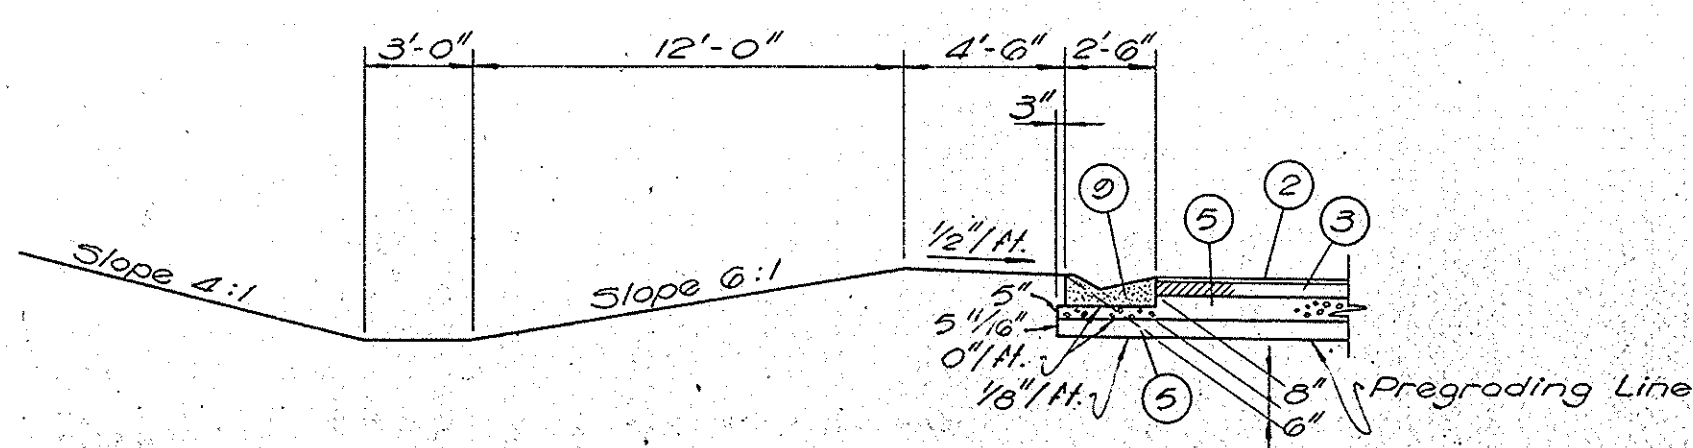


**CUT SECTION FOR RAMPS ON TANGENT
OVER 2% GRADE**

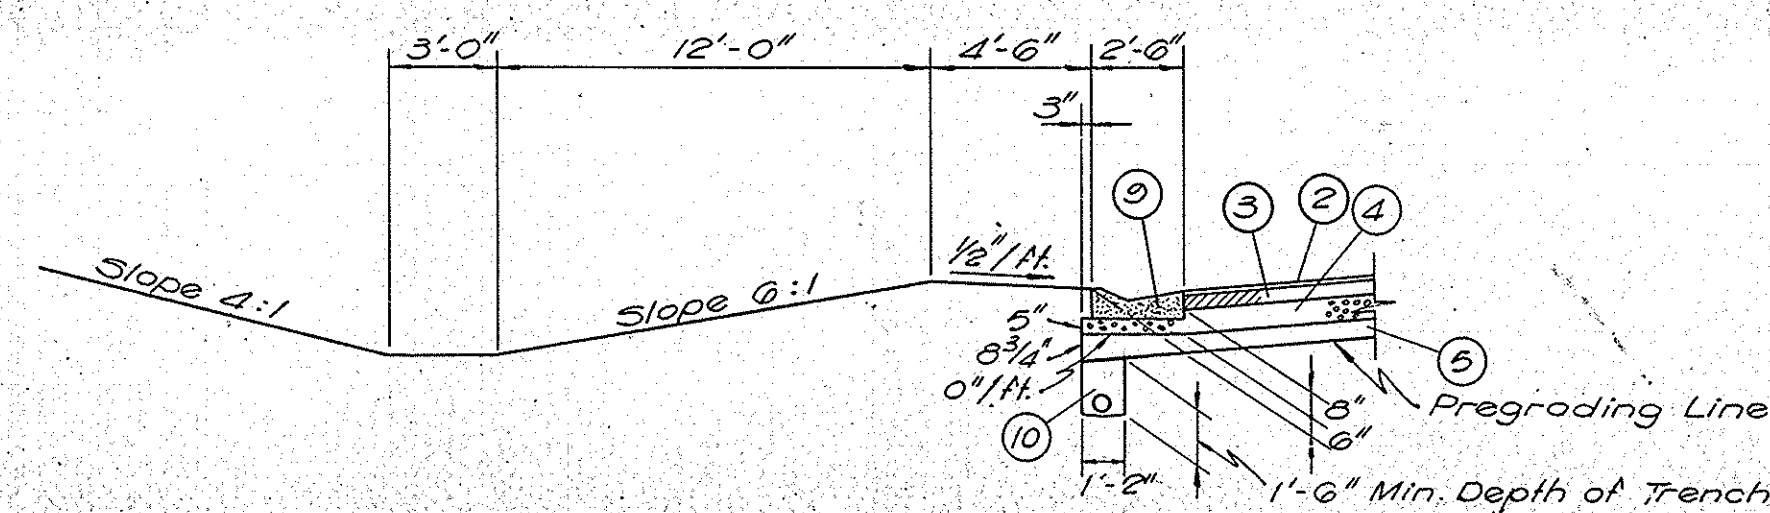


**CUT SECTION FOR RAMP CURVES SUPERELEVATED TO LEFT
OVER 2% GRADE**

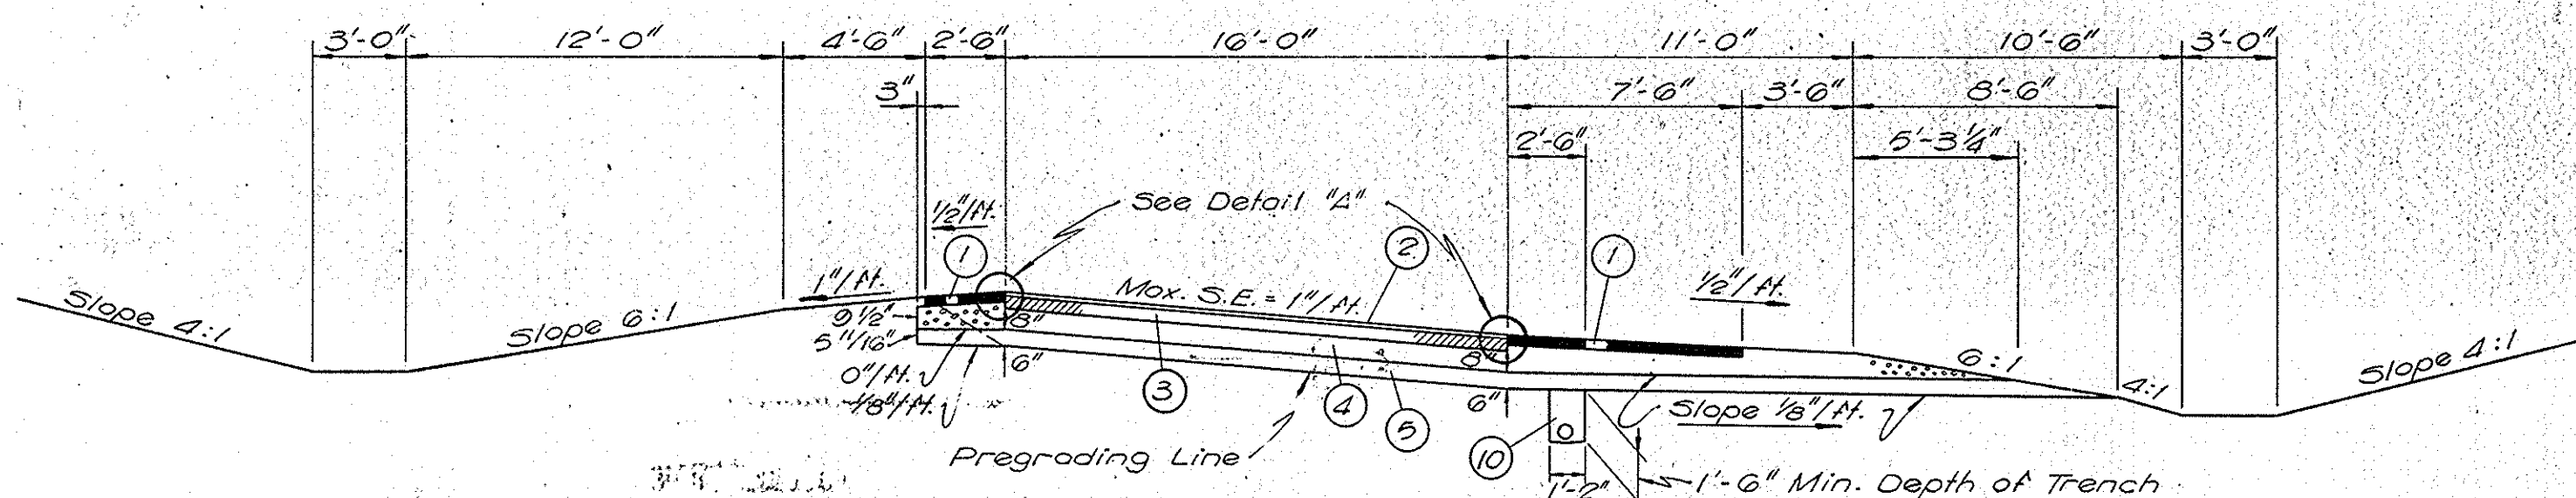

**CUT SECTION FOR RAMP CURVES SUPERELEVATED TO RIGHT
LESS THAN 2% GRADE**

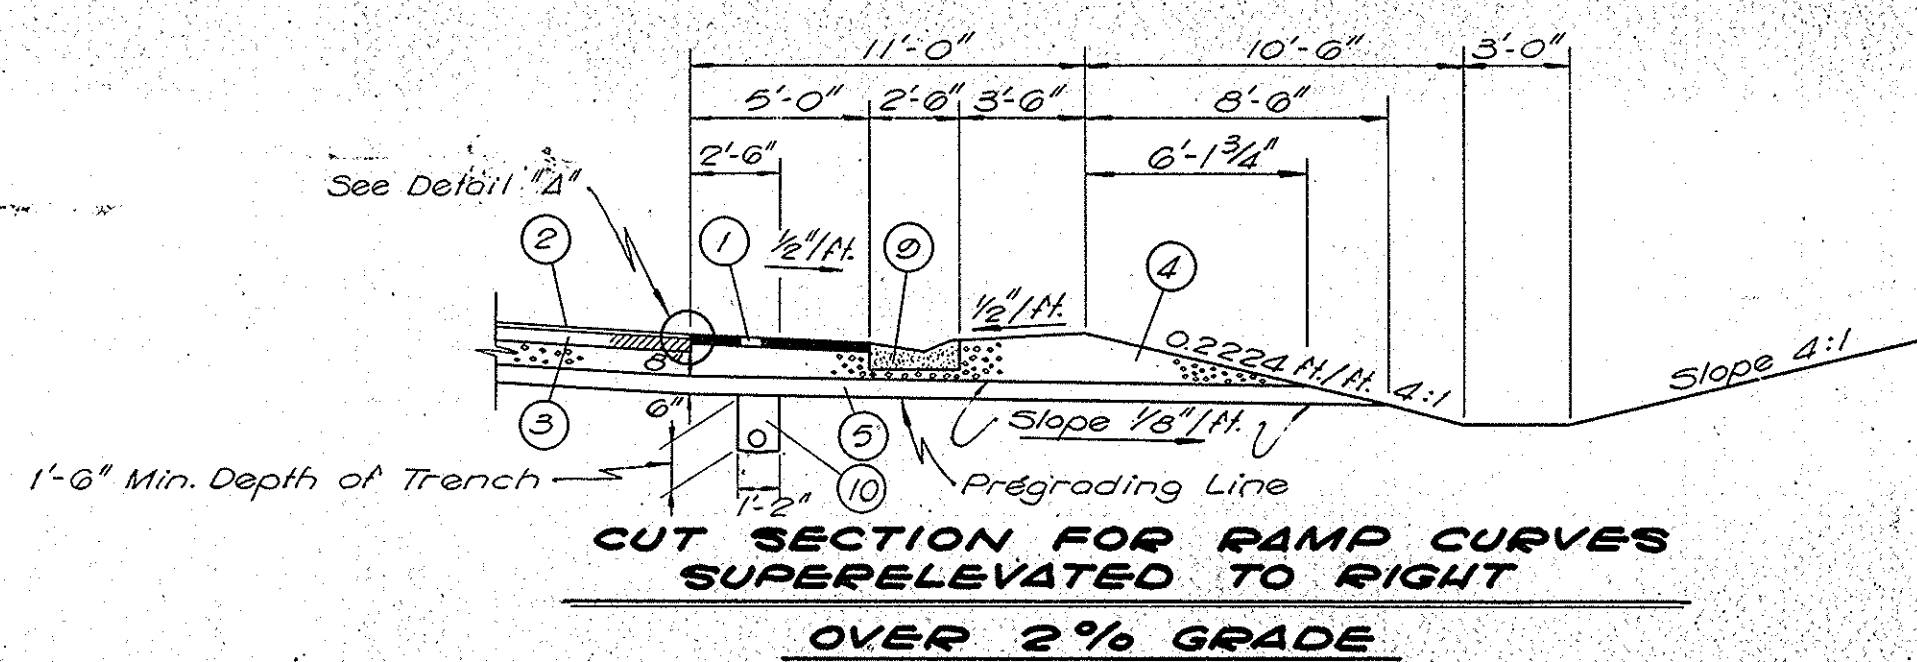

**CUT SECTION FOR RAMP CURVES SUPERELEVATED TO RIGHT
OVER 2% GRADE**

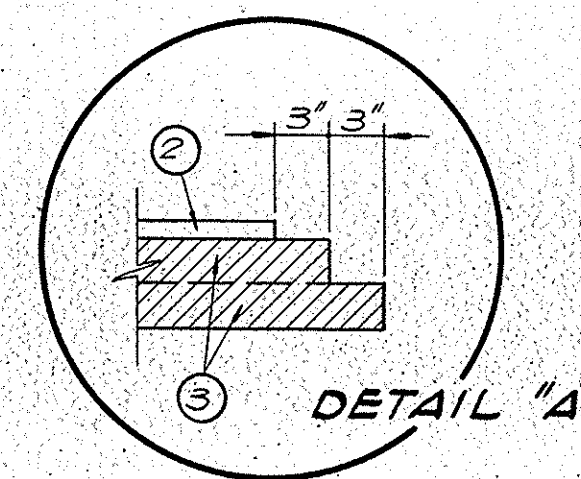

DETAIL "A"

LEGEND

- ① 3" Bituminous Shoulder
 - ② 80#/SYD H.A.E. Surface Type III / H.A.C. Surface Type "B" (* Bitum. Surface)
 - ③ 570#/SYD Hot Asphaltic Concrete Base (* Bitum. Base)
 - ④ Type "a" Compacted Aggregate Base
 - ⑤ Subbase Type II
 - ⑥ Paved Side Ditch Type "A"
 - ⑦ Standard Lip Gutter
 - ⑧ Subsurface Drain - See Misc. Std. Sheet "N"
- * Indicates Pay Item

**PAVING
S.R. 37 INTERCHANGE
TYPICAL CROSS SECTIONS**


SCALE: 3/16" = 1'-0"

SUBMITTED FOR APPROVAL _____

ENGINEER OF ROAD DESIGN, INDIANA STATE HIGHWAY COMMISSION


PROJECT NO.	LINE	SHEET NO.	TOTAL SHEETS	FILE
I-64-3(33)86		13		

FEDERAL ROAD REGION NO.	STATE	PROJECT NO.	FISCAL YEAR	SHEET NO.	TOTAL SHEETS
4	IND.	I-64-3(33)86	1967	14	

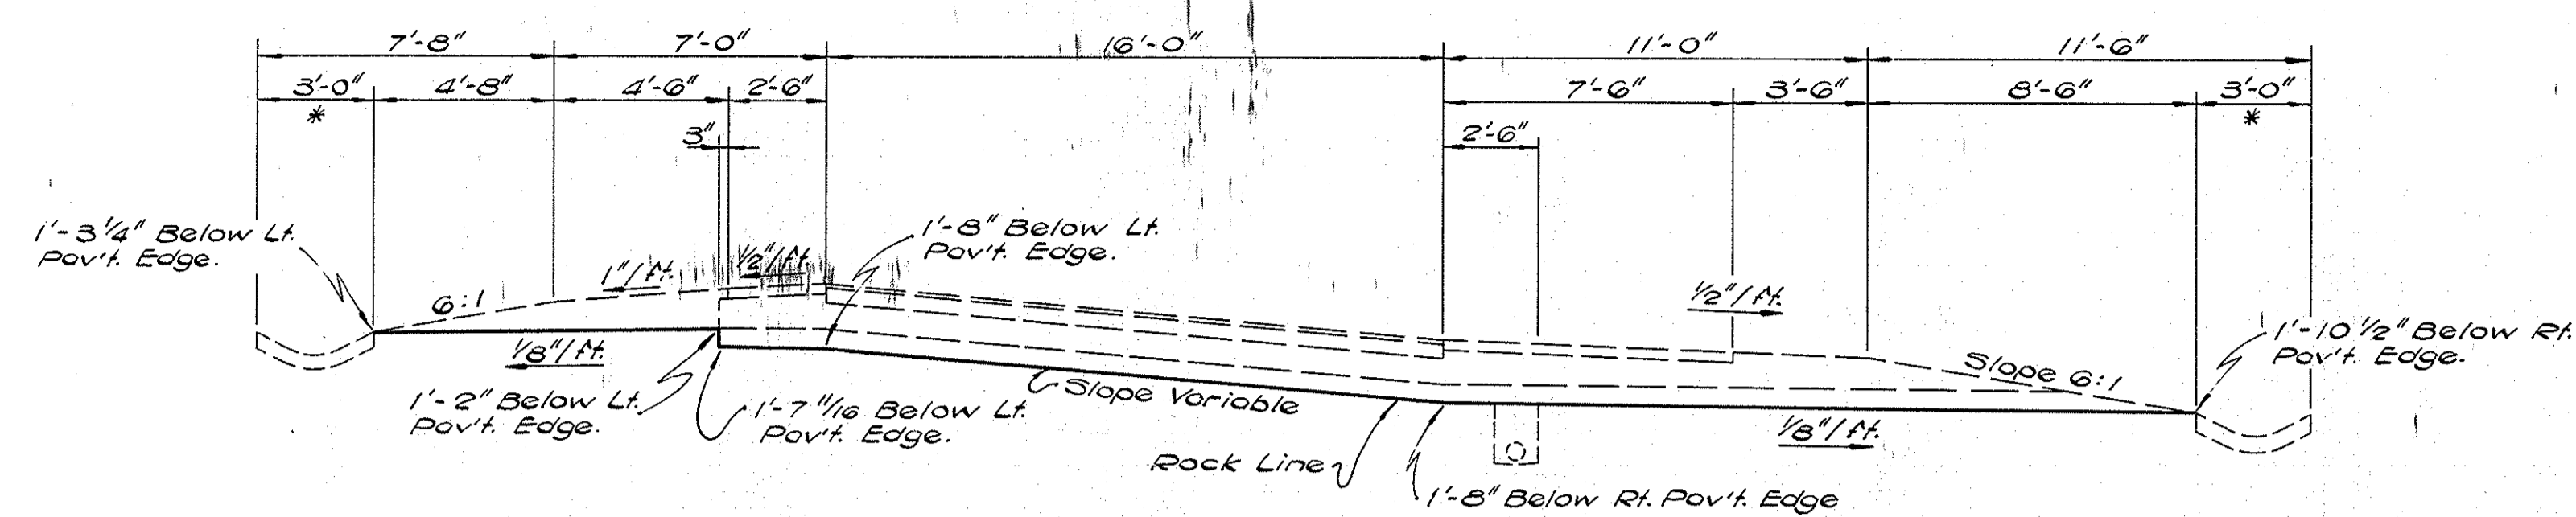


**RAMP SECTION IN ROCK ON TANGENT
OR SUPERELEVATED TO RIGHT
LESS THAN 2% GRADE**

Sta. 5+35 to Sta. 11+35 NWR

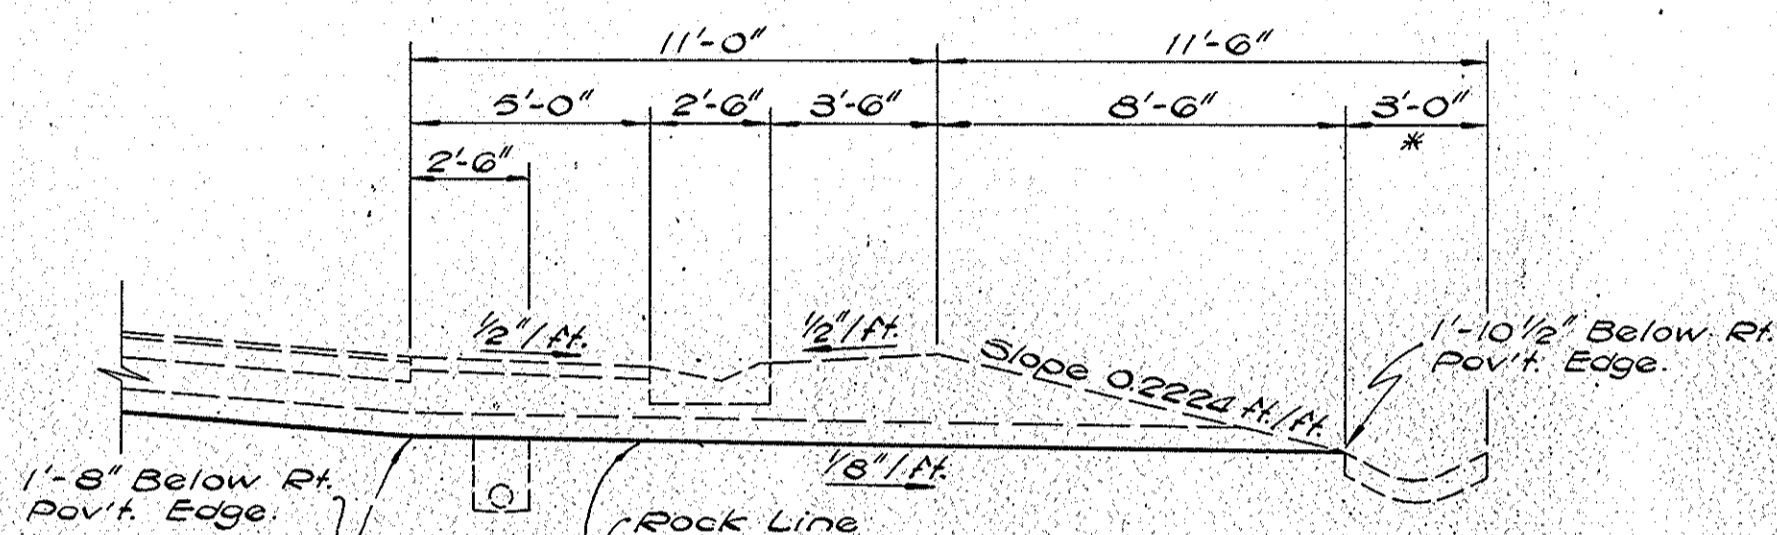


**RAMP SECTION IN ROCK ON TANGENT
OR SUPERELEVATED TO RIGHT
OVER 2% GRADE**

Sta. 4+60 to Sta. 13+50 SER
Sta. 11+35 to Sta. 14+79.41 NWR

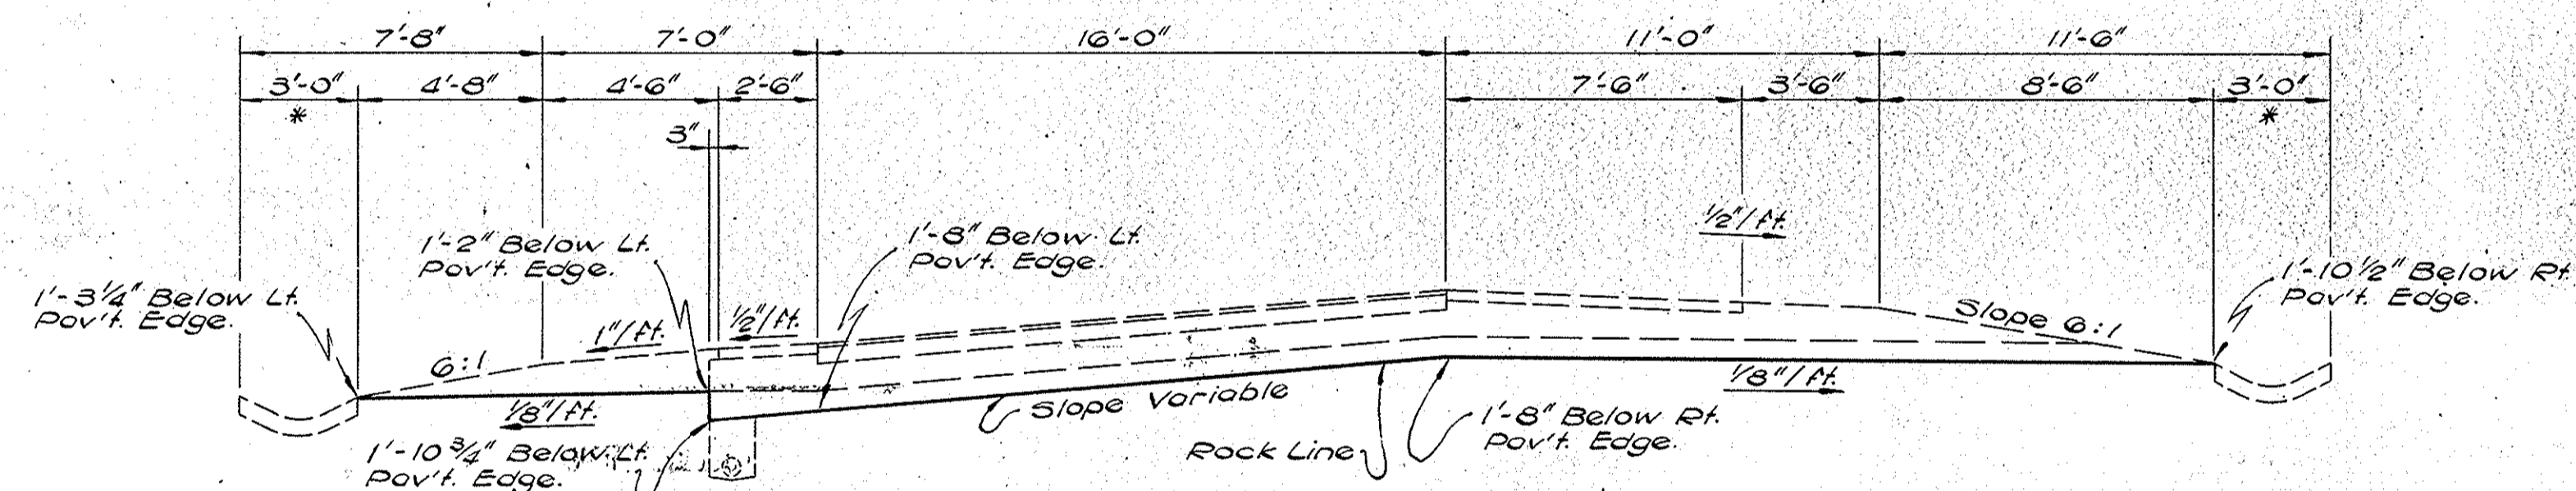

**RAMP SECTION IN ROCK SUPERELEVATED TO LEFT
LESS THAN 2% GRADE**

Sta. 1+27.90 to Sta. 5+35 NWR

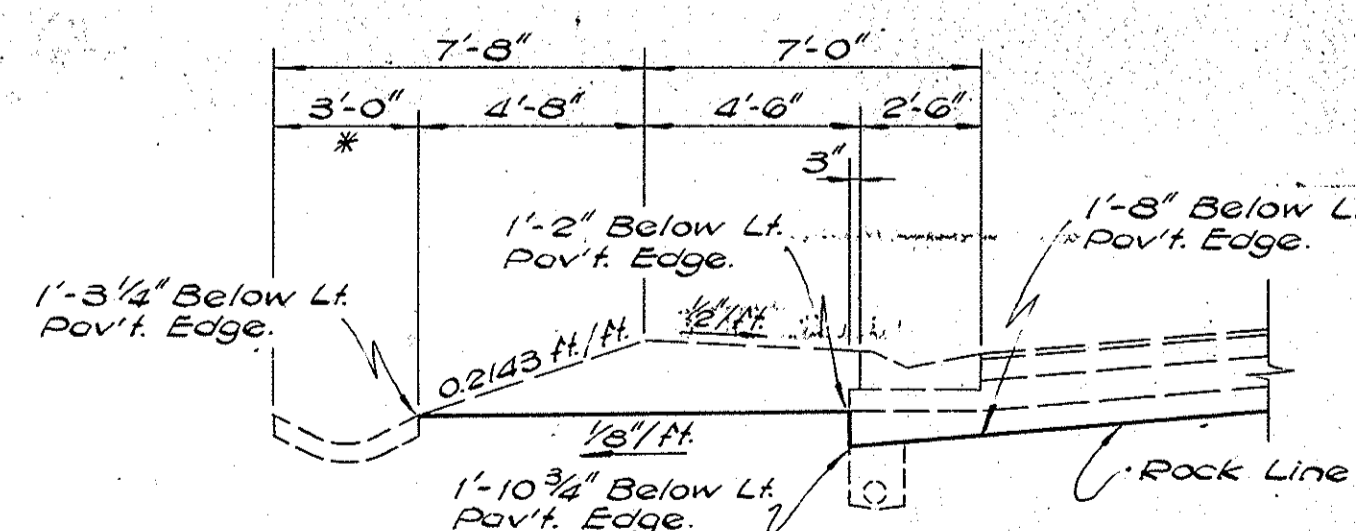

**RAMP SECTION IN ROCK
SUPERELEVATED TO LEFT
OVER 2% GRADE**

Sta. 1+27.90 to Sta. 4+60 SER
Sta. 21+30 to Sta. 23+85.81 NER

* For other than P.S.D. Type "A", grade as directed by the Engineer.

S.R. 37 INTERCHANGE GRADING TYPICAL CROSS SECTIONS


SCALE: 1/4" = 1'-0"

SUBMITTED FOR APPROVAL _____


ENGINEER OF ROAD DESIGN, INDIANA STATE HIGHWAY COMMISSION

PROJECT NO.	LINE	SHEET NO.	TOTAL SHEETS	FILE
I-64-3(33)86		14		


FEDERAL ROAD REGION NO.	STATE	PROJECT NO.	FISCAL YEAR	SHEET NO.	TOTAL SHEETS
4	IND.	I-64-3(33)86	1967	15	

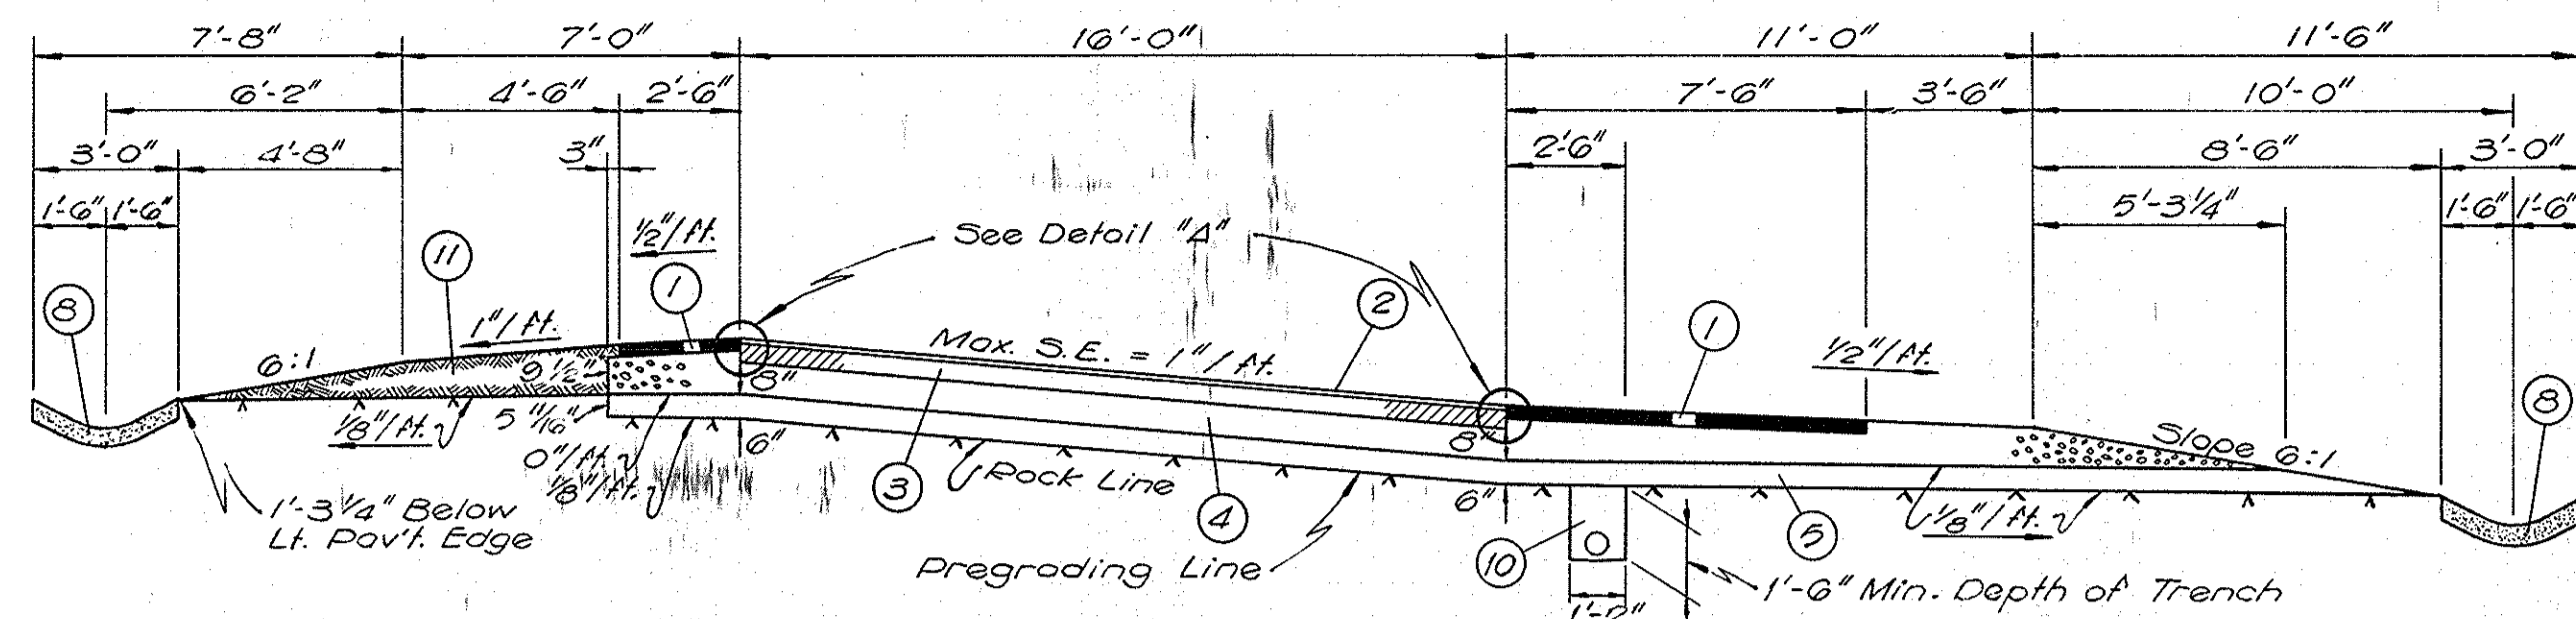


**RAMP SECTION IN ROCK ON TANGENT OR SUPERELEVATED TO RIGHT
LESS THAN 2% GRADE**

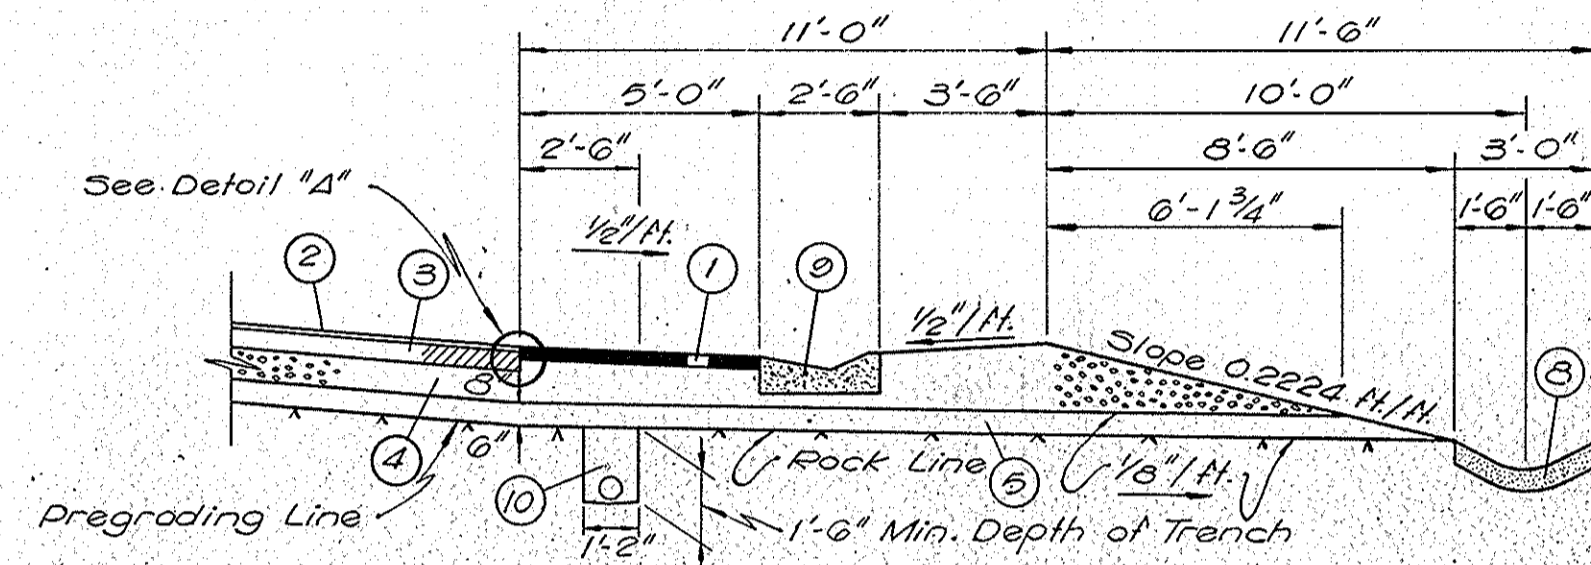


**RAMP SECTION IN ROCK ON TANGENT OR SUPERELEVATED TO RIGHT
OVER 2% GRADE**

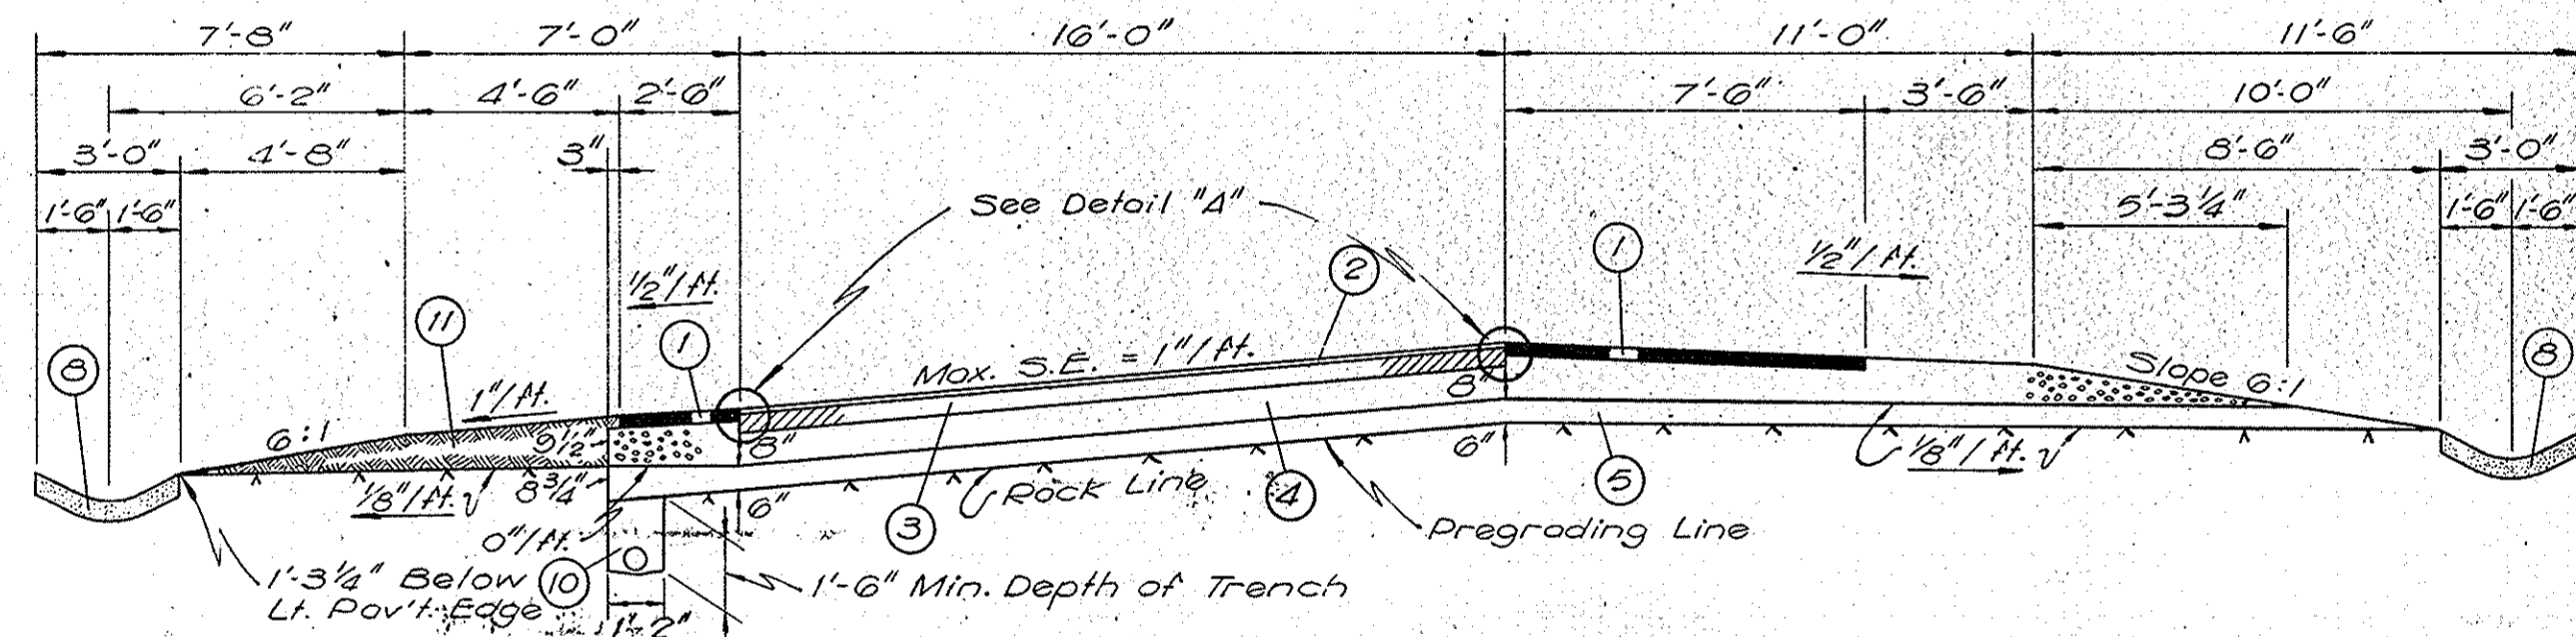

**RAMP SECTION IN ROCK SUPERELEVATED TO LEFT
LESS THAN 2% GRADE**

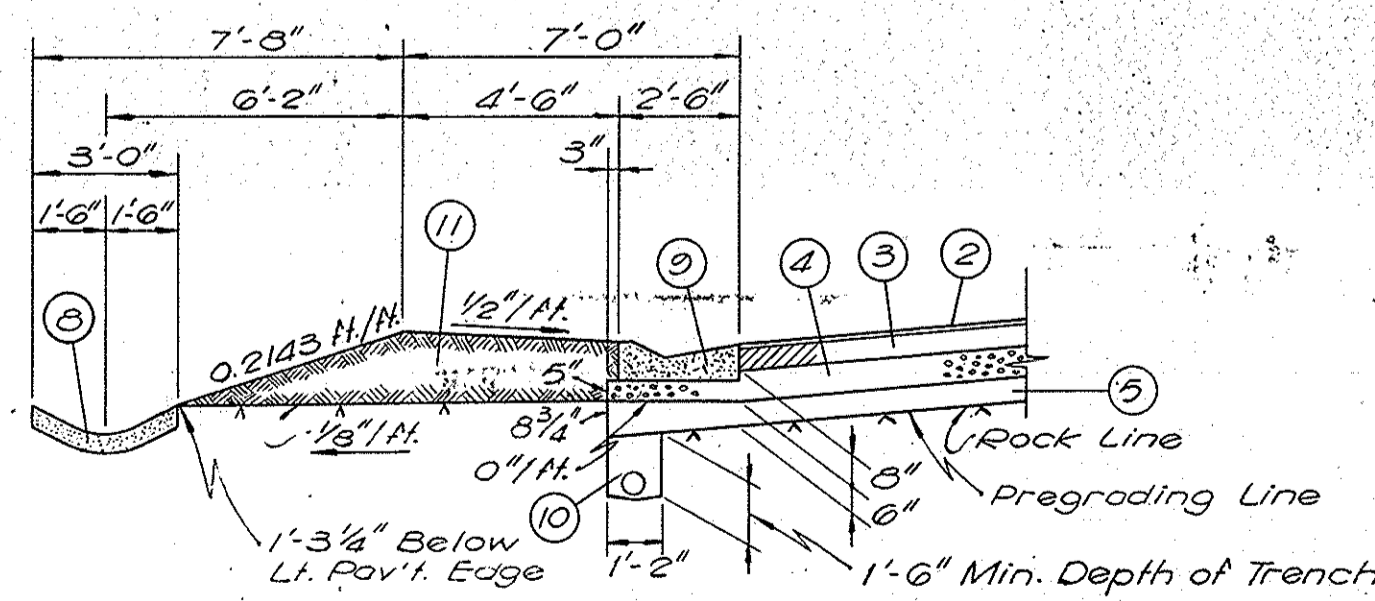

**RAMP SECTION IN ROCK SUPERELEVATED TO LEFT
OVER 2% GRADE**

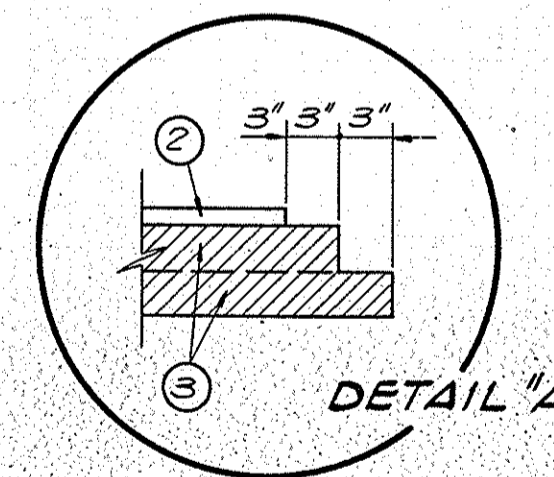

DETAIL "A"

LEGEND

- ① 3" Bituminous Shoulder
- ② 90#/SYD H.A.E. Surface Type III / H.A.C. Surface Type "B" (* Bituminous Surface)
- ③ 570#/SYD Hot Asphaltic Concrete Base (* Bituminous Base)
- ④ Type "D" Compacted Aggregate Base
- ⑤ Subbase Type II
- ⑥ Paved Side Ditch Type "A"
- ⑦ Standard Lip Gutter
- ⑧ Subsurface Drain - See Misc. Sheet "M"
- ⑨ Earth Backfill

* Indicates Pay Item


PAVING S.R. 37 INTERCHANGE TYPICAL CROSS SECTIONS

SCALE: 1/4" = 1'-0"

SUBMITTED FOR APPROVAL _____


ENGINEER OF ROAD DESIGN, INDIANA STATE HIGHWAY COMMISSION

PROJECT NO.	LINE	SHEET NO.	TOTAL SHEETS	FILE
I-64-3(33)86		15		

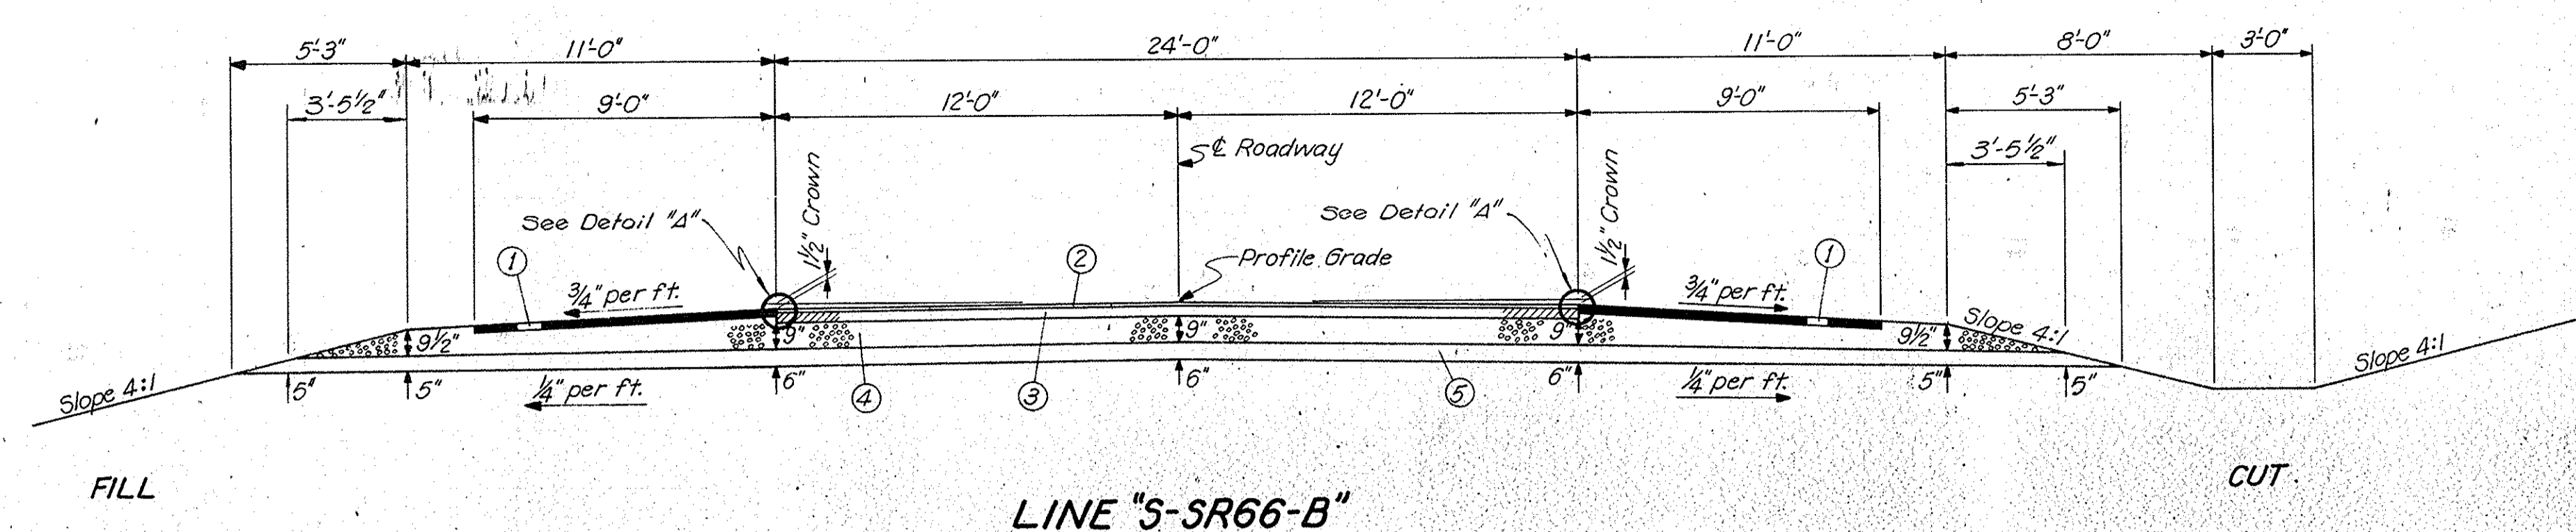


LINE "S-SR66-B"

Sta. 41+00.00 to Sta. 41+54.57
 Sta. 41+54.57 to Sta. 44+92.46 Lt.
 Sta. 41+54.57 to Sta. 45+04.57 (350' Taper on Rt.)
 Sta. 54+95.43 to Sta. 58+45.43 (350' Taper on Lt.)
 Sta. 55+07.54 to Sta. 58+45.43
 Sta. 58+45.43 to Sta. 59+00.00

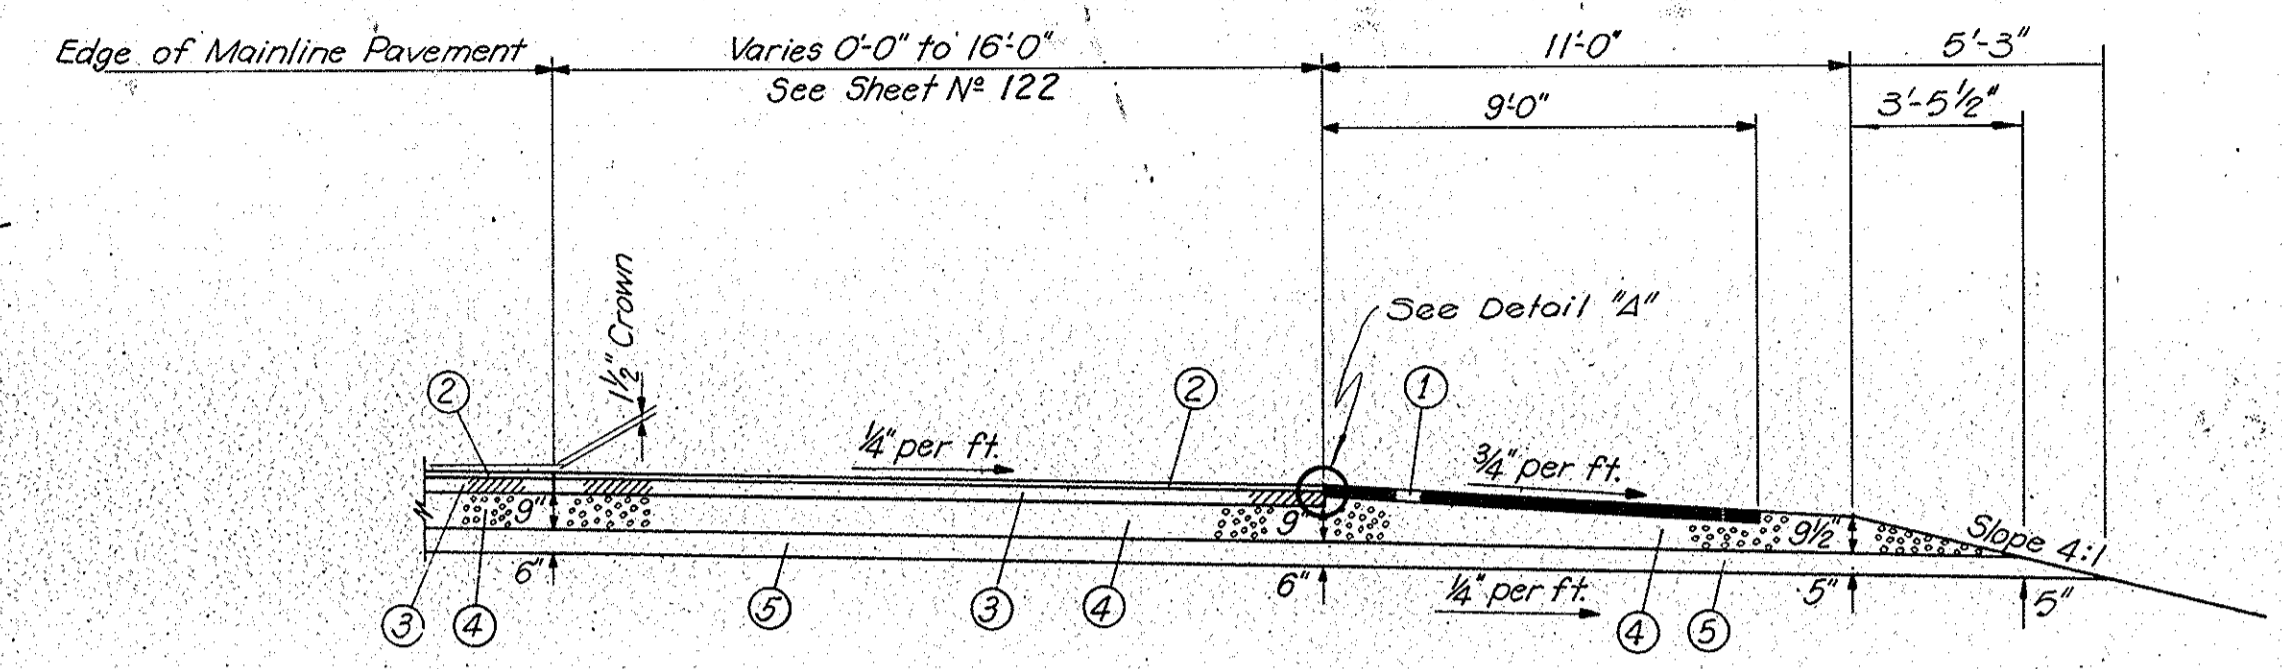

Sta. 41+54.57 to Sta. 45+04.57 Rt.
 Sta. 54+95.43 to Sta. 58+45.43 Lt.

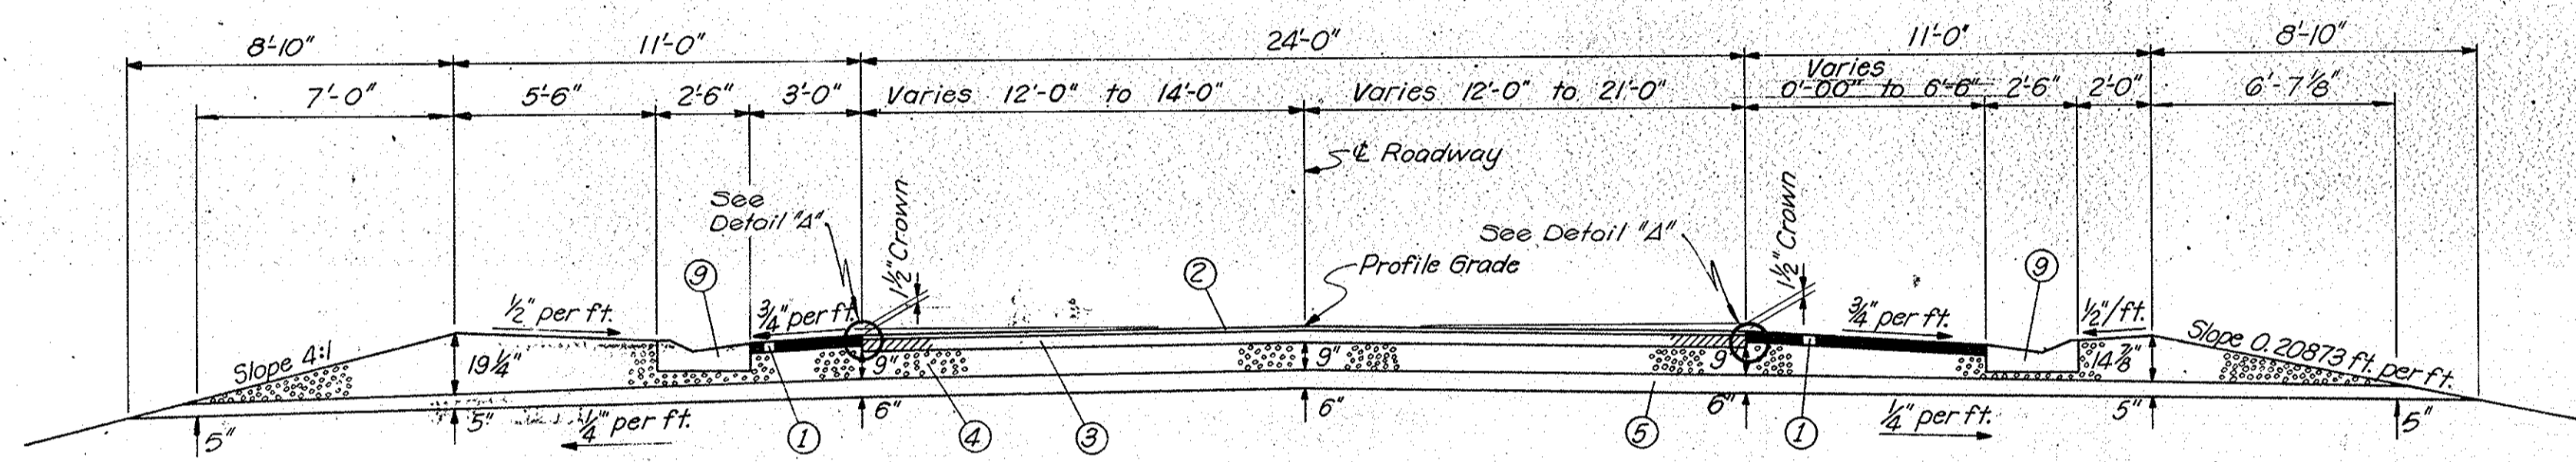


LINE "S-SR66-B"


Sta. 44+92.46 to Sta. 46+38.87 (see ramp intersection details on Sht. #122)	Sta. 45+04.57 to Sta. 46+34.16 (see ramp intersection details on Sht. #122)
Sta. 46+38.87 to Sta. 47+51.00	Sta. 46+34.16 to Sta. 47+24.16 (9/100 pvm't. taper)
Sta. 47+51.00 to Sta. 48+51.00 (2/100 pvm't. taper)	Sta. 47+24.16 to Sta. 48+51.00

SECTION REVERSED FOR FOLLOWING SECTIONS

Sta. 51+48.02 to Sta. 52+75.84	Sta. 51+48.02 to Sta. 52+48.02 (2/100 pvm't. taper)
Sta. 52+75.84 to Sta. 53+65.84 (9/100 pvm't. taper)	Sta. 52+48.02 to Sta. 53+61.13
Sta. 53+65.84 to Sta. 54+95.43 (see ramp intersection details on Sht. #122)	Sta. 53+61.13 to Sta. 55+07.54 (see ramp intersection details on Sht. #122)

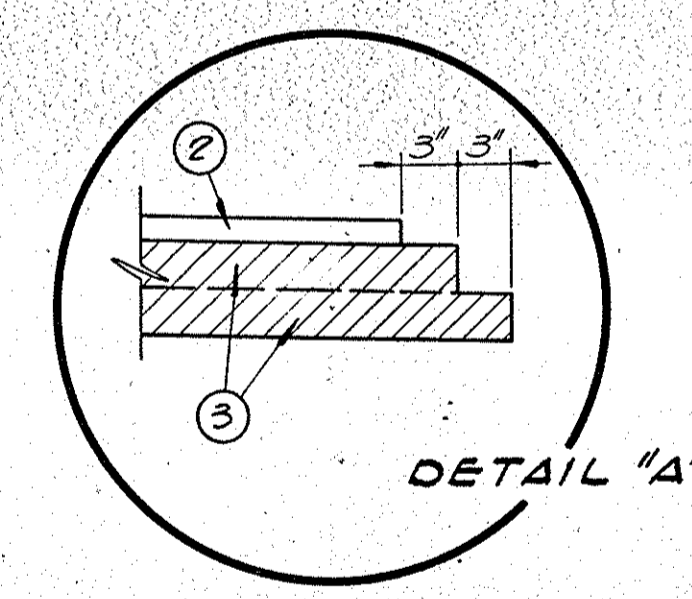

- LEGEND**
- ① 3" Bituminous Shoulder
 - ② 100#/SYD H.A.E. Surface Type III / H.A.C. Surface Type "B" (* Bituminous Surface)
 - ③ 450#/SYD H.A.C. Base (* Bituminous Base)
 - ④ Type "P" Compacted Aggregate Base
 - ⑤ Subbase Type II
 - ⑥ Standard Lip Gutter
- * Indicates Pay Item

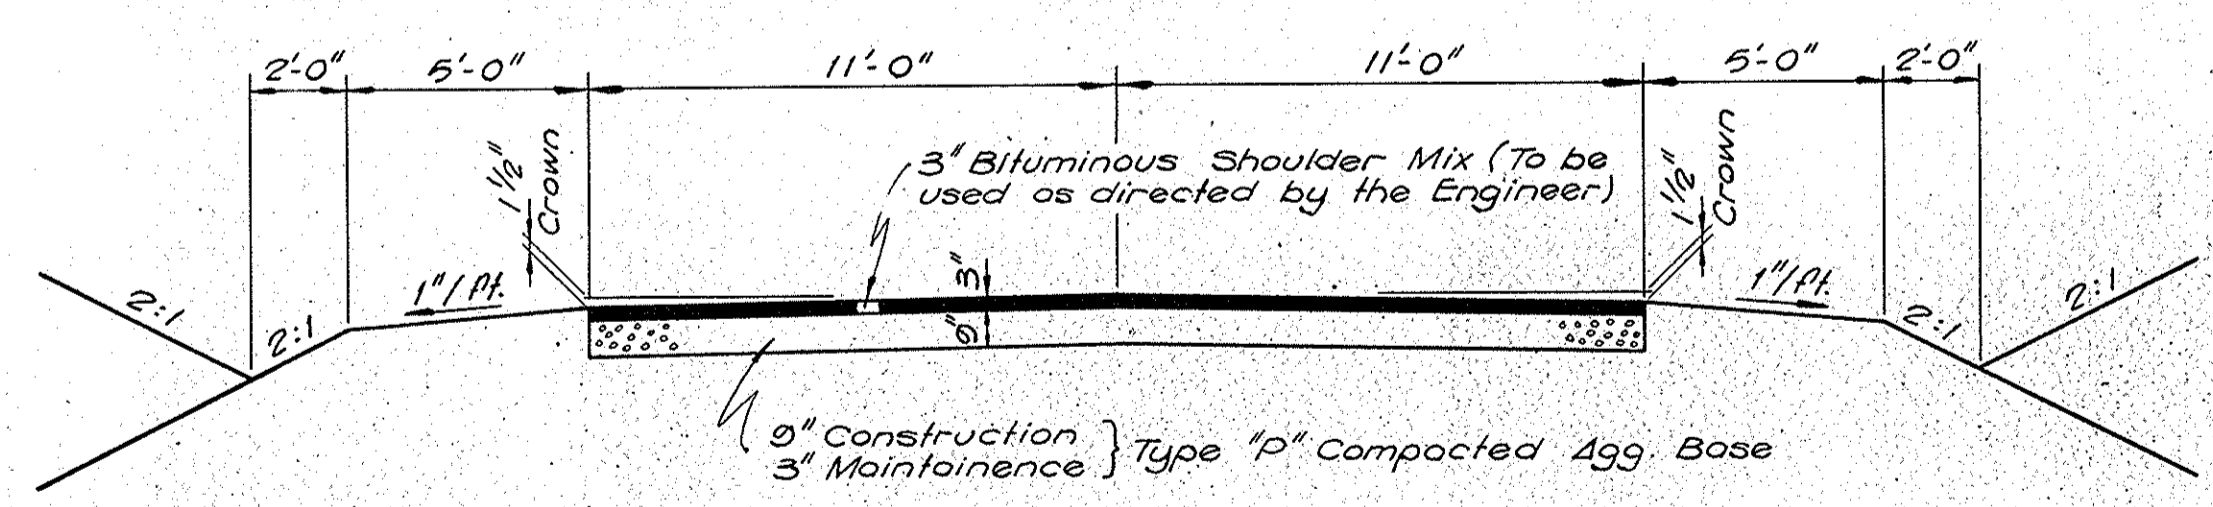

TEMPORARY RUNAROUND

Sta. 0+00.00 to Sta. 20+48.98


PAVING LINE "S-S.R.66-B" TYPICAL CROSS SECTIONS

SCALE: 1/4" = 1'-0"


SUBMITTED FOR APPROVAL

ENGINEER OF ROAD DESIGN, INDIANA STATE HIGHWAY COMMISSION

FEDERAL ROAD REGION NO.	STATE	PROJECT NO.	FISCAL YEAR	SHEET NO.	TOTAL SHEETS
4	IND.	1-64-3(33)86	1967	17	

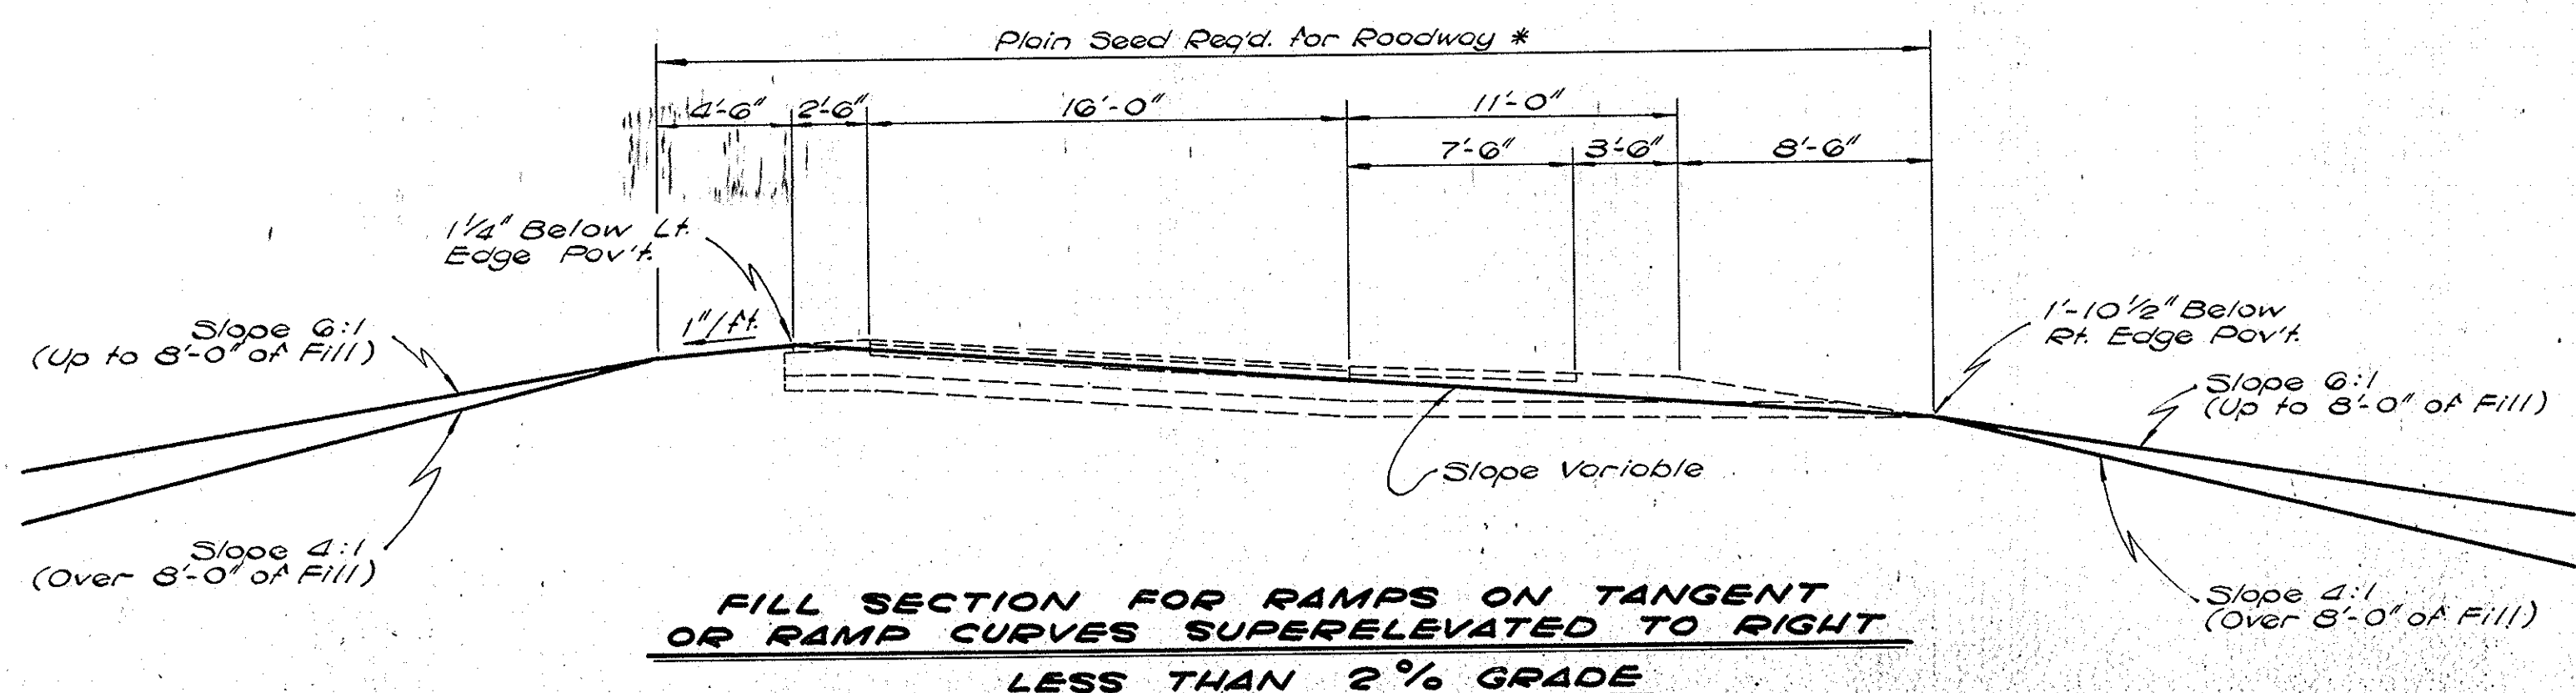


Sta. 8+80 to Sta. 10+70 SER
 Sta. 17+80 to Sta. 20+61.85 NER

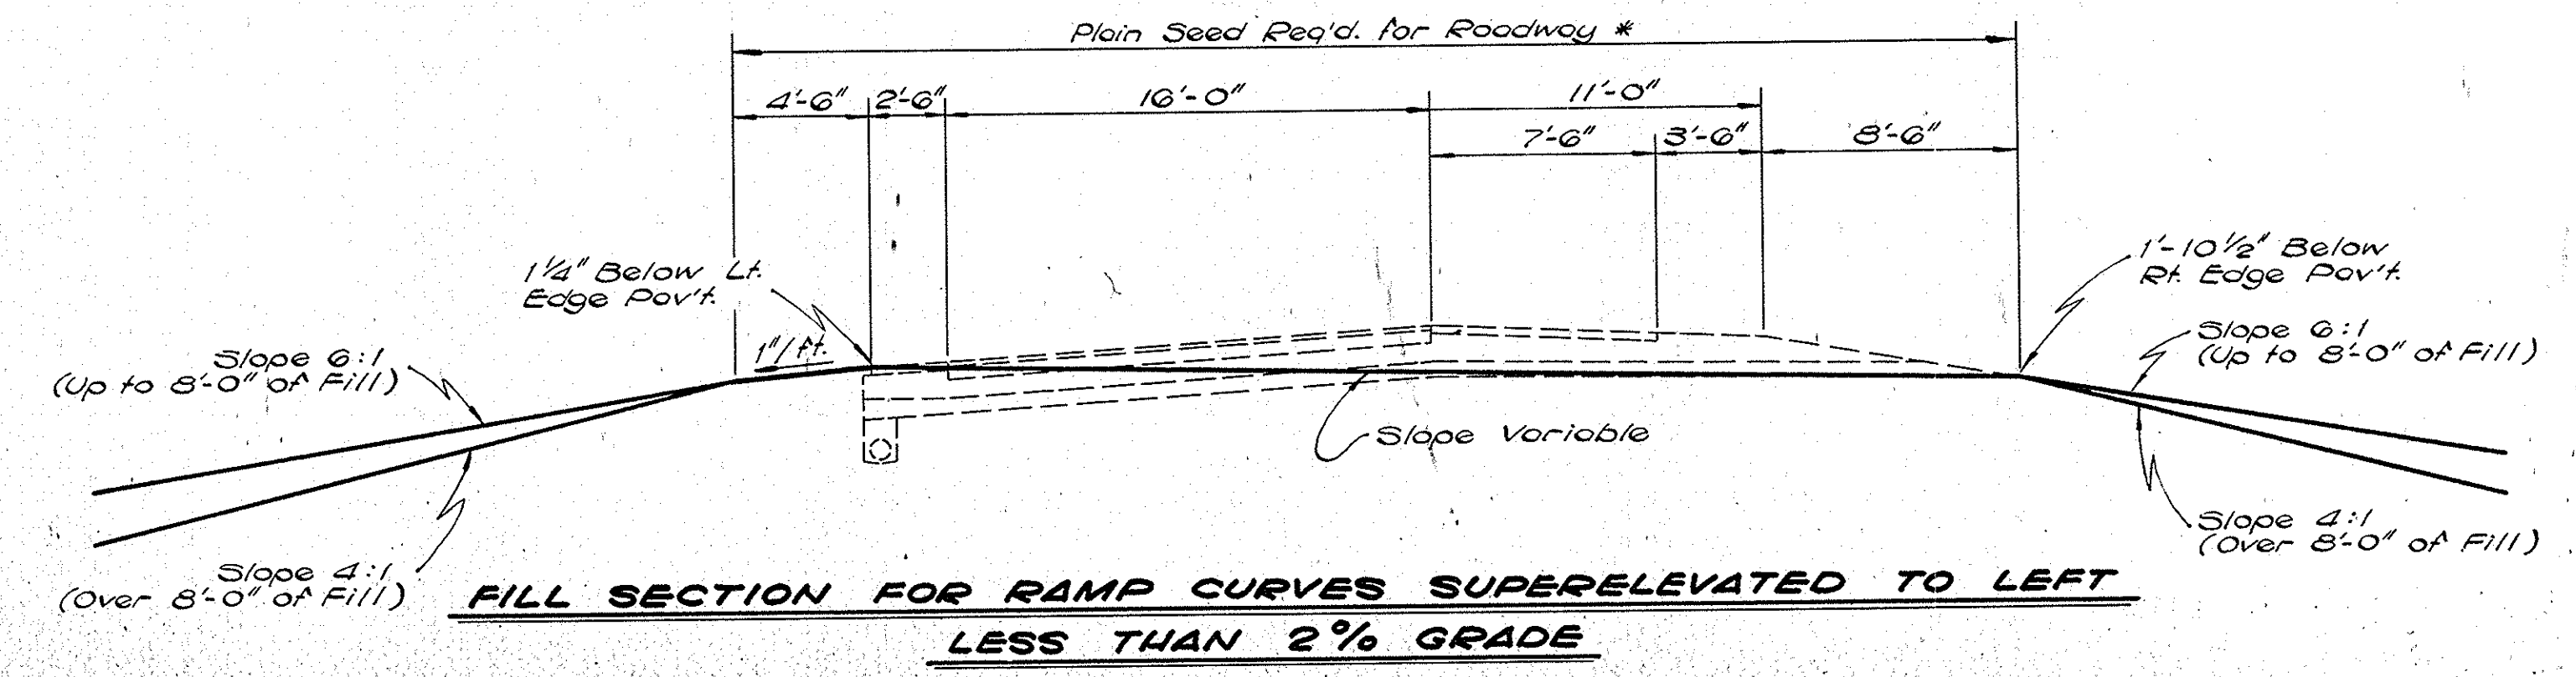


Sta. 1+27.90 to Sta. 4+50 SER

* Plain Seeding Req'd. - 140#/Acre
 Agricultural Rye.

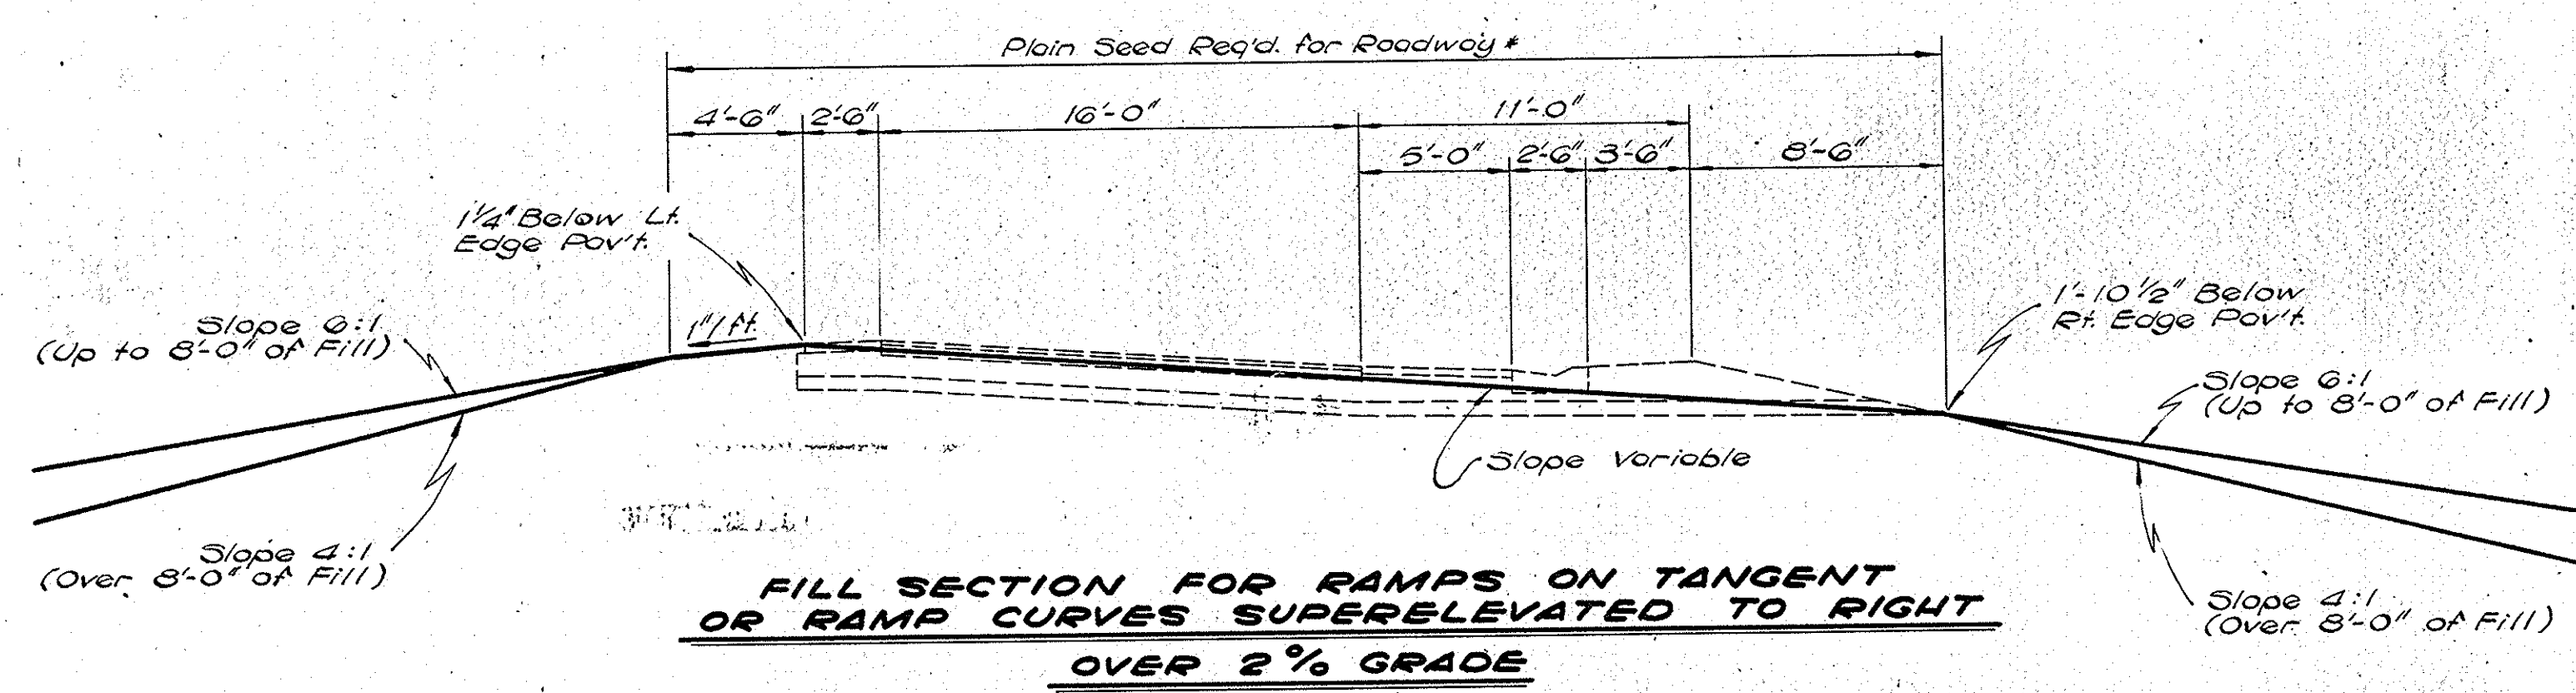

Sta. 15+70 to Sta. 21+74.78 SWR
 Sta. 7+50 to Sta. 19+37.46 NWR

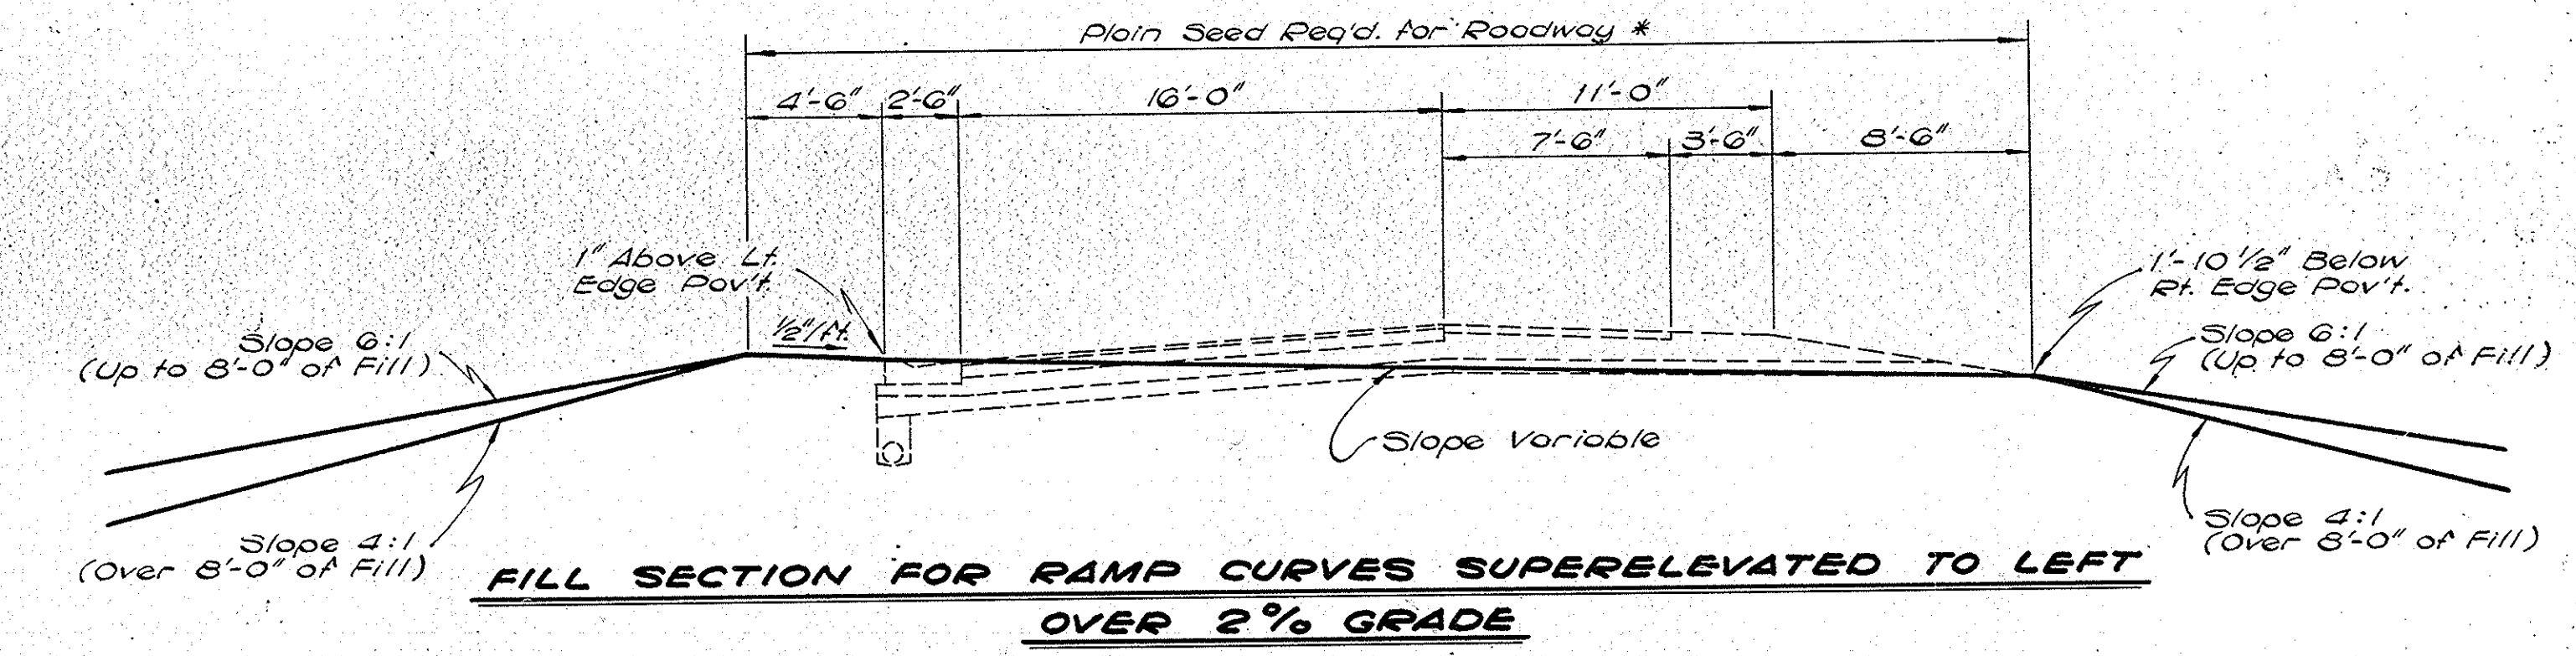

Sta. 1+27.90 to Sta. 3+25 NWR


S.R.66 INTERCHANGE GRADING TYPICAL CROSS SECTIONS

SCALE: 3/16" = 1'-0"


SUBMITTED FOR APPROVAL _____

ENGINEER OF ROAD DESIGN, INDIANA STATE HIGHWAY COMMISSION


PROJECT NO.	LINE	SHEET NO.	TOTAL SHEETS	FILE
1-64-3(33)86		17		

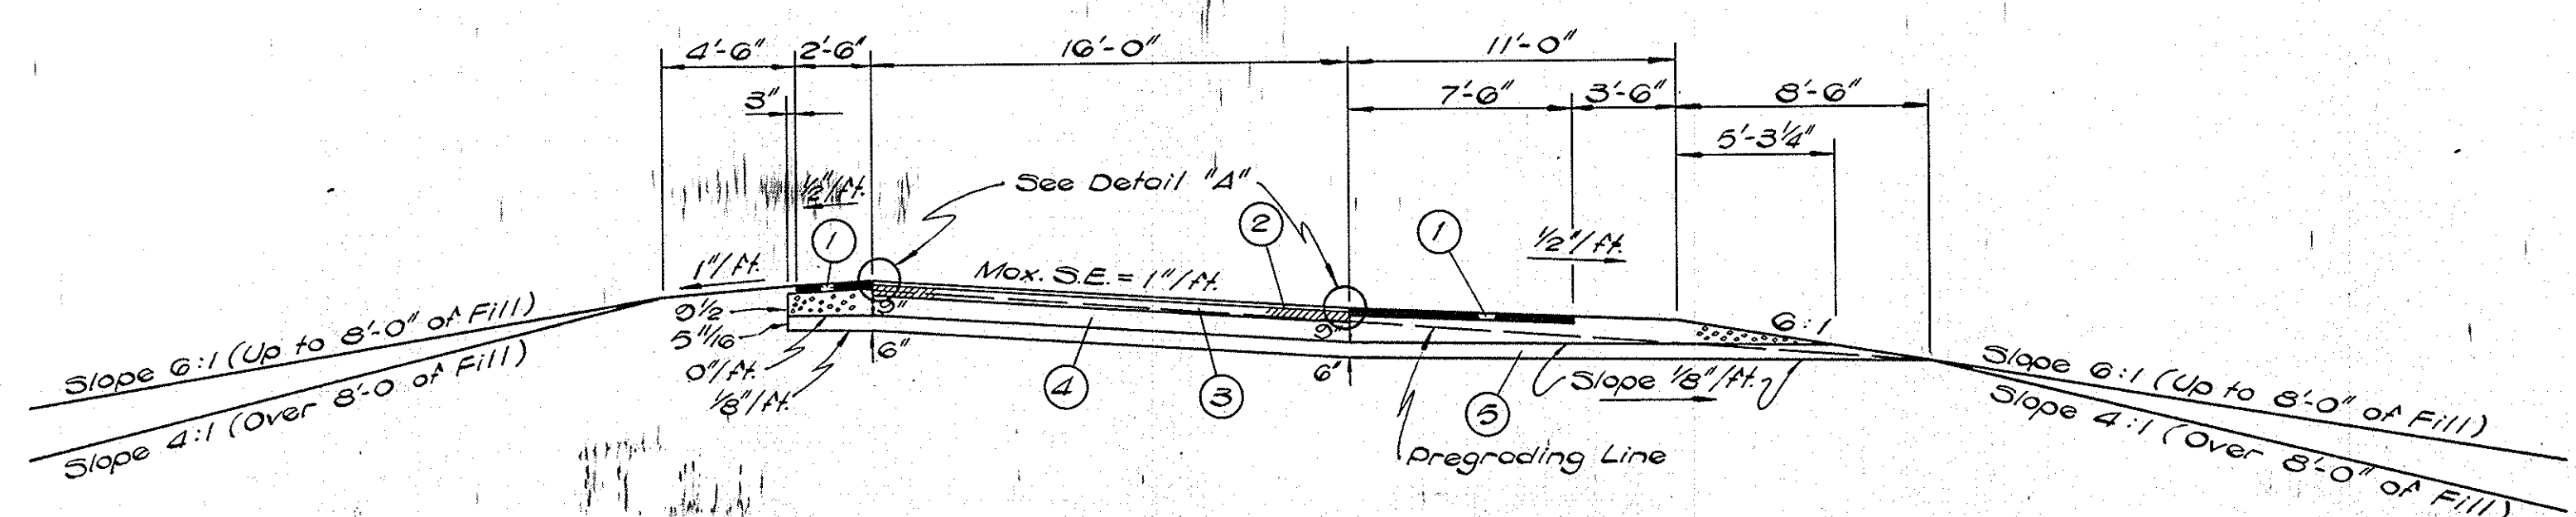


**FILL SECTION FOR RAMP CURVES SUPERELEVATED TO RIGHT
LESS THAN 2% GRADE**

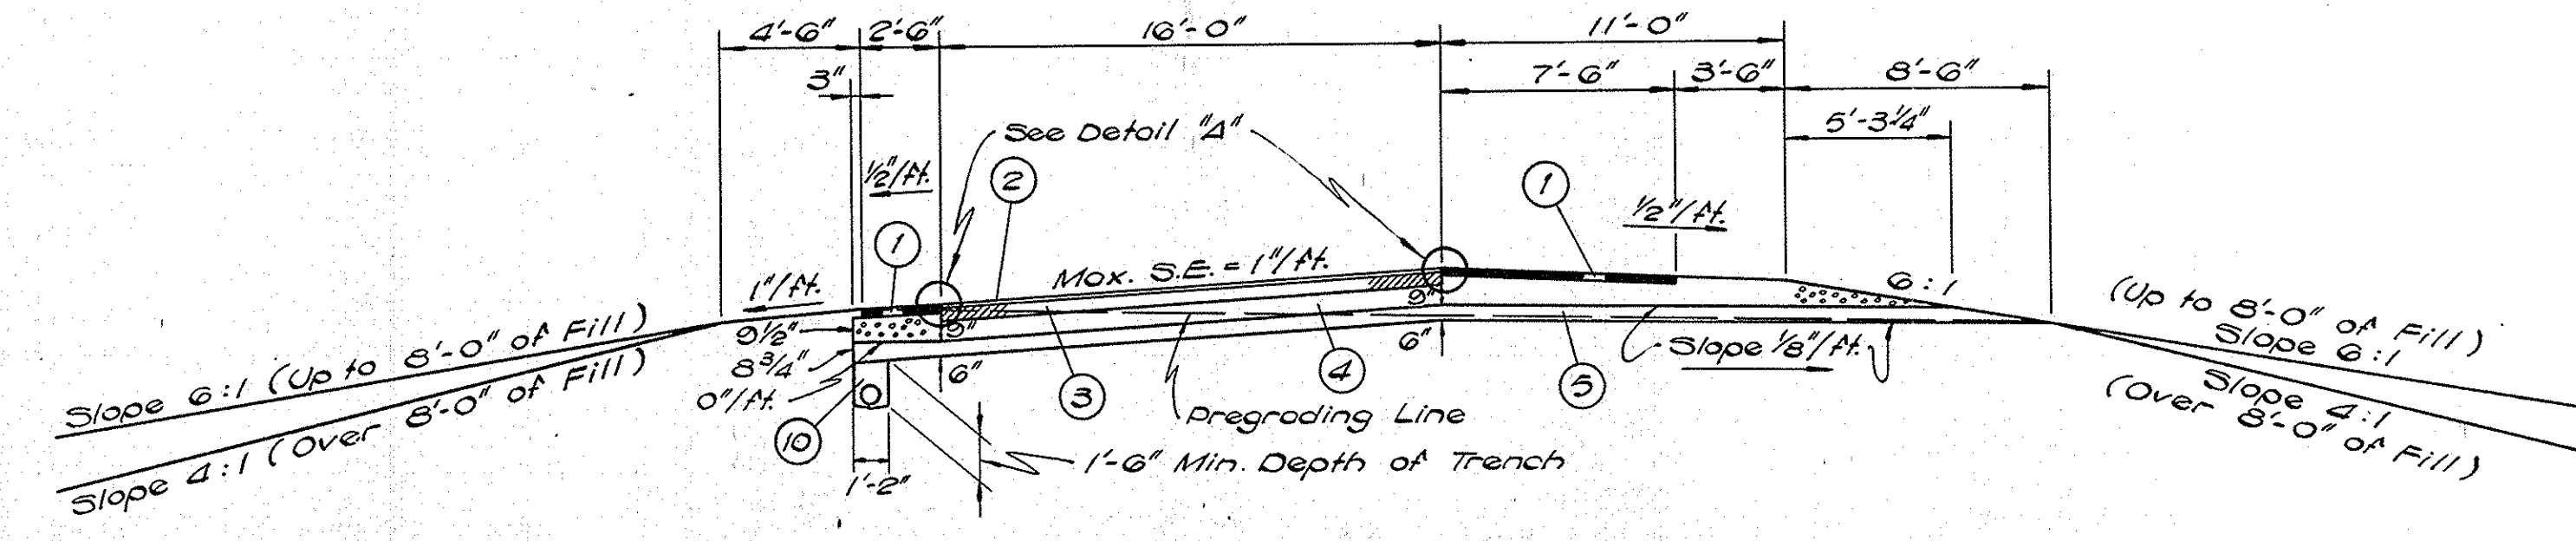


**FILL SECTION FOR RAMP CURVES SUPERELEVATED TO LEFT
LESS THAN 2% GRADE**

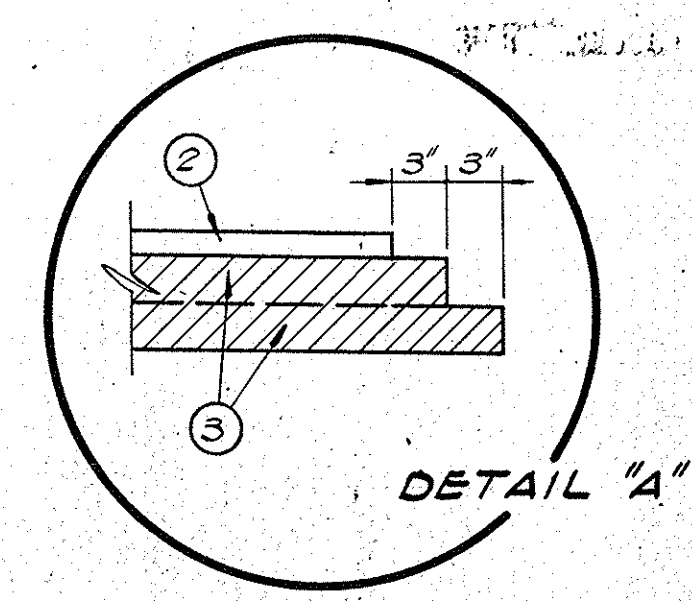

DETAIL "A"

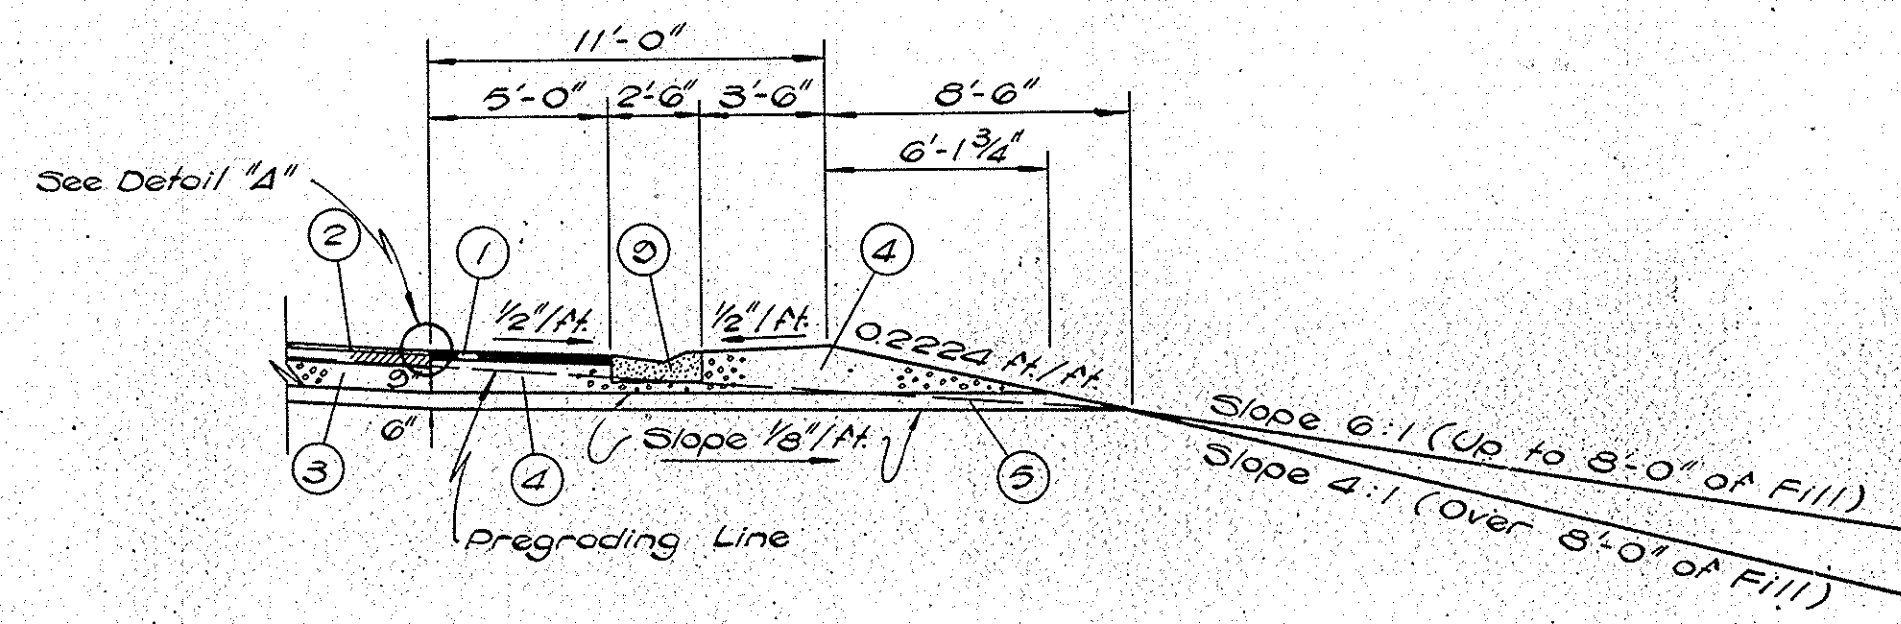

**FILL SECTION FOR RAMP CURVES SUPERELEVATED TO RIGHT
OVER 2% GRADE**

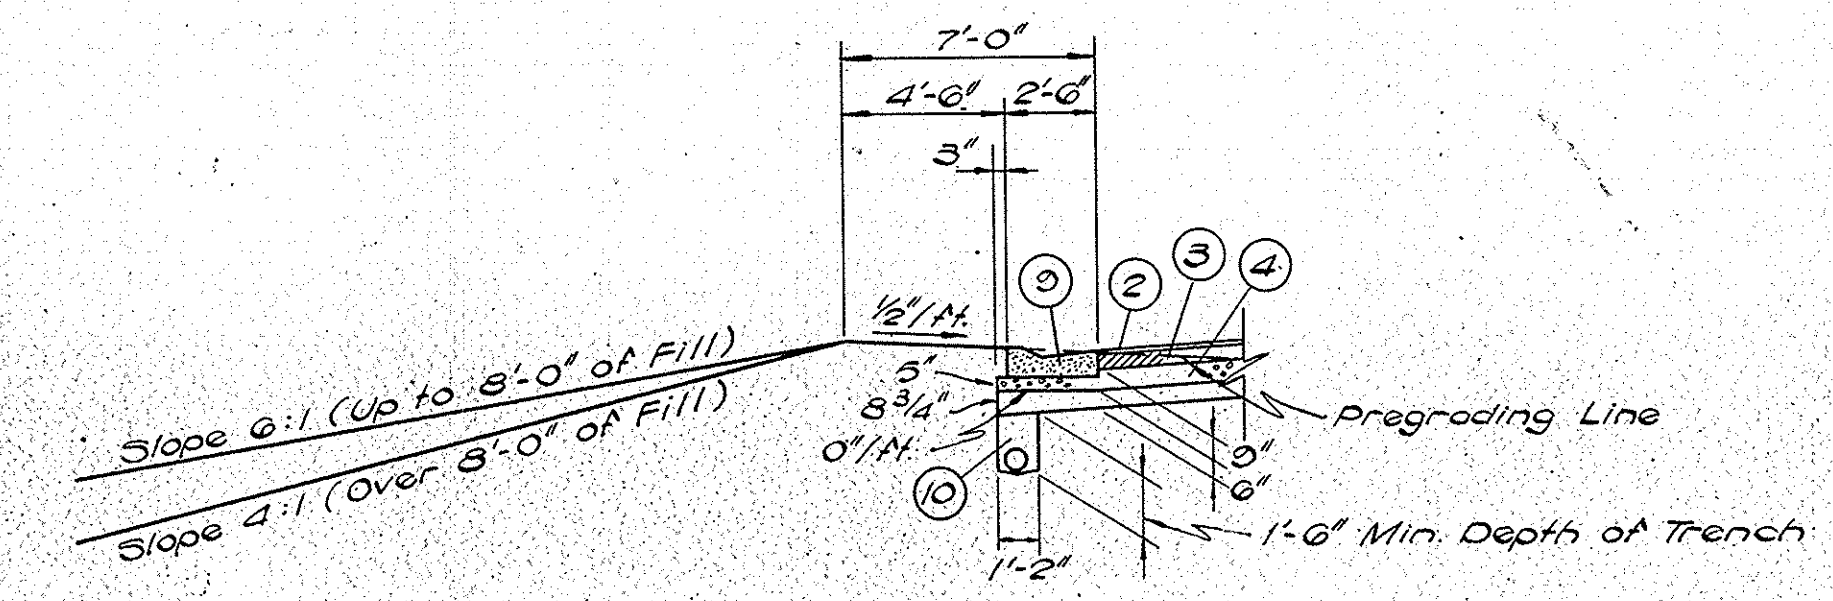

**FILL SECTION FOR RAMP CURVES SUPERELEVATED TO LEFT
OVER 2% GRADE**

LEGEND

- ① 3' Bituminous Shoulder
- ② 100#/3YD H.A.E. Surface Type III / H.A.C. Surface Type "B" (*Bituminous Surface)
- ③ 450#/3YD Hot Asphaltic Concrete Base (*Bituminous Base)
- ④ Type "P" Compacted Aggregate Base
- ⑤ Subbase Type II
- ⑥ Paved Side Ditch Type "A"
- ⑦ Standard Lip Gutter
- ⑩ Subsurface Drain - See Misc. Std. Sheet 111

* Indicates Pay Item


PAVING S.R.66 INTERCHANGE TYPICAL CROSS SECTIONS

SCALE: 3/16" = 1'-0"


SUBMITTED FOR APPROVAL _____

ENGINEER OF ROAD DESIGN, INDIANA STATE HIGHWAY COMMISSION


FEDERAL ROAD REGION NO.	STATE	PROJECT NO.	FISCAL YEAR	SHEET NO.	TOTAL SHEETS
4	IND.	I-64-3(33)86	1967	19	

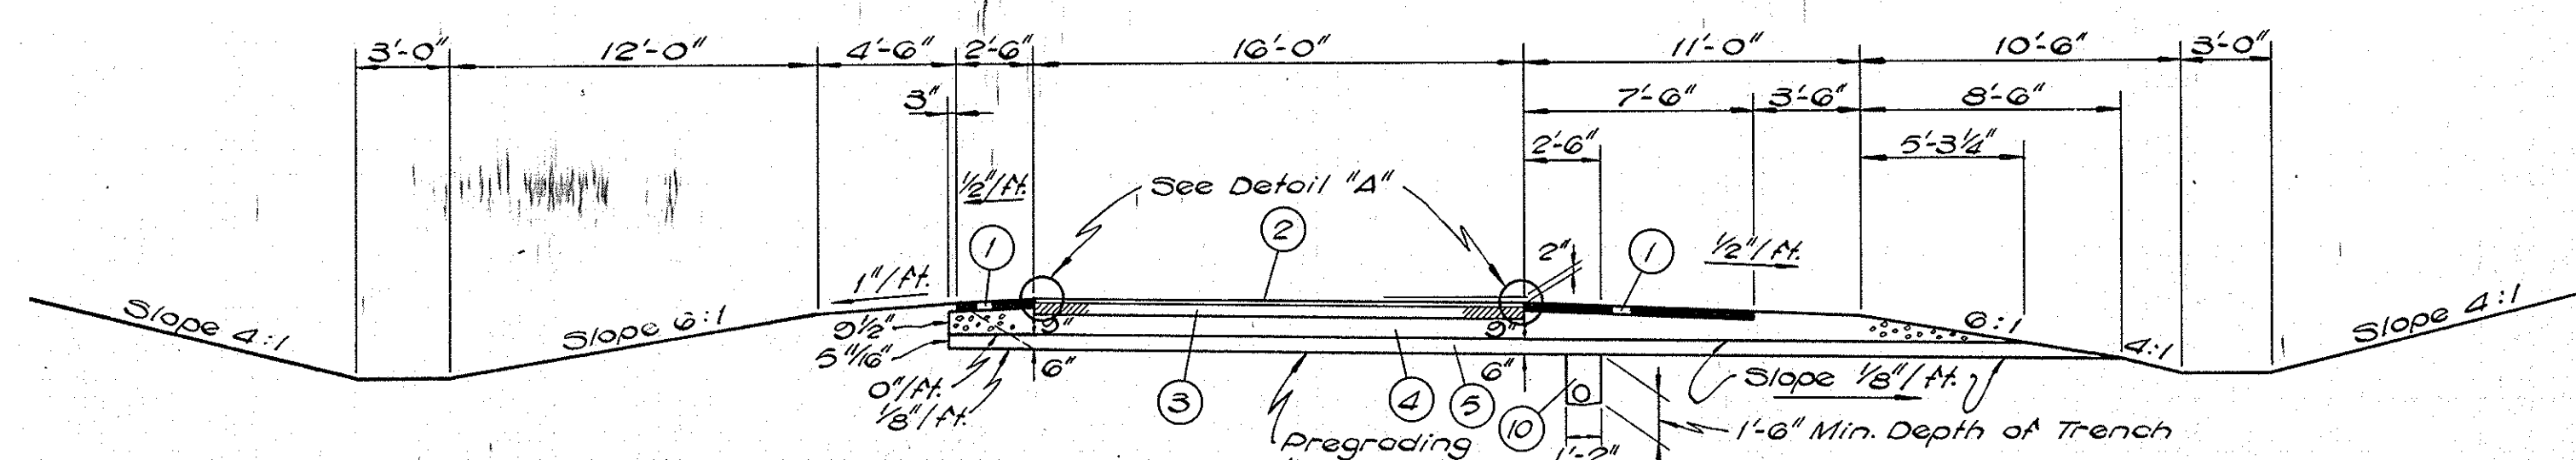


**CUT SECTION FOR RAMPS ON TANGENT
LESS THAN 2% GRADE**

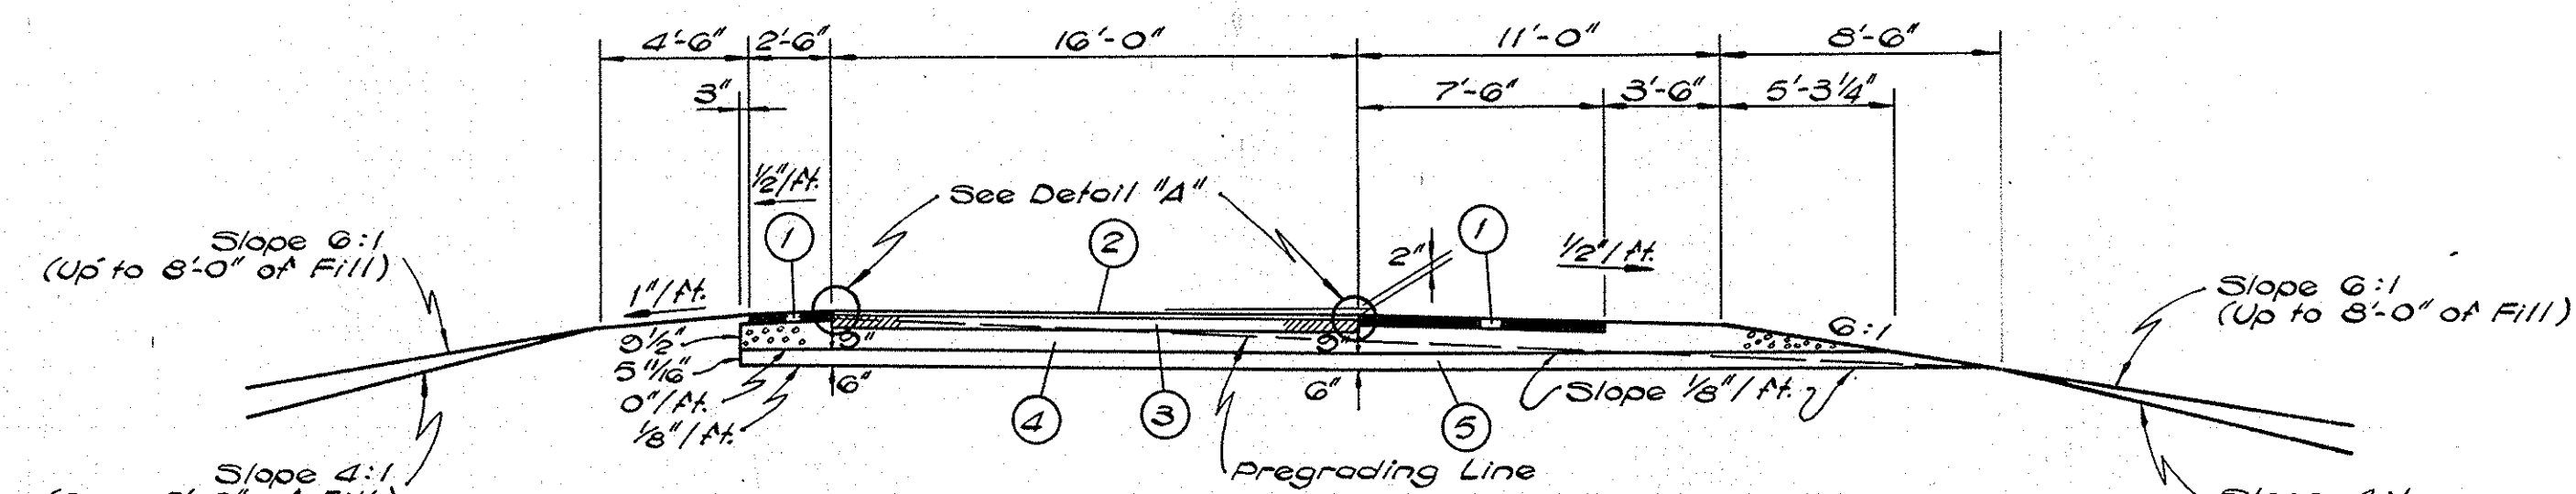


**FILL SECTION FOR RAMPS ON TANGENT
LESS THAN 2% GRADE**

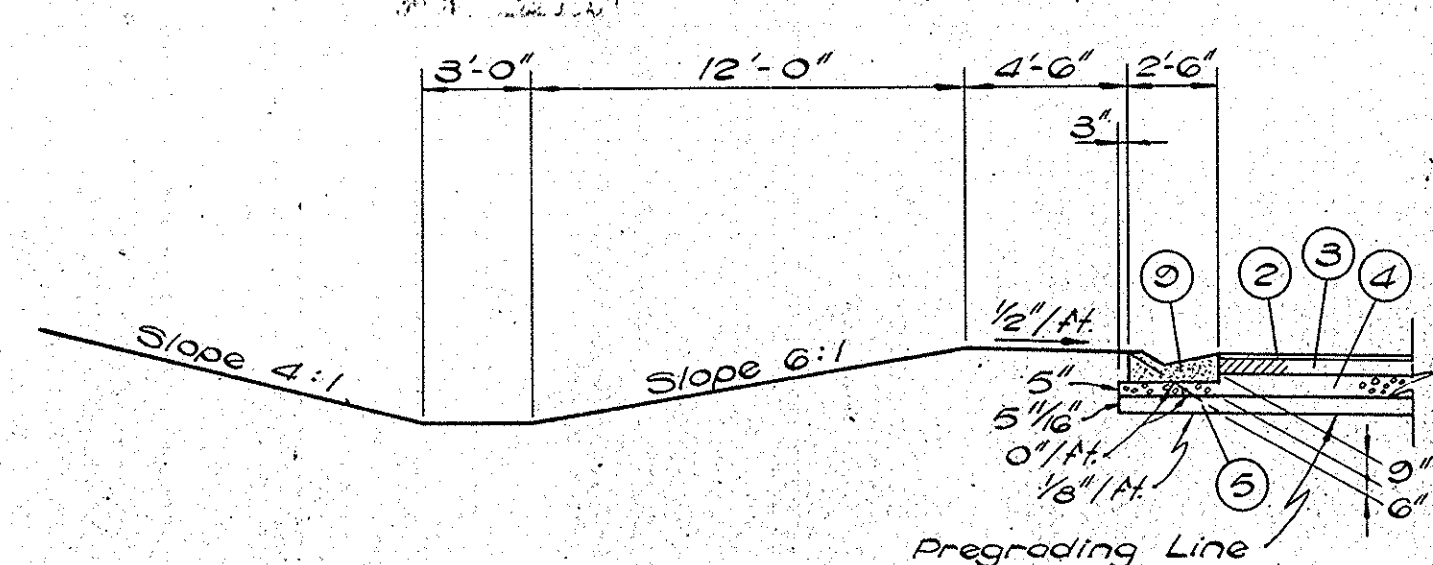

**CUT SECTION FOR RAMPS ON TANGENT
OVER 2% GRADE**

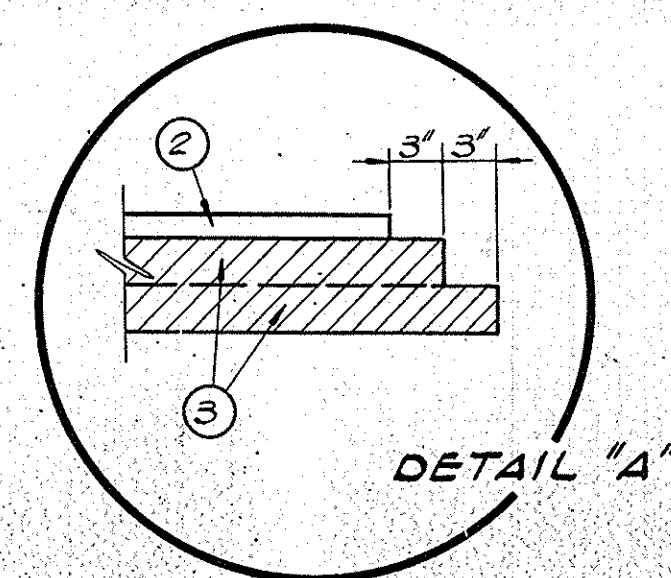

DETAIL "A"

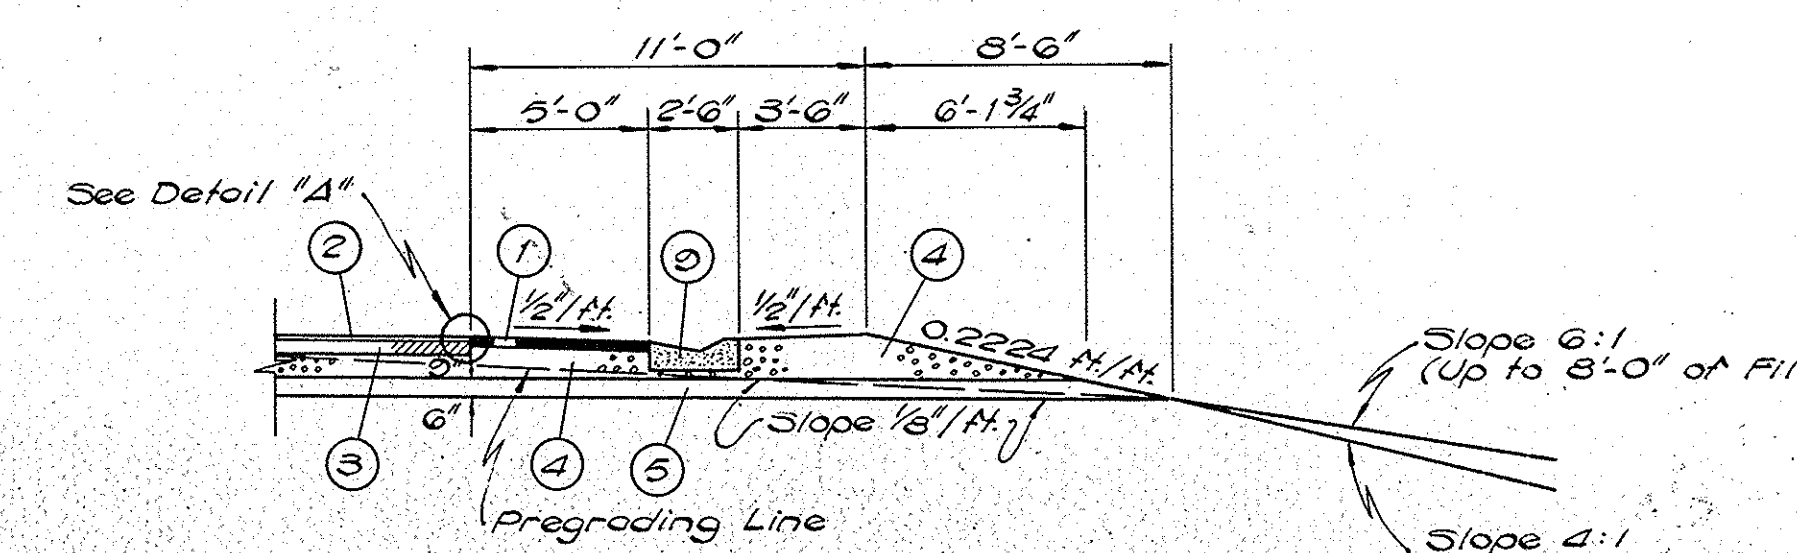

**FILL SECTION FOR RAMPS ON TANGENT
OVER 2% GRADE**

LEGEND

- ① 3" Bituminous Shoulder
 - ② 100#/SYD H.A.E. Surface Type III/H.A.C. Surface Type "B" (* Bituminous Surface)
 - ③ 450 #/SYD Hot Asphaltic Concrete Base (* Bituminous Base)
 - ④ Type "P" Compacted Aggregate Base
 - ⑤ Subbase Type II
 - ⑥ Standard Lip Gutter
 - ⑩ Subsurface Drain - See Misc. Std. Sheet "A"
- * Indicates Pay Item

PAVING S.R. 66 INTERCHANGE TYPICAL CROSS SECTIONS


SCALE: 3/16" = 1'-0"

SUBMITTED FOR APPROVAL _____

ENGINEER OF ROAD DESIGN, INDIANA STATE HIGHWAY COMMISSION


PROJECT NO.	LINE	SHEET NO.	TOTAL SHEETS	FILE
I-64-3(33)86		19		

FEDERAL ROAD REGION NO.	STATE	PROJECT NO.	FISCAL YEAR	SHEET NO.	TOTAL SHEETS
4	IND	I-64-3(33)86	1967	20	

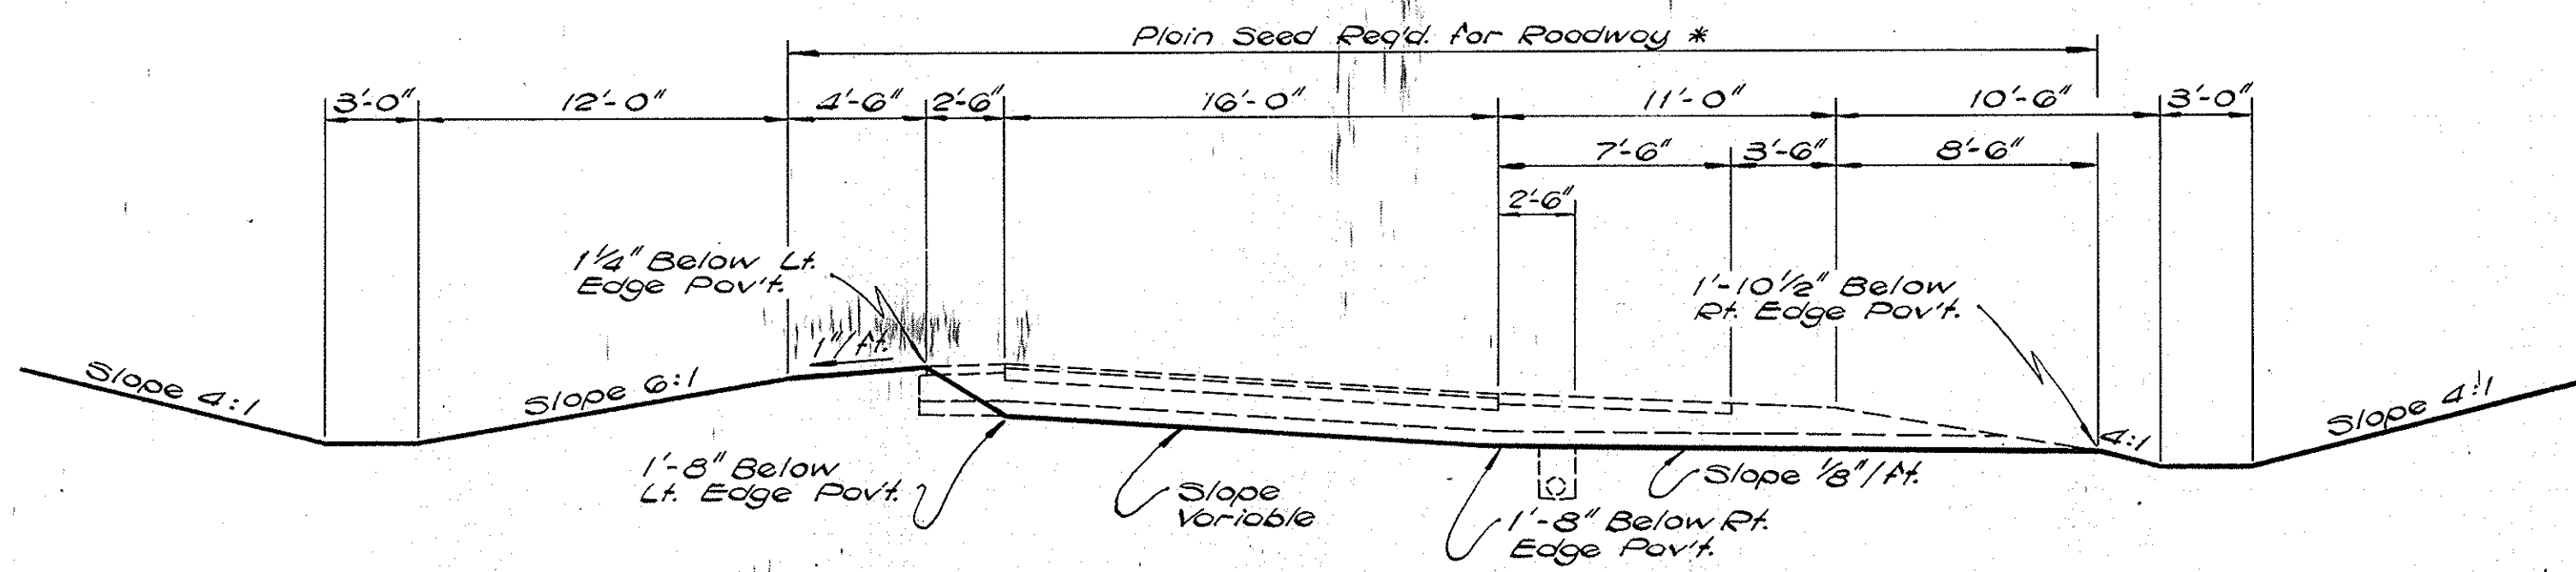

CUT SECTION FOR RAMPS ON TANGENT OR RAMP CURVES SUPERELEVATED TO RIGHT LESS THAN 2% GRADE


Sta. 7+62 to Sta. 8+80 SER
 Sta. 10+70 to Sta. 14+50 SER
 Sta. 8+97.47 to Sta. 17+80 NER

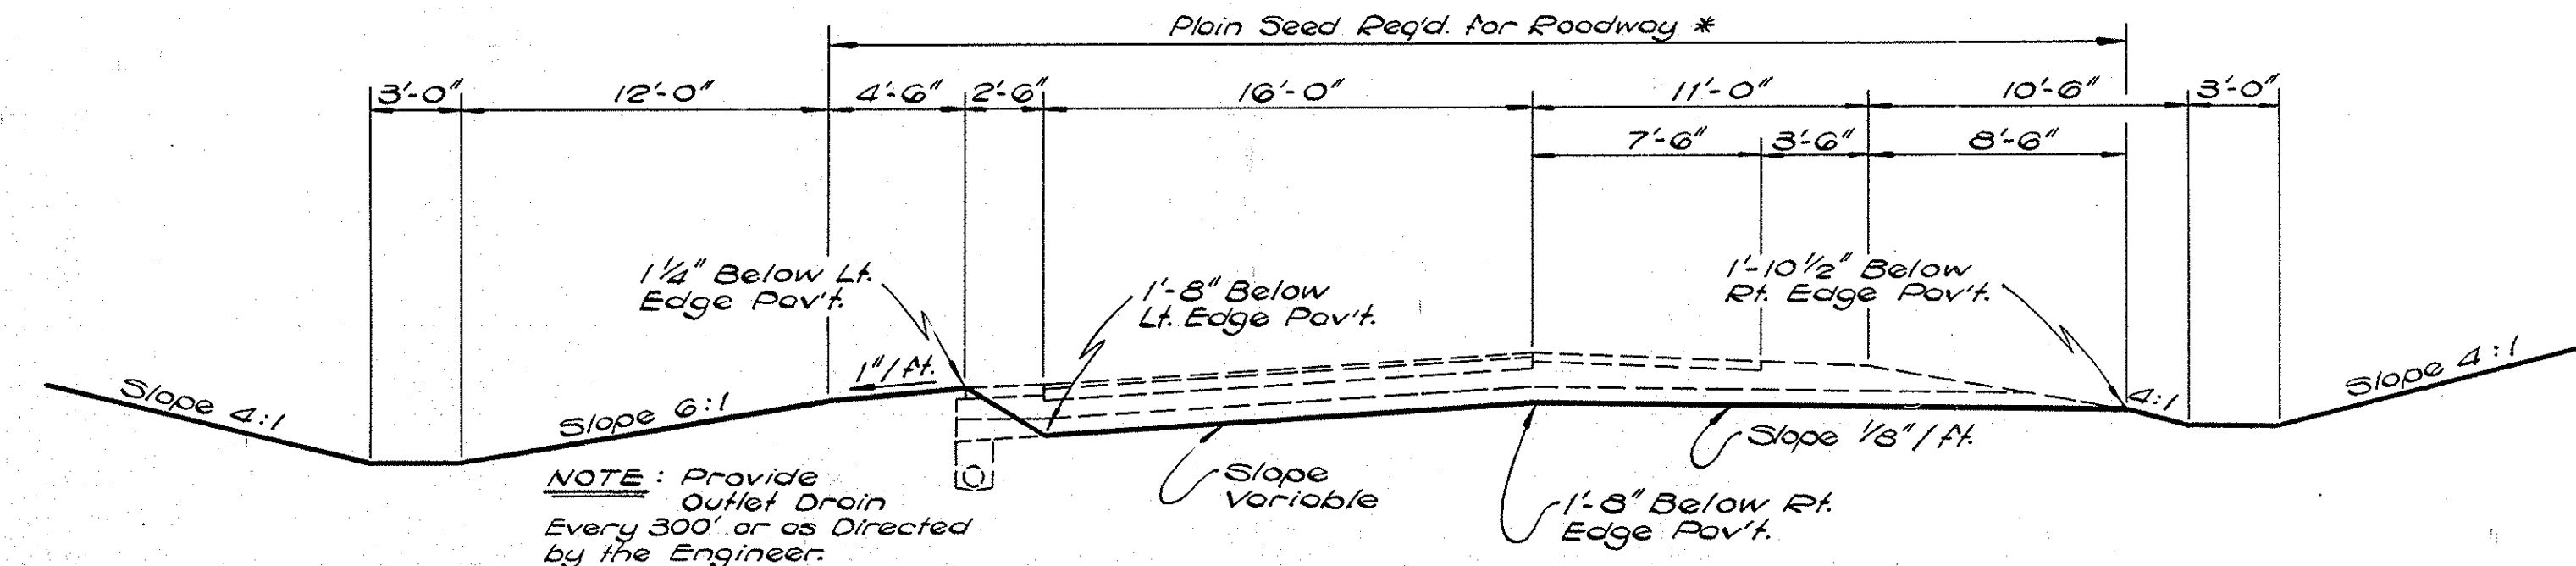

CUT SECTION FOR RAMP CURVES SUPERELEVATED TO LEFT LESS THAN 2% GRADE


Sta. 4+50 to Sta. 7+62 SER

* Plain Seeding Req'd. - 120#/Acre Agricultural Rye.

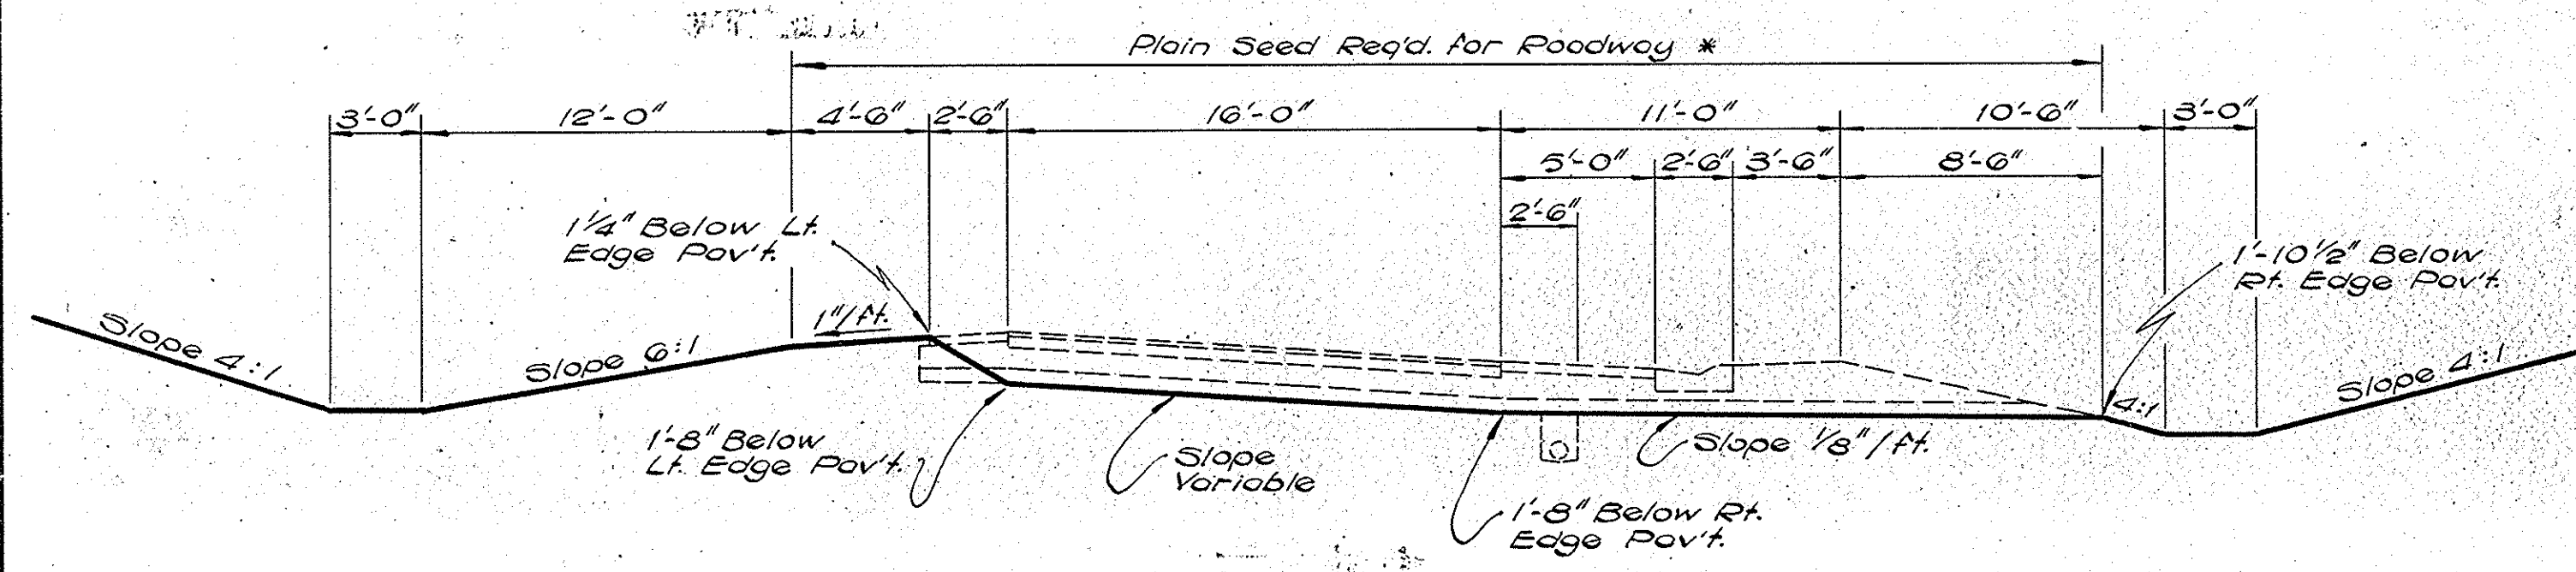

CUT SECTION FOR RAMPS ON TANGENT OR RAMP CURVES SUPERELEVATED TO RIGHT OVER 2% GRADE

Sta. 14+50 to Sta. 16+29.03 SER
 Sta. 9+00.72 to Sta. 15+70 SWR
 Sta. 6+83 to Sta. 7+50 NWR

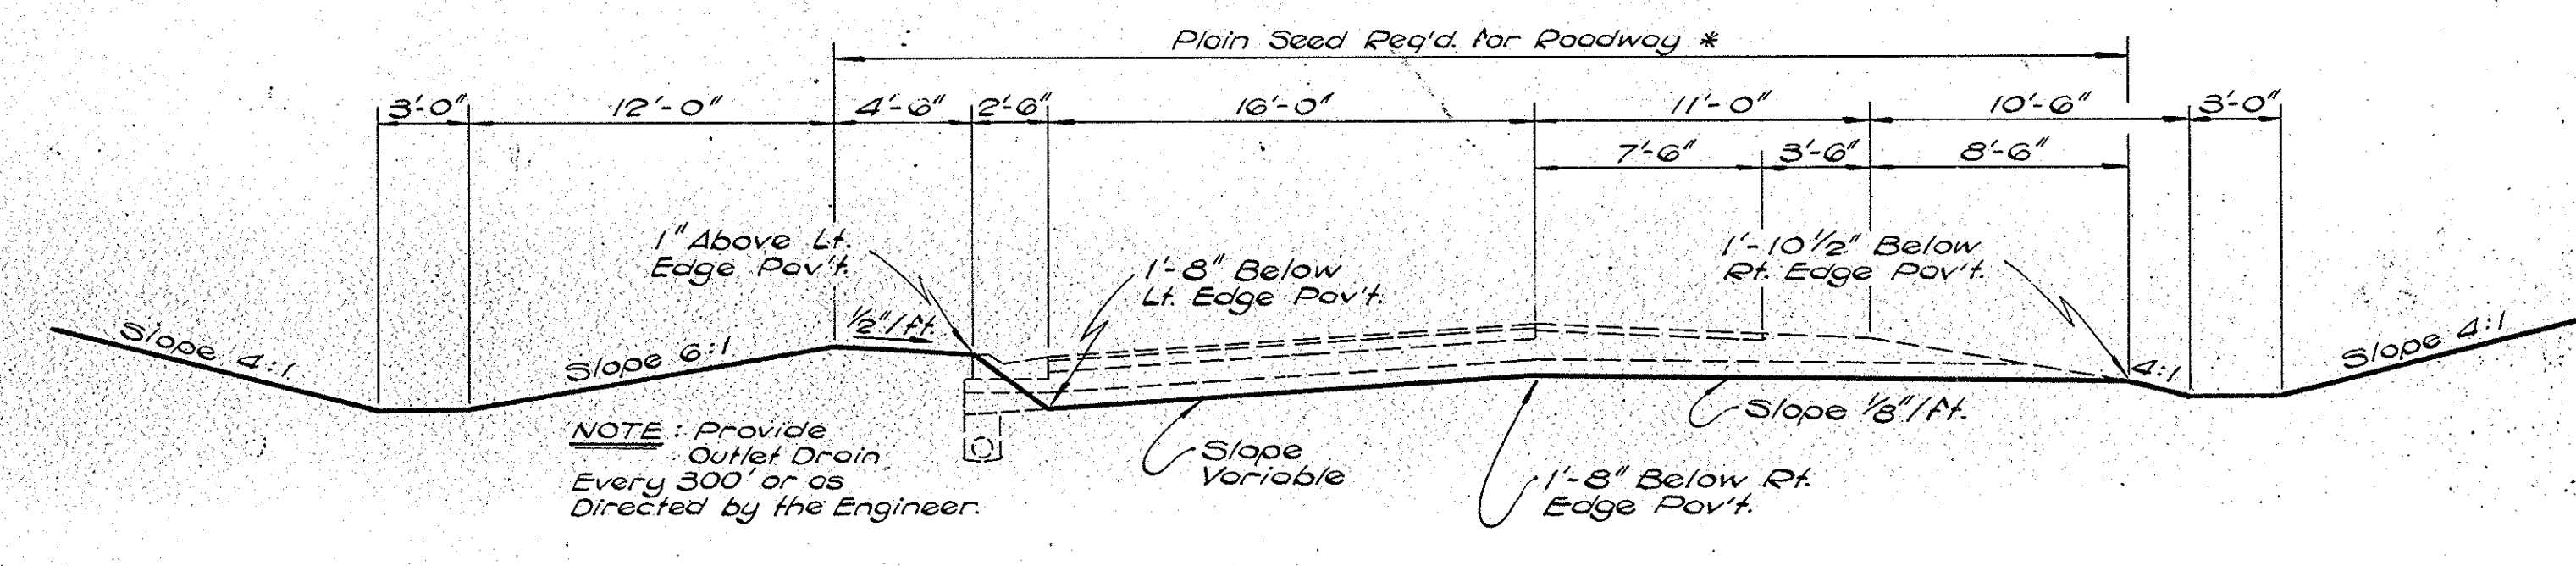

CUT SECTION FOR RAMP CURVES SUPERELEVATED TO LEFT OVER 2% GRADE

Sta. 3+25 to Sta. 6+83 NWR


S.R.66 INTERCHANGE GRADING TYPICAL CROSS SECTIONS

SCALE: 3/16" = 1'-0"


SUBMITTED FOR APPROVAL _____

ENGINEER OF ROAD DESIGN, INDIANA STATE HIGHWAY COMMISSION


PROJECT NO.	LINE	SHEET NO.	TOTAL SHEETS	FILE
I-64-3(33)86		20		

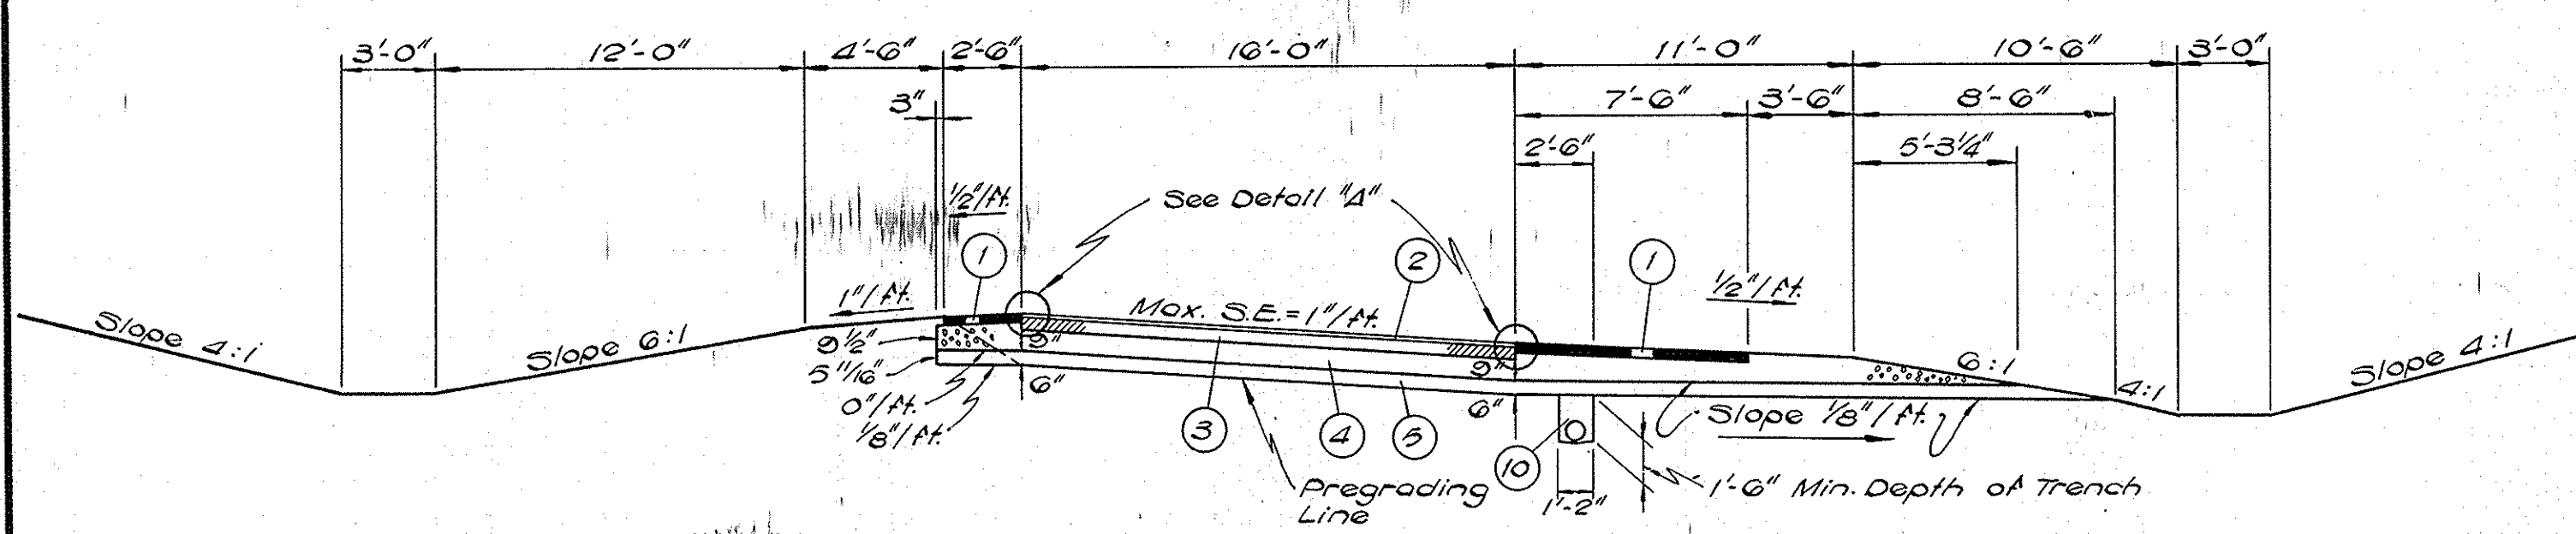


**CUT SECTION FOR RAMP CURVES SUPERELEVATED TO RIGHT
LESS THAN 2% GRADE**

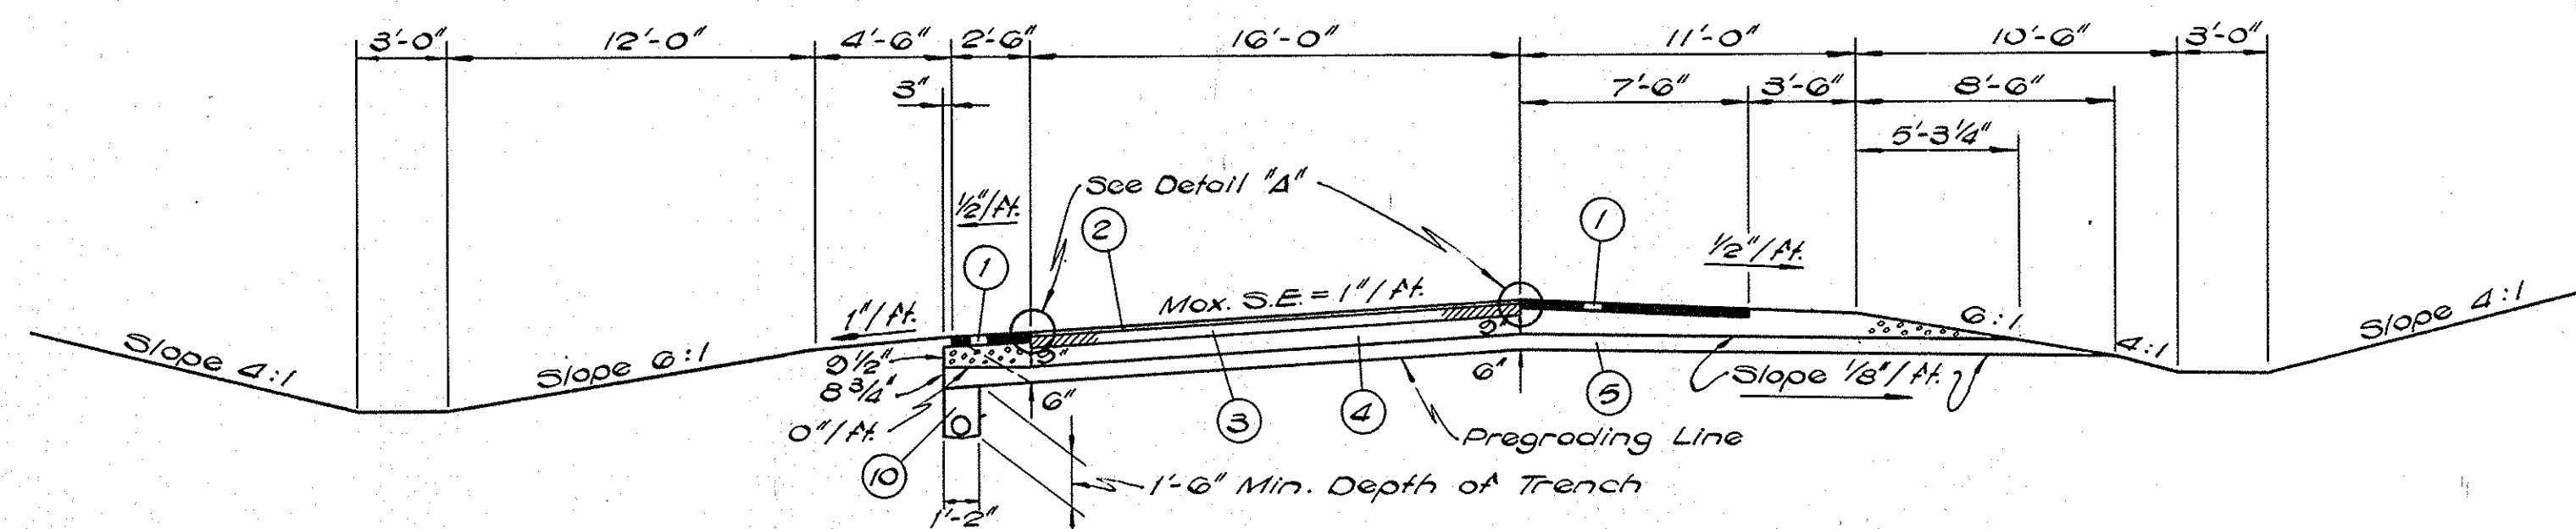


**CUT SECTION FOR RAMP CURVES SUPERELEVATED TO LEFT
LESS THAN 2% GRADE**

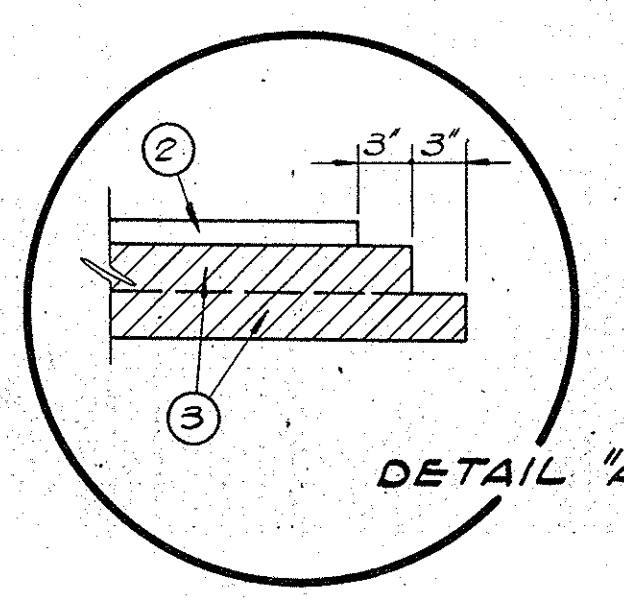

DETAIL "A"

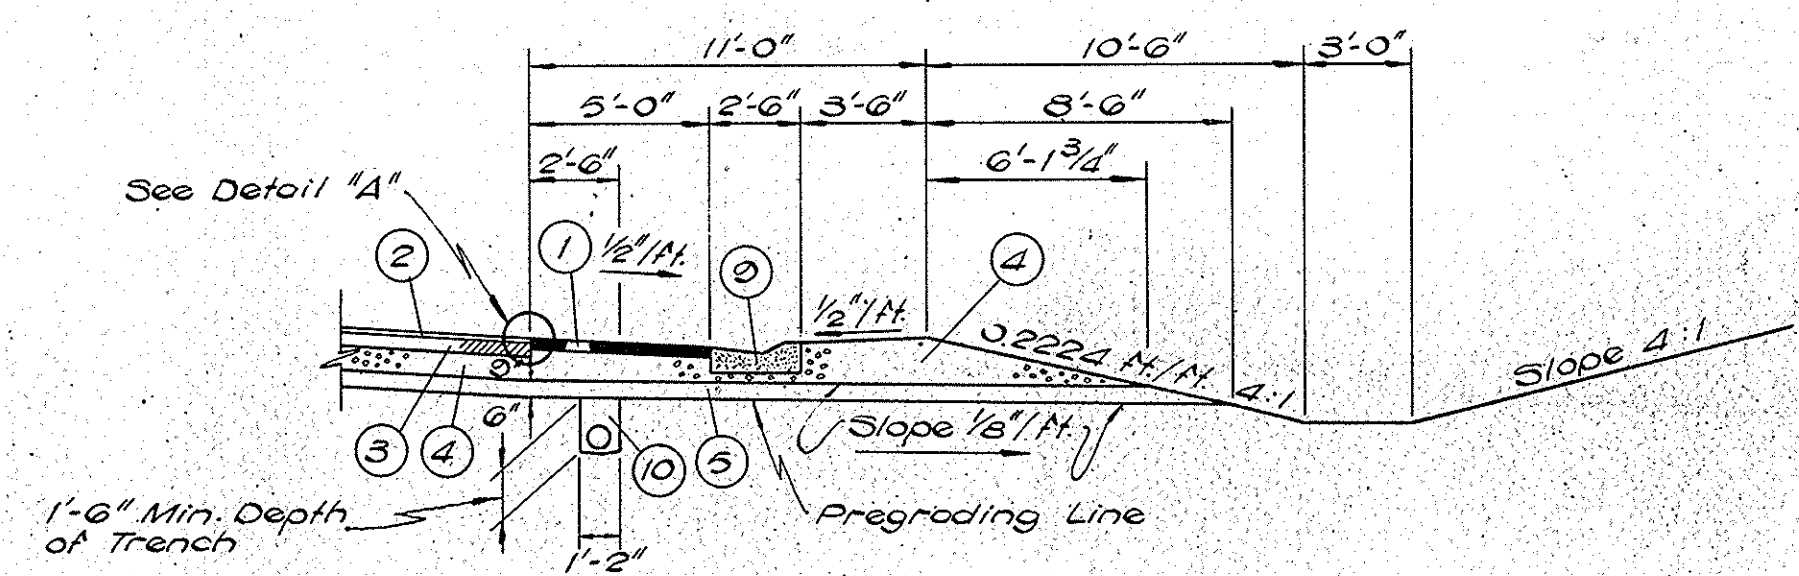

**CUT SECTION FOR RAMP CURVES SUPERELEVATED TO RIGHT
OVER 2% GRADE**

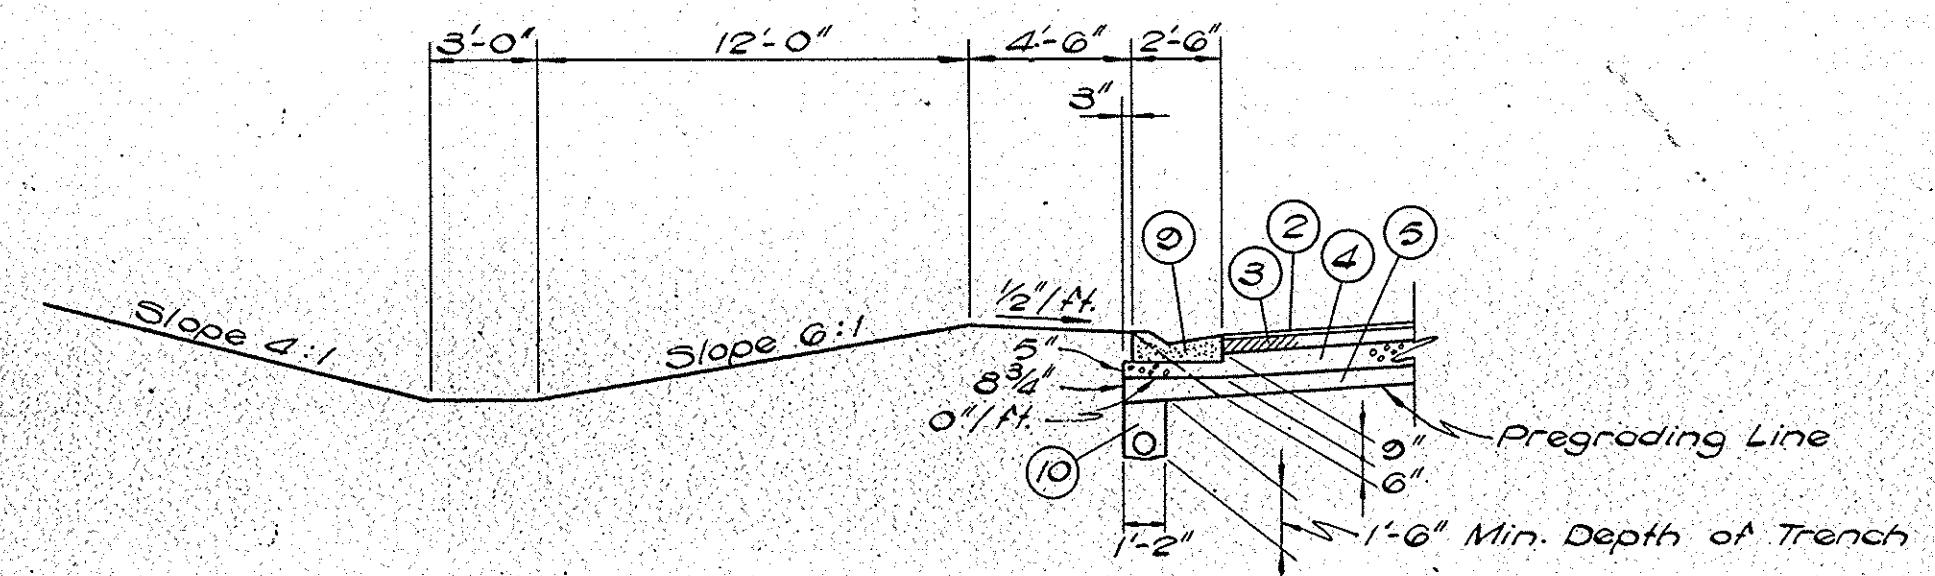

**CUT SECTION FOR RAMP CURVES SUPERELEVATED TO LEFT
OVER 2% GRADE**

LEGEND

- ① 3" Bituminous Shoulder
- ② 100#/SYD H.A.E. Surface Type III / H.A.C. Surface Type "B" (* Bituminous Surface)
- ③ 450#/SYD Hot Asphaltic Concrete Base (* Bituminous Base)
- ④ Type "P" Compacted Aggregate Base
- ⑤ Subbase Type II
- ⑥ Standard Lip Gutter
- ⑩ Subsurface Drain - See Misc. Std. Sheet 144

* Indicates Pay Items


PAVING S.R.66 INTERCHANGE TYPICAL CROSS SECTIONS

SCALE: 3/16" = 1'-0"


SUBMITTED FOR APPROVAL _____

ENGINEER OF ROAD DESIGN, INDIANA STATE HIGHWAY COMMISSION

FEDERAL ROAD REGION NO.	STATE	PROJECT NO.	FISCAL YEAR	SHEET NO.	TOTAL SHEETS
4	IND.	1-64-3(33)86	1967	22	

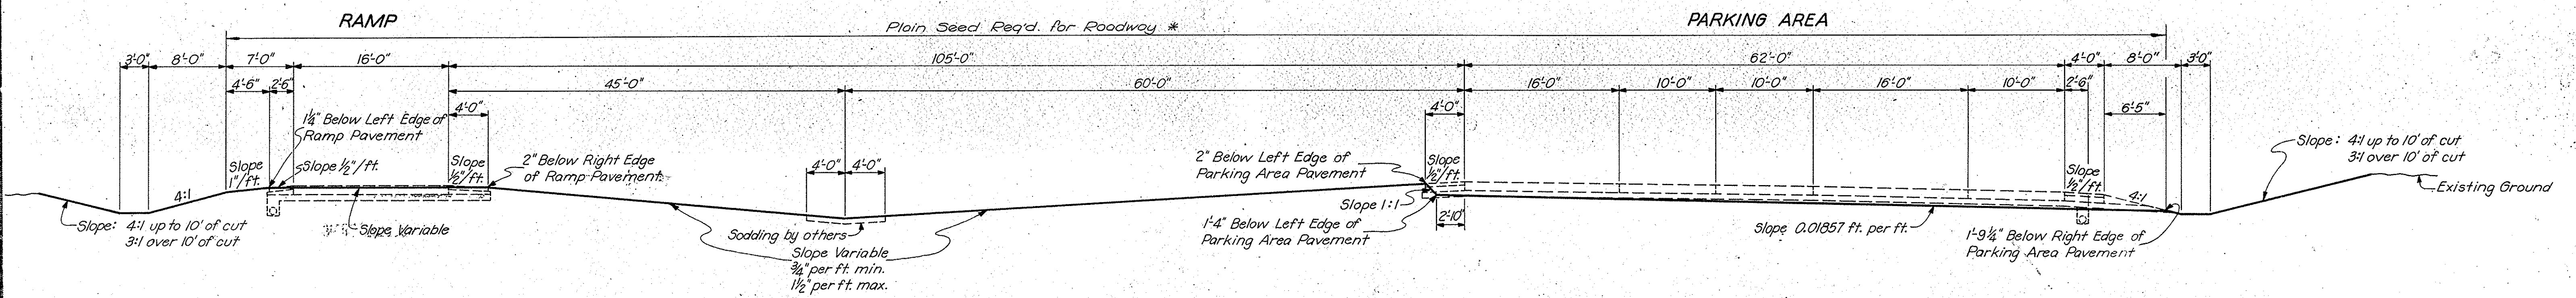

SECTION "A-A"
TYPICAL CUT SECTION THRU RAMP & PARKING AREA

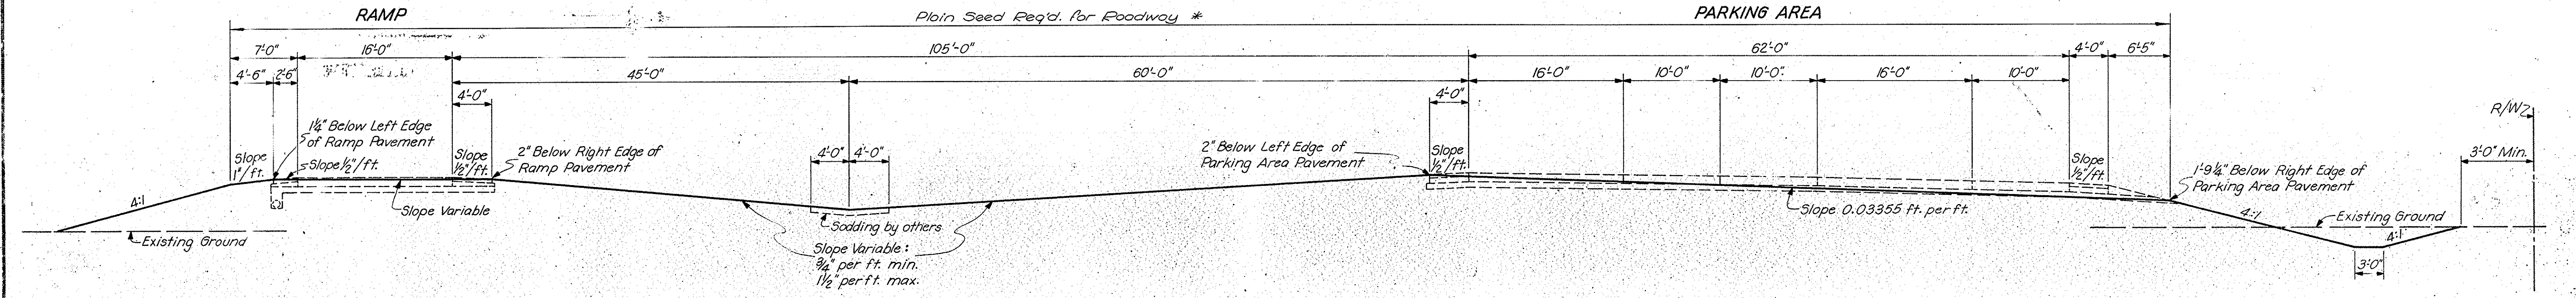

SECTION "A-A"
TYPICAL FILL SECTION THRU RAMP & PARKING AREA

* Plain Seeding Req'd. - 140#/Acre
Agricultural Rye.


WEIGH STATION GRADING TYPICAL CROSS SECTIONS

SCALE: 1/8" = 1'-0"


SUBMITTED FOR APPROVAL

PROJECT NO.	LINE	SHEET NO.	TOTAL SHEETS
1-64-3(33)86		22	


FEDERAL ROAD REGION NO.	STATE	PROJECT NO.	FISCAL YEAR	SHEET NO.	TOTAL SHEETS
4	IND.	64-3(33)86	1967	23	

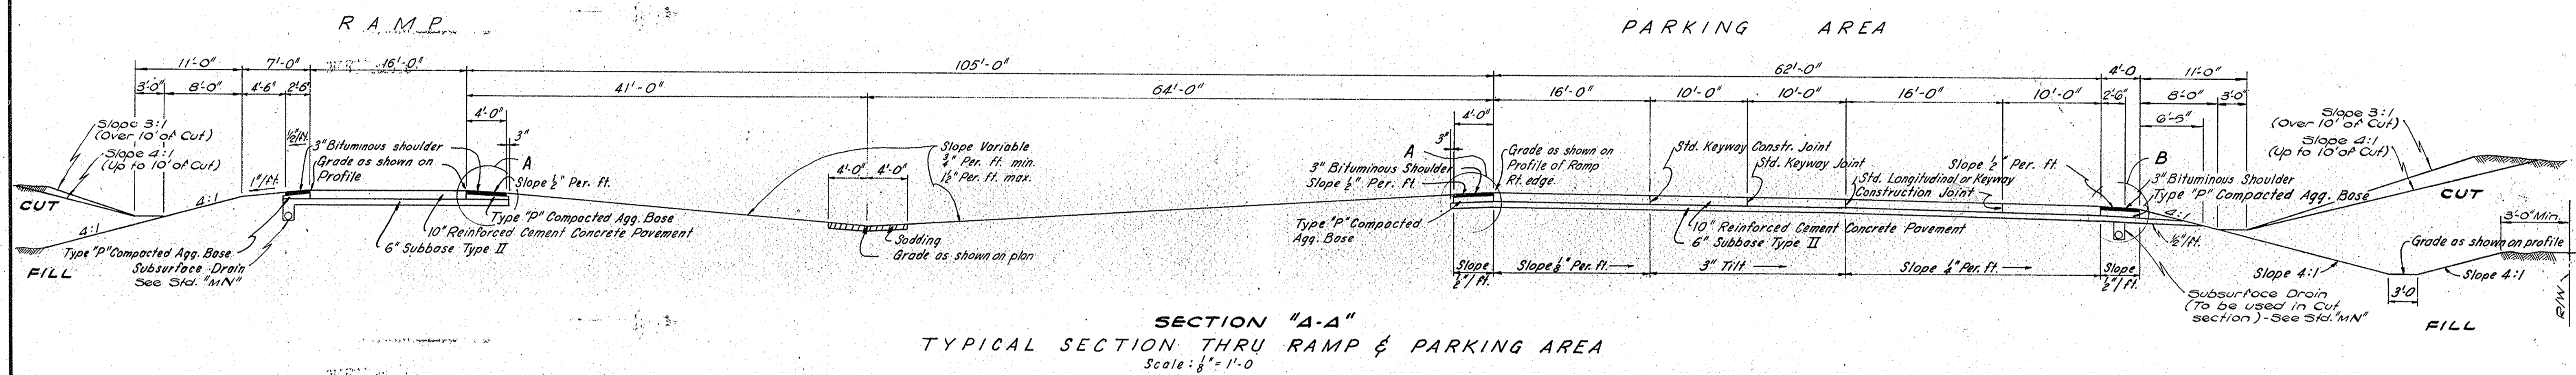

SECTION "A-A"
TYPICAL SECTION THRU RAMP & PARKING AREA
Scale: 1/8" = 1'-0"

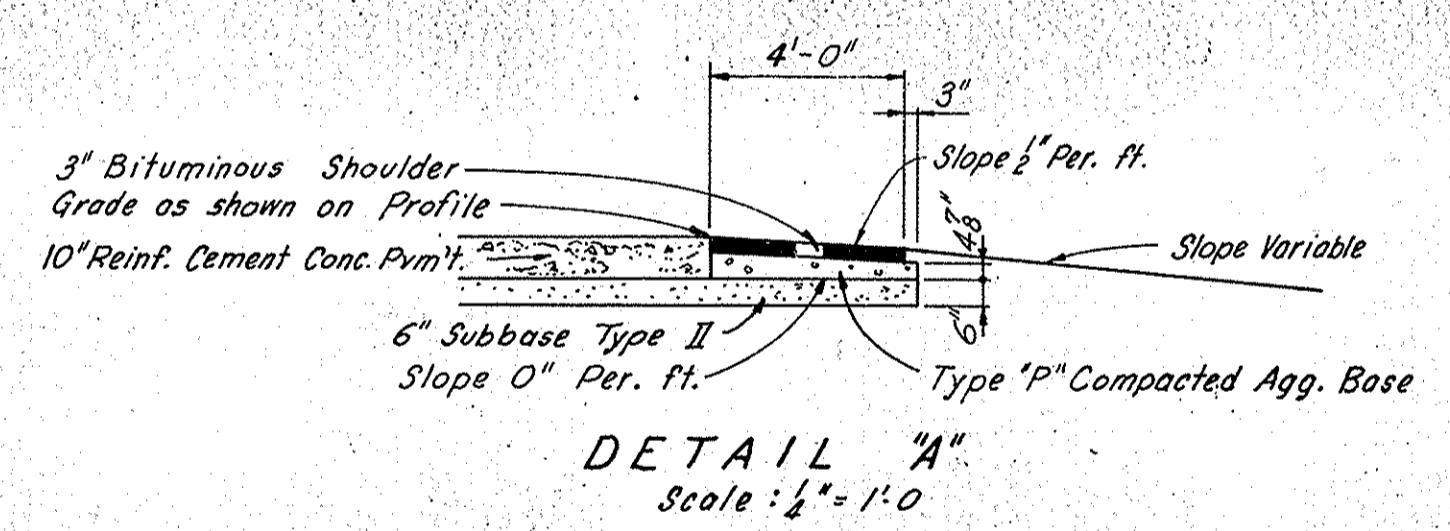

DETAIL "A"
Scale: 1/4" = 1'-0"

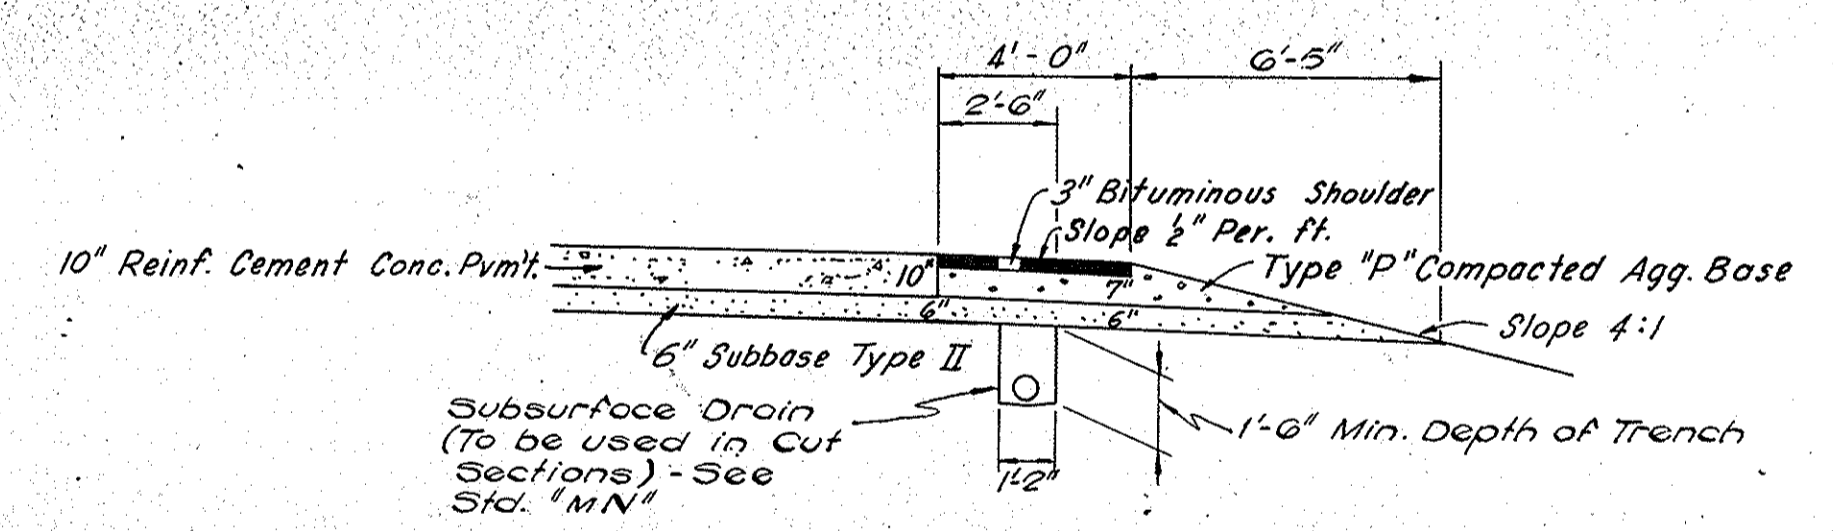

DETAIL "B"
Scale: 1/4" = 1'-0"

PAVING WEIGH STATION TYPICAL CROSS SECTIONS


SCALE: As Noted

SUBMITTED FOR APPROVAL _____

ENGINEER OF ROAD DESIGN, INDIANA STATE HIGHWAY COMMISSION

PROJECT NO.	LINE	SHEET NO.	TOTAL SHEETS	FILE
64-3(33)86		23		


FEDERAL ROAD DISTRICT NO.	STATE	PROJECT NO.	FISCAL YEAR	SHEET NO.	TOTAL SHEETS
4	IND.	I-64-3(33)86	1967	24	

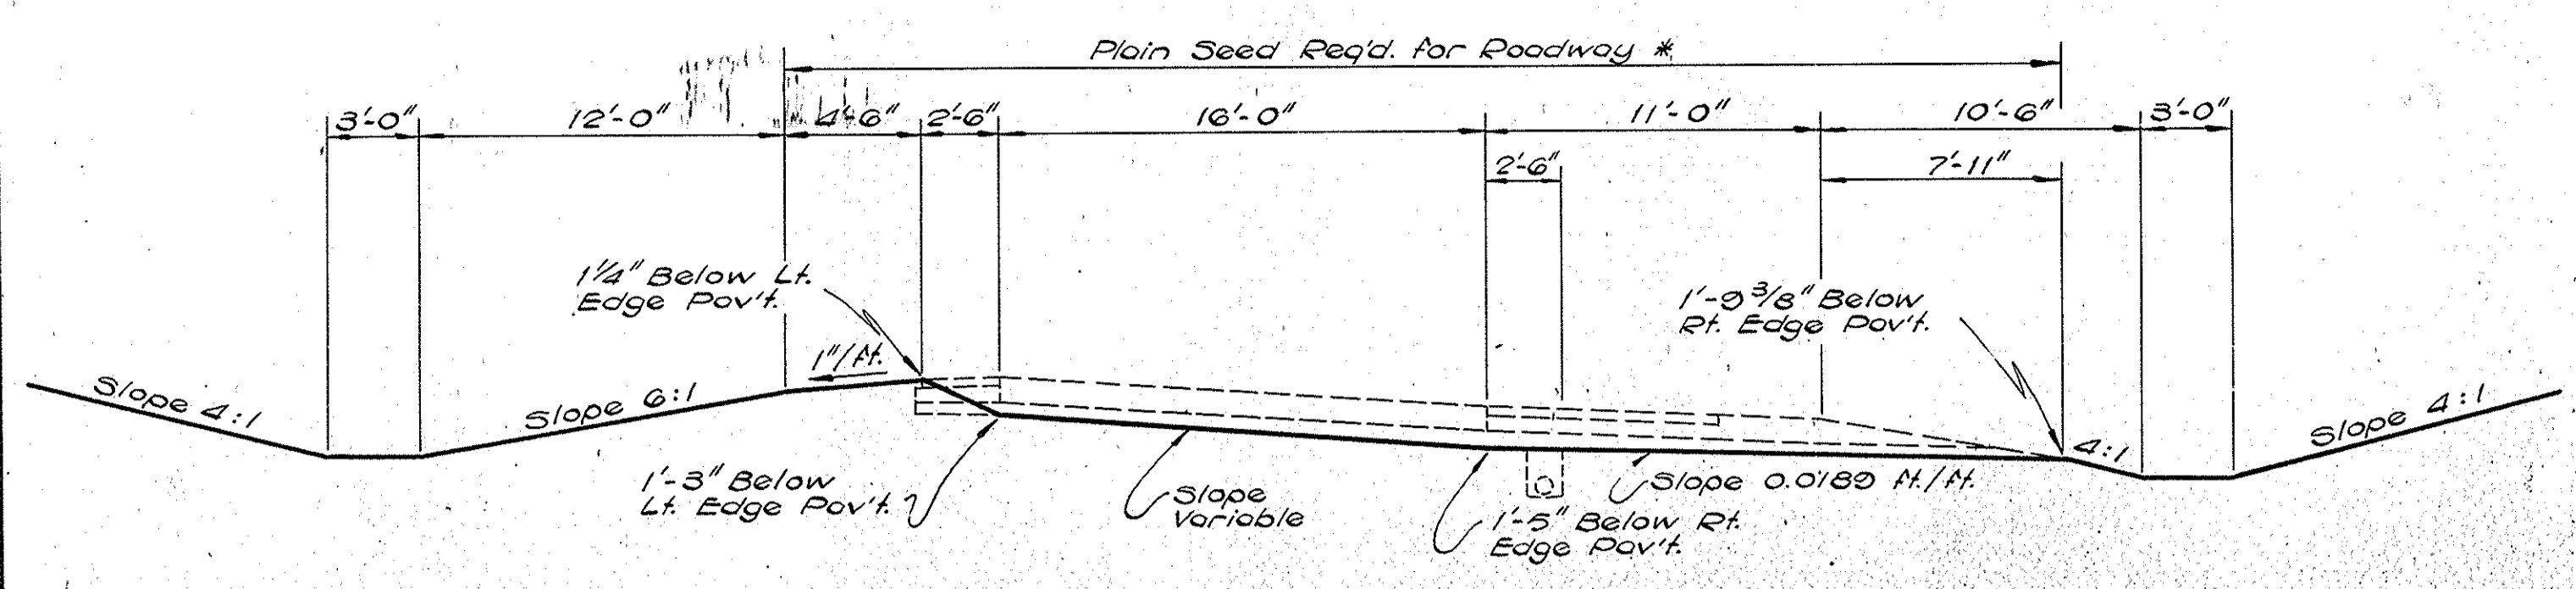

CUT SECTION FOR RAMPS ON TANGENT OR RAMP CURVES SUPERELEVATED TO RIGHT
LESS THAN 2% GRADE AND OVER 2% GRADE


Sta. 9+31.29 to Sta. 13+00 E.B.R.
 Sta. 24+05 to Sta. 28+62.42 E.B.R.
 Sta. 12+82.42 to Sta. 16+30 W.B.R.
 Sta. 26+00 to Sta. 28+00 W.B.R.

* Plain Seeding Req'd. - 140 #/Acre Agricultural Rye.

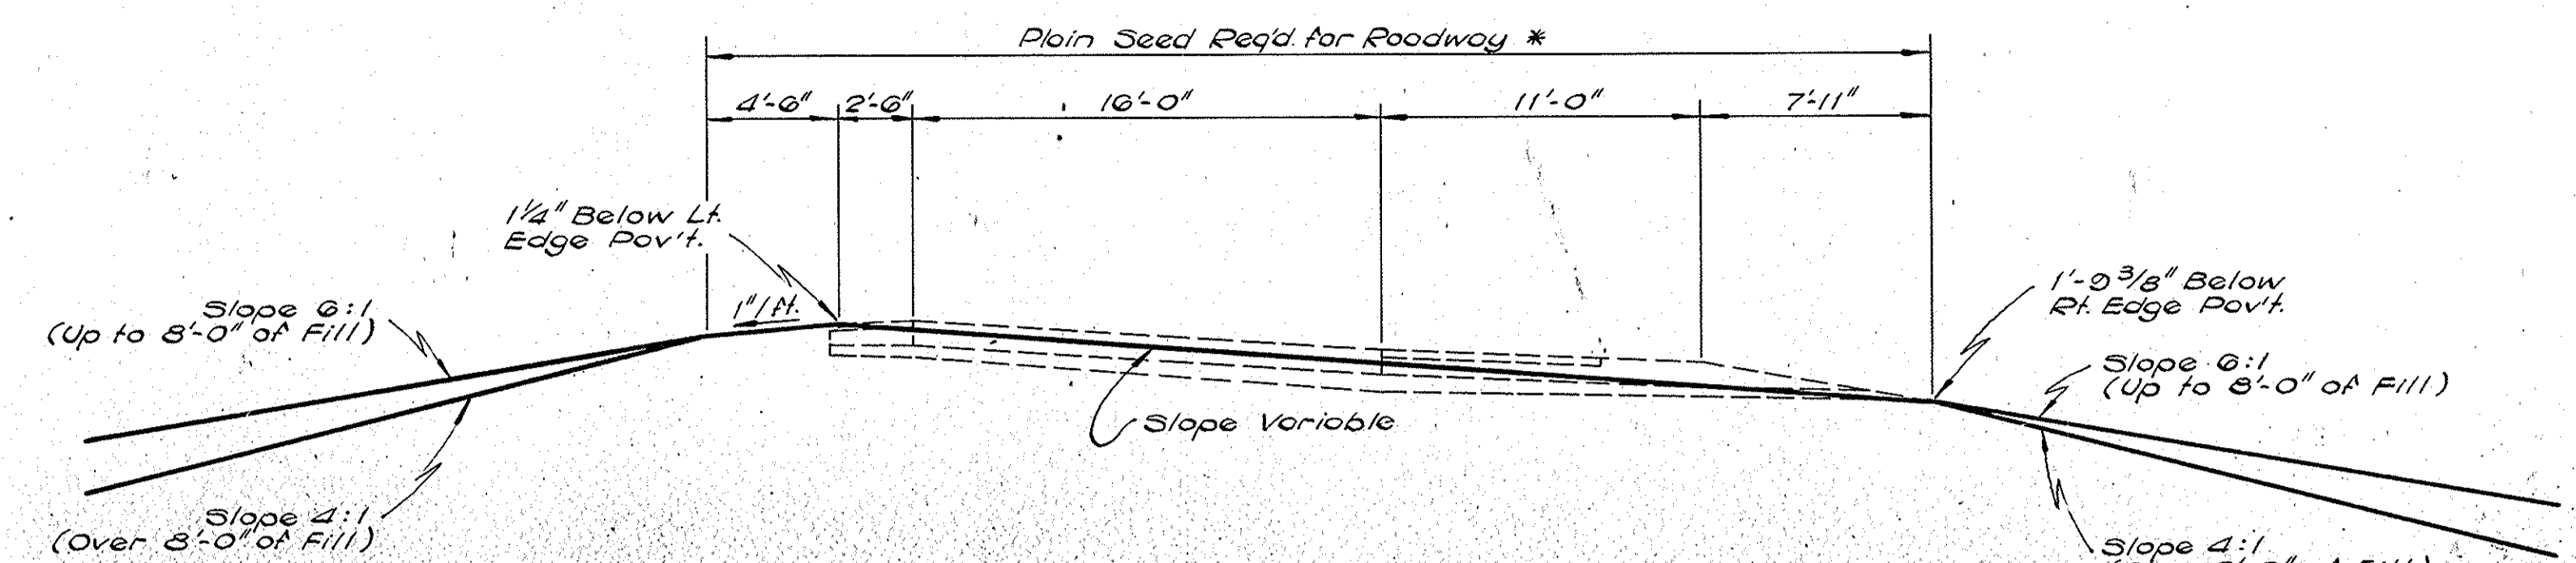


FILL SECTION FOR RAMPS ON TANGENT OR RAMP CURVES SUPERELEVATED TO RIGHT
LESS THAN 2% GRADE & OVER 2% GRADE

Sta. 17+00 to Sta. 17+92.00 E.B.R.
 Sta. 18+50 to Sta. 19+37.00 W.B.R.
 Sta. 23+90 to Sta. 26+00 W.B.R.
 Sta. 28+00 to Sta. 30+59.15 W.B.R.

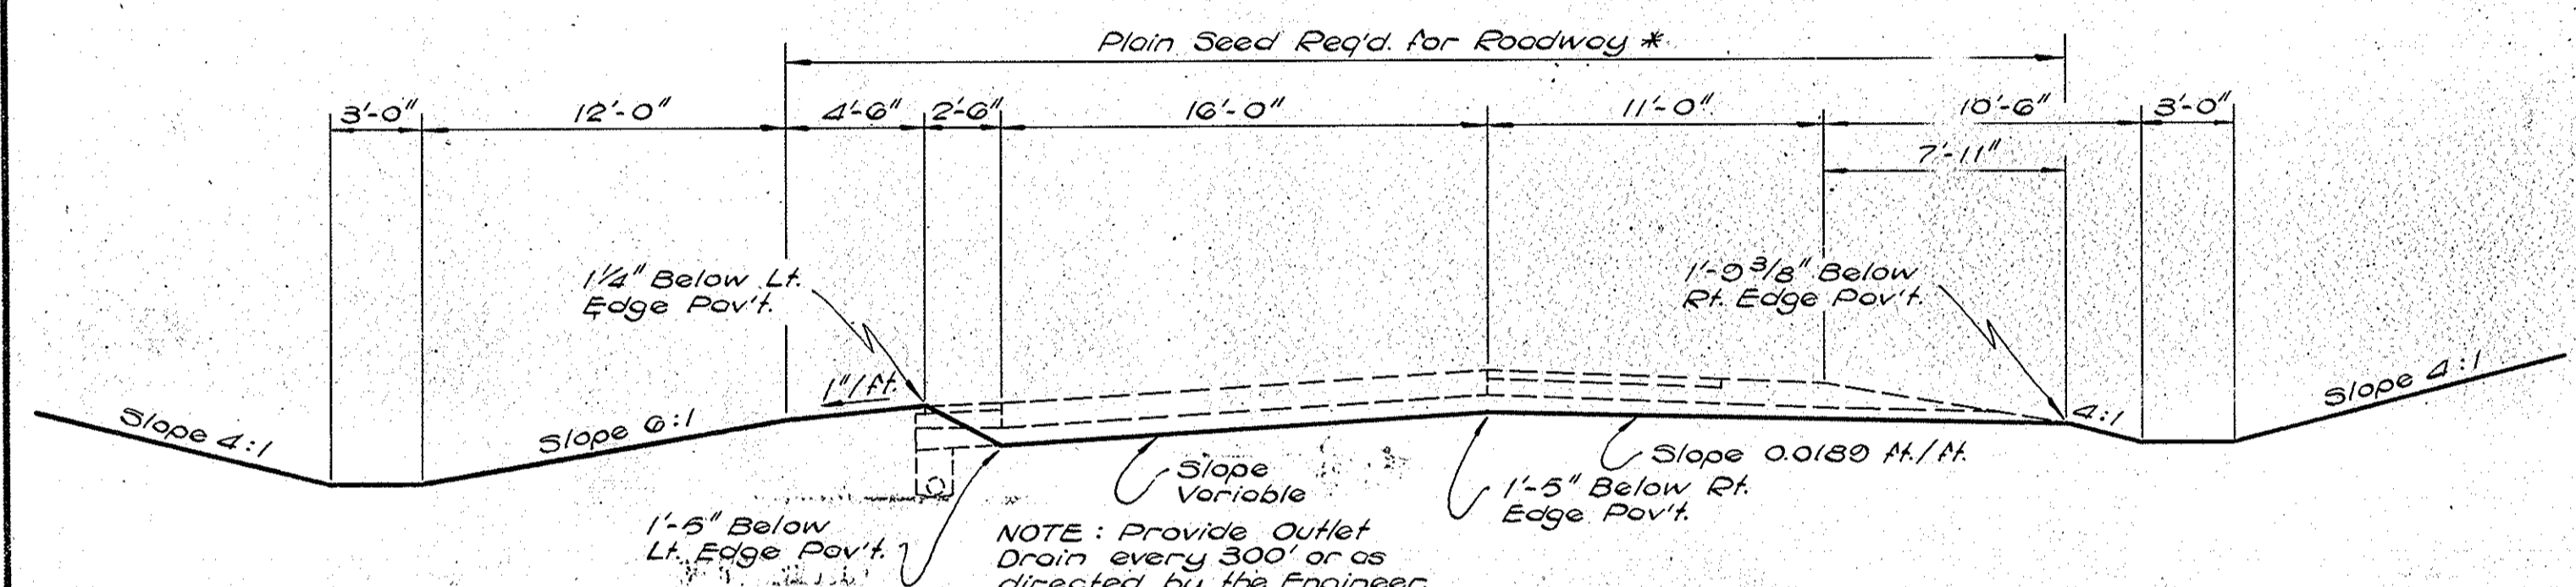


CUT SECTION FOR RAMP CURVES SUPERELEVATED TO LEFT
LESS THAN 2% GRADE

Sta. 19+57.00 to Sta. 24+05 E.B.R.
 Sta. 21+02.00 to Sta. 23+90 W.B.R.

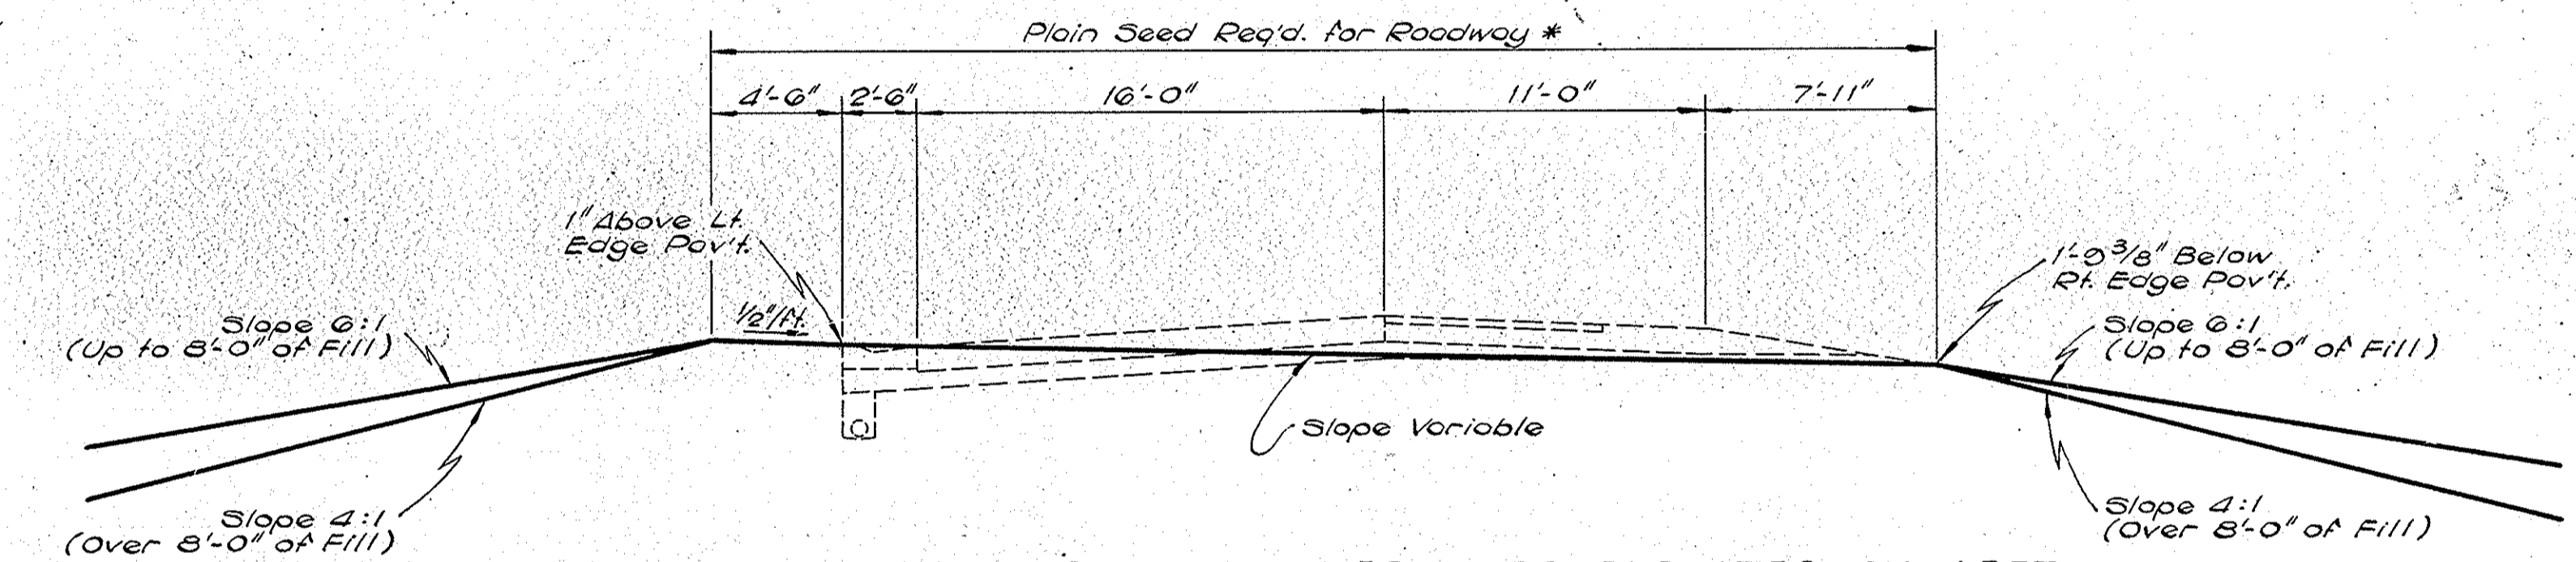

FILL SECTION FOR RAMP CURVES SUPERELEVATED TO LEFT
OVER 2% GRADE

Sta. 13+80 to Sta. 17+00 E.B.R.
 Sta. 17+50 to Sta. 18+50 W.B.R.

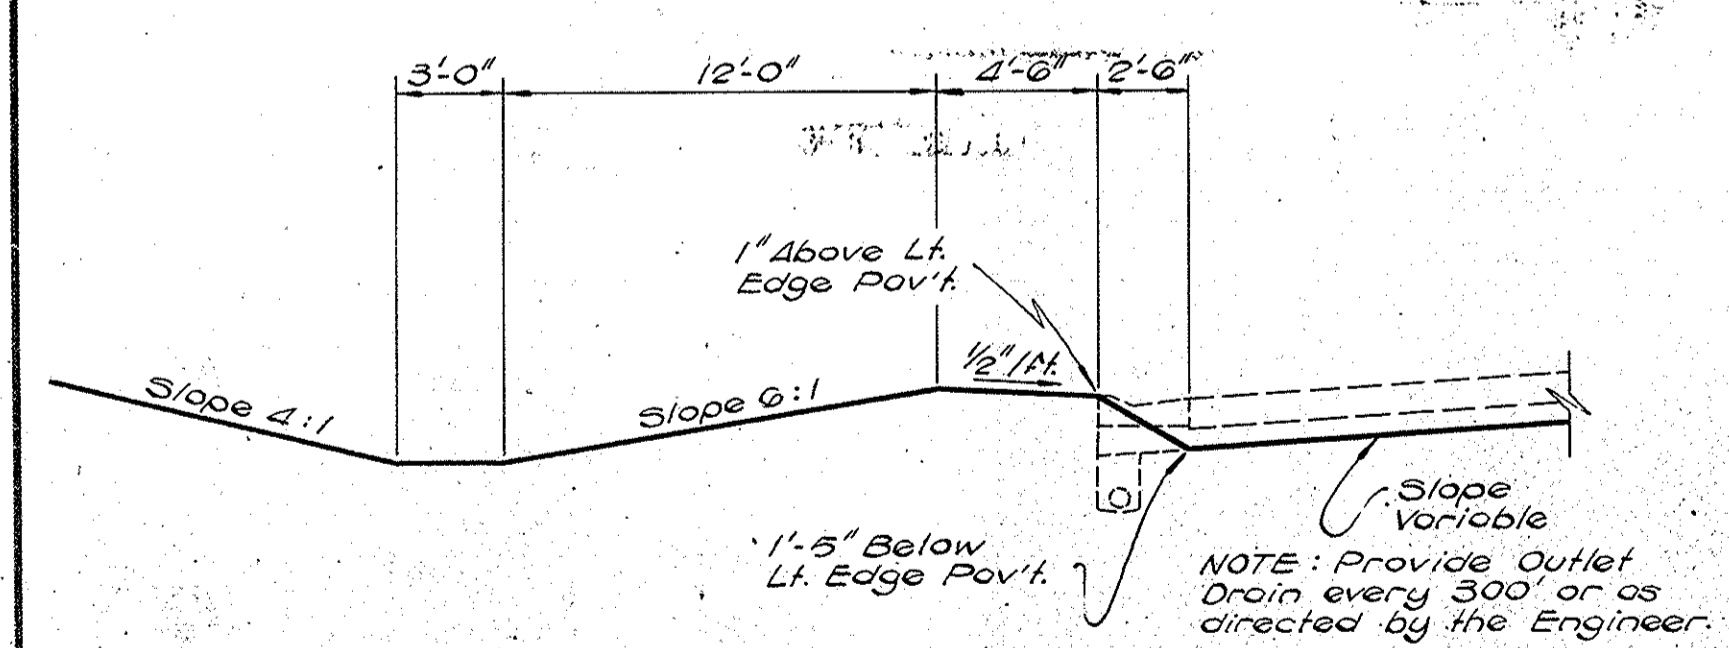

CUT SECTION FOR RAMP CURVES SUPERELEVATED TO LEFT
OVER 2% GRADE

Sta. 16+30. to Sta. 17+50 W.B.R.

WEIGH STATION GRADING TYPICAL CROSS SECTIONS


SCALE: 3/16" = 1'-0"

SUBMITTED FOR APPROVAL _____

ENGINEER OF ROAD DESIGN, INDIANA STATE HIGHWAY COMMISSION



PROJECT NO.	LINE	SHEET NO.	TOTAL SHEETS	FILE
I-64-3(33)86		24		

FEDERAL ROAD REGION NO.	STATE	PROJECT NO.	FISCAL YEAR	SHEET NO.	TOTAL SHEETS
4	IND.	1-64-3(33)86	1967	25	

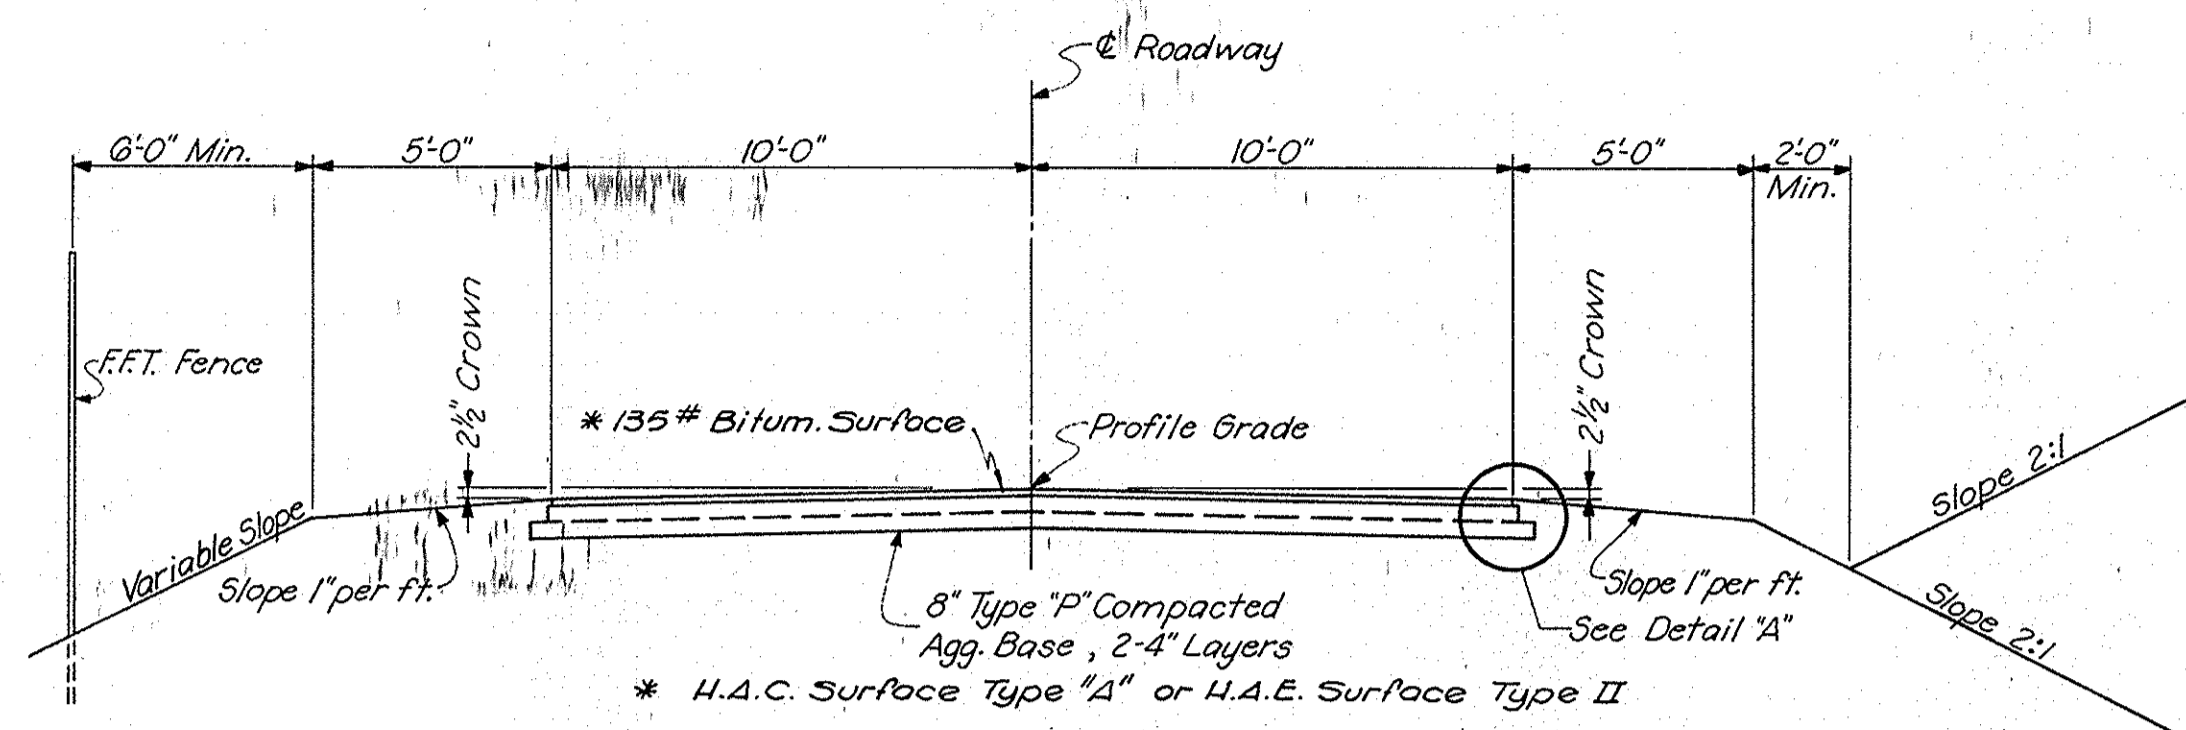


RELOCATED COUNTY ROAD No 1

Sta. 9+40.00 to Sta. 10+00.00
Sta. 16+13.48 to Sta. 34+18.70
Sta. 36+06.03 to Sta. 40+87.80

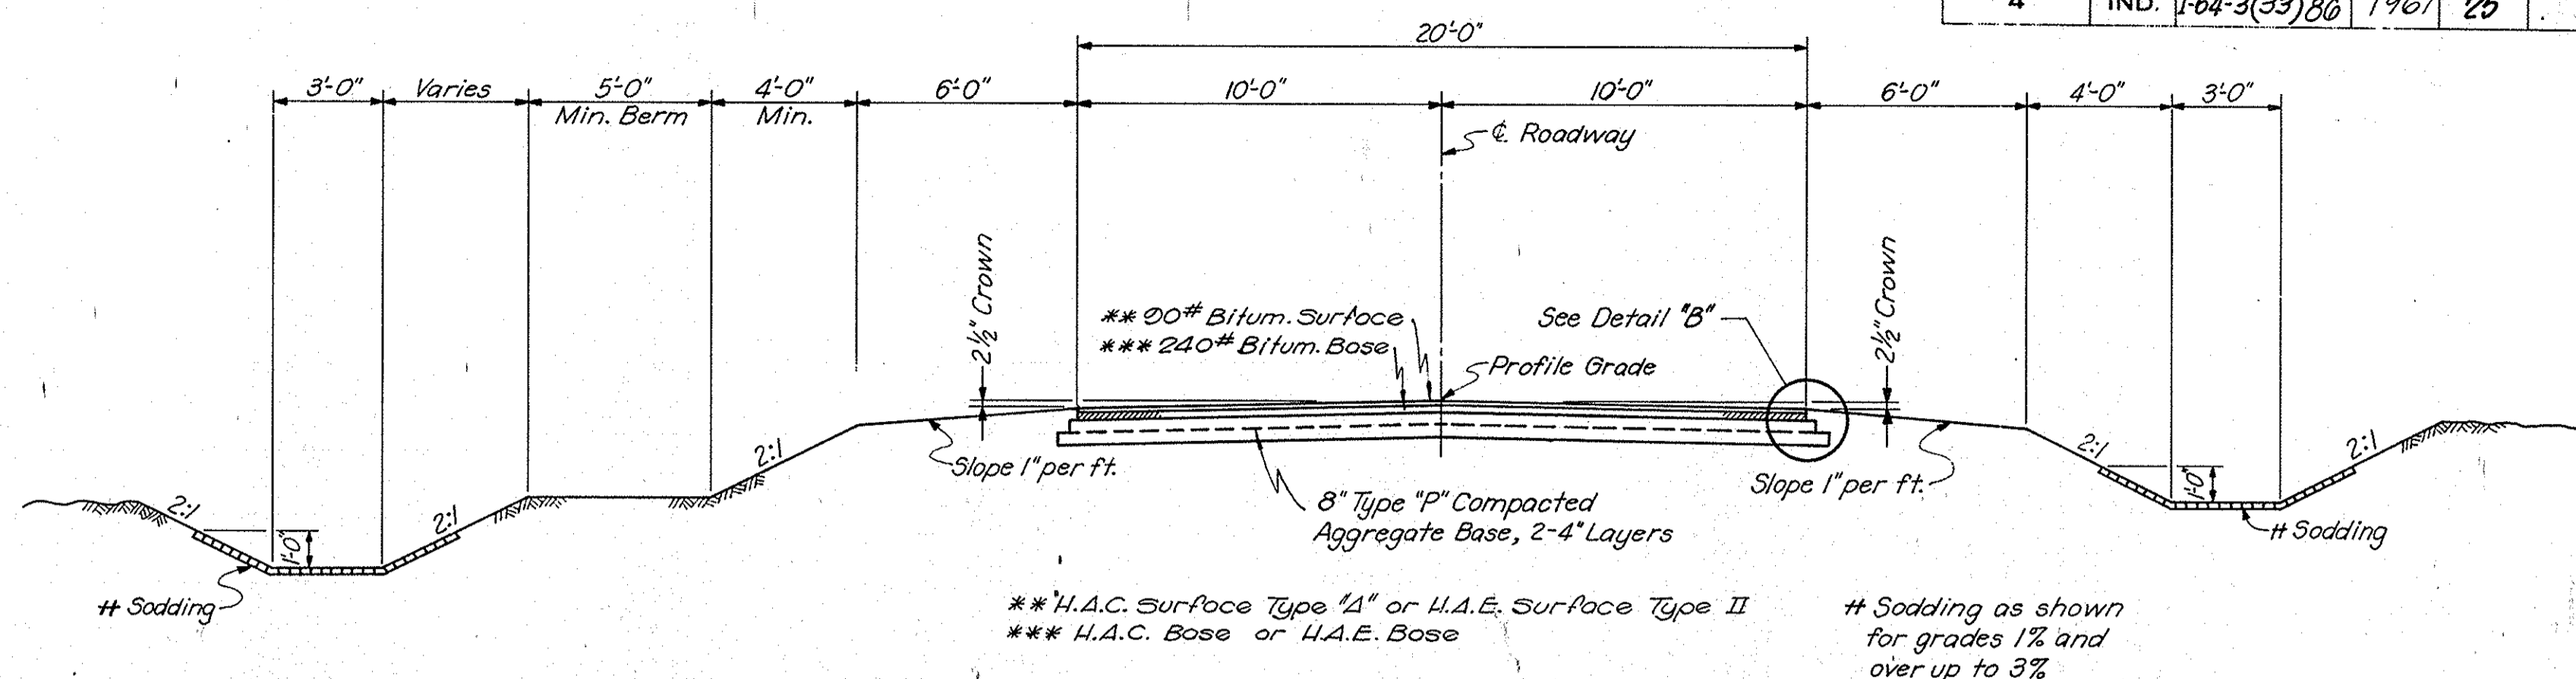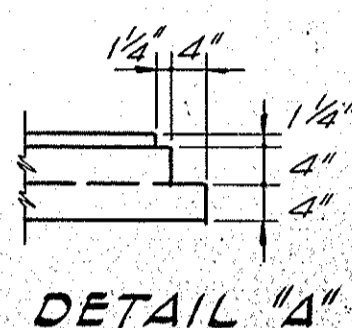



S-1-1B RIDDLE ROAD

Sta. 41+50.00 to Sta. 48+00.68
Sta. 56+77.97 to Sta. 58+50

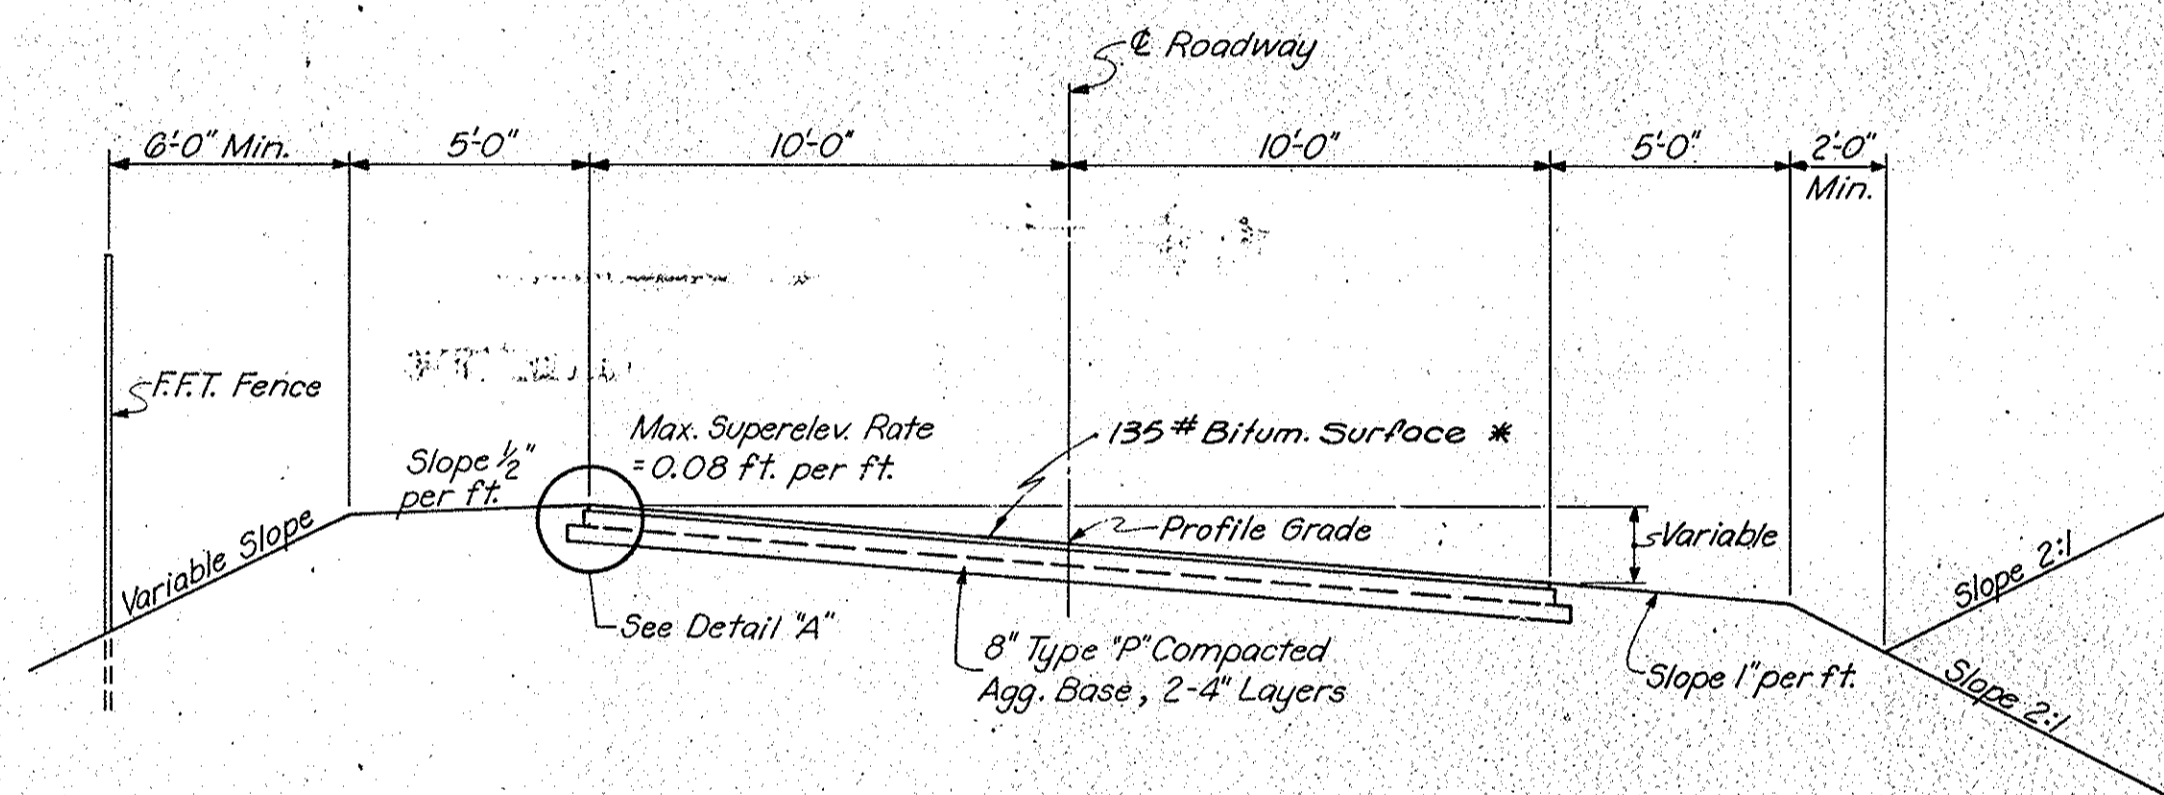


RELOCATED COUNTY ROAD No 1

Sta. 10+00.00 to Sta. 16+13.48
Sta. 34+18.70 to Sta. 36+06.03

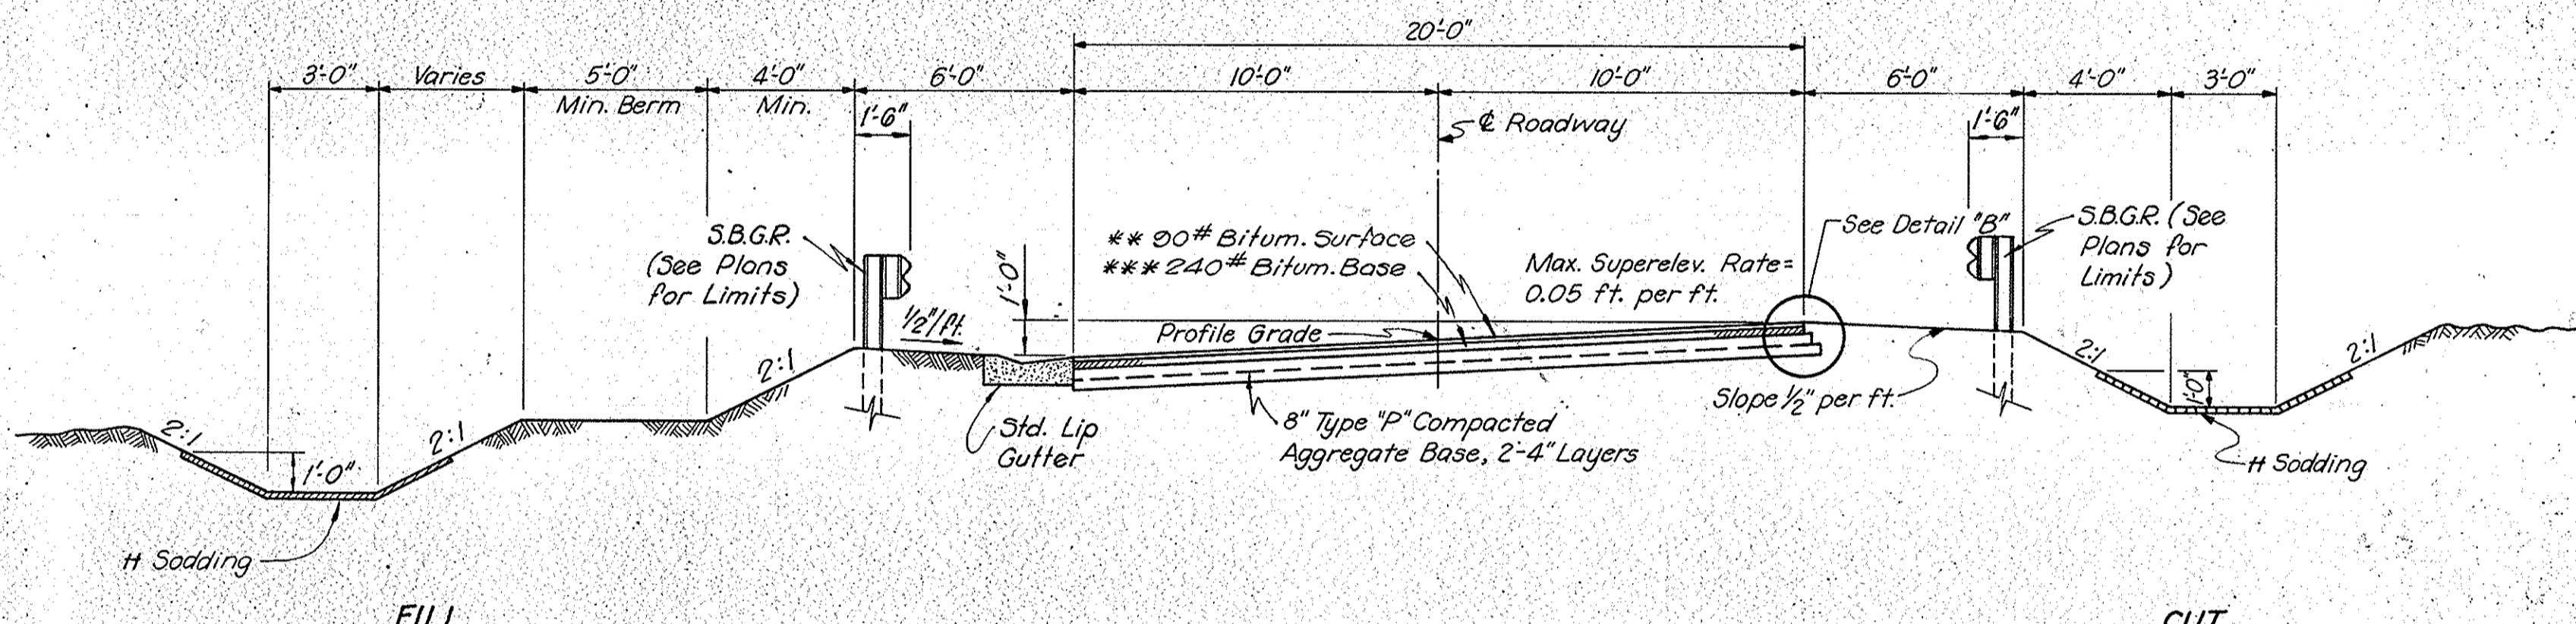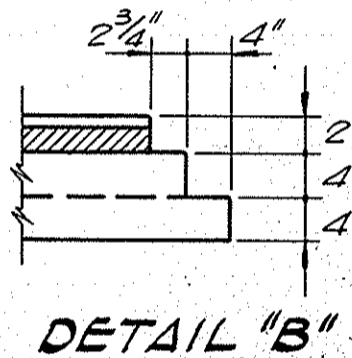

S-1-1B RIDDLE ROAD

Sta. 48+00.68 to Sta. 48+71
Sta. 51+25.50 to Sta. 56+77.97

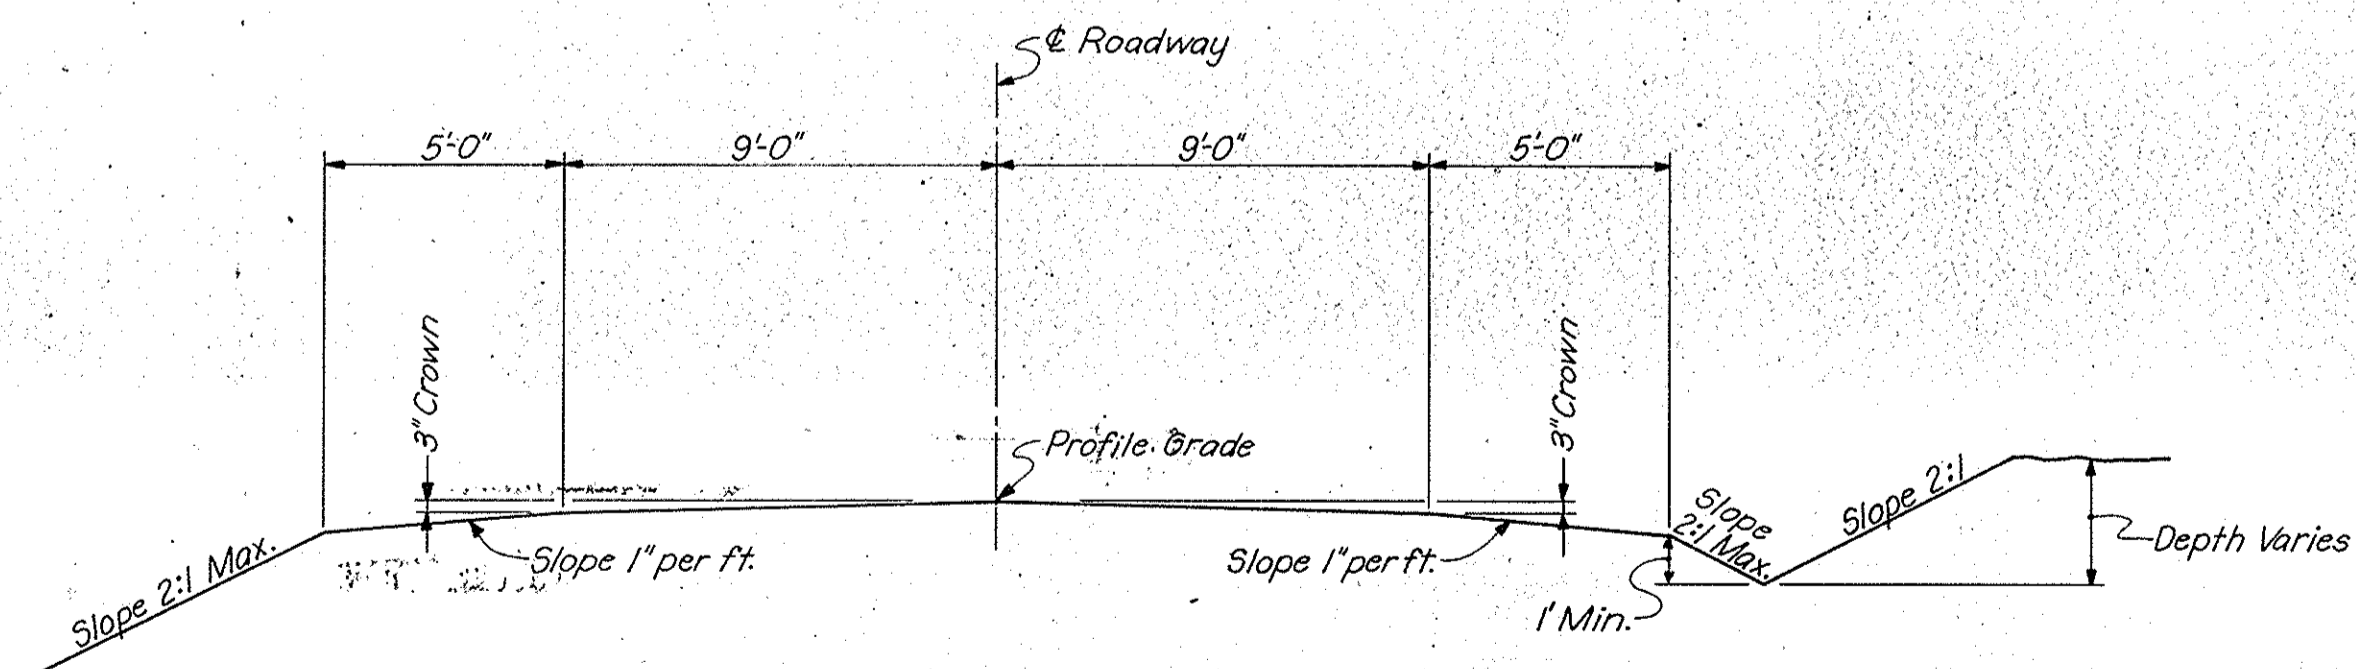

ACCESS ROADS No 1, 6, & 7

Access Road No 1 Sta. 0+10.00 to Sta. 6+00.00
Access Road No 6 Sta. 2+90.00 to Sta. 5+15.00
Access Road No 7 Sta. 0+10.00 to Sta. 2+51.3


TYPICAL CROSS SECTIONS

SCALE: 1/4" = 1'-0"

RECOMMENDED FOR APPROVAL



ENGINEER OF ROAD DESIGN, INDIANA STATE HIGHWAY COMMISSION

PROJECT NO.	LINE	SHEET NO.	TOTAL SHEETS	FILE
1-64-3(33)86		25		

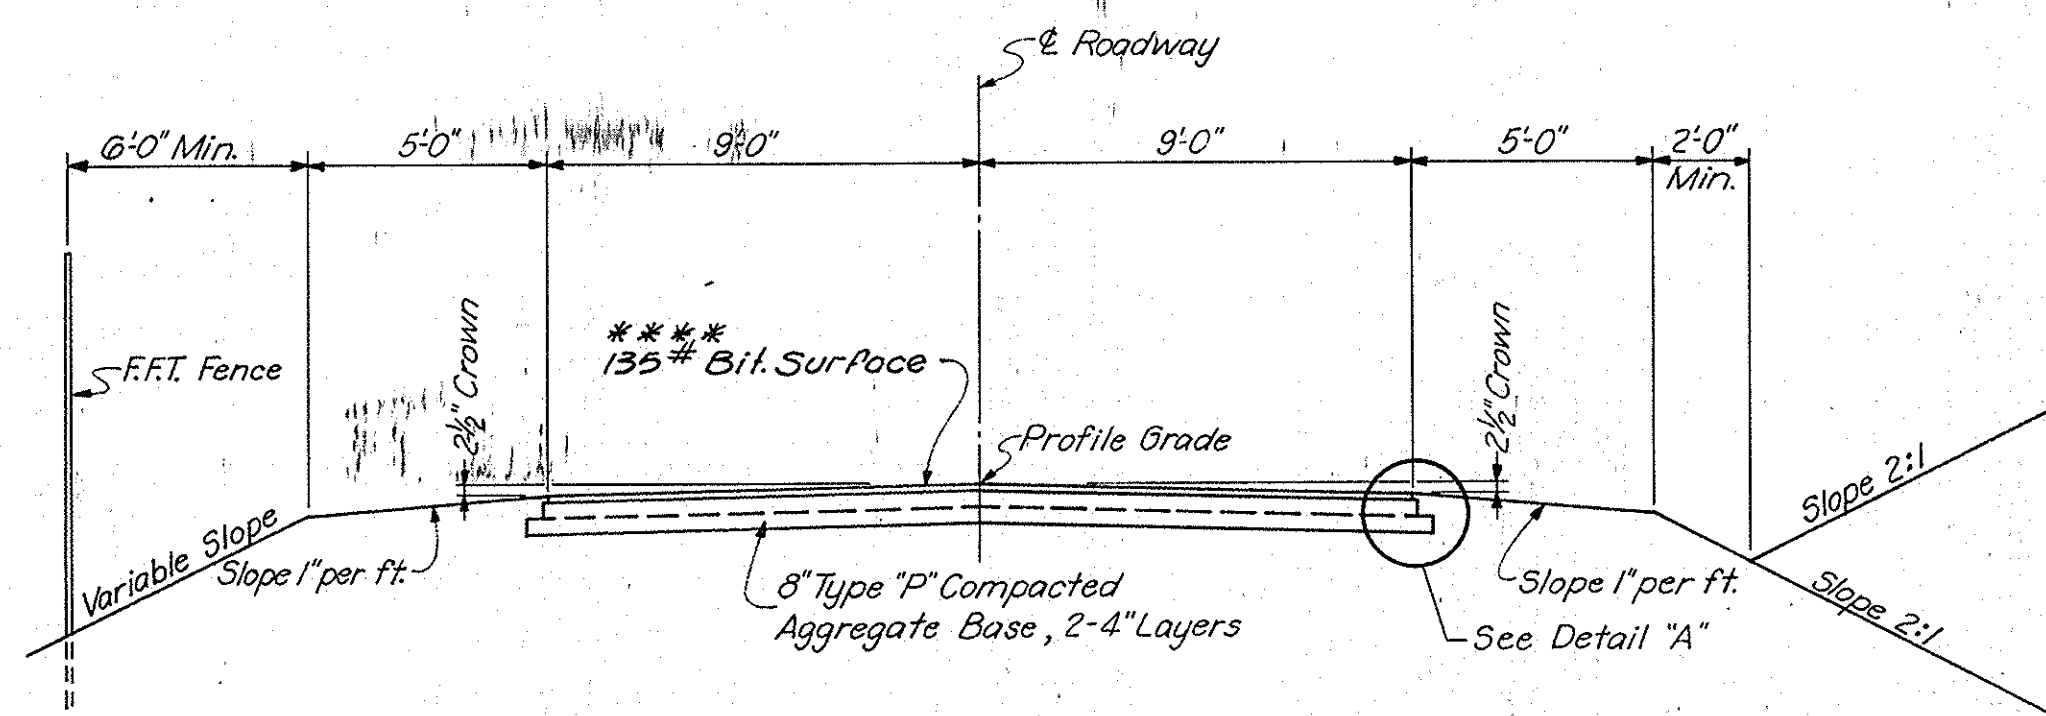



**RELOCATED COUNTY ROADS NO 2, 3 & 4
ACCESS ROADS NO 3 & 5**

- | | |
|--|--|
| Reloc. Co. Rd. No 2 - Sta. 0+13.00 to Sta. 6+54.05 Line F.R. #1 | Reloc. Co. Rd. No 4 - Sta. 11+60.68 to Sta. 15+01.72 Line F.R. #1A-B |
| Reloc. Co. Rd. No 2 - Sta. 13+09.61 to Sta. 15+50.00 Line F.R. #1 | Reloc. Co. Rd. No 4 - Sta. 5+68.23 to Sta. 5+83.73 Line F.R. #1-B |
| Reloc. Co. Rd. No 3 - Sta. 10+10.00 to Sta. 10+77.79 Line F.R. #2 | Reloc. Co. Rd. No 4 - Sta. 7+80.08 to Sta. 18+50.52 Line F.R. #1-B |
| Reloc. Co. Rd. No 3 - Sta. 14+81.20 to Sta. 21+14.04 Line F.R. #2 | Reloc. Co. Rd. No 4 - Sta. 23+85.21 to Sta. 41+70.72 Line F.R. #1-B |
| Reloc. Co. Rd. No 3 - Sta. 22+47.98 to Sta. 24+53.96 Line F.R. #2 | Reloc. Co. Rd. No 4 - Sta. 44+16.48 to Sta. 44+30.00 Line F.R. #1-B |
| Reloc. Co. Rd. No 3 - Sta. 26+94.31 to Sta. 27+00.00 Line F.R. #2 | Access Rd. No 3 - Sta. 10+00.00 to Sta. 27+00.00 Line A.R. #2 |
| Reloc. Co. Rd. No 4 - Sta. 4+50.00 to Sta. 9+83.70 Line F.R. #1A-B | Access Rd. No 5 - Sta. 10+00.00 to Sta. 25+94.42 Line A.R. #1 |
| Reloc. Co. Rd. No 4 - Sta. 10+04.60 to Sta. 10+99.28 Line F.R. #1A-B | |

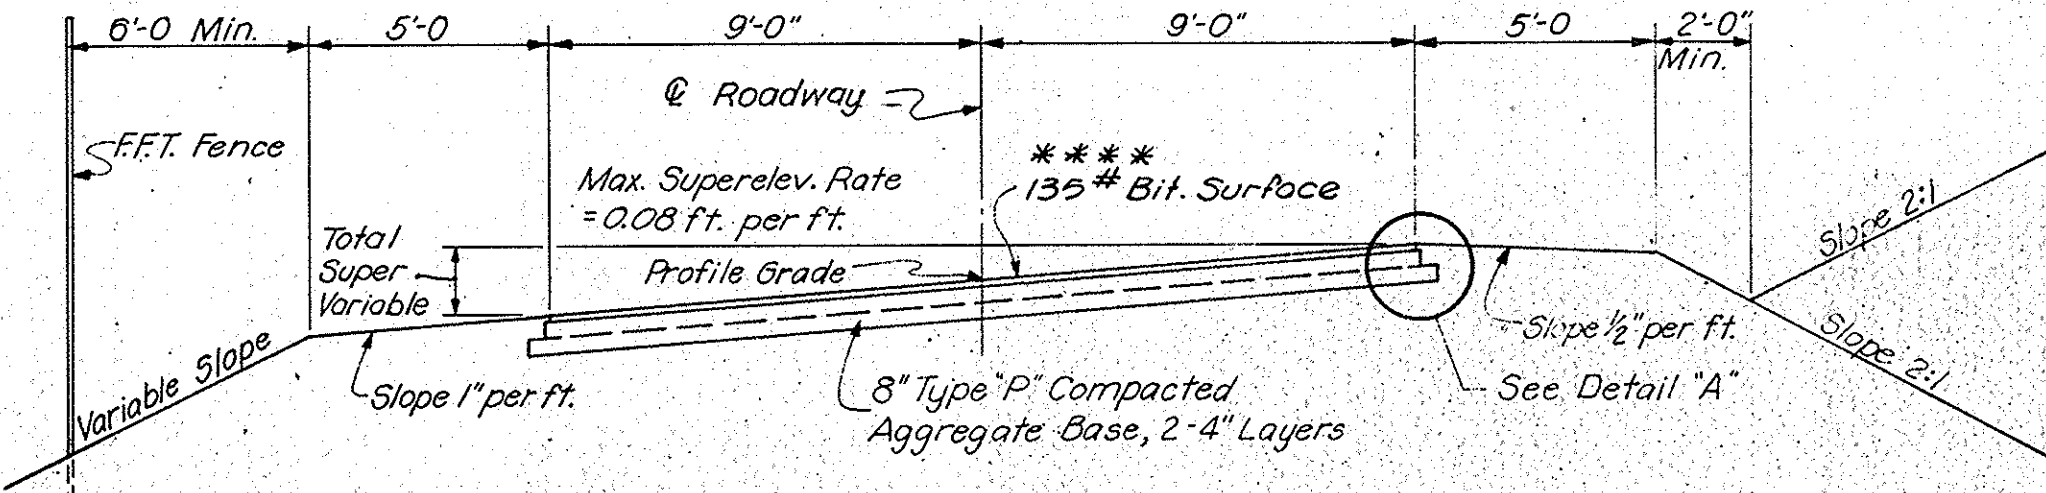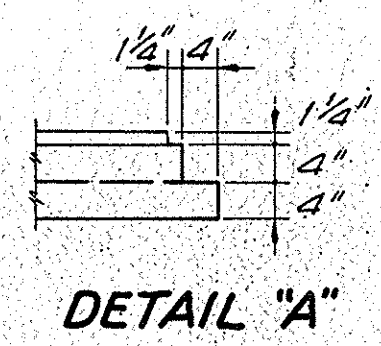


**RELOCATED COUNTY ROADS NO 2, 3 & 4
SECTION SHOWS CURVE TO LEFT - CURVE TO RIGHT REVERSED**

- | | |
|--|---|
| Reloc. Co. Rd. No 2 - Sta. 6+54.05 to Sta. 13+09.61 Line F.R. #1 | Reloc. Co. Rd. No 3 - Sta. 10+77.79 to Sta. 14+81.20 Line F.R. #2 |
| Reloc. Co. Rd. No 3 - Sta. 21+14.04 to Sta. 22+47.98 Line F.R. #2 | Reloc. Co. Rd. No 3 - Sta. 24+53.96 to Sta. 26+94.31 Line F.R. #2 |
| Reloc. Co. Rd. No 4 - Sta. 10+99.28 to Sta. 11+60.68 Line F.R. #1A-B | Reloc. Co. Rd. No 4 - Sta. 15+01.72 to Sta. 16+49.61 Line F.R. #1A-B = Sta. 5+69.23 F.R. #1-B |
| Reloc. Co. Rd. No 4 - Sta. 5+83.73 to Sta. 7+80.08 Line F.R. #1-B | Reloc. Co. Rd. No 4 - Sta. 18+50.52 to Sta. 23+85.21 Line F.R. #1-B |
| Reloc. Co. Rd. No 4 - Sta. 41+70.72 to Sta. 44+16.48 Line F.R. #1-B | |

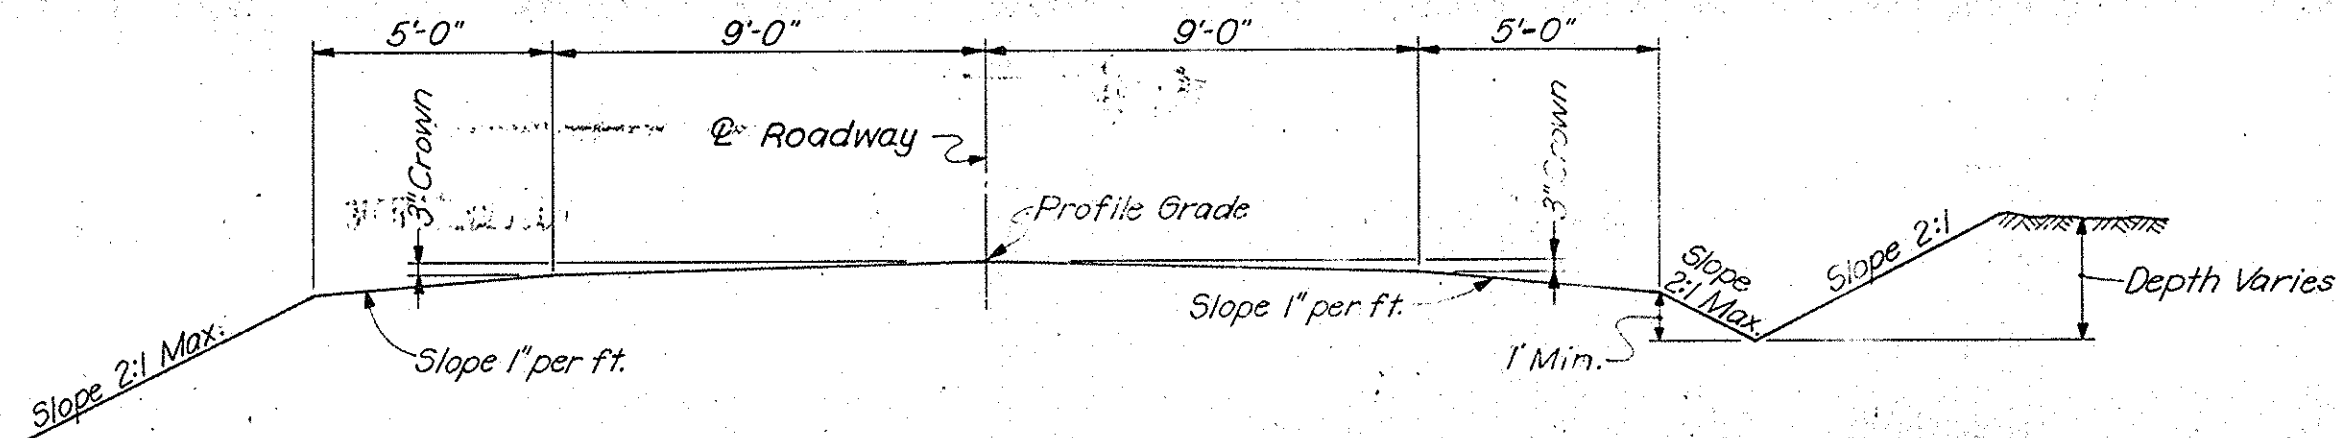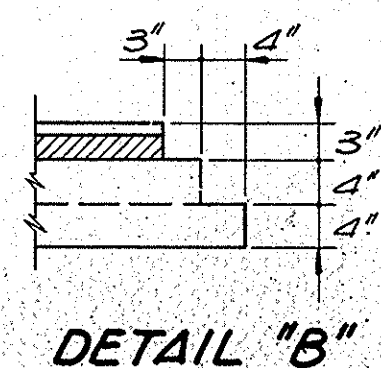

ACCESS ROADS NO 2 & 4


- | |
|---|
| Access Rd. No 2 - Sta. 0+00.00 to Sta. 22+50.00 Line A.R. #1 |
| Access Rd. No 4 - Sta. 0+00.00 to Sta. 9+35.50 Line A.R. #1-B |

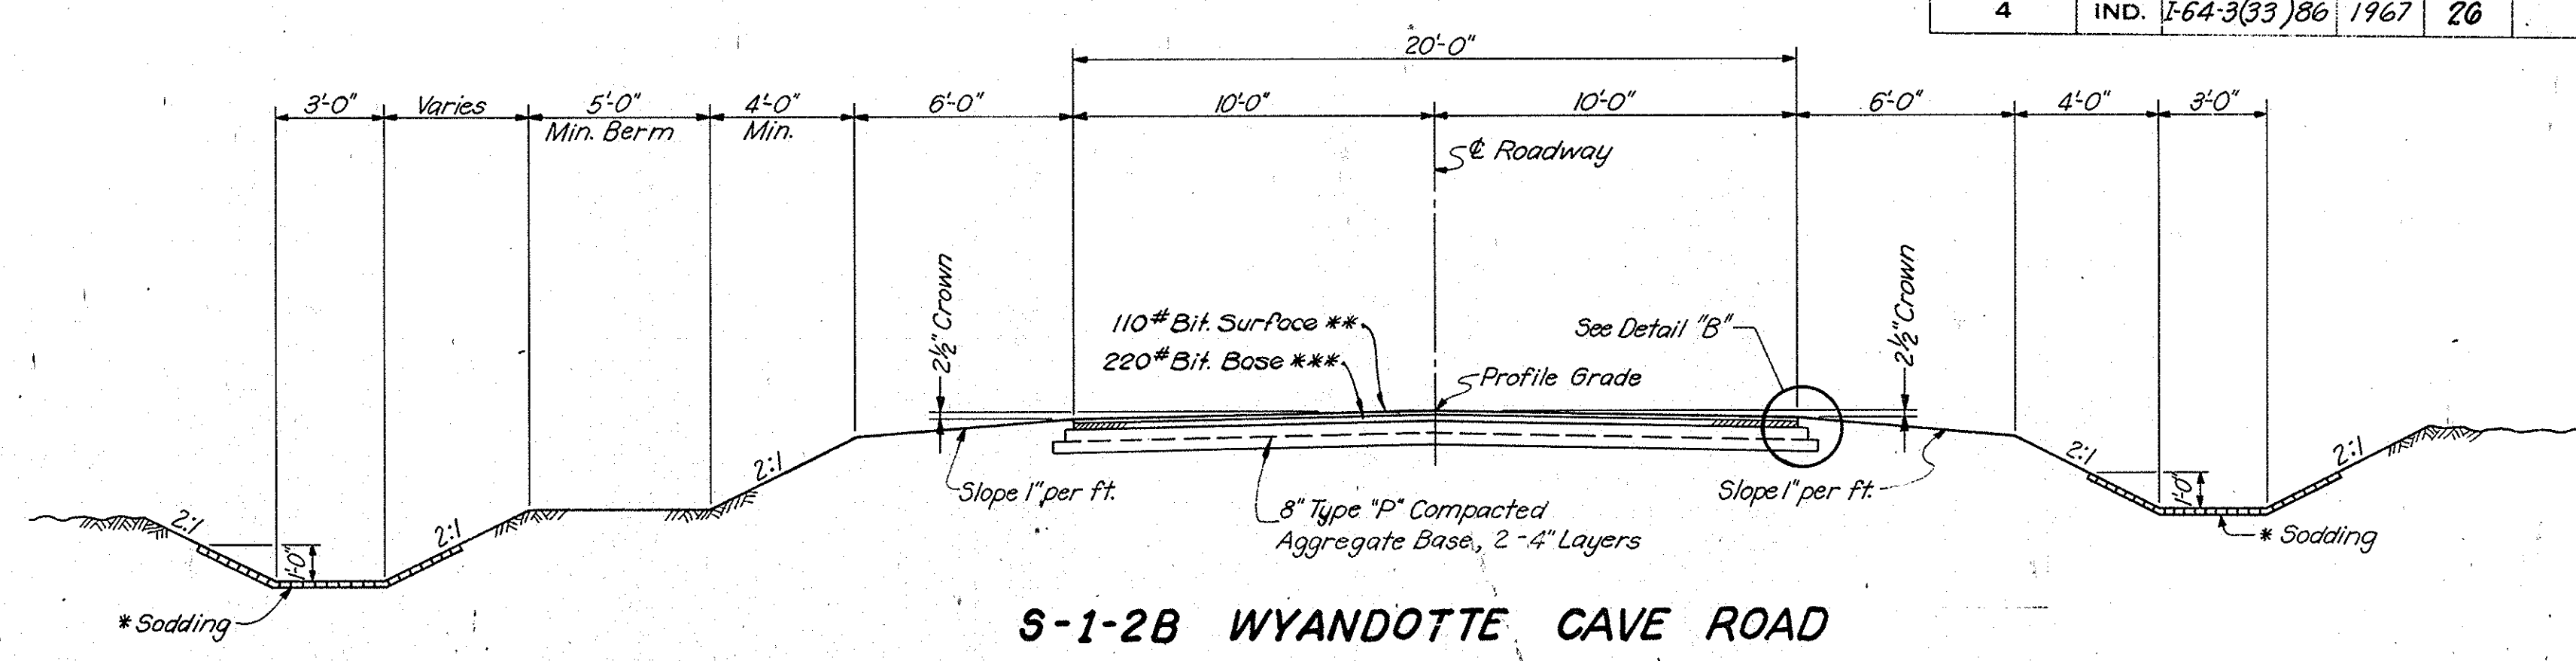

S-1-2B WYANDOTTE CAVE ROAD

- | | |
|--------------------------------|--------|
| Sta. 34+75.00 to Sta. 37+89.36 | |
| Sta. 41+44.29 to Sta. 44+25.00 | |
| Sta. 51+39 to Sta. 54+39.76 | |
| Sta. 56+77.61 to Sta. 57+75 | on Lt. |
| Sta. 57+75 to Sta. 59+50 | on Rt. |
| Sta. 59+50 to Sta. 60+00.00 | |


CUT

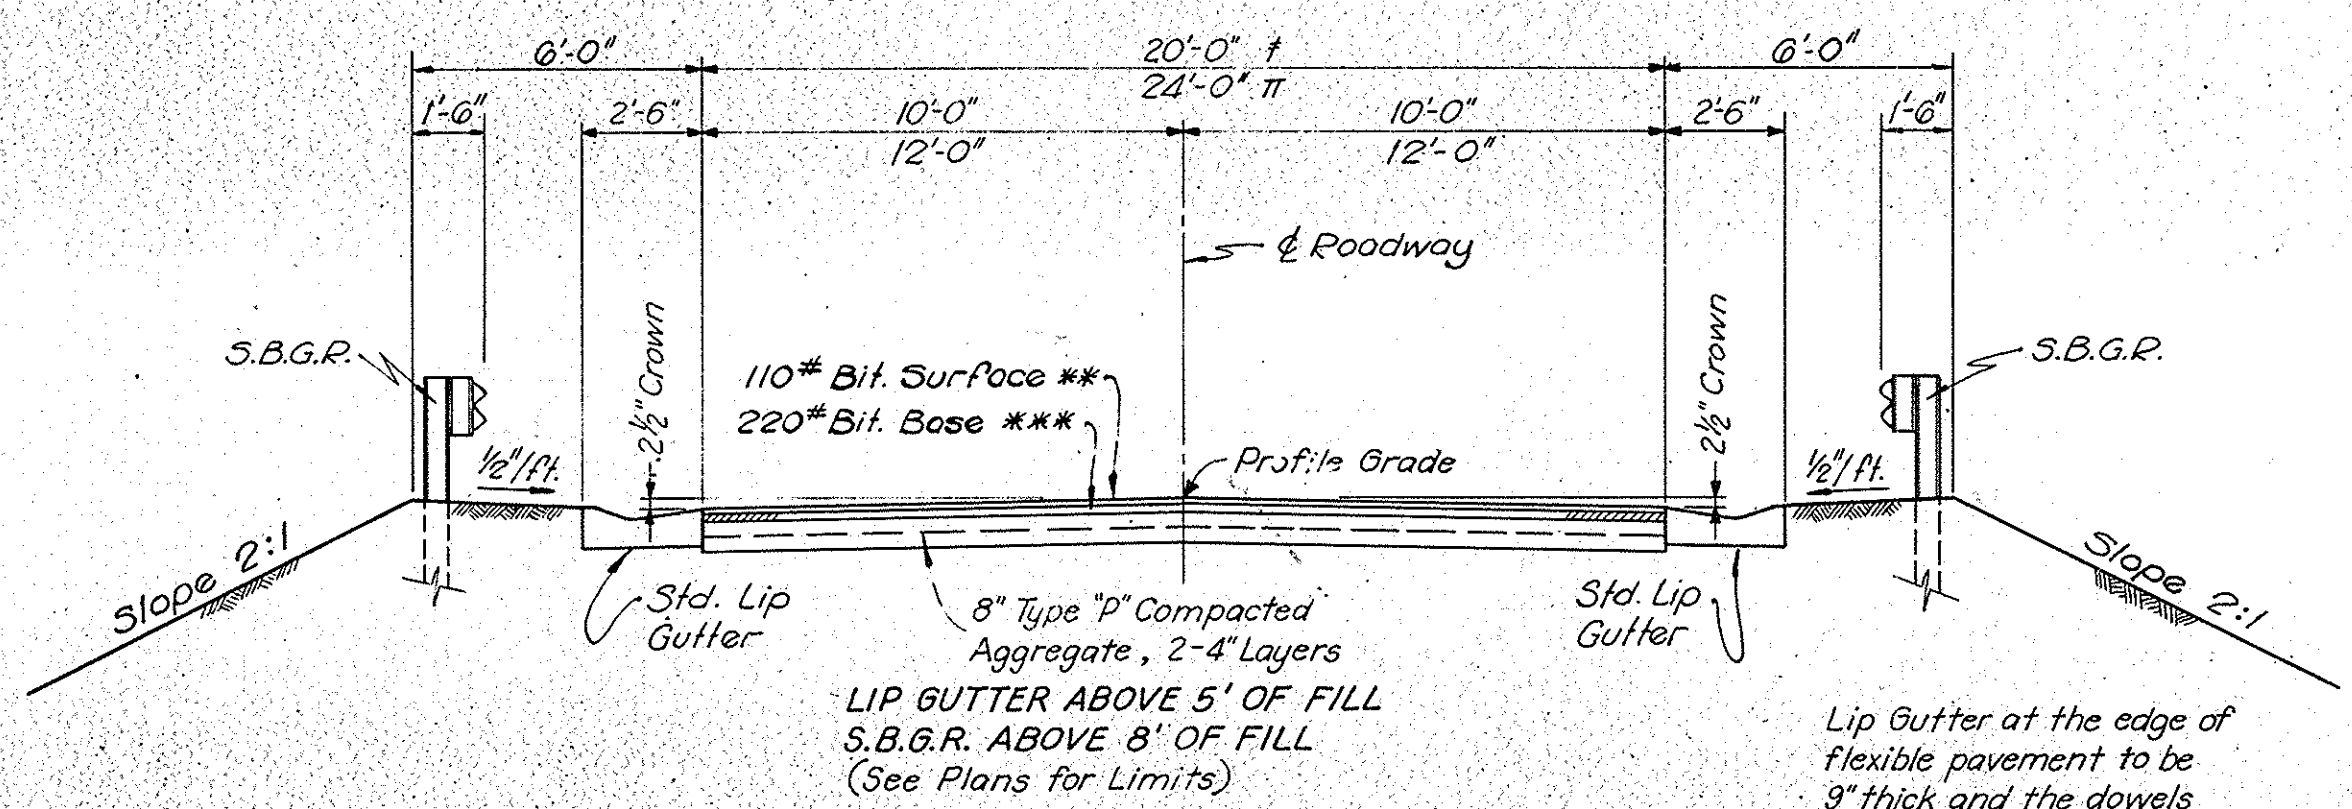

S-1-2B WYANDOTTE CAVE ROAD

- | | |
|-----------------------------------|--------|
| † Sta. 44+25.00 to Sta. 46+05.00 | |
| †† Sta. 47+96.00 to Sta. 49+48.00 | |
| † Sta. 56+00 to Sta. 57+75 | on Rt. |
| † Sta. 57+75 to Sta. 59+50 | on Lt. |

Lip Gutter at the edge of flexible pavement to be 3" thick and the dowels are to be omitted.

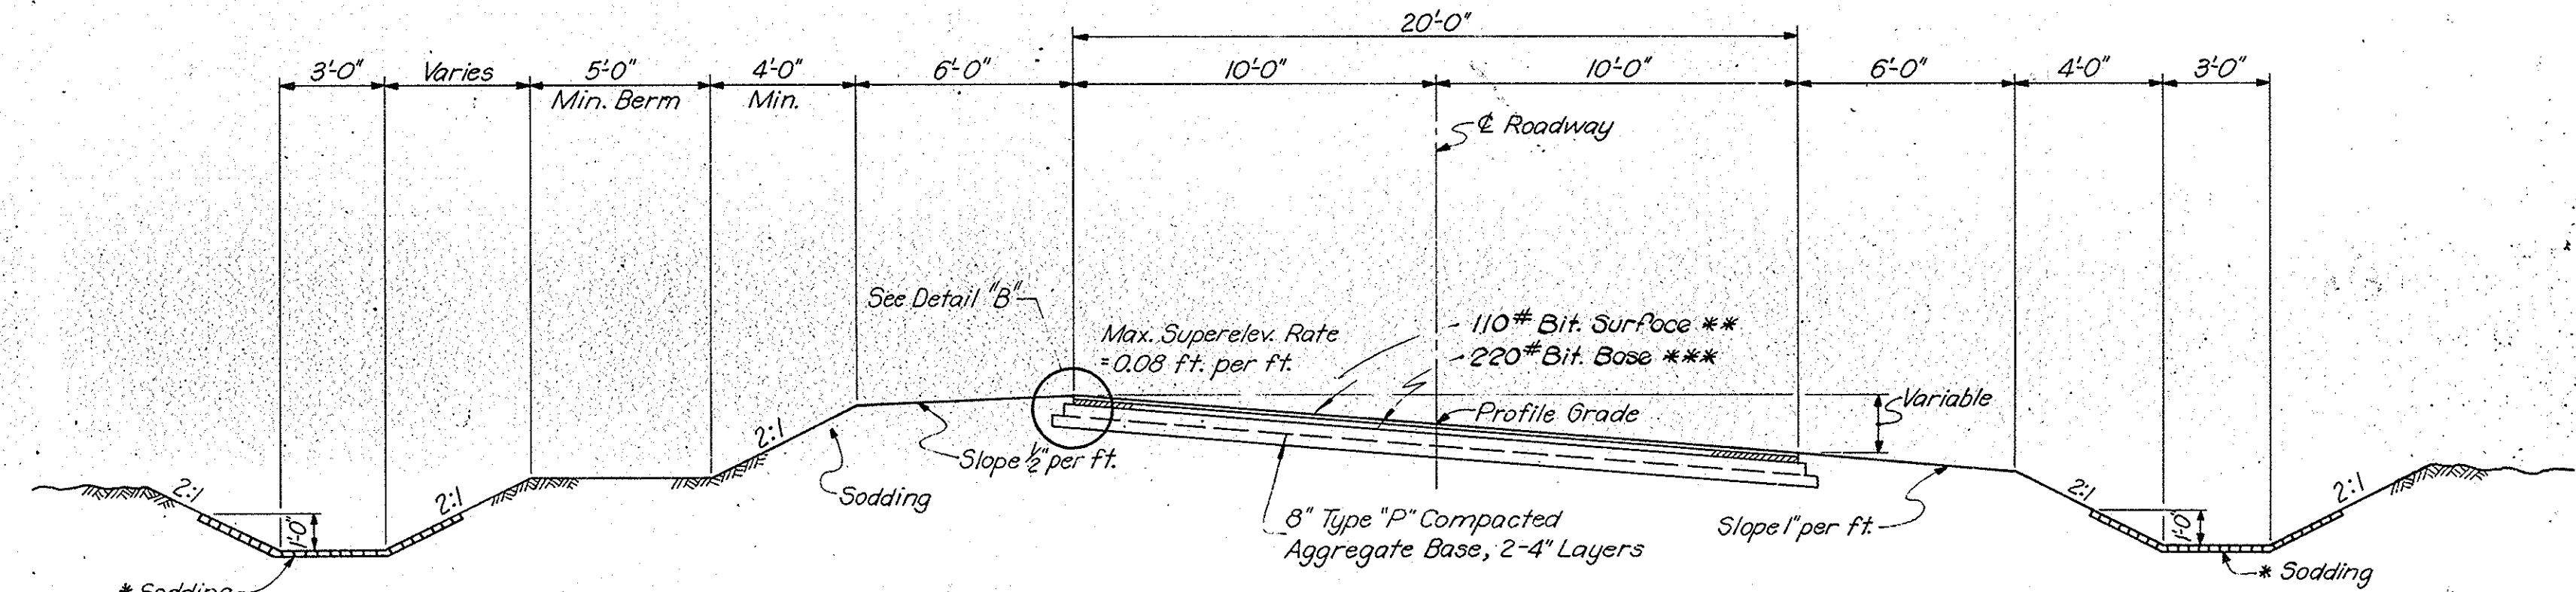

S-1-2B WYANDOTTE CAVE ROAD

- | | |
|--------------------------------|--------|
| Sta. 37+89.36 to Sta. 41+44.29 | |
| Sta. 54+39.76 to Sta. 56+00 | |
| Sta. 56+00 to Sta. 56+77.61 | on Lt. |

CUT

**PAVING
TYPICAL CROSS SECTIONS**


SCALE: 1/4" = 1'-0"

* Sodding as shown for grades 1% and over up to 3%.
 ** H.A.C. Surface Type "B" or H.A.E. Surface Type III.
 *** H.A.C. Base or H.A.E. Base.
 **** H.A.C. Surface Type "A" or H.A.E. Surface II.

SUBMITTED FOR APPROVAL _____

ENGINEER OF ROAD DESIGN, INDIANA STATE HIGHWAY COMMISSION

FEDERAL ROAD REGION NO.	STATE	PROJECT NO.	FISCAL YEAR	SHEET NO.	TOTAL SHEETS
4	IND.	I-64-3(33)86	1967	27	

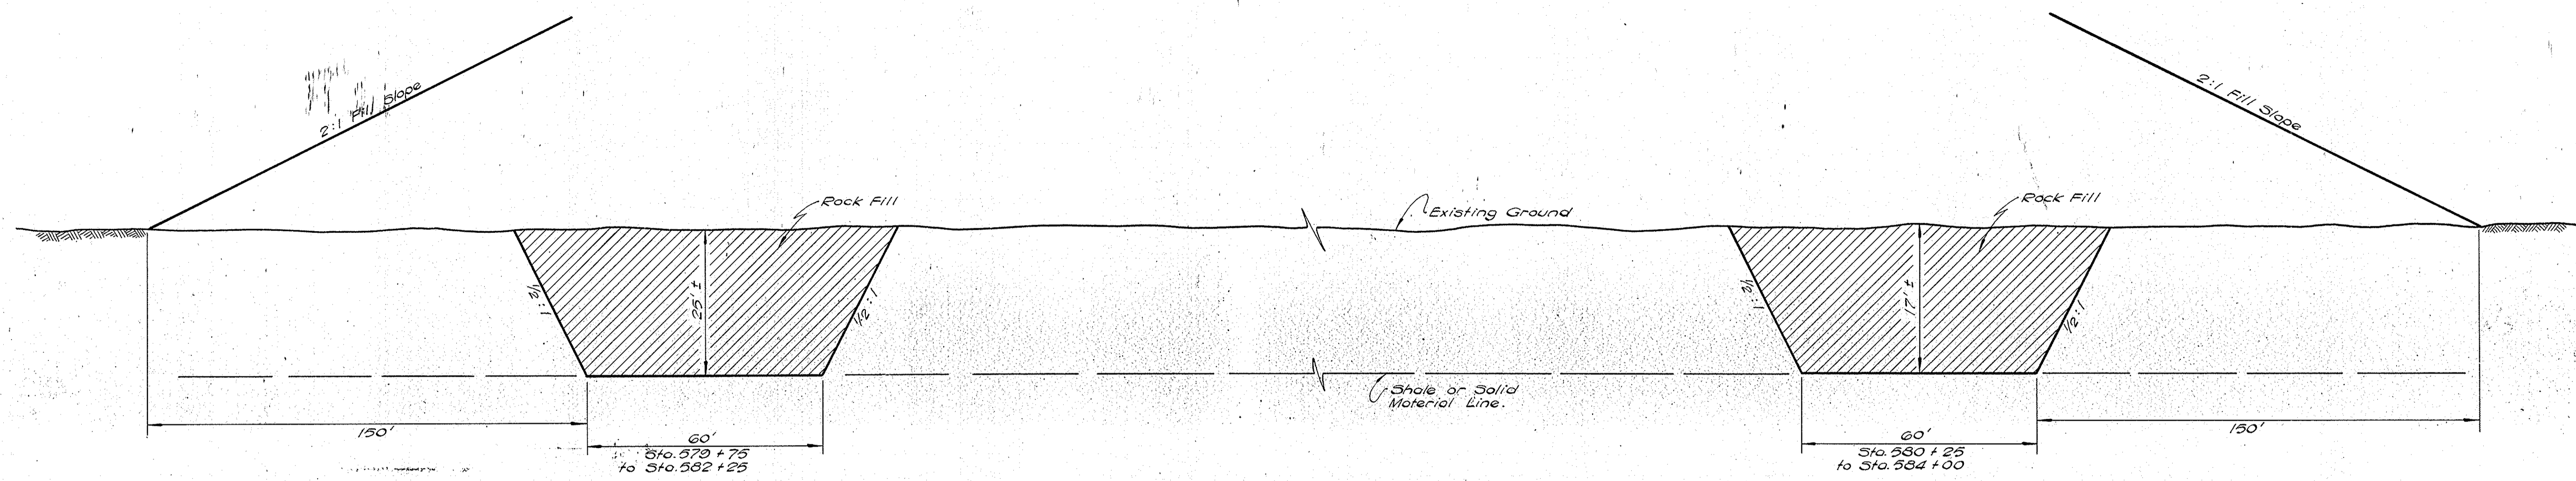

ROCK FILL KEY TYPICAL CROSS SECTIONS


SCALE: None

SUBMITTED FOR APPROVAL _____

ENGINEER OF ROAD DESIGN, INDIANA STATE HIGHWAY COMMISSION

PROJECT NO.	LINE	SHEET NO.	TOTAL SHEETS	FILE
I-64-3(33)86		27		

FEDERAL ROAD REGION NO.	STATE	PROJECT NO.	FISCAL YEAR	SHEET NO.	TOTAL SHEETS
4	IND.	I-64-3(33)06	1967	28	

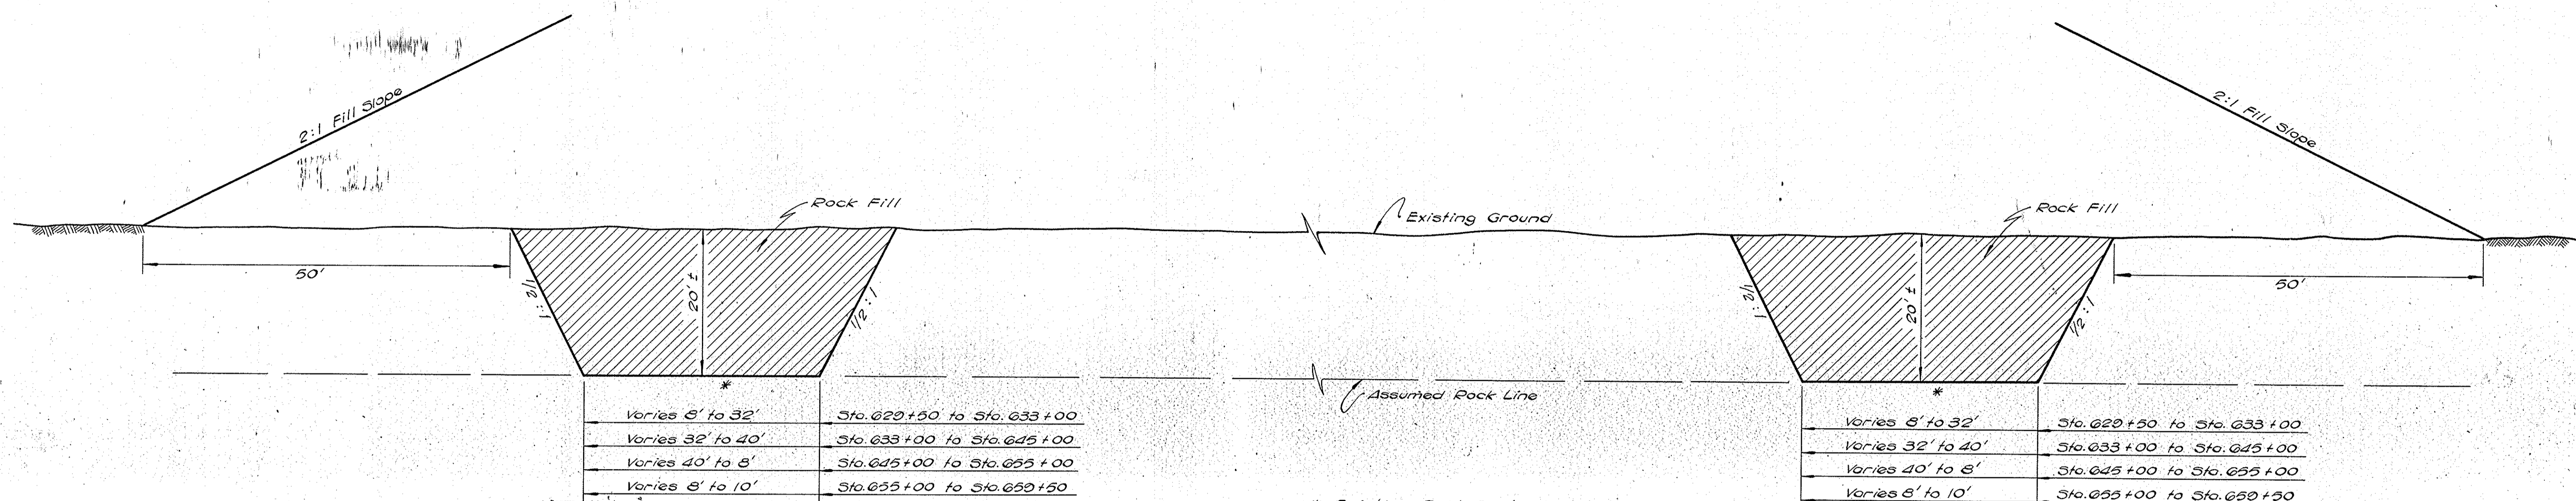

Thickness	Stationing
Varies 8' to 32'	Sta. 020+50 to Sta. 033+00
Varies 32' to 40'	Sta. 033+00 to Sta. 045+00
Varies 40' to 8'	Sta. 045+00 to Sta. 055+00
Varies 8' to 10'	Sta. 055+00 to Sta. 050+50

Thickness	Stationing
Varies 8' to 32'	Sta. 020+50 to Sta. 033+00
Varies 32' to 40'	Sta. 033+00 to Sta. 045+00
Varies 40' to 8'	Sta. 045+00 to Sta. 055+00
Varies 8' to 10'	Sta. 055+00 to Sta. 050+50

* Existing Rock Surface of bottom of key to be loosened to insure proper bonding.

ROCK FILL KEY TYPICAL CROSS SECTIONS

SCALE: None

SUBMITTED FOR APPROVAL _____

ENGINEER OF ROAD DESIGN, INDIANA STATE HIGHWAY COMMISSION

SEPTEMBER 1963

PROJECT NO.	LINE	SHEET NO.	TOTAL SHEETS	FILE
I-64-3(33)06		28		

TYPICAL CROSS SECTION STATIONING

FEDERAL ROAD REGION NO.	STATE	PROJECT NO.	FISCAL YEAR	SHEET NO.	TOTAL SHEETS
4	IND.	I-64-3(33)80	1967	20	20

EAST BOUND LANE

STATION TO STATION	LINE	PAVEMENT SECTION N°	MEDIAN SECTION N°
2463+00 to 2466+00.00	"A"	3	*
EQ: 2466+00.00 "A" Back			
= 467+89.44 "A" Ahead			
467+89.44 to 471+37.00	"A"	3	*
471+37.00 to 474+80	"A"	7	*
474+80 to 486+48.00	"A"	11	*
486+48.00 to 495+50	"A"	4	*
495+50 to 501+80	"A"	17 Lt. 3 Rt.	*
501+80 to 504+25	"A"	3	*
504+25 to 509+51.02	"A"	4	*
509+51.02 to 513+40	"A"	12	*
513+40 to 517+70	"A"	8	*
517+70 to 518+25	"A"	12	*
518+25 to 527+70	"A"	20	*
527+70 to 529+37.73	"A"	20	22
529+37.73 to 532+28.23	"A"	4	14
532+28.23 to 542+35.86	"A"	4	1
542+35.86 to 549+00	"A"	11	1
549+00 to 552+90	"A"	10	15
552+90 to 553+20	"A"	7	1
553+20 to 554+81.42	"A"	11	1
554+81.42 to 565+	"A"	4	1
570+ to 570+55	"A"	4	1
570+55 to 577+20	"A"	17	15
577+20 to 588+15	"A"	4	1
588+15 to 588+84.88	"A"	17	15
588+84.88 to 592+75	"A"	10	22
592+75 to 601+14.05	"A"	10	*
601+14.05 to 602+25	"A"	17	*
602+25 to 604+60	"A"	3 Lt. 4 Rt.	*
604+60 to 608+60	"A"	3	*
608+60 to 610+25	"A"	3 Lt. 4 Rt.	*
610+25 to 611+173.6	"A"	17	*
611+173.6 to 621+90	"A"	20	*
621+90 to 622+28.73	"A"	8	14
622+28.73 to 625+58.27	"A"	3	14
625+58.27 to 629+27.30	"A"	3	1
EQ: 629+27.30 "A" Back			
= 7+27.30 "B" Ahead			
7+27.30 to 11+05	"B"	3	1
11+05 to 20+50	"B"	4	1
20+50 to 25+25	"B"	3	1
25+25 to 30+10	"B"	17	15
30+10 to 33+21.15	"B"	3	1
33+21.15 to 36+00	"B"	7	14
36+00 to 45+01.08	"B"	7	*
45+01.08 to 46+90	"B"	3	*
46+90 to 65+75	"B"	17	*
65+75 to 66+34.45	"B"	3 Lt. 17 Rt.	*
66+34.45 to 69+00	"B"	8 Lt. 20 Rt.	*
69+00 to 67+16.07	"B"	8	*
67+16.07 to 68+60	"B"	3	*
68+60 to 69+10	"B"	4 Lt. 17 Rt.	*
69+10 to 74+60	"B"	17	*
74+60 to 77+06.80	"B"	4	*
77+06.80 to 78.50	"B"	11	*
78+50 to 80+60	"B"	11 Lt. 10 Rt.	*
80+60 to 88+75	"B"	10	*
88+75 to 92+51.47	"B"	11	*
92+51.47 to 102+09.44	"B"	4	*
102+09.44 to 103+	"B"	12	*
104+ to 105+35	"B"	12	*
105+35 to 112+10	"B"	8 Lt. 20 Rt.	*
112+10 to 123+10.77	"B"	12	*
123+10.77 to 132+10.72	"B"	4	*
132+10.72 to 143+21.05	"B"	11	*
143+21.05 to 145+50	"B"	4	*
145+50 to 151+50	"B"	17	*
151+50 to 152+27.00	"B"	3	*
152+27.00 to 153+25	"B"	12	*
153+25 to 162+00	"B"	20	*
162+00 to 162+01.38	"B"	8	*
162+01.38 to 164+25	"B"	3	*
164+25 to 169+50	"B"	4	*

STATION TO STATION	LINE	PAVEMENT SECTION N°	MEDIAN SECTION N°
169+50 to 172+28.77	"B"	17	*
172+28.77 to 181+75	"B"	10	*
181+75 to 183+22.10	"B"	7	*
183+22.10 to 191+50	"B"	3	*
191+50 to 192+10	"B"	4	*
192+10 to 192+65	"B"	3	*
192+65 to 193+06.07	"B"	17	*
193+06.07 to 195+15	"B"	20	*
195+15 to 197+15	"B"	12	*
197+15 to 197+50	"B"	8	*
197+50 to 198+80	"B"	20	*
198+80 to 200+50	"B"	12	*
200+50 to 212+61.40	"B"	20	*
212+61.40 to 235+02.00	"B"	17	*
235+02.00 to 241+25	"B"	10	*
241+25 to 242+50	"B"	7	*
242+50 to 243+00	"B"	11	*
243+00 to 247+03.33	"B"	11	14
247+03.33 to 248+75	"B"	4	1
248+75 to 261+50.15	"B"	3	1
261+50.15 to 262+03.24	"B"	3	14
262+03.24 to 268+00	"B"	8	14
268+00 to 271+00	"B"	20	14
271+00 to 277+38.24	"B"	20	*
277+38.24 to 289+00	"B"	17	*
289+00 to 291+50	"B"	3 Lt. 17 Rt.	*
291+50 to 295+25	"B"	4 Lt. 3 Rt.	*
295+25 to 298+70	"B"	3	*
298+70 to 300+75	"B"	4 Lt. 17 Rt.	*
300+75 to 302+00	"B"	4	*
302+00 to 309+40	"B"	3	*
309+40 to 317+07.86	"B"	4	*
317+07.86 to 324+50	"B"	7	*
324+50 to 328+60	"B"	7	14
328+60 to 329+73.48	"B"	11	14
329+73.48 to 336+75	"B"	4	1
336+75 to 338+20	"B"	3	1
338+20 to 342+20	"B"	4	1
342+20 to 343+30	"B"	3 Lt. 4 Rt.	1
343+30 to 346+05.30	"B"	4	1
346+05.30 to 349+20	"B"	12	1
349+20 to 351+20	"B"	8	1
351+20 to 360+40.30	"B"	12	1
360+40.30 to 363+50	"B"	4	1
363+50 to 364+50	"B"	3	11
364+50 to 372+20	"B"	17	15
372+20 to 372+75	"B"	3	1
372+75 to 375+35	"B"	4	1
375+35 to 376+50	"B"	3	1
376+50 to 379+35	"B"	4	1
379+35 to 389+62.40	"B"	17	15
EQ: 389+62.40 "B" Back			
= 389+05.00 "B" Ahead			
389+05.00 to 390+25	"B"	17	15
390+25 to 398+75	"B"	4	1
398+75 to 402+03.11	"B"	17	15
402+03.11 to 417+57.55	"B"	10	15
417+57.55 to 418+05.33	"B"	10	22
418+05.33 to 422+30	"B"	17	22
422+30 to 423+80	"B"	3	14
423+80 to 443+18.01	"B"	4	*
443+18.01 to 457+25	"B"	12	*
457+25 to 459+28.91	"B"	8	*
459+28.91 to 477+40	"B"	3	*
477+40 to 477+73.78	"B"	4	*
477+73.78 to 484+30	"B"	7	*
484+30 to 489+00.61	"B"	11	*
489+00.61 to 495+30	"B"	4	*
495+30 to 502+14.90	"B"	3	*
502+14.90 to 512+08.24	"B"	8	*
512+08.24 to 519+20	"B"	3	*
519+20 to 524+02.27	"B"	4	*
524+02.27 to 530+75	"B"	11	*
530+75 to 539+57.83	"B"	7	*
539+57.83 to 546+00	"B"	4	*

EAST BOUND LANE

STATION TO STATION	LINE	PAVEMENT SECTION N°	MEDIAN SECTION N°
546+00 to 548+75	"B"	3	*
548+75 to 550+25	"B"	4	*
550+25 to 554+41.45	"B"	3	*
554+41.45 to 561+25	"B"	8	*
561+25 to 570+50	"B"	12	*
570+50 to 573+40	"B"	8	*
573+40 to 578+35	"B"	12	*
578+35 to 580+84.31	"B"	12	14
580+84.31 to 582+72.05	"B"	4	14
582+72.05 to 589+40	"B"	4	1
589+40 to 593+32.34	"B"	17	15
EQ: 593+32.34 "B" Back			
= 593+34.25 "B" Ahead			
593+34.25 to 609+60.92	"B"	10	15
609+60.92 to 620+00	"B"	4	1
620+00 to 622+05.07	"B"	17	15
622+05.07 to 628+30	"B"	20	15
628+30 to 649+04.55	"B"	12	1
649+04.55 to Bridge Except.	"B"	4	1
Bridge Except. to 671+25	"B"	17	15
671+25 to 674+55	"B"	3	1
674+55 to 680+23.64	"B"	4	1
680+23.64 to 682+33.43	"B"	4	14
682+33.43 to 686+70	"B"	12	14
686+70 to 693+80	"B"	12	*
693+80 to 696+53.43	"B"	20	*
696+53.43 to 706+75	"B"	17	*
706+75 to 707+75	"B"	3	*
707+75 to 713+31.61	"B"	4	*
713+31.61 to 716+50	"B"	11	*
716+50 to 718+20	"B"	7	*
718+20 to 720+50	"B"	11	*
720+50 to 721+75	"B"	7	*
721+75 to 724+25	"B"	10	*
724+25 to 726+75	"B"	10 Lt. 11 Rt.	*
726+75 to 730+35	"B"	11	*
730+35 to 731+30	"B"	7	*
731+30 to 733+40	"B"	11	*
733+40 to 735+20	"B"	7	*
735+20 to 736+20	"B"	11	*
736+20 to 737+40	"B"	7	*
737+40 to 738+75	"B"	11 Lt. 7 Rt.	*
738+75 to 741+00.04	"B"	11	*
741+00.04 to 742+11.41	"B"	4	*

* See Cross Sections for Median Grading.

SUBMITTED FOR APPROVAL _____

TYPICAL CROSS SECTION STATIONING

FEDERAL ROAD REGION NO.	STATE	PROJECT NO.	FISCAL YEAR	SHEET NO.	TOTAL SHEETS
4	IND.	1-64-3(33)96	1967	30	

WEST BOUND LANE

WEST BOUND LANE

STATION TO STATION	LINE	PAVEMENT SECTION N°	MEDIAN SECTION N°
2463+22 to 2464+75	"AL"	5	*
2464+75 to 2467+00.00	"AL"	2	*
EQ: 2467+00.00 "AL" Back			
= 468+33.45 "AL" Ahead			
468+33.45 to 473+82.82	"AL"	2	*
473+82.82 to 474+50	"AL"	9	*
474+50 to 478+50	"AL"	9 Lt. 13 Rt.	*
478+50 to 484+20	"AL"	13	*
484+20 to 487+25	"AL"	9	*
487+25 to 488+95.82	"AL"	9 Lt. 13 Rt.	*
488+95.82 to 492+25	"AL"	2	*
492+25 to 495+50	"AL"	5	*
495+50 to 505+00	"AL"	10	*
505+00 to 508+50	"AL"	10 Lt. 2 Rt.	*
508+50 to 510+80	"AL"	2 Lt. 5 Rt.	*
510+80 to 512+77.74	"AL"	5	*
512+77.74 to 528+10	"AL"	18	*
528+10 to 532+06.32	"AL"	18	22
EQ: 532+06.32 "AL" Back			
= 532+28.23 "A" Ahead			
532+28.23 to 538+25	"A"	10	15
538+25 to 538+90.	"A"	10 Lt. 5 Rt.	1
538+90 to 542+35.80	"A"	5	1
542+35.80 to 554+81.42	"A"	13	1
554+81.42 to 505+	"A"	5	1
570+ to 570+60	"A"	5	1
570+60 to 577+10	"A"	10	15
577+10 to 587+25	"A"	5	1
587+25 to 588+84.88	"A"	10	15
EQ: 588+84.88 "A" Back			
= 588+84.88 "AL" Ahead			
588+84.88 to 590+70.63	"AL"	10	15
590+70.63 to 592+75	"AL"	21	22
592+75 to 603+82.24	"AL"	21	*
603+82.24 to 613+82.77	"AL"	10	*
613+82.77 to 621+00	"AL"	13	*
621+00 to 625+58.78	"AL"	6	14
EQ: 625+58.78 "AL" Back			
= 625+58.27 "A" Ahead			
625+58.27 to 629+27.30	"A"	2	1
EQ: 629+27.30 "A" Back			
= 7+27.30 "B" Ahead			
7+27.30 to 11+80	"B"	2	1
11+80 to 20+25	"B"	5	1
20+25 to 24+50	"B"	2	1
24+50 to 29+75	"B"	10	15
29+75 to 32+75	"B"	2	1
32+75 to 33+21.15	"B"	10	15
EQ: 33+21.15 "B" Back			
= 33+21.15 "BL" Ahead			
33+21.15 to 36+60	"BL"	10	22
36+60 to 38+85	"BL"	10	*
38+85 to 44+75	"BL"	2	*
44+75 to 50+25.25	"BL"	10	*
50+25.25 to 57+35	"BL"	21	*
57+35 to 67+75	"BL"	13	*
67+75 to 70+00	"BL"	9	*
70+00 to 74+50	"BL"	21	*
74+50 to 78+75	"BL"	13	*
78+75 to 79+50	"BL"	21 Lt. 13 Rt.	*
79+50 to 85+00	"BL"	21	*
85+00 to 95+75	"BL"	13	*
95+75 to 96+87.75	"BL"	9	*
96+87.75 to 107+18.30	"BL"	2	*
107+18.30 to 109+00	"BL"	10	*
109+00 to 116+75	"BL"	6	*
116+75 to 122+01.72	"BL"	13	*
122+01.72 to 127+50	"BL"	10	*
127+50 to 128+	"BL"	10 Lt. 5 Rt.	*
130+ to 131+95.17	"BL"	5	*
131+95.17 to 141+97.25	"BL"	13	*
141+97.25 to 147+75	"BL"	5	*
147+75 to 151+11.54	"BL"	10	*
151+11.54 to 152+75	"BL"	18	*
152+75 to 162+14.04	"BL"	10	*

STATION TO STATION	LINE	PAVEMENT SECTION N°	MEDIAN SECTION N°
162+14.04 to 166+	"BL"	5	*
167+ to 169+75	"BL"	5	*
169+75 to 171+43.70	"BL"	10 Lt. 5 Rt.	*
171+43.70 to 173+75	"BL"	21 Lt. 13 Rt.	*
173+75 to 181+28.23	"BL"	13	*
181+28.23 to 191+08.88	"BL"	5	*
191+08.88 to 200+00	"BL"	10	*
200+00 to 201+50	"BL"	18 Lt. 10 Rt.	*
201+50 to 207+50	"BL"	18	*
207+50 to 208+50	"BL"	18 Lt. 10 Rt.	*
208+50 to 209+30.88	"BL"	10	*
209+30.88 to 212+75	"BL"	5	*
212+75 to 221+01.10	"BL"	10	*
EQ: 221+01.10 "BL" Back			
= 221+00.00 "BL" Ahead			
221+00.00 to 225+00	"BL"	10	*
225+00 to 227+05.80	"BL"	2 Lt. 10 Rt.	*
227+05.80 to 228+30	"BL"	9 Lt. 10 Rt.	*
228+30 to 238+70	"BL"	13 Lt. 10 Rt.	*
238+70 to 243+00	"BL"	13	*
243+00 to 243+24.69	"BL"	13	14
243+24.69 to 246+10.65	"BL"	5	14
EQ: 246+10.65 "BL" Back			
= 247+03.33 "B" Ahead			
247+03.33 to 261+50.15	"B"	2	1
EQ: 261+50.15 "B" Back			
= 261+50.15 "BL" Ahead			
261+50.15 to 264+00	"BL"	6	14
264+00 to 271+00	"BL"	18	22
271+00 to 277+06.03	"BL"	18	*
EQ: 277+06.03 "BL" Back			
= 277+50.86 "BL" Ahead			
277+50.86 to 295+70	"BL"	10	*
295+70 to 303+80	"BL"	5	*
303+80 to 306+00	"BL"	5 Lt. 10 Rt.	*
306+00 to 307+75	"BL"	10	*
307+75 to 308+75	"BL"	5 Lt. 10 Rt.	*
308+75 to 313+76.71	"BL"	5	*
EQ: 313+76.71 "BL" Back			
= 313+30.20 "BL" Ahead			
313+30.20 to 321+25	"BL"	13	*
321+25 to 324+60	"BL"	9	*
324+60 to 326+50	"BL"	9	14
326+50 to 329+25.44	"BL"	13	14
329+25.44 to 329+80.10	"BL"	5	14
EQ: 329+80.10 "BL" Back			
= 329+73.48 "B" Ahead			
329+73.48 to 335+75	"B"	5	1
335+75 to 338+35	"B"	2	1
338+35 to 341+25	"B"	5	1
341+25 to 346+06.30	"B"	2	1
346+06.30 to 350+35	"B"	0	1
350+35 to 353+55	"B"	13	15
353+55 to 354+80	"B"	0	1
354+80 to 360+40.30	"B"	10	1
360+40.30 to 364+35	"B"	5	1
364+35 to 376+70	"B"	10	15
376+70 to 379+20	"B"	2 Lt. 5 Rt.	1
379+20 to 389+02.40	"B"	10	15
EQ: 389+02.40 "B" Back			
= 389+05.00 "B" Ahead			
389+05.00 to 399+75	"B"	5	1
399+75 to 401+50	"B"	2	1
401+50 to 402+03.11	"B"	10	15
EQ: 402+03.11 "B" Back			
= 402+03.11 "BL" Ahead			
402+03.11 to 408+50	"BL"	21	15
408+50 to 409+00	"BL"	9	1
409+00 to 411+25	"BL"	13	1
411+25 to 412+25	"BL"	9	1
412+25 to 417+57.55	"BL"	21	15
417+57.55 to 422+75	"BL"	2	14
422+75 to 423+50	"BL"	5	14
423+50 to 433+40	"BL"	5	*
433+40 to 434+50	"BL"	2	*

STATION TO STATION	LINE	PAVEMENT SECTION N°	MEDIAN SECTION N°
434+50 to 441+17.22	"BL"	10	*
441+17.22 to 451+00	"BL"	18	*
451+00 to 453+00	"BL"	6	*
453+00 to 461+87.22	"BL"	10	*
461+87.22 to 464+80	"BL"	5	*
464+80 to 477+03.02	"BL"	12	*
477+03.02 to 482+50	"BL"	9	*
482+50 to 484+50	"BL"	13 Lt. 9 Rt.	*
484+50 to 490+00	"BL"	9	*
490+00 to 493+04.62	"BL"	13	*
493+04.62 to 494+50	"BL"	5	*
494+50 to 502+06.79	"BL"	2	*
502+06.79 to 507+50	"BL"	10	*
507+50 to 514+06.79	"BL"	6	*
514+06.79 to 523+50	"BL"	2	*
523+50 to 525+02.74	"BL"	5	*
525+02.74 to 528+40	"BL"	9	*
528+40 to 535+00	"BL"	13	*
535+00 to 538+20	"BL"	9	*
538+20 to 541+11.41	"BL"	13	*
541+11.41 to 545+70	"BL"	2	*
545+70 to 550+75	"BL"	10	*
550+75 to 551+25	"BL"	2	*
551+25 to 552+40	"BL"	6	*
552+40 to 554+75	"BL"	2	*
554+75 to 558+01.39	"BL"	6	*
558+01.39 to 559+40	"BL"	10	*
559+40 to 560+00	"BL"	6	*
560+00 to 564+35	"BL"	18	*
564+35 to 565+70	"BL"	6	*
565+70 to 578+50	"BL"	18	*
578+50 to 580+25	"BL"	6	*
580+25 to 582+10	"BL"	6	14
582+10 to 584+00	"BL"	6 Lt. 10 Rt.	14
584+00 to 584+48.06	"BL"	10	14
EQ: 584+48.06 "BL" Back			
= 582+72.05 "B" Ahead			
582+72.05 to 585+50	"B"	6	1
585+50 to 587+00	"B"	2 Lt. 6 Rt.	1
587+00 to 588+50	"B"	2	1
588+50 to 593+32.34	"B"	10	13
EQ: 593+32.34 "B" Back			
= 593+34.25 "B" Ahead			
593+34.25 to 609+00.02	"B"	21	13
609+00.02 to 611+75	"B"	10	15
611+75 to 613+00	"B"	10 Lt. 6 Rt.	1
613+00 to 615+50	"B"	6	1
615+50 to 616+00	"B"	2 Lt. 6 Rt.	1
616+00 to 617+15	"B"	2 Lt. 10 Rt.	1
617+15 to 620+25	"B"	2	1
620+25 to 622+05.07	"B"	10	15
622+05.07 to 628+40	"B"	13	15
628+40 to 640+04.55	"B"	10	1
640+04.55 to	"B"	5	1
to 672+40	"B"	10	15
672+40 to 674+20	"B"	2	1
674+20 to 676+40	"B"	5	1
676+40 to 677+20	"B"	2 Lt. 5 Rt.	1
677+20 to 680+23.64	"B"	5	1
EQ: 680+23.64 "B" Back			
= 680+23.64 "BL" Ahead			
680+23.64 to 680+75	"BL"	10	14
680+75 to 683+75	"BL"	6	14
683+75 to 684+55	"BL"	10	14
684+55 to 686+10	"BL"	6 Lt. 10 Rt.	14
686+10 to 689+70	"BL"	6	14
689+70 to 690+60	"BL"	6	*
690+60 to 694+23.64	"BL"	10	*
694+23.64 to 694+70	"BL"	5	*
694+70 to 695+10	"BL"	2	*
695+10 to 705+50	"BL"	10	*
705+50 to 706+10	"BL"	10 Lt. 2 Rt.	*
706+10 to 707+80	"BL"	2 Lt. 5 Rt.	*
707+80 to 710+20.68	"BL"	5	*
710+20.68 to 713+00	"BL"	13	*

STATION TO STATION	LINE	PAVEMENT SECTION N°	MEDIAN SECTION N°
713+00 to 728+70	"BL"	9	*
728+70 to 739+75.74	"BL"	13	*
739+75.74 to 742+70.00	"BL"	5	*

* See Cross Sections for Median Grading.

SUBMITTED FOR APPROVAL

ENGINEER OF ROAD DESIGN - INDIANA STATE HIGHWAY COMMISSION


COUNTY	TOWNSHIP	SECTION	INDEX	OWNER	ACRE
CRAWFORD	UNION	13	15A	CLYDE ROBERTS	2
"	"	"	15B	THOMAS & MELLIE MILBY	2.75
"	"	14	15C	GREY, ASH ET AL.	8.20
"	"	"	4B	NORMAN BURNSWORTH	0.50
"	"	23	4B	DENOLA FAULKNER	0.50
"	"	23	10	EVERETT & ESTELLA TIMBERLAKE	10
"	"	23	12B	GEORGE & HALLIE RAINEY	19.1
"	"	23	12C	WILLIAM & MARTENIA SMITH	1.82
"	"	24	18	GRANT SATTERFIELD	10
"	"	24	19	ELMER & ALICE HOUSE	19
"	"	25	3	E.F. JR. ALLINGER	5
"	"	25	4	ELMER & ALICE HOUSE	4
"	"	25	9A	SHERRIL & BERTHA WRIGHT	4
"	"	25	9B	JOHN F. & ROSA STROUT	4
"	"	25	10B	THOMAS & ARZELLA COLLINS	4
"	"	25	11	RUSSELL & TERESIA UNDERHILL	16.75
"	"	25	13	VERSEL D. WRIGHT	13
"	OHIO	19	23B	SAMUEL D. WRIGHT, RAINEY, GEORGE ET UX.	0.25
"	"	19	14	J.C. LONGEST & LEO LAND	10
"	"	19	15	GRANT SATTERFIELD	2
"	"	20	5A	GRESHAM RITCHIE	28.30
"	"	20	5B	GENE & JOAN RITCHIE	8.30
"	"	20	6A	REVA LYNCH	4
"	UNION	26	11	ROBERT & MINNIE FISCHER	9
"	"	14	17	R.L. SCHROEDER	12

END IO4(b)5 SECTION A14.1-A14.2
 BEGIN IO4(b)5 SECTION A14.2-A14.3

STA. 629+27.39 "A" BACK
 STA. 7+27.39 "B" AHEAD

LEGEND
 LANDLOCKED (NO ACCESS PROVIDED)



(30)86 P.E.
 (33)86 R/W
 (38)86 GRADING
 (39)86 PAVING
 BEGIN PROJECT I-64-3
 BEGIN IO4(b)5 SECTION A14.1-A14.2
 STA. 2463+00.00 "A" AHEAD
 STA. 2463+22.00 "AL" AHEAD
 (5)73 P.E.
 (10)73 R/W
 (22)87 GRADING
 (26)73 PAVING
 END PROJECT I-64-2
 END IO4(b)5 SECTION A13-A14.1
 STA. 2463+00.00 "A" BACK
 STA. 2463+22.00 "AL" BACK

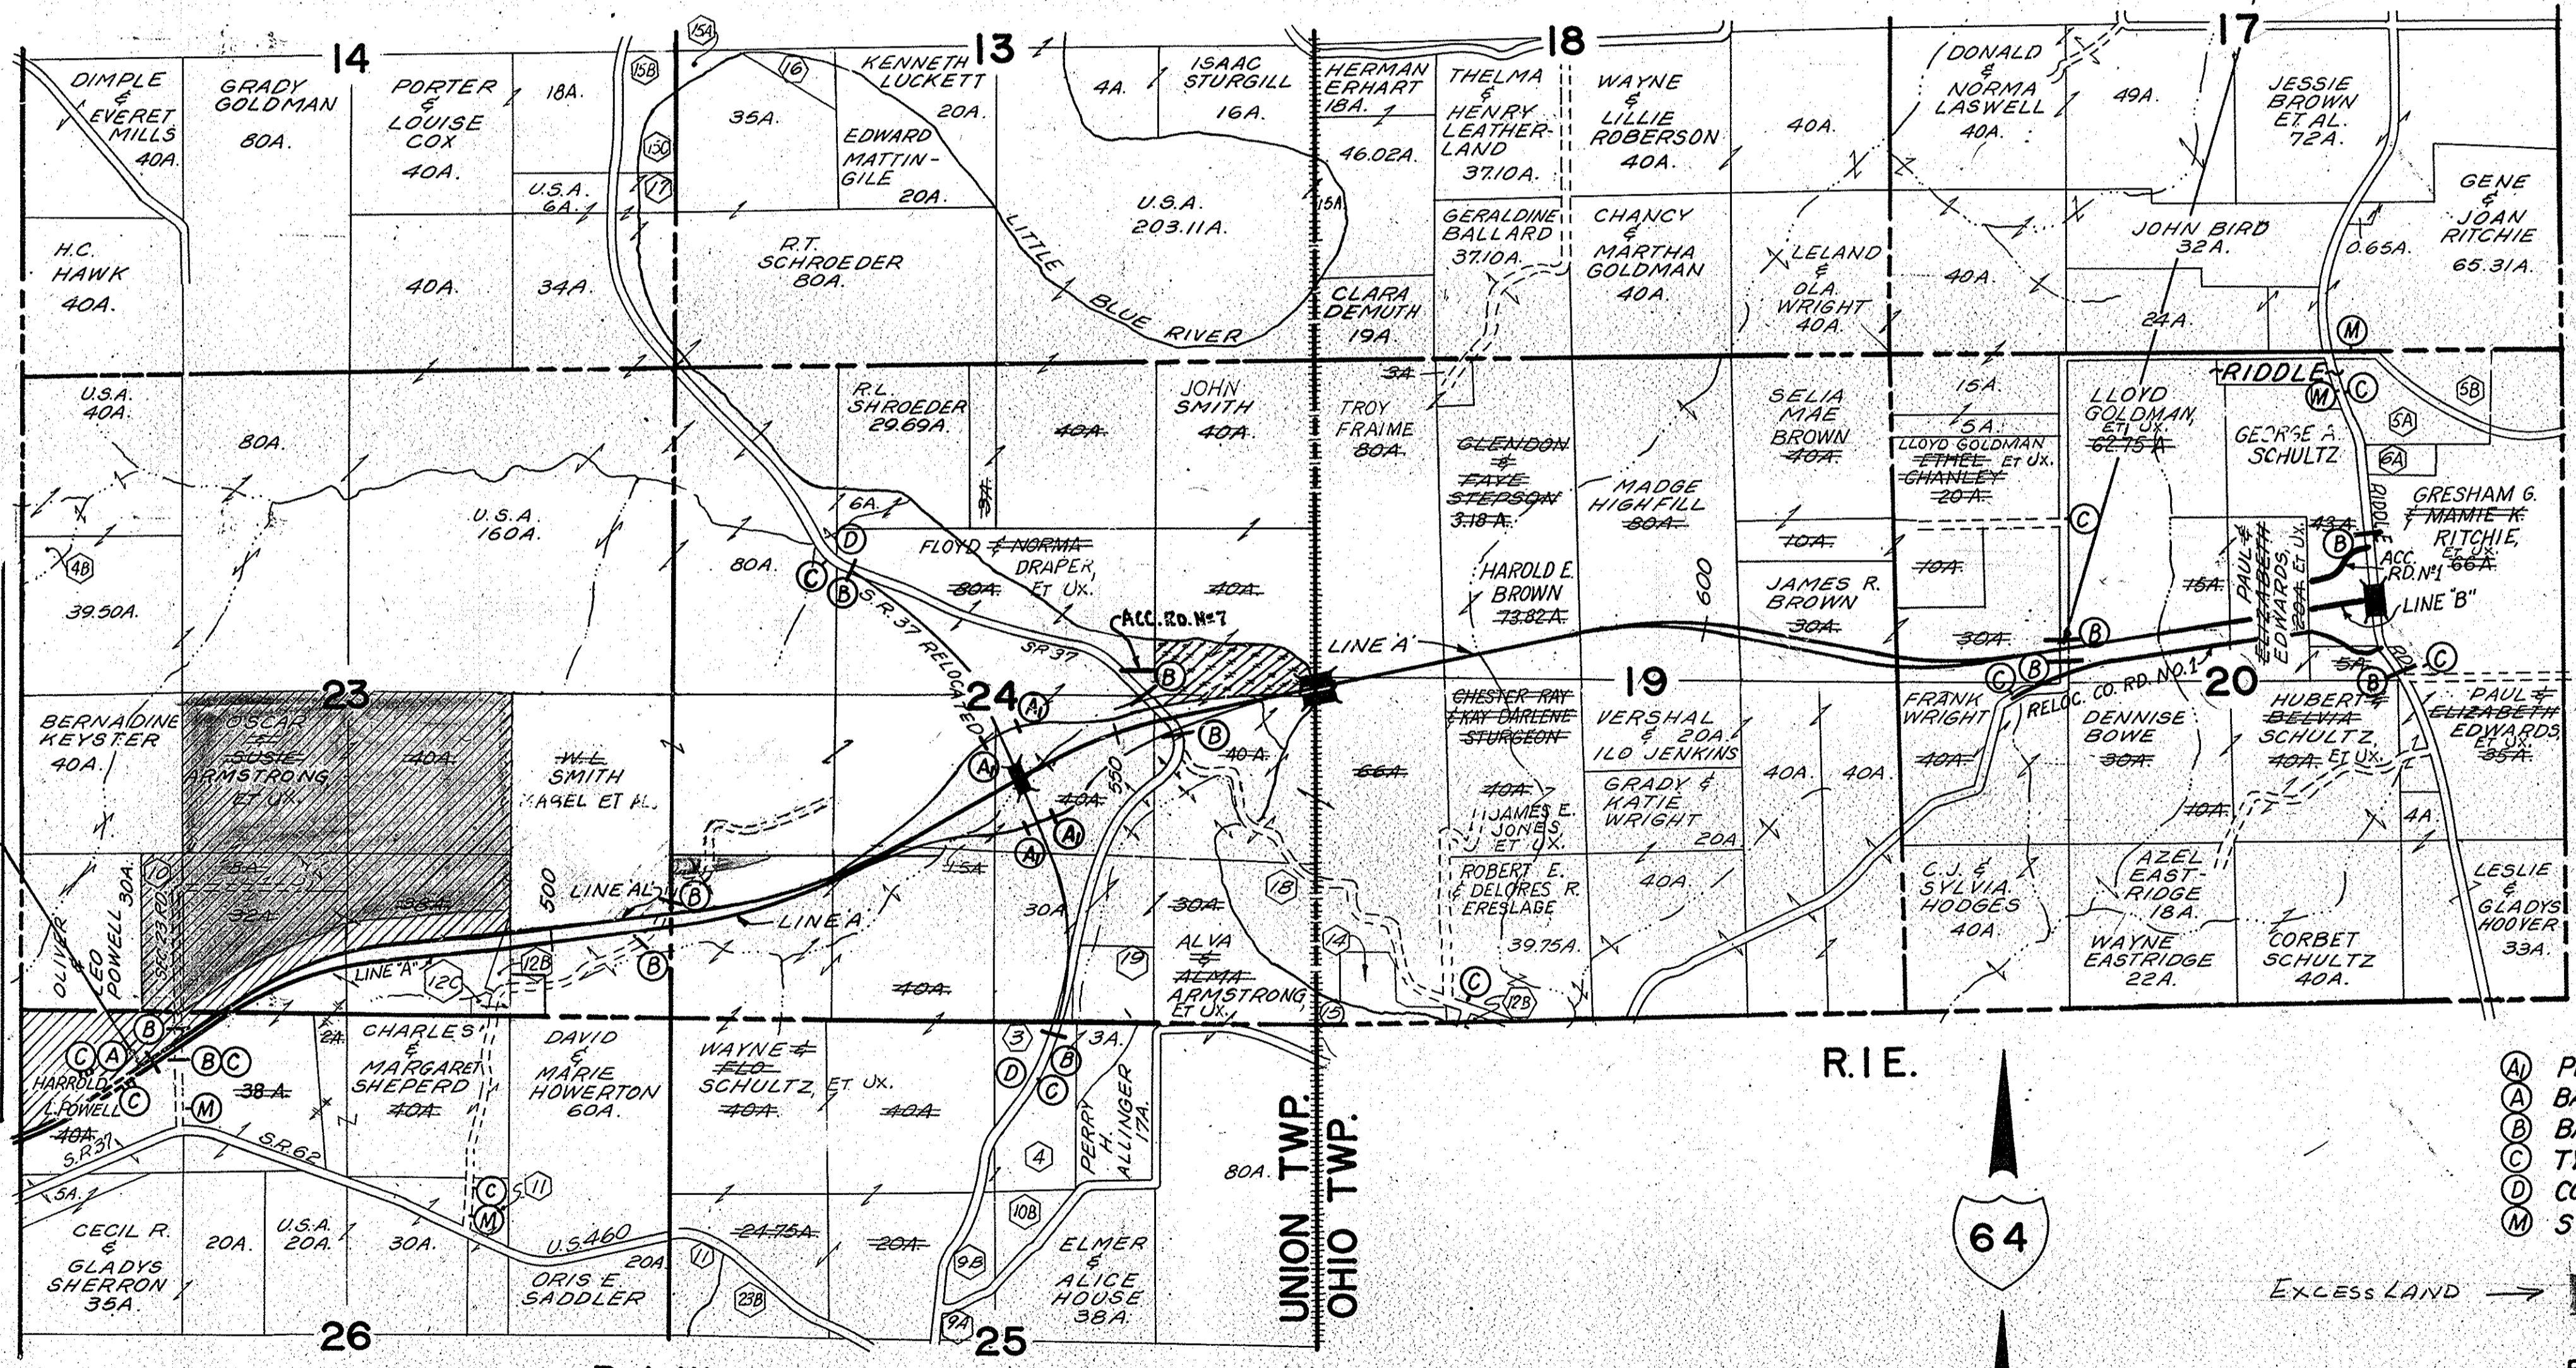


- (A) PERMANENT BARRICADE, TYPE A
- (B) BARRICADE, TYPE A
- (C) BARRICADE, TYPE B
- (D) TYPICAL SIGN STANDARD
- (E) CONSTRUCTION IDENTIFICATION SIGN
- (M) STANDARD SIGN M-29


C R A W F O R D C O.

PROJECT I-64-3(33)86 R/W
 PLAT I
 FOR ROAD DESIGN
 SCALE: 1" = 1000'

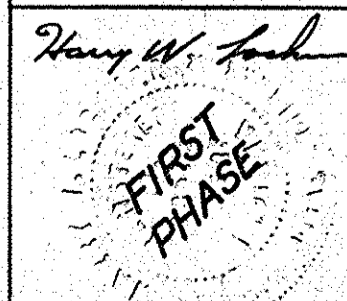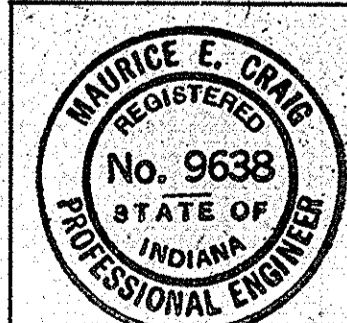

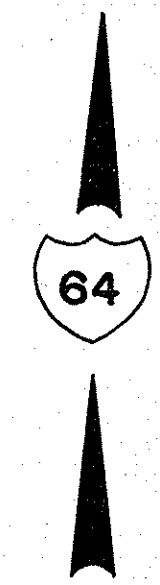

LEGEND
 LANDLOCKED, (NO ACCESS PROVIDED)

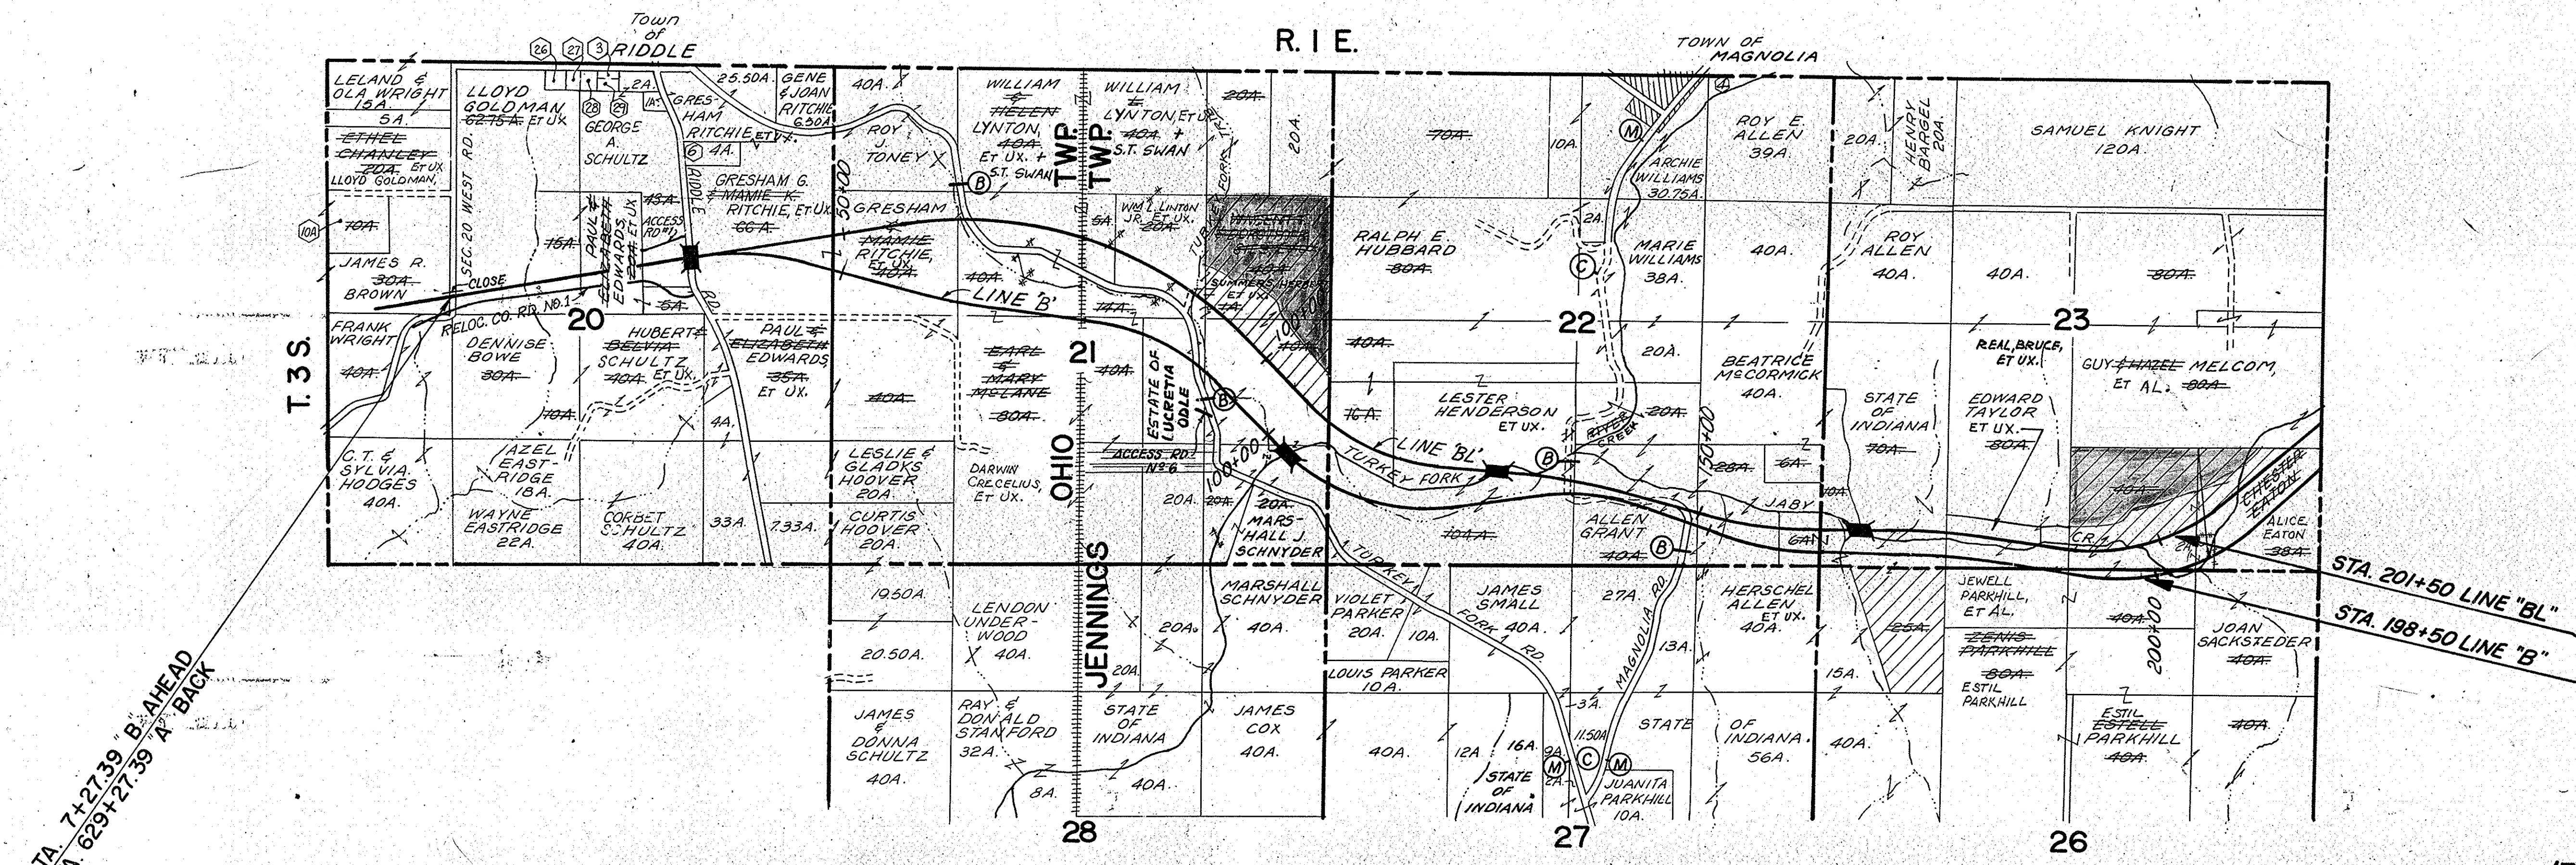

STA. 7+27.39 "A" AHEAD
 STA. 629+27.39 "A" BACK

BEGIN I04(b)5 SECTION A14.2 - A14.3
 END I04(b)5 SECTION A14.1 - A14.2

C R A W F O R D C O.


END PROJECT I-64-3(38)86 GRADING
 END I04(b)5 SECTION A14.2 - A14.3
 BEGIN PROJECT I-64-3(40)93 GRADING
 BEGIN I04(b)5 SECTION A14.3 - A14.4.1

COUNTY	TOWNSHIP	SECTION	INDEX	OWNER	ACRES
CRAWFORD	OHIO	20	3	U.B. CHURCH	0.33
"	"	20	26	HERMAN CHANLEY	1
"	"	20	27	CEMETERY	0.50
"	"	20	28	"	0.40
"	"	20	29	"	0.50
"	"	20	10A	"	4
"	"	20	6	"	1
"	JENNINGS	22	4	SHELIA MAE BROWN SYLVIA SCHULTZ H.W. COX	

- (A) PERMANENT BARRICADE, TYPE A
- (A) BARRICADE, TYPE A
- (B) BARRICADE, TYPE B
- (C) TYPICAL SIGN STANDARD
- (D) CONSTRUCTION IDENTIFICATION SIGN
- (M) STANDARD SIGN M-29

Excess Land

PROJECT I-64-3(33)86 R/W
PLAT I
FOR ROAD DESIGN
 SCALE: 1" = 1000'

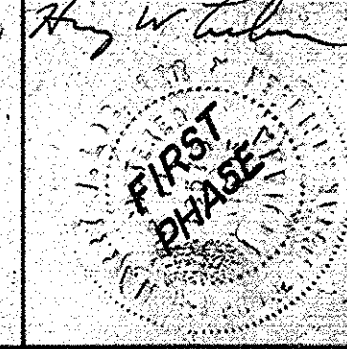

Rev. 6-9-65


C R A W F O R D C O.
J E N N I N G S T W P

END 104(b)5 SECTION A14.3-A14.1
BEGIN 104(b)5 SECTION A14.4.1-A14.4.2

LANDLOCKED (NO ACCESS PROVIDED)


R.1E.

R.2E.

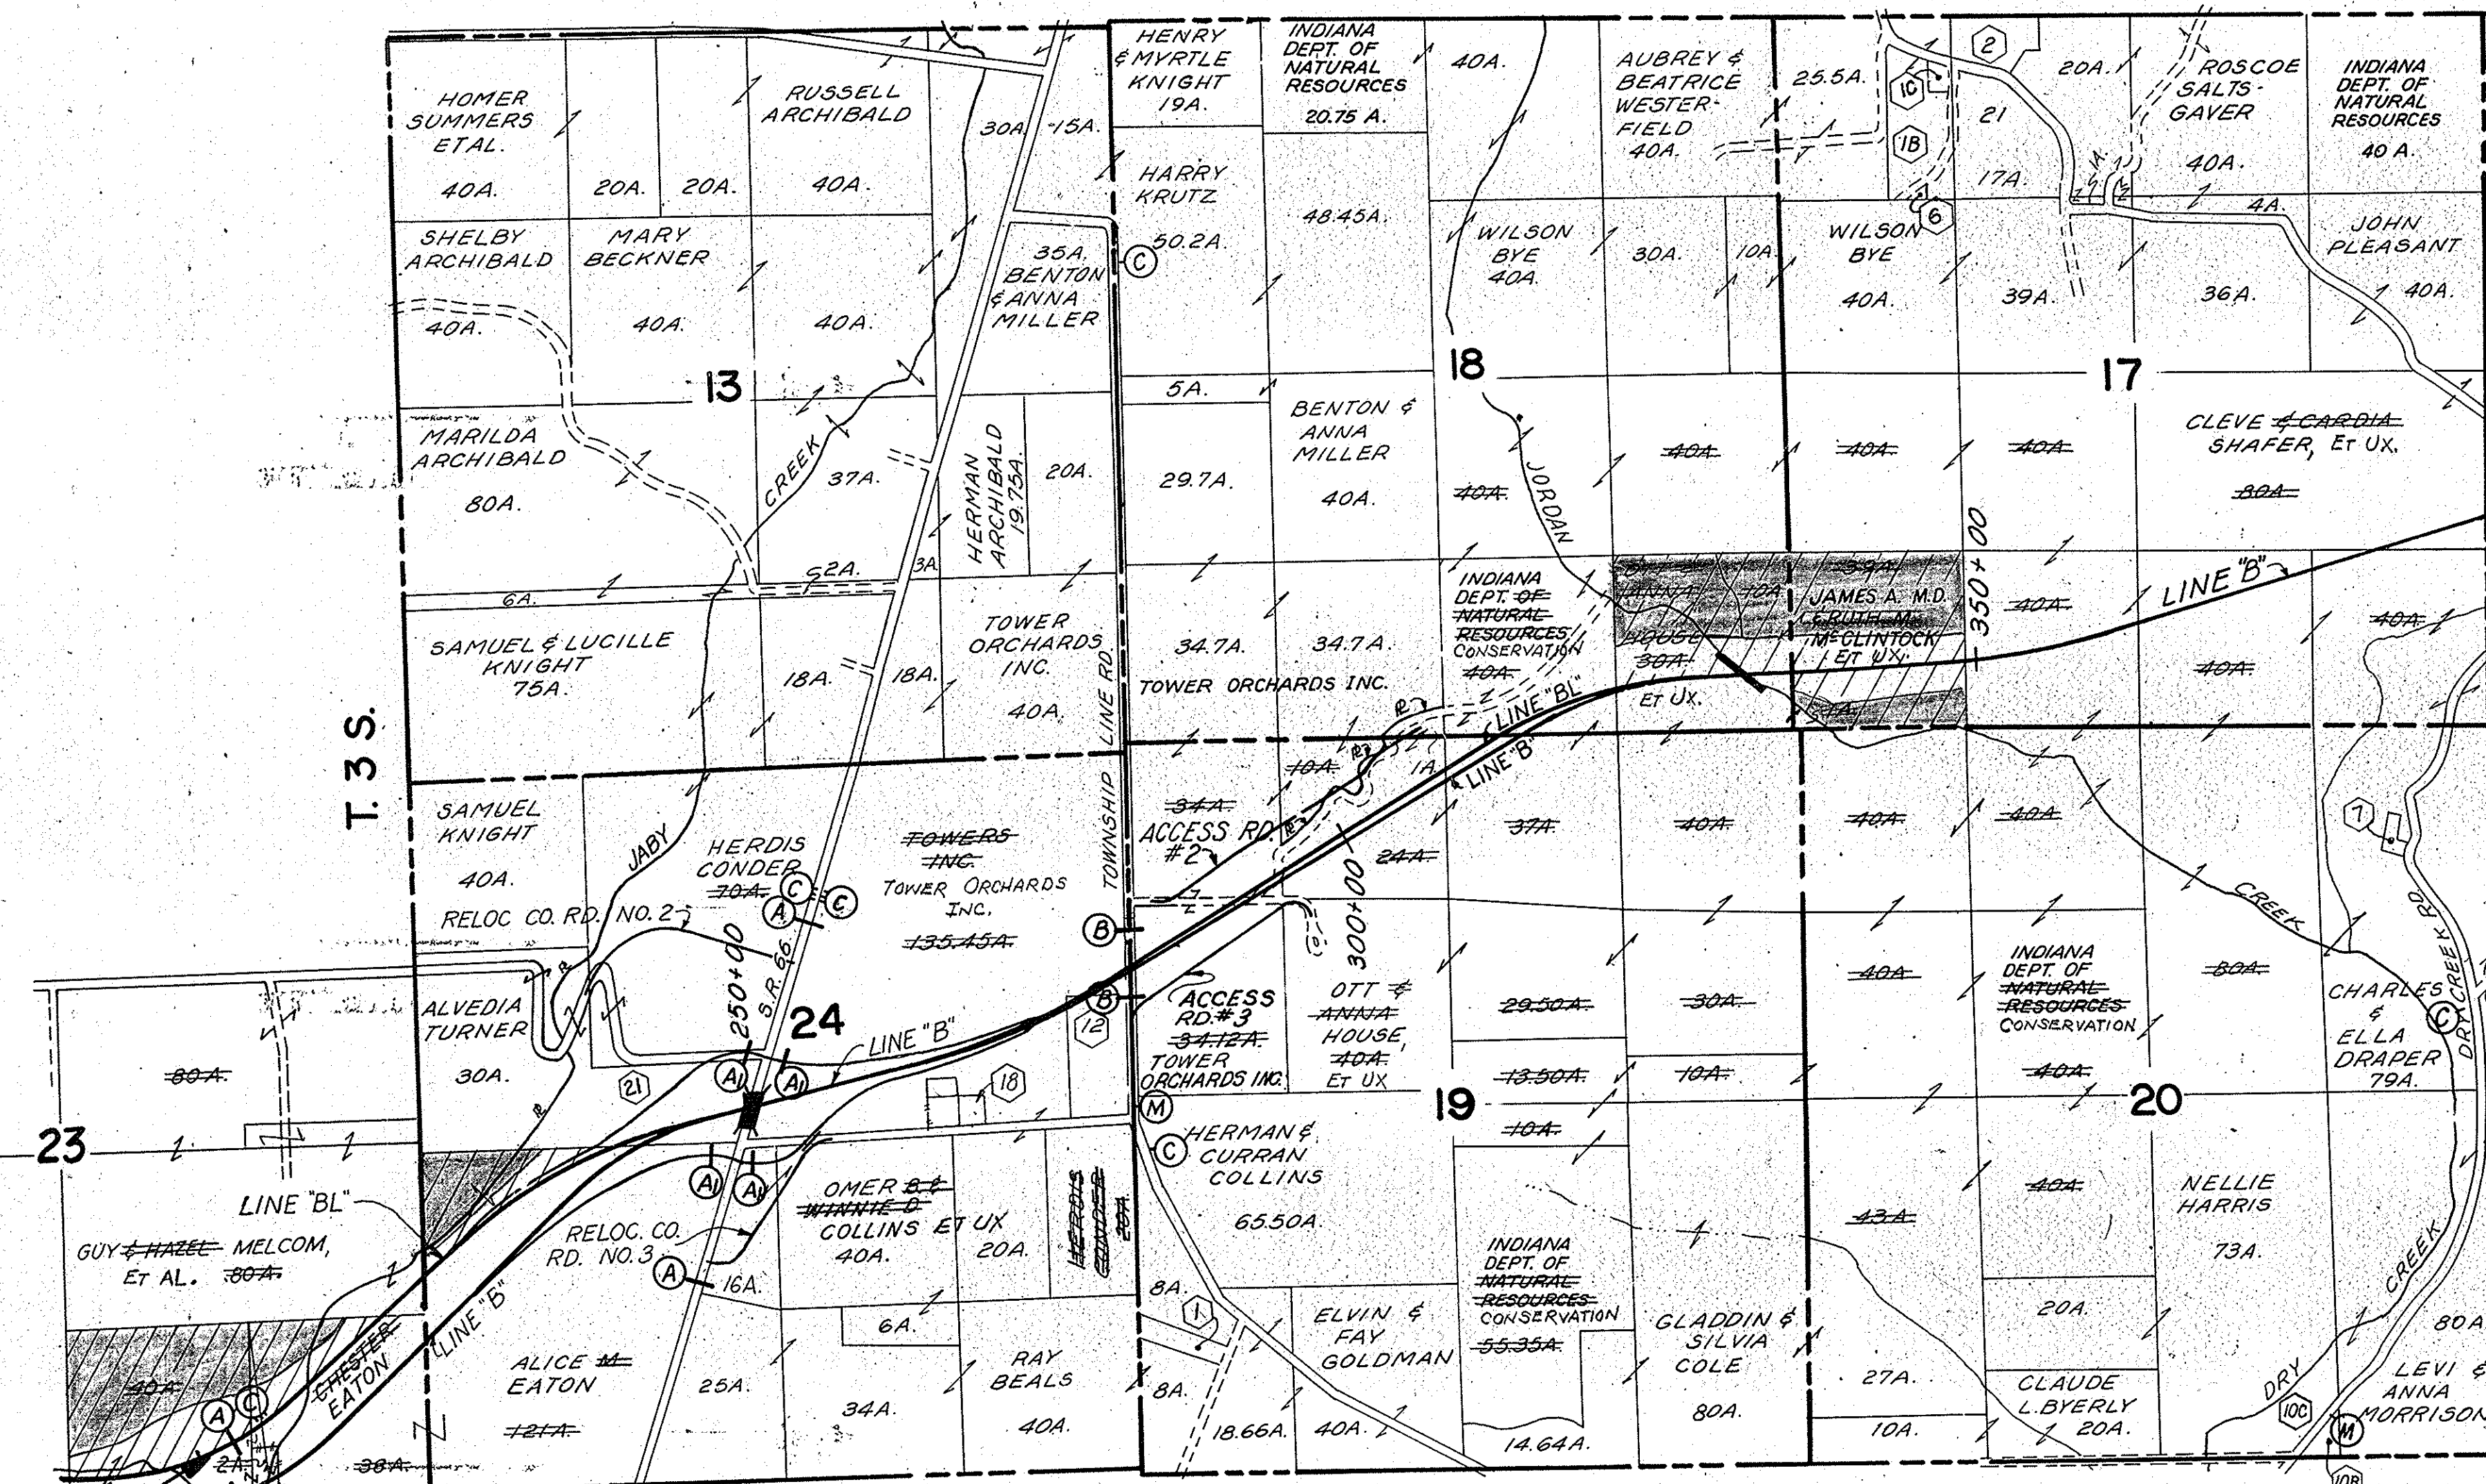

STA. 389+62.40 "B" BACK
STA. 389+65.00 "B" AHEAD

COUNTY	TOWNSHIP	SECTION	INDEX	OWNER	ACRES
CRAWFORD	JENNINGS	17	1B	OWEN & ALICE SALTS GAVER	13.5
"	"	17	1C	TRUSTEES SHAFER RIDGE CHRISTIAN CHURCH	0.5
"	"	17	2	CORA BERNARDI	5
"	"	17	6	JENNINGS TWP	0.5
"	"	19	1	WILLIAM T. BEALS	2
"	"	20	7	TRUSTEES OF FULL GOSPEL CHURCH	2
"	"	20	10B	HARRY ANDREWS	7
"	"	20	10C	GLADDIN & SILVA COLE	7
"	"	24	12	HERMAN E. & EFFIE B. COLLINS, ET UX.	13
"	"	24	18	CHURCH	2.23
"	"	24	21	MARGARET, MICHAEL, JANET RUTH, BARBARA JEAN & DANIEL ARMENOFF, ET AL.	26

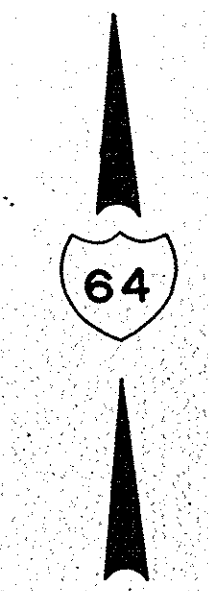


BEGIN PROJECT 1-64-3 (40) 93 GRADING
(41) 93 PAVING
BEGIN 104(b)5 SECTION A14.3-A14.4.1

END PROJECT 1-64-3 (38) 86 GRADING
(39) 86 PAVING
END 104(b)5 SECTION A14.2-A14.3

- (A) PERMANENT BARRICADE, TYPE A
- (A) BARRICADE, TYPE A
- (B) BARRICADE, TYPE B
- (C) TYPICAL SIGN STANDARD
- (D) CONSTRUCTION IDENTIFICATION SIGN
- (M) STANDARD SIGN M-29

EXCESS LAND

PROJECT 1-64-3(33)86 R/W
PLAT I
FOR ROAD DESIGN
SCALE 1" = 1000

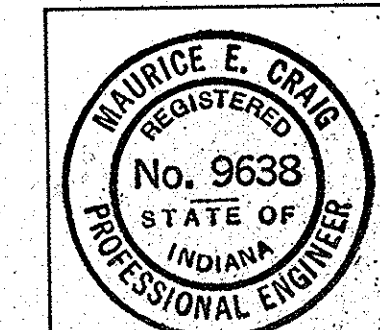


First Phase

BEGIN I04(b)5 SECTION A14.4.1 - A14.4.2
 END I04(b)5 SECTION A14.3 - A14.4.1

STA 389+62.40 "B" BACK
 STA 389+65.00 "B" AHEAD

LEGEND
 [Hatched Box] LANDLOCKED (NO ACCESS PROVIDED)


CRAWFORD CO.
 JENNINGS TWP.
 HARRISON CO.
 SPENCER TWP.

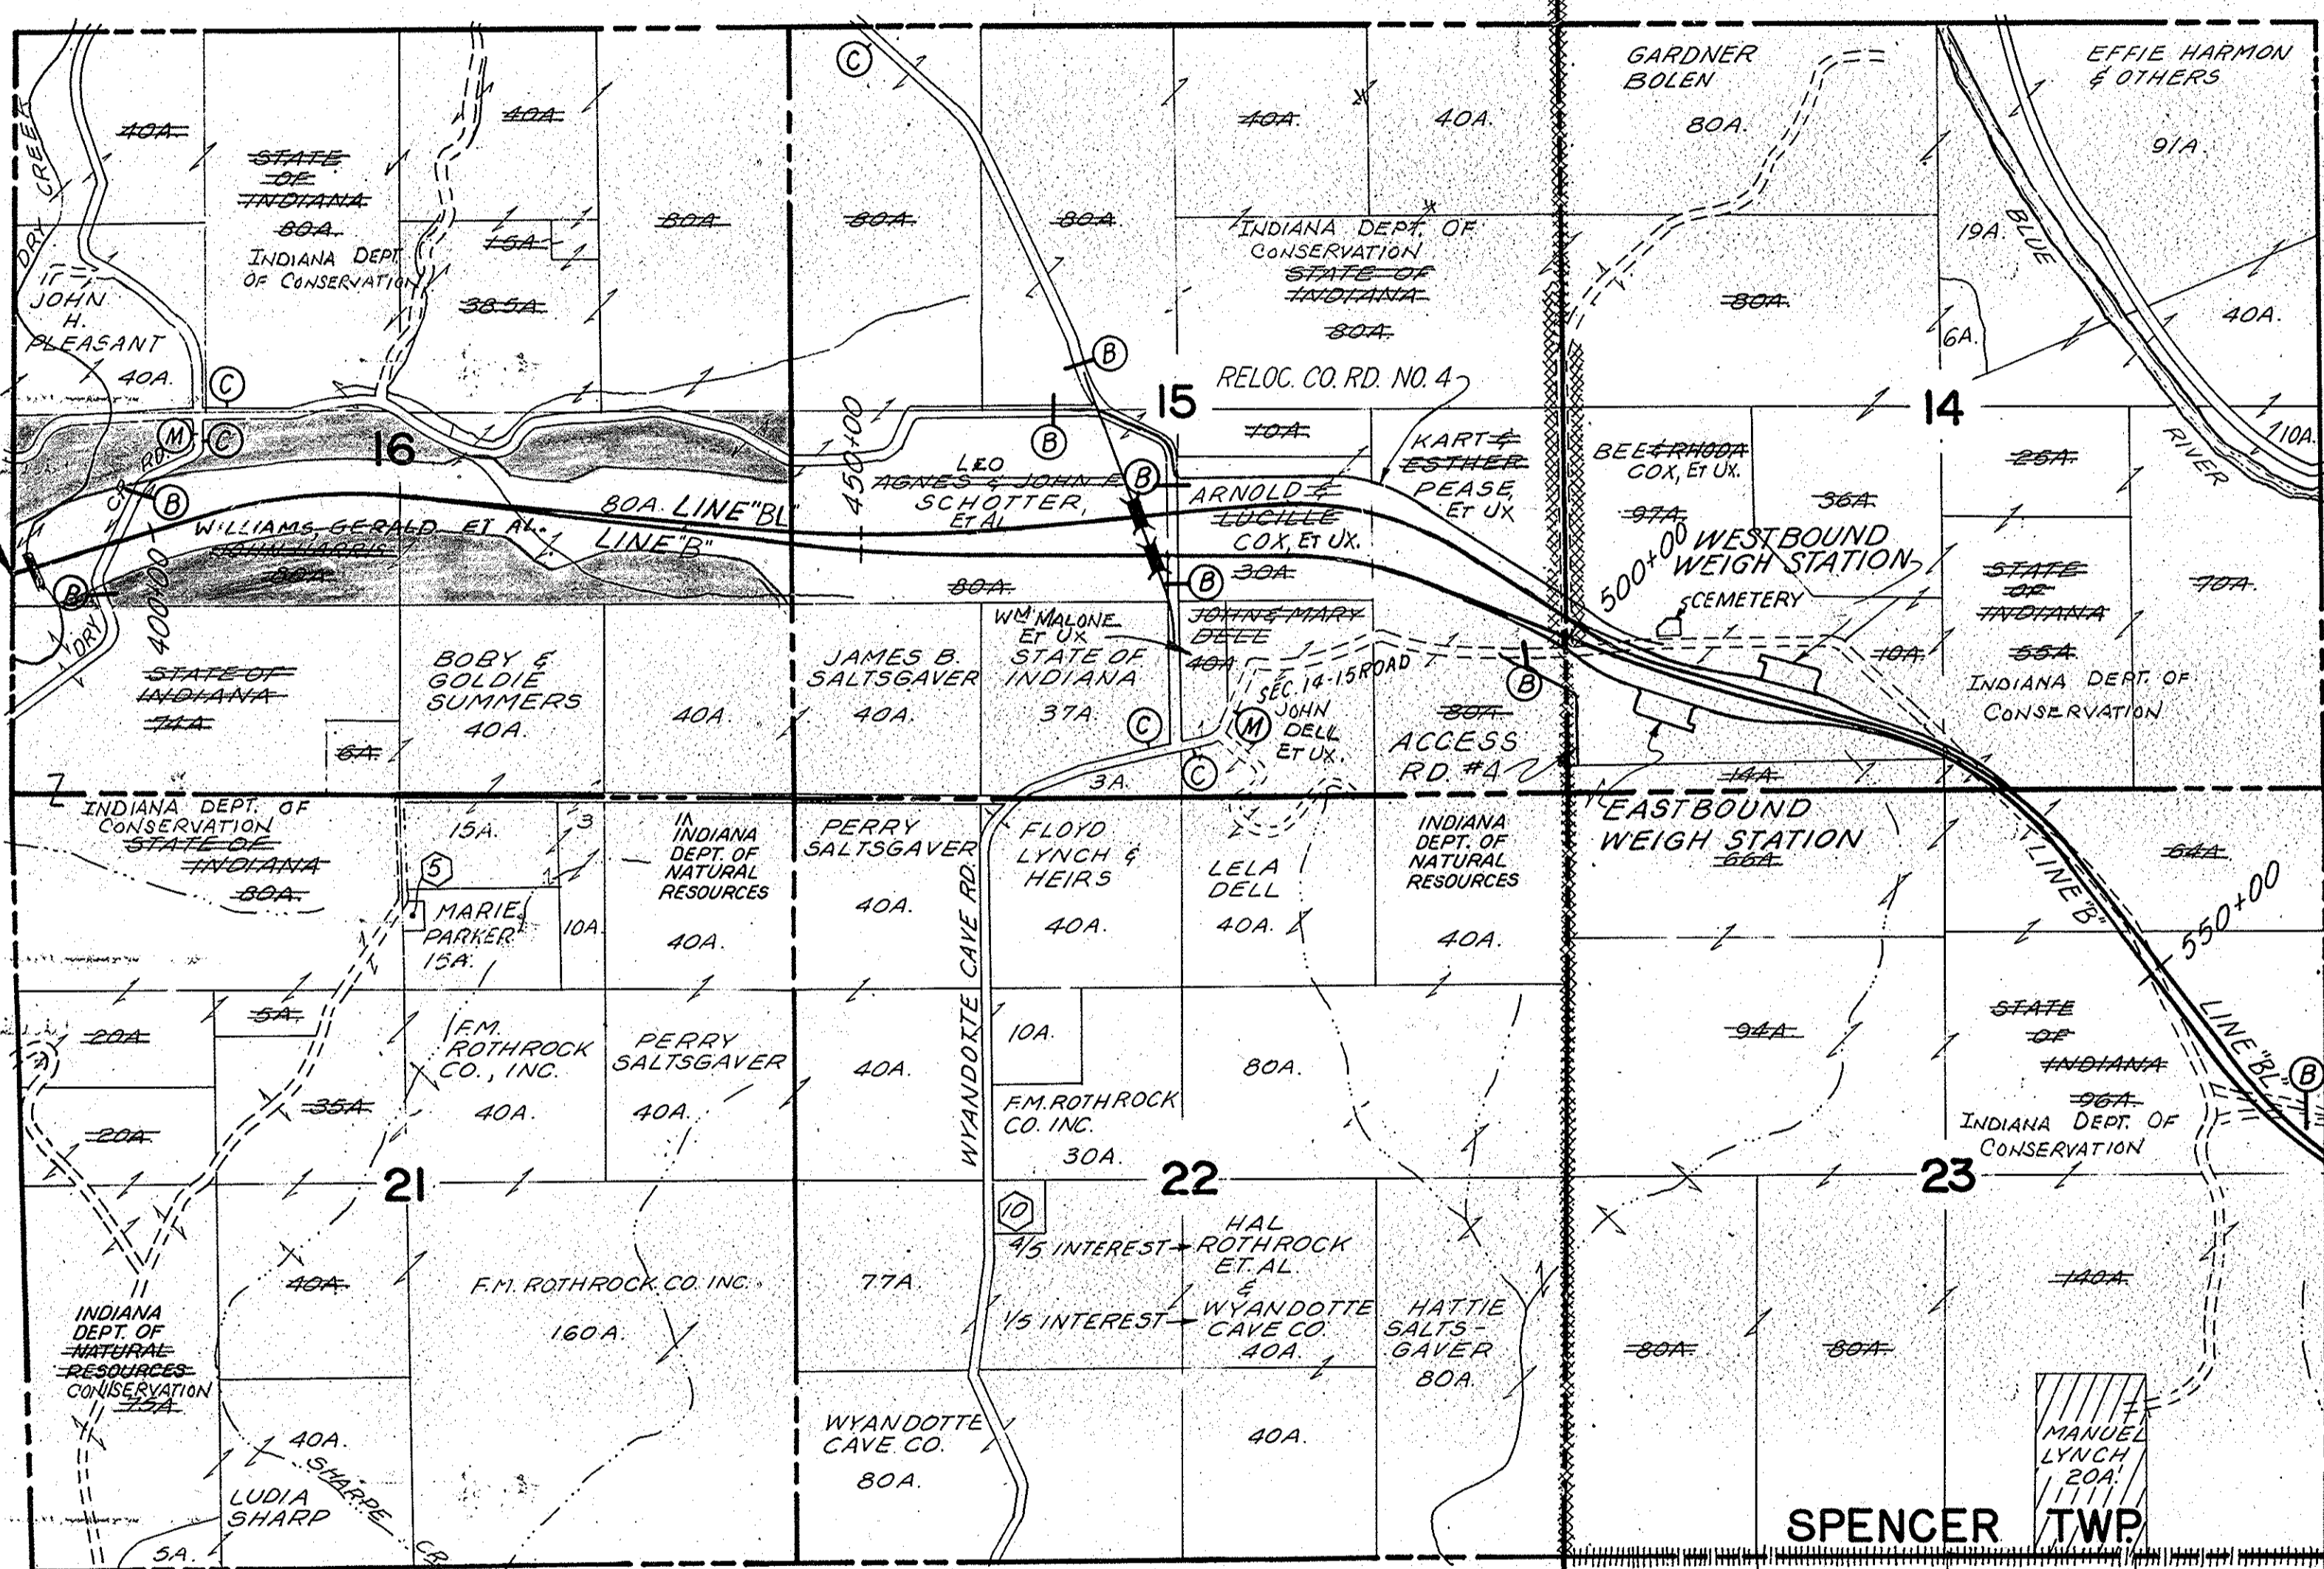

END I04(b)5 SECTION A14.4.1 - A14.4.2
 BEGIN I04(b)5 SECTION A14.4.2 - A14.5

STA 567+00.00 "B" BACK - STA 566+99.05 "B" AHEAD
 STA 568+41.00 "B"


T. 3 S.

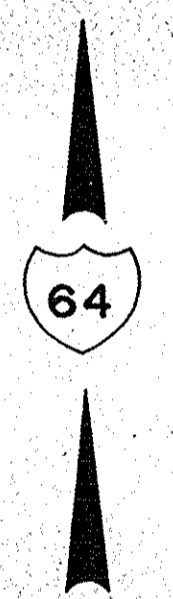

COUNTY	TOWNSHIP	SECTION	INDEX	OWNER	ACRES
CRAWFORD	JENNINGS	21	5	LOLA SIBERT	1
"	"	22	10	GARLAND SALTSGAVER	3
HARRISON	HARRISON	26	5	DOROTHY K. SMITH	3/8
"	"	"	6	MICHAEL MURPHY	1
"	"	"	9A	ROY & FRANCES RUSS	1
"	"	"	11	JAMES N. SIBERT	5

- (A) PERMANENT BARRICADE, TYPE A
- (A) BARRICADE, TYPE A
- (B) BARRICADE, TYPE B
- (C) TYPICAL SIGN STANDARD
- (D) CONSTRUCTION IDENTIFICATION SIGN
- (M) STANDARD SIGN M-29

1580 W. of SEC 2

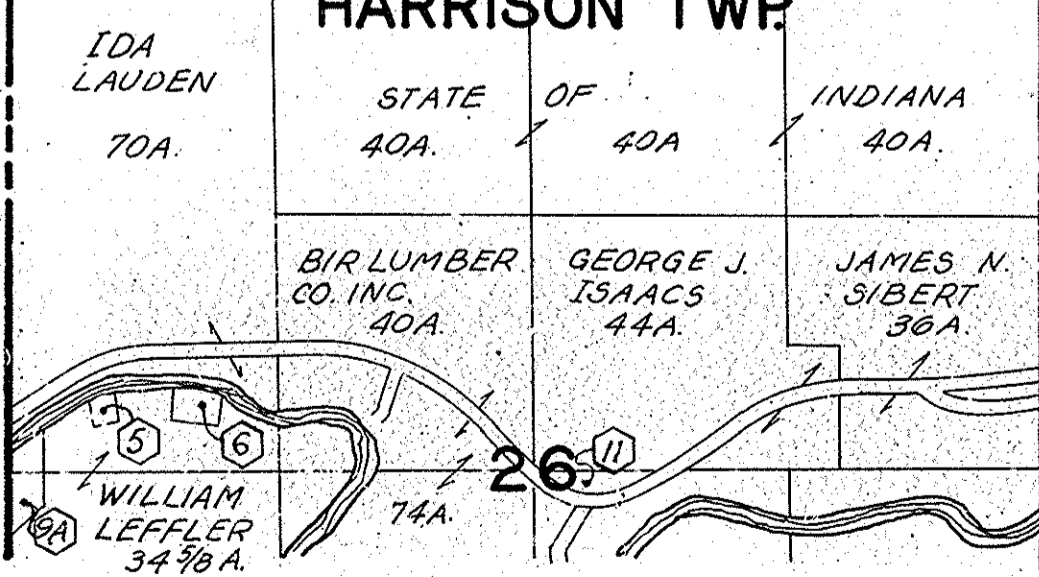

PROJECT 1-64-3(33)86 R/W
PLAT I
FOR ROAD DESIGN
 SCALE: 1" = 1000'



FIRST PHASE


FEDERAL ROAD REGION NO.	STATE	PROJECT NO.	FISCAL YEAR	SHEET NO.	TOTAL SHEETS
4	IND.	I-64-3(33)86	1967	35	

COUNTY	TOWNSHIP	SECTION	PARCEL	OWNER	ACRES
HARRISON	HARRISON	25	6	LAURA SIBERT	2.8
"	"	"	7	CEMETERY	UNKNOWN
"	"	"	8	LAURA SIBERT	0.5
"	"	"	9	JOS. & RUBY SIBERT	7.9
"	"	"	10	BLUE RIVER CHAPEL	UNKNOWN
"	"	"	11	JOS. & RUBY SIBERT	0.5
"	"	"	12	BENTLEY CONRAD	2.08
"	"	"	14A	BENTLEY CONRAD	1
"	"	"	15	OTNO HOBACK	1
"	"	"	26	THOMAS GRAFT	5.75
"	"	30	3	JULIUS ROTHROCK	1
"	"	"	4C	LENA ROTHROCK	0.6
"	"	"	6	RHEA ROTHROCK	1
"	"	"	7A	BLUE RIVER PARADISE SUBDIVISION	1
"	"	"	9	SCHOOL	1.5
"	"	"	10	JULIUS ROTHROCK	0.25
"	"	"	11	LENA ROTHROCK	0.25
"	"	"	12	VICTOR ROTHROCK	0.25
"	"	"	13	VICTOR ROTHROCK	1
"	"	"	26	DOROTHY K. SMITH	3/8
"	"	"	6	MICHAEL MURPHY	1
"	"	"	9A	ROY & FRANCES RUSS	1
"	"	"	11	JAMES N SIBERT	5

COUNTY	TOWNSHIP	SECTION	INDEX	OWNER	ACRES
HARRISON	SPENCER	13	5	ALVIN HARMON	0.5
"	"	"	5A	EDWARD LARBERG	0.5
"	"	"	5B	ANNA JACKSON	1
"	"	"	27	HOWARD JACOBS	1
"	"	"	28	EICHOLZ & RUSH	1
"	"	"	29	W.M. BYRANE	1
"	"	19	11	WILLIAM B. JAMES	1
"	"	"	2A	PHILLIP J. & WANDA L. HUGHES	1
"	"	"	3	DORA, JOAN & ROBERT HUGHES	1
"	"	"	5	HOWARD H. & BARBARA STREET	1
"	"	"	7	SCHOOL	1
"	"	"	11	EARL E. SAUERHEBER	1
"	"	"	13	HARRY SIBERT	17.50
"	"	"	14	ROY HUGHES	1.50
"	"	"	20	JULIUS ROTHROCK	1.95
"	"	"	21	ROBERT ROTHROCK	9.75
"	"	"	21A	FRANK ROTHROCK	3.25

LEGEND
 LANDLOCKED (NO ACCESS PROVIDED)

SPENCER TWP.
HARRISON TWP.

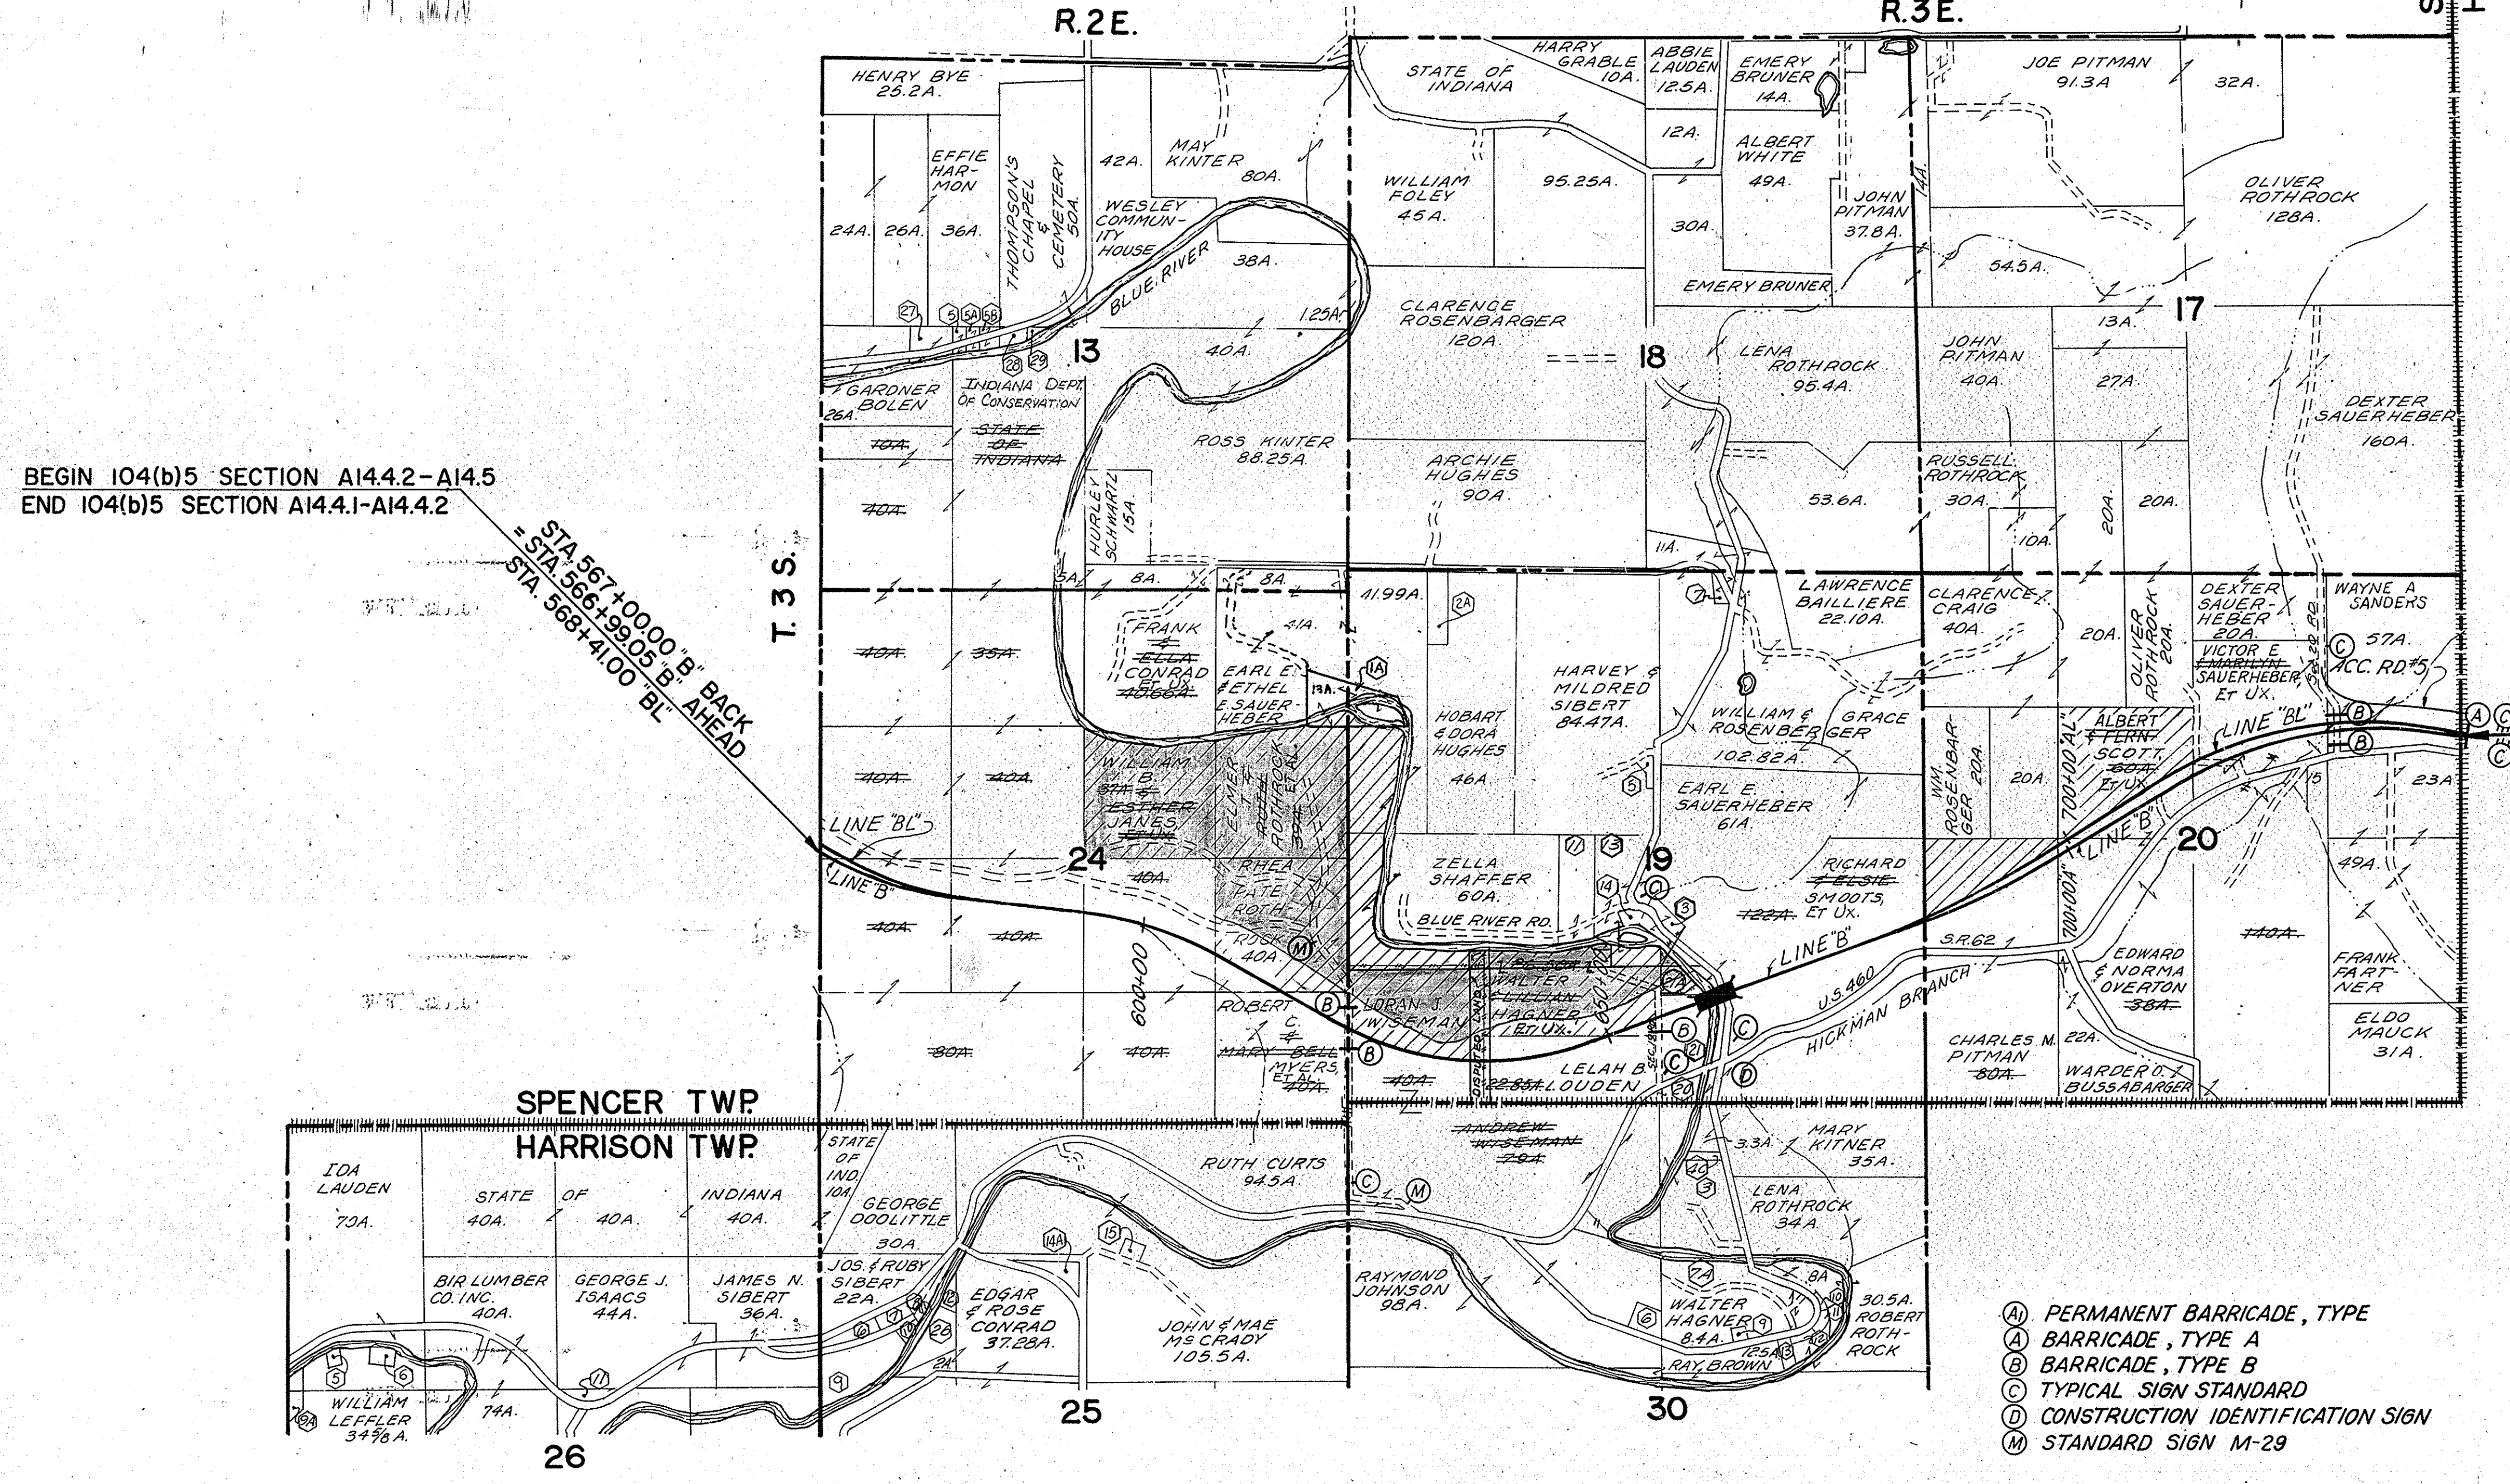

BEGIN I04(b)5 SECTION A14.2-A14.5
END I04(b)5 SECTION A14.4-A14.4.2


STA. 567+00.00 "B" BACK
= STA. 566+99.05 "B" AHEAD
= STA. 568+41.00 "BL"

(30)86 P.E.
(33)86 R/W
END PROJECT I-64-3
(40)93 GRADING
(41)93 PAVING
END I04(b)5 SECTION A14.2-A14.5
STA. 742+11.41 "B" BACK
STA. 742+70.00 "BL" BACK

(31)03 P.E.
(32)03 R/W
BEGIN PROJECT I-64-3
(34)03 GRADING
(35)03 PAVING
BEGIN I04(b)5 SECTION A14.5-A15.0.1
STA. 1122+38.11 "A" AHEAD
STA. 1122+32.11 "AL" AHEAD

- (A) PERMANENT BARRICADE, TYPE
- (A) BARRICADE, TYPE A
- (B) BARRICADE, TYPE B
- (C) TYPICAL SIGN STANDARD
- (D) CONSTRUCTION IDENTIFICATION SIGN
- (M) STANDARD SIGN M-29

PROJECT I-64-3(33)86 R/W
PLAT I
FOR ROAD DESIGN
SCALE: 1" = 1000'

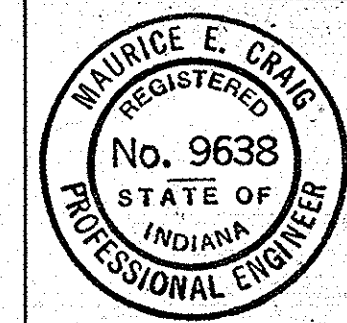

FIRST PHASE

HARRISON CO.

PROJECT NO.	LINE	SHEET NO.	TOTAL SHEETS	FILE
I-64-3(33)86		35		

PUBLIC UTILITY OWNERS

- 1. ELECTRIC SERVICE BY:**
Dubois Co. R.E.M.C.
Post Office Box 309
Jasper, Indiana
- 2. TELEPHONE SERVICE BY:**
Eureka Telephone Co.
Post Office Box 345
Corydon, Indiana

Harrison County R.E.M.C.
Corydon, Indiana

EXCESS LAND TRANSFERRED TO DEPARTMENT OF NATURAL RESOURCES AS PER DECLARATION OF DEPARTMENTAL TRANSFER OF REAL ESTATE DATED NOVEMBER 19, 1975.

Sec. 23, T3S, R1W
Union Twp.
Crawford County
Sta 2462+00 to Sta 482+30
Dr. 20 Ac. C=0.7

Bench Mark Post Req'd.
Station 480+00 "B"

FEDERAL ROAD DISTRICT NO.	STATE	PROJECT NO.	FISCAL YEAR	SHEET NO.	TOTAL SHEETS
4	IND.	I-64-3(33)86	1967	38	

By Waters Cem. added 7-31-69 S.M. Sharple
REV. 6-12-72 (Per 9.05) LOCATION OF "BY-WATERS CEMENTERY" STA. 472+50 ± "A"
Monument Type "D" Req'd.
42' Rt. of RT. Sta. 486+48.00 "A"

PARCEL 52 ON PROJECT I-64-3(33) AND PARCEL 42 ON PROJECT I-64-2(10) COVER THE SAME LAND, WITH ACQUISITION THEREOF ENTIRELY UNDER SAID PROJECT I-64-2(10)

BEGIN PROJ. I-64-3(33) 86
STA. 2463+00.00 LINE "A" Ahd.
END PROJ. I-64-3(33) 86
STA. 2463+00.00 LINE "A" Back

LEGEND

- L.A.R/W..... Limited Access Right-of-Way
- A.C.L..... Access Control Line
- R/W..... Right-of-Way
- F.F.T.F..... Form Field Type Fence
- R.W.M..... Right-of-Way Marker
- A.S.B.W..... A Strand Barbed Wire

LEVEL EQUATION:

B.M.#1(Ahead) LINE "A" Proj. I-64-3(33)86 Elev. 622.19
= B.M.#1(Back) LINE "A" Proj. I-64-3(33)86 Elev. 622.20

GENERAL NOTES

Standard Divided Lane Sections for Federal Aid Interstate Projects adopted May 1964 as shown on sheet N-1 to be used on this project except Subbase shall be Type II only.

Standard Pavement Section E-11-JR Revised 8-11-67 as shown on sheet N-1 to be used on this project. Typical Cross Sections as shown on sheets N-2 to be used on this project.

Indiana State Highway Commission Standard Specifications dated 1963 to be used with this project.

Standard under dates as listed in the Index on the Title Sheet to be used on this project.

Grade Line as shown on profile represents top of Finished Surface as per plans.

The Contractor must check the plan quantities of Subbase as given on the Estimate of Quantities Sheet. (See Special Provisions.)

A Keyway Joint is to be constructed on Median side of each pavement.

All Ditches of 1% grade and over shall be sodded except where ditch is in Rock cut or where Paved Side Ditch is to be constructed.

All Earth Shoulders, Cut and Fill slopes shall be plain or mulched sodded except where sodding is specified.

Sodding shall be placed along Paved Side Ditch as shown on Misc. Standard Sheet "B".

Excavation Quantities as shown on Plan and Profile sheets include estimated excavation for Public and Private Approaches. (See Table on Sheet N-148)

Curves on Mainline shall be Super-elevated as shown on Sheet N-139 & 140.

Curves on Relocated Middle Road and Reloc. Coll. Rd. N-21 shall be Super-elevated as shown on sheets N-142 & 144.

Quantities for Pipe Culvert Headwalls are based on using Standard Headwalls for retaining 2:1 or 3:1 slopes, and Private Drive Headwalls for retaining 4:1 or flatter slopes.

For "Kinds of Pipe" permitted for each size and classification as shown on the Structure Data Sheet, see Misc. Standard Sheet "P".

All Limited Access R/W (L.A.R/W) to be fenced with Form Field Type Fence (F.F.T.F.) or A Strand Barbed Wire (A.S.B.W.) as specified in the plans.



The minimum grade for Subsurface Drains shall be 0.20% where the profile grade is less than 0.20%, special grades for Subsurface Drains shall be established by the Engineer.

The Final Cross Sections of the "Grading Contract" shall be the original Cross Sections of the "Paving Contract", except that partial or complete cross sections shall be taken if necessary to determine the actual quantities of Excavation.

Contractor shall establish rock or shale line of top bench prior to Project Engineer establishing final slope stakes.

CURVE NO. 19 LINE "A"
Δ = 25°11'00" Rt.
D = 1°40'00"
R = 3437.75'
T = 767.90'
L = 1511.00'
E = 84.72'
Rate of Super-elev. = 0.042'/ft.

SUBJECT TO A BLANKET EASEMENT FOR R/W IN FAVOR OF INDIANA STATE-WIDE RURAL ELECTRIC COOR. INC. For Plan & Profile of Line "AL" See Sheet N-39

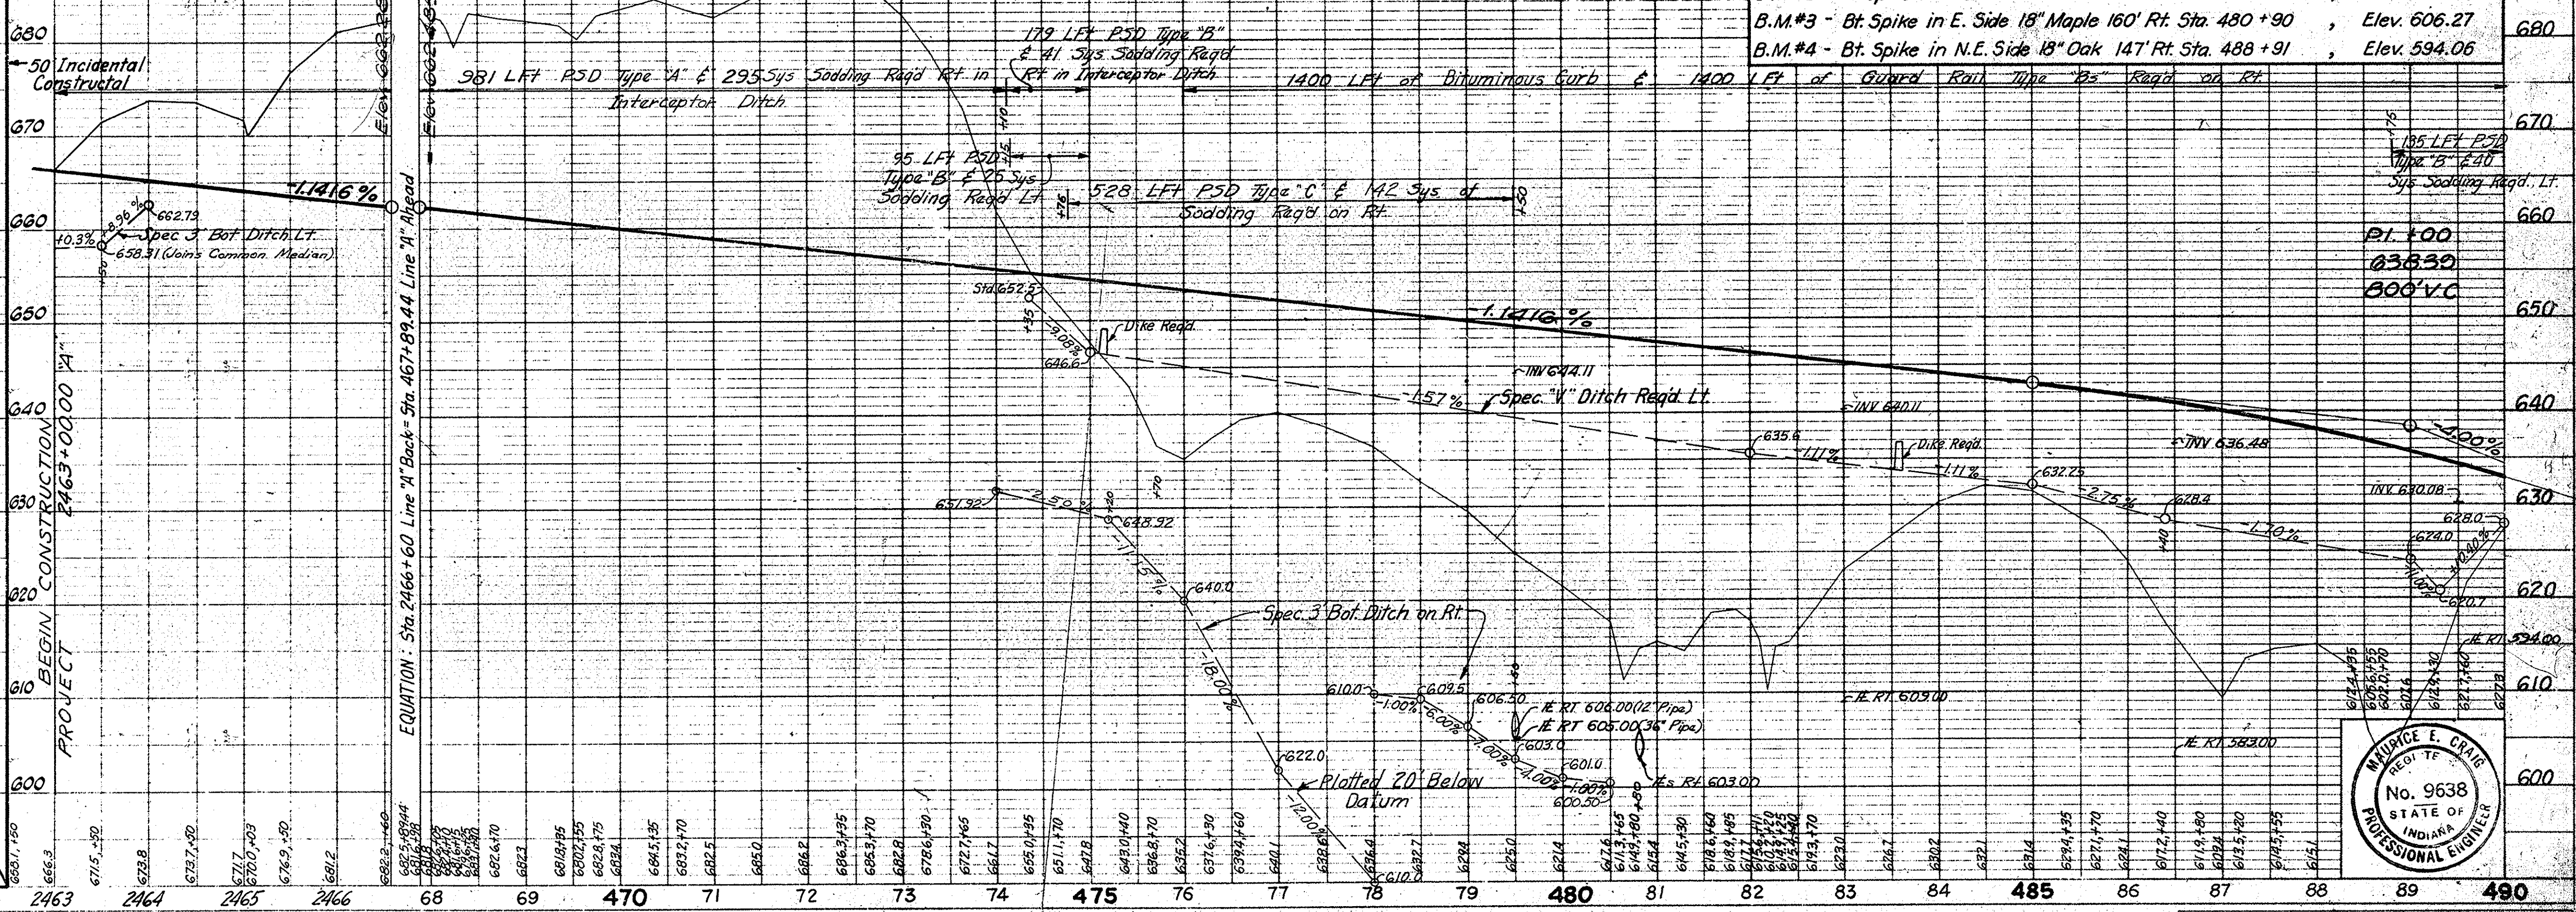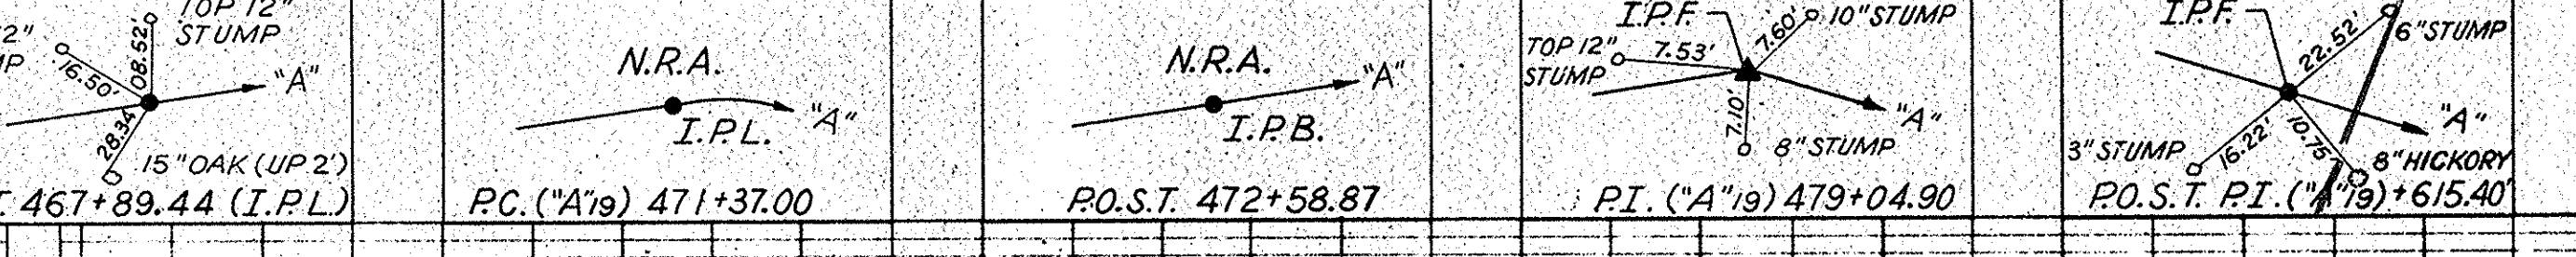

B.M.#1 - Bt. Spike in E. Side 12" Maple 230' Rt. Sta. 2465+15 Line "A", Elev. 699.19	
B.M.#2 - Bt. Spike in E. Side 18" Oak 190' Rt. Sta. 475+97, Elev. 643.70	
B.M.#3 - Bt. Spike in E. Side 18" Maple 160' Rt. Sta. 480+90, Elev. 606.27	
B.M.#4 - Bt. Spike in N.E. Side 18" Oak 147' Rt. Sta. 488+91, Elev. 594.06	


MILWAUKEE E. ORTIG
REG. P.E.
No. 9638
STATE OF INDIANA
PROFESSIONAL ENGINEER

PROJECT NO.	LINE	SHEET NO.	TOTAL SHEETS	FILE
I-64-3(33)86	A	38		


PUBLIC UTILITY OWNERS

TELEPHONE SERVICE BY:
Eureka Telephone Co.
P.O. Box 345
Corydon, Indiana

ELECTRIC SERVICE BY:
Dubois R.E.M.C.
P.O. Box 309
Jasper, Indiana

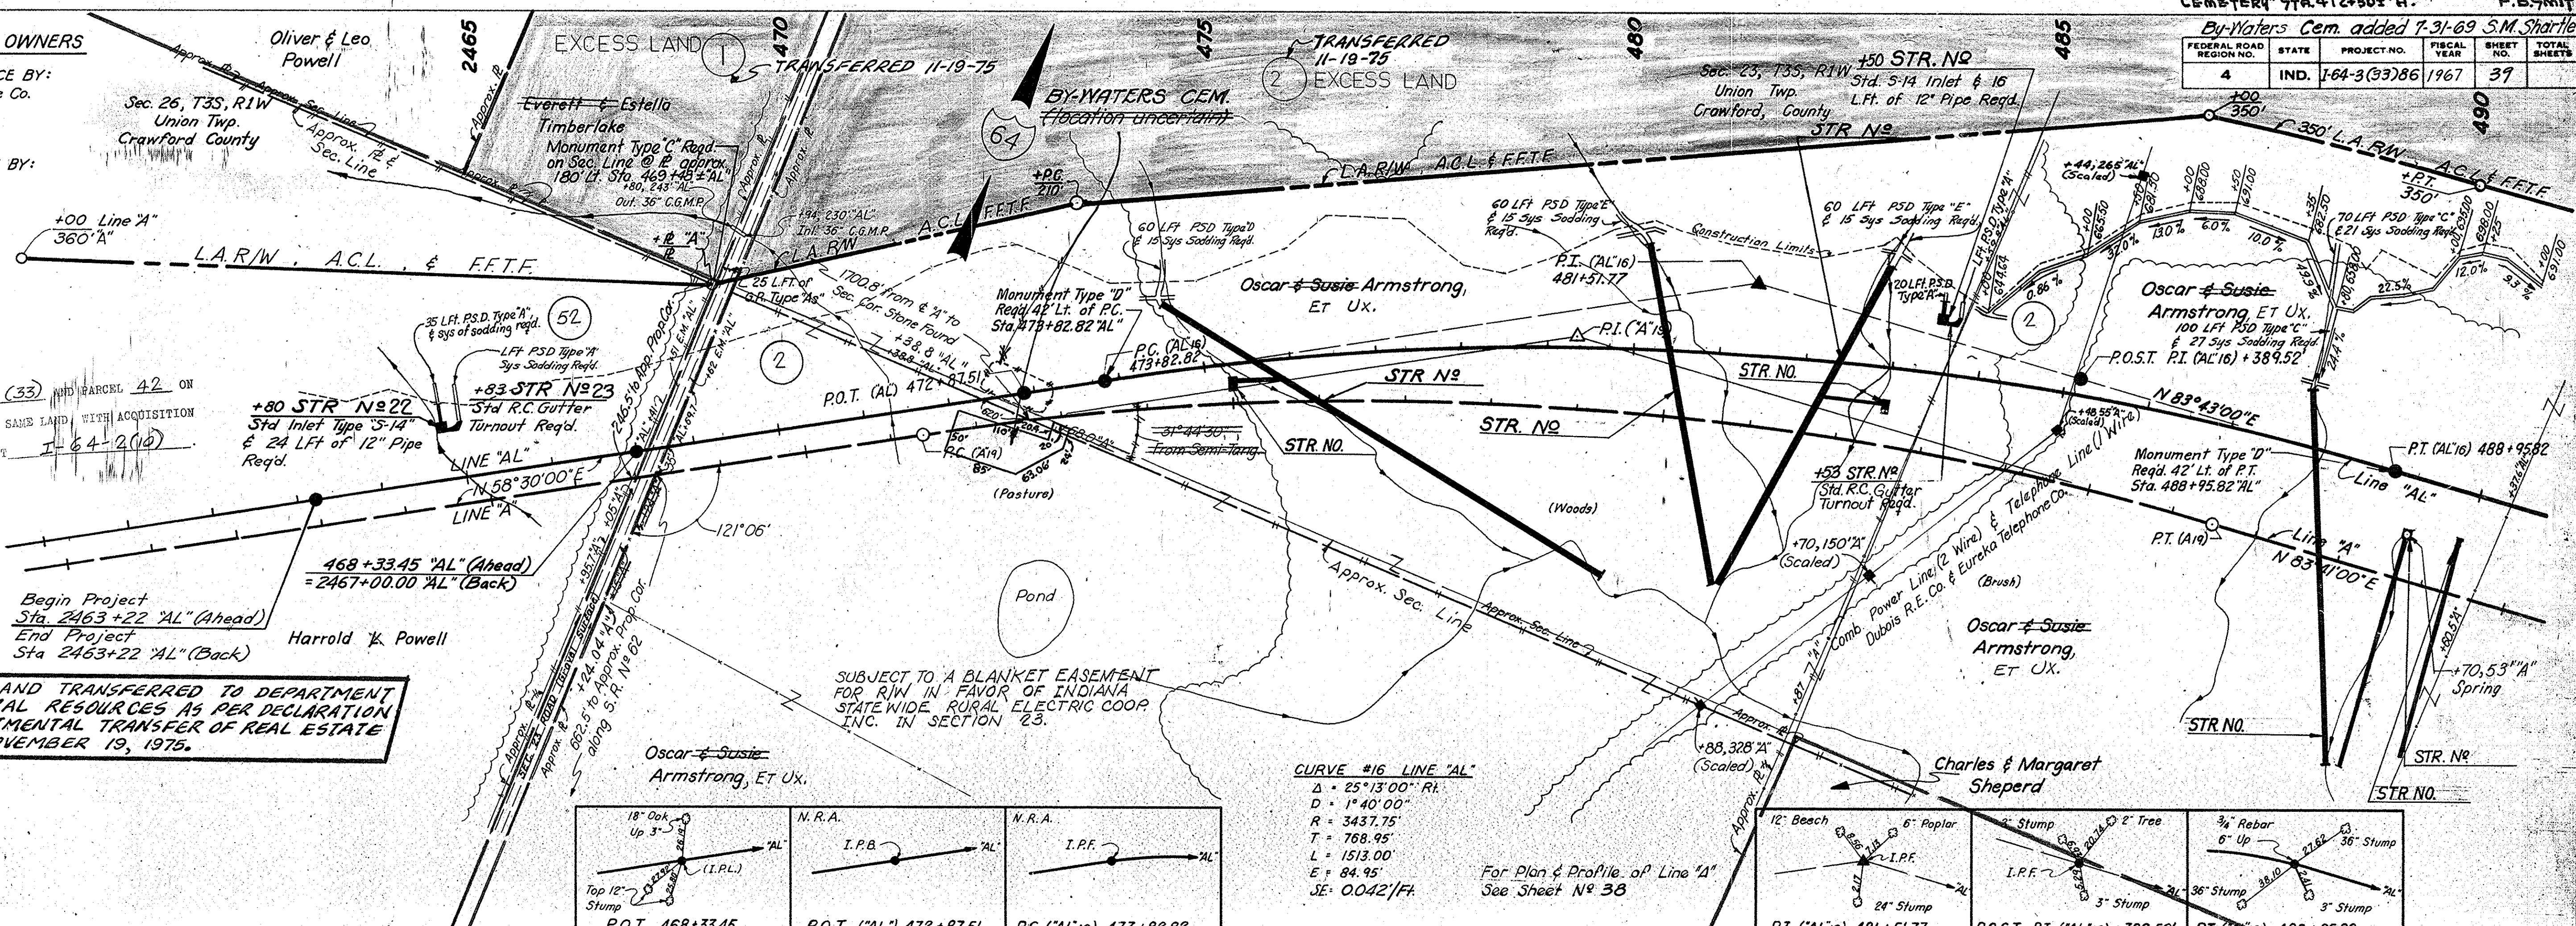

EXCESS LAND TRANSFERRED TO DEPARTMENT OF NATURAL RESOURCES AS PER DECLARATION OF DEPARTMENTAL TRANSFER OF REAL ESTATE DATED NOVEMBER 19, 1975.

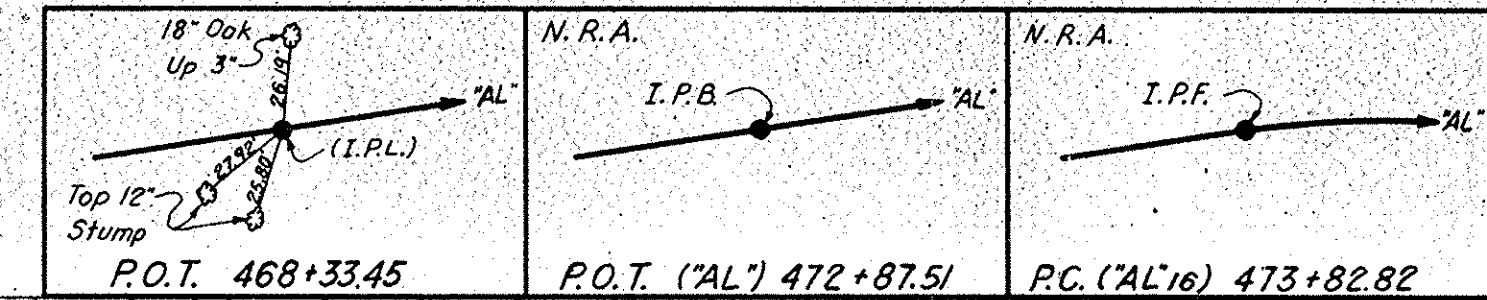

CURVE #16 LINE 'A'
Δ = 25°13'00" R.
D = 1°40'00"
R = 3437.75'
T = 768.95'
L = 1513.00'
E = 84.95'
SE = 0042/FT

For Plan & Profile of Line 'A'
See Sheet No. 38


PARCEL 52 ON PROJECT I-64-3(33) AND PARCEL 42 ON PROJECT I-64-2(10) COVER THE SAME LAND WITH ACQUISITION THEREOF ENTIRELY UNDER SAID PROJECT I-64-2(10)

Begin Project Sta. 2463+22 'AL' (Ahead)
End Project Sta. 2463+22 'AL' (Back)

PLAN

DATE	11-16-66
BY	G.H.C.
CHECKED	G.H.C.
DATE	11-16-66
BY	G.H.C.
CHECKED	G.H.C.

FOR GENERAL NOTES SEE SHEET NO. 38

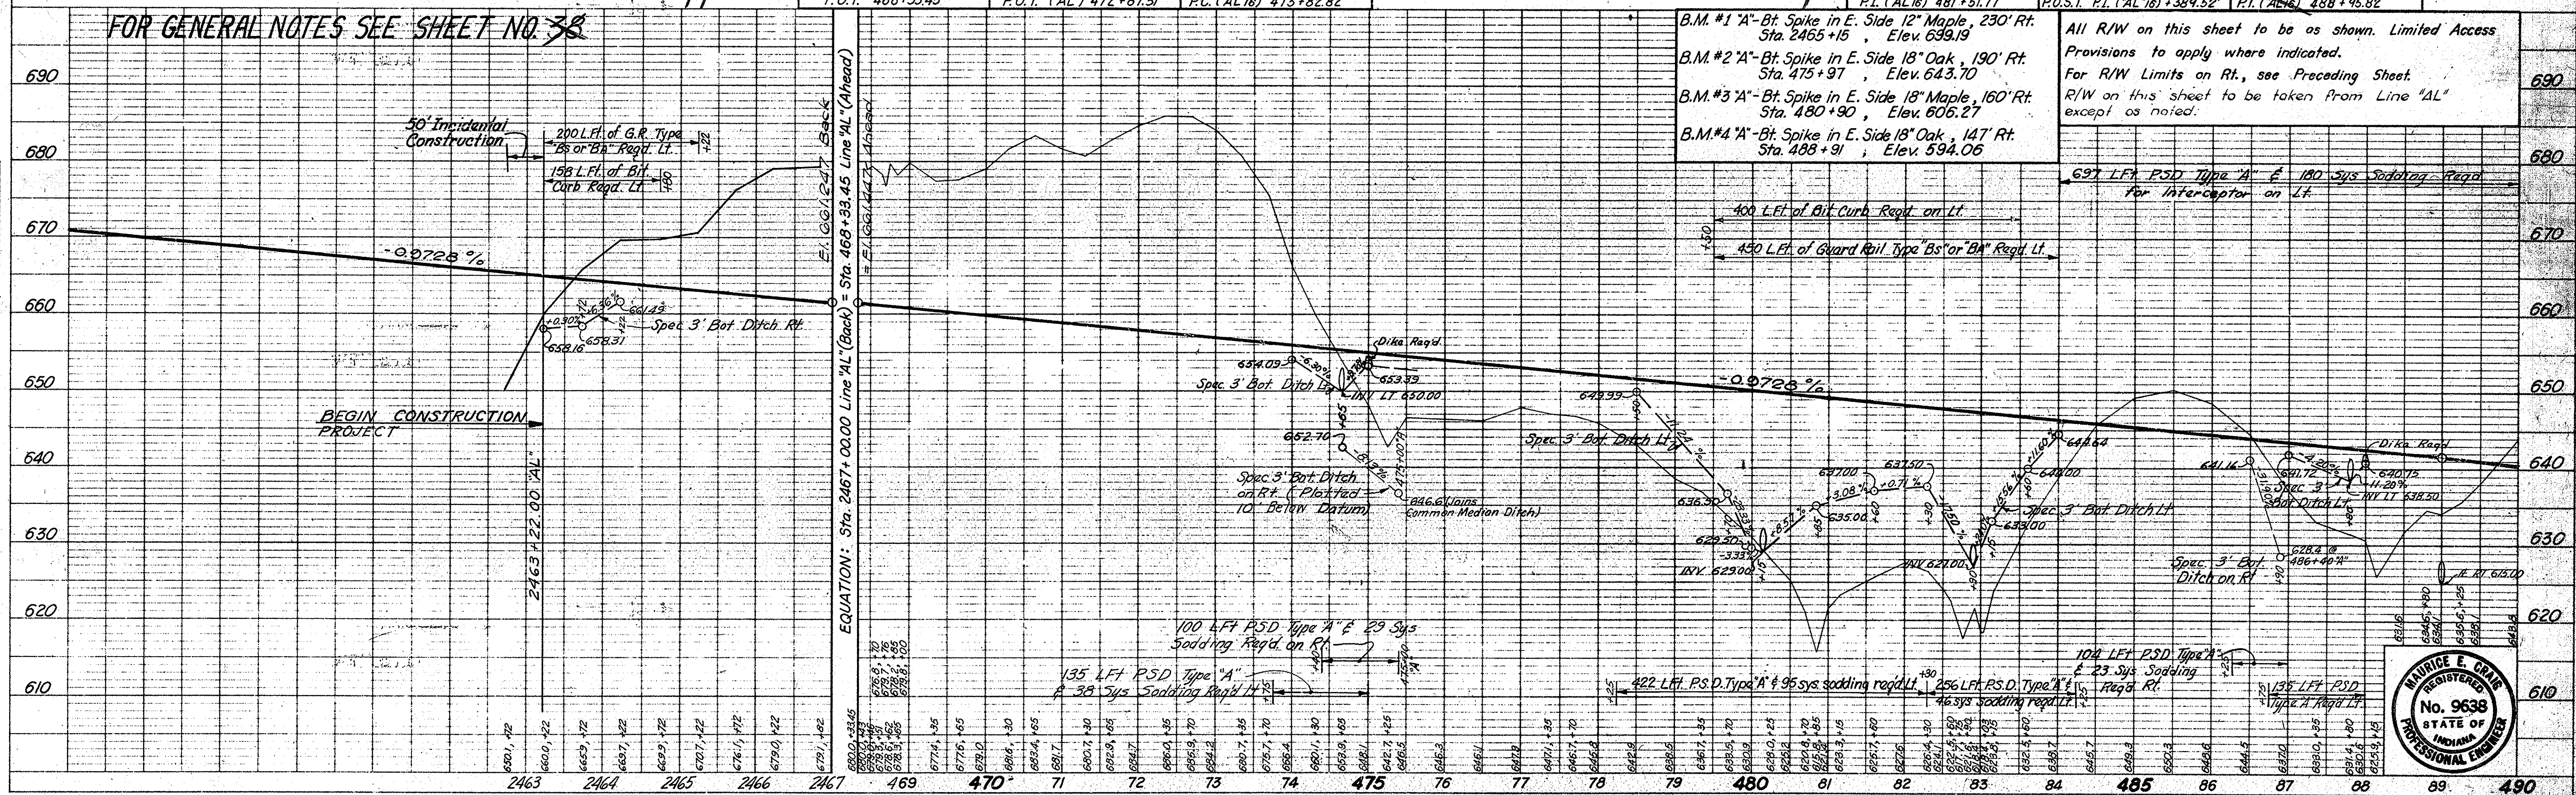


- B.M. #1 'A'-Bt. Spike in E. Side 12' Maple, 230' Rt. Sta. 2465+15, Elev. 639.19
- B.M. #2 'A'-Bt. Spike in E. Side 18" Oak, 190' Rt. Sta. 475+97, Elev. 643.70
- B.M. #3 'A'-Bt. Spike in E. Side 18" Maple, 160' Rt. Sta. 480+90, Elev. 606.27
- B.M. #4 'A'-Bt. Spike in E. Side 18" Oak, 147' Rt. Sta. 488+91, Elev. 594.06

All R/W on this sheet to be as shown. Limited Access Provisions to apply where indicated. For R/W Limits on Rt., see Preceding Sheet. R/W on this sheet to be taken from Line 'AL' except as noted.

PROFILE


DATE	11-16-66
BY	G.H.C.
CHECKED	G.H.C.
DATE	11-16-66
BY	G.H.C.
CHECKED	G.H.C.

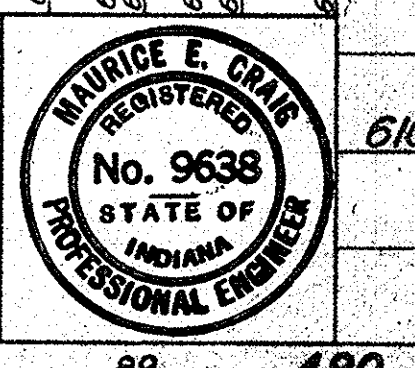

FEDERAL ROAD REGION NO.	STATE	PROJECT NO.	FISCAL YEAR	SHEET NO.	TOTAL SHEETS
4	IND.	164-3(33)86	1967	40	

DATE: 1-19-69
 SURVEYED BY: G.M. JAW
 CHECKED BY: G.M. JAW
 NO. 9325 L. STRUCTURE NOTATIONS CHECKED: D.B.


DATE: 1-19-69
 SURVEYED BY: G.M. JAW
 CHECKED BY: G.M. JAW
 NO. 9325 L. STRUCTURE NOTATIONS CHECKED: D.B.

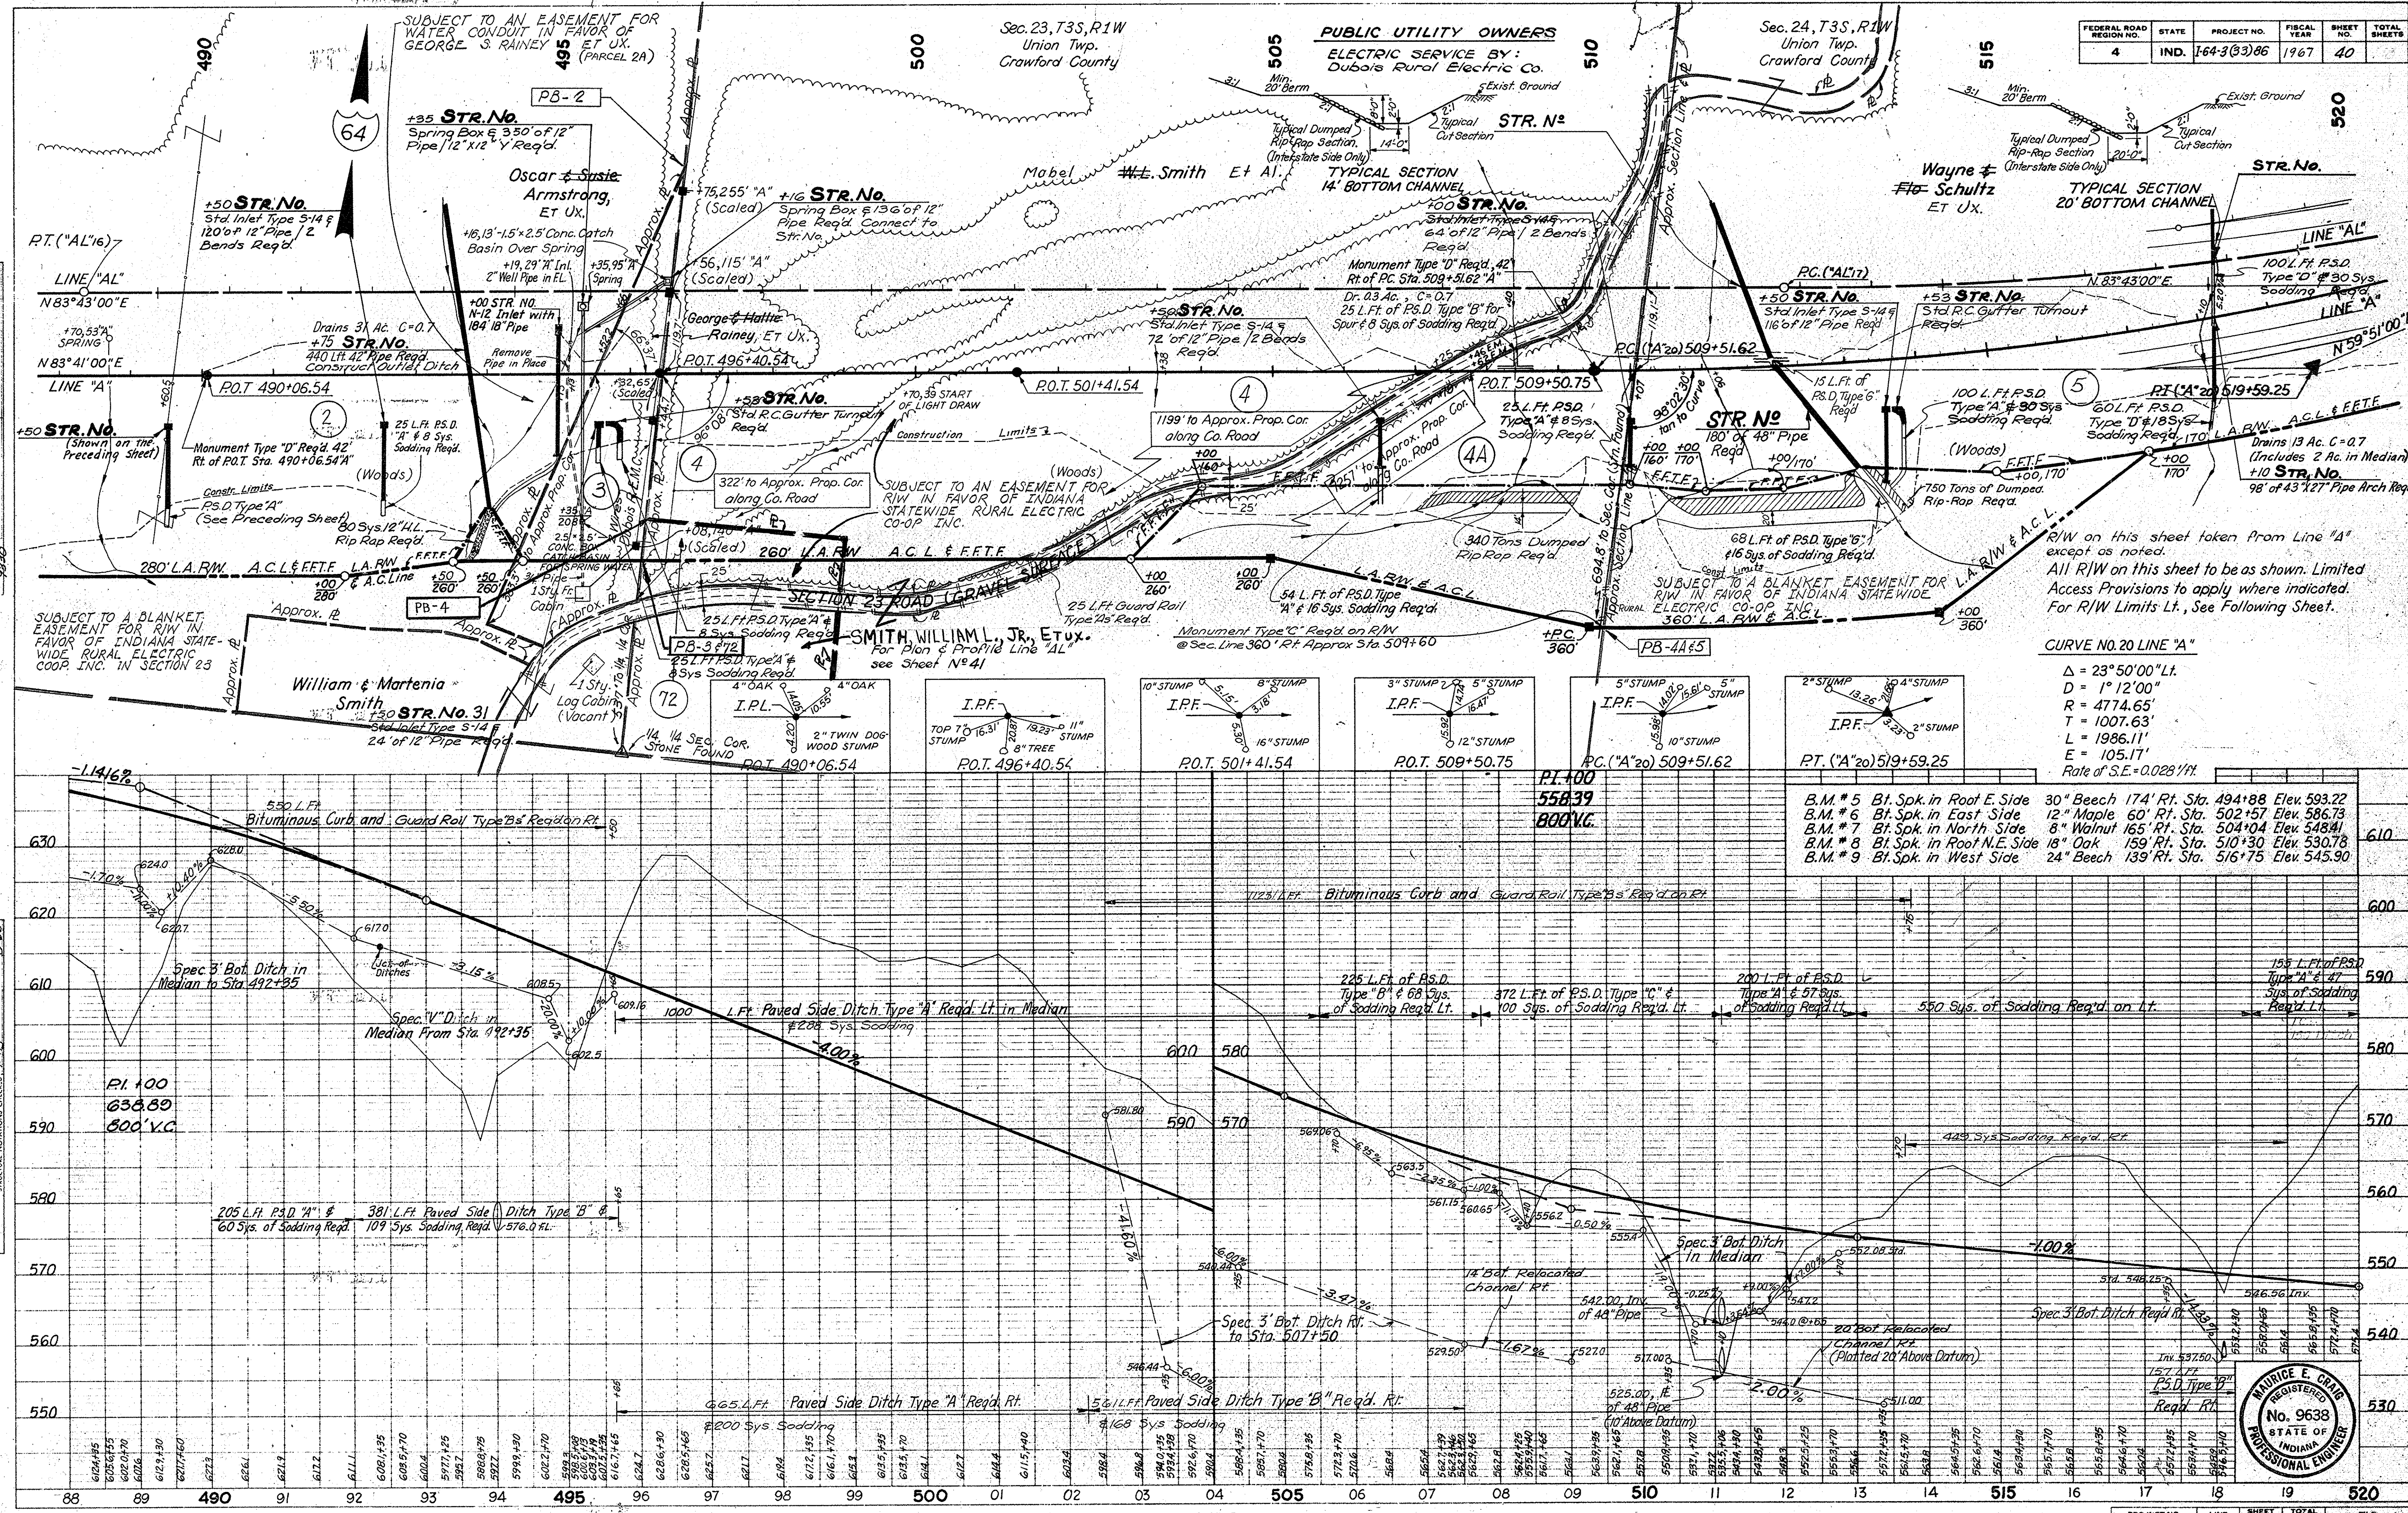

R/W on this sheet taken from Line "A" except as noted.
 All R/W on this sheet to be as shown. Limited Access Provisions to apply where indicated. For R/W Limits Lt., See Following Sheet.

CURVE NO. 20 LINE "A"
 $\Delta = 23^{\circ}50'00''$ L.T.
 $D = 1^{\circ}12'00''$
 $R = 4774.65'$
 $T = 1007.63'$
 $L = 1986.11'$
 $E = 105.17'$
 Rate of S.E. = 0.028 1/11

- B.M. # 5 Bl. Spk. in Root E. Side 30" Beech 174' Rt. Sta. 494+88 Elev. 593.22
- B.M. # 6 Bl. Spk. in East Side 12" Maple 60' Rt. Sta. 502+57 Elev. 586.73
- B.M. # 7 Bl. Spk. in North Side 8" Walnut 165' Rt. Sta. 504+04 Elev. 548.41
- B.M. # 8 Bl. Spk. in Root N.E. Side 18" Oak 159' Rt. Sta. 510+30 Elev. 530.78
- B.M. # 9 Bl. Spk. in West Side 24" Beech 139' Rt. Sta. 516+75 Elev. 545.90

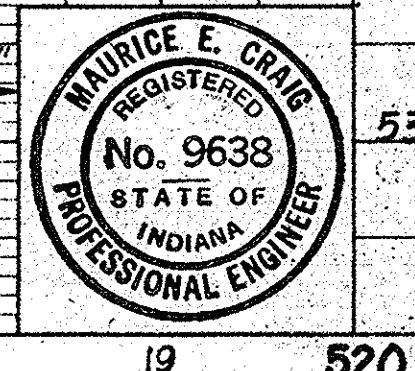

PROJECT NO.	LINE	SHEET NO.	TOTAL SHEETS	FILE
164-3(33)86	A	40		




FEDERAL ROAD REGION NO.	STATE	PROJECT NO.	FISCAL YEAR	SHEET NO.	TOTAL SHEETS
4	IND.	I-64-3(33)86	1967	41	(48)

PLAN

DATE: 1-5-66
 DRAWN BY: S.M. CLINE
 CHECKED BY: J.E. DICKSON
 NO. OF SHEETS: 41
 NO. OF SHEETS CHECKED: 41
 NO. OF SHEETS BY WAY CHECKED: 41


PROFILE

DATE: 1-5-66
 DRAWN BY: S.M. CLINE
 CHECKED BY: J.E. DICKSON
 NO. OF SHEETS: 41
 NO. OF SHEETS CHECKED: 41
 NO. OF SHEETS BY WAY CHECKED: 41

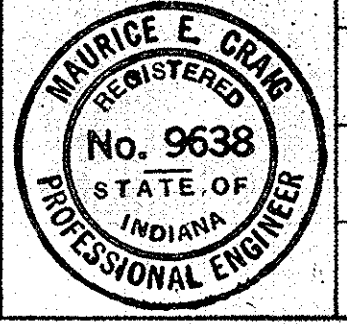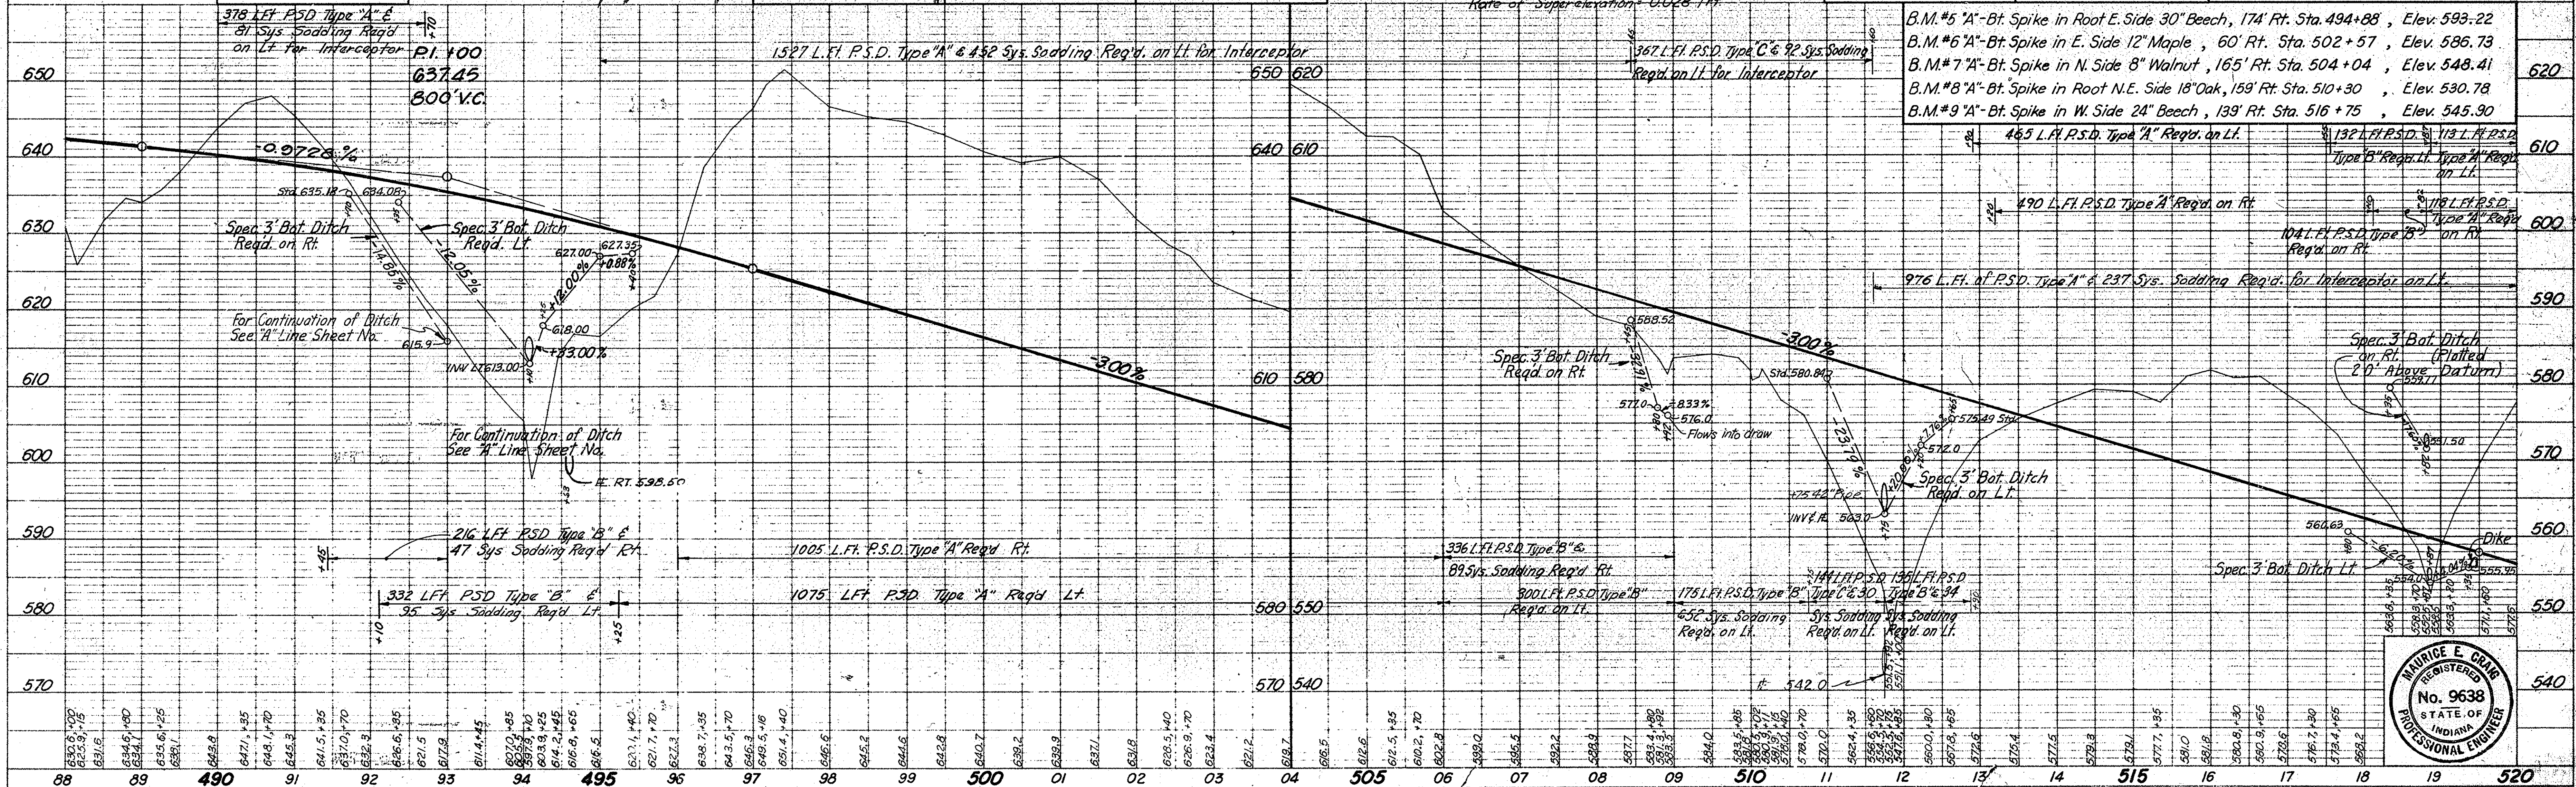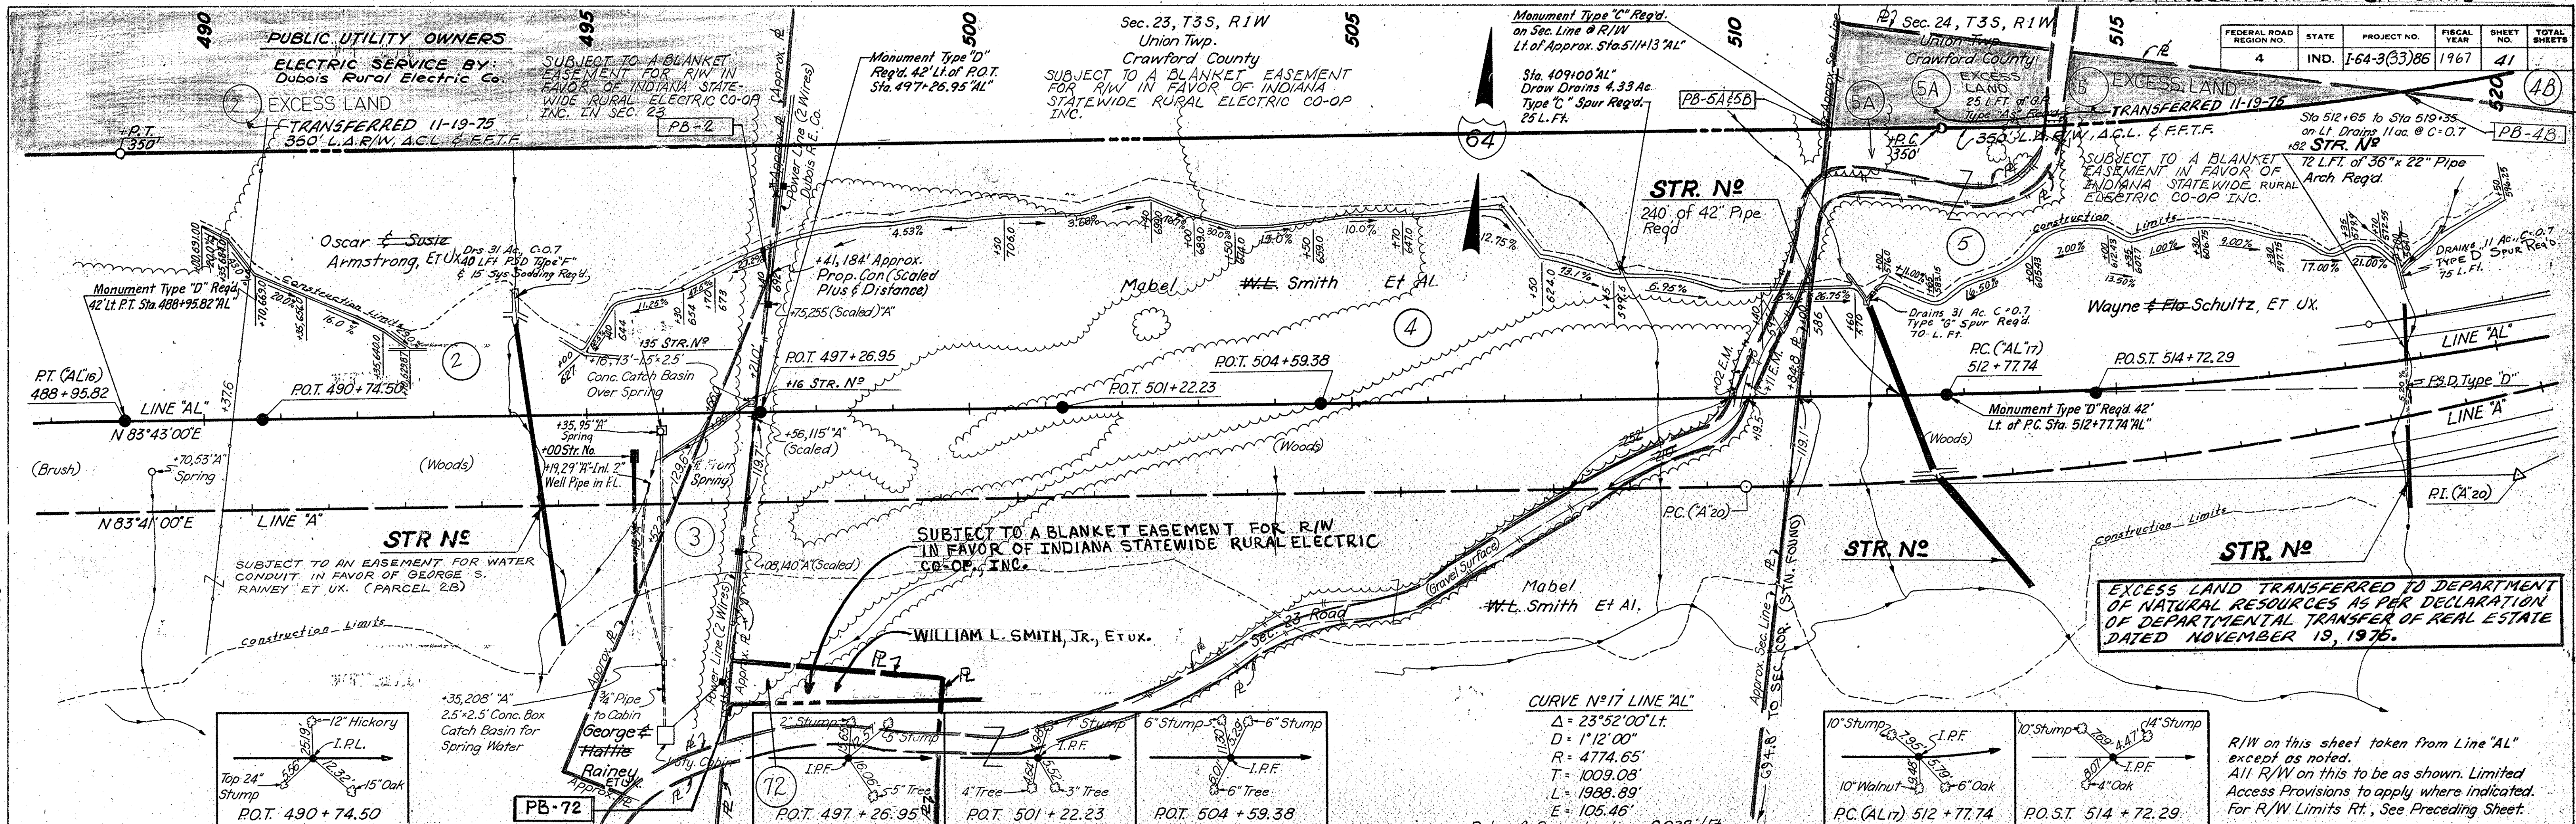

PROJECT NO.	LINE	SHEET NO.	TOTAL SHEETS	FILE
I-64-3(33)86	AL	41	(48)	

Sec. 24, T3S, R1W
Union Twp.
Crawford County

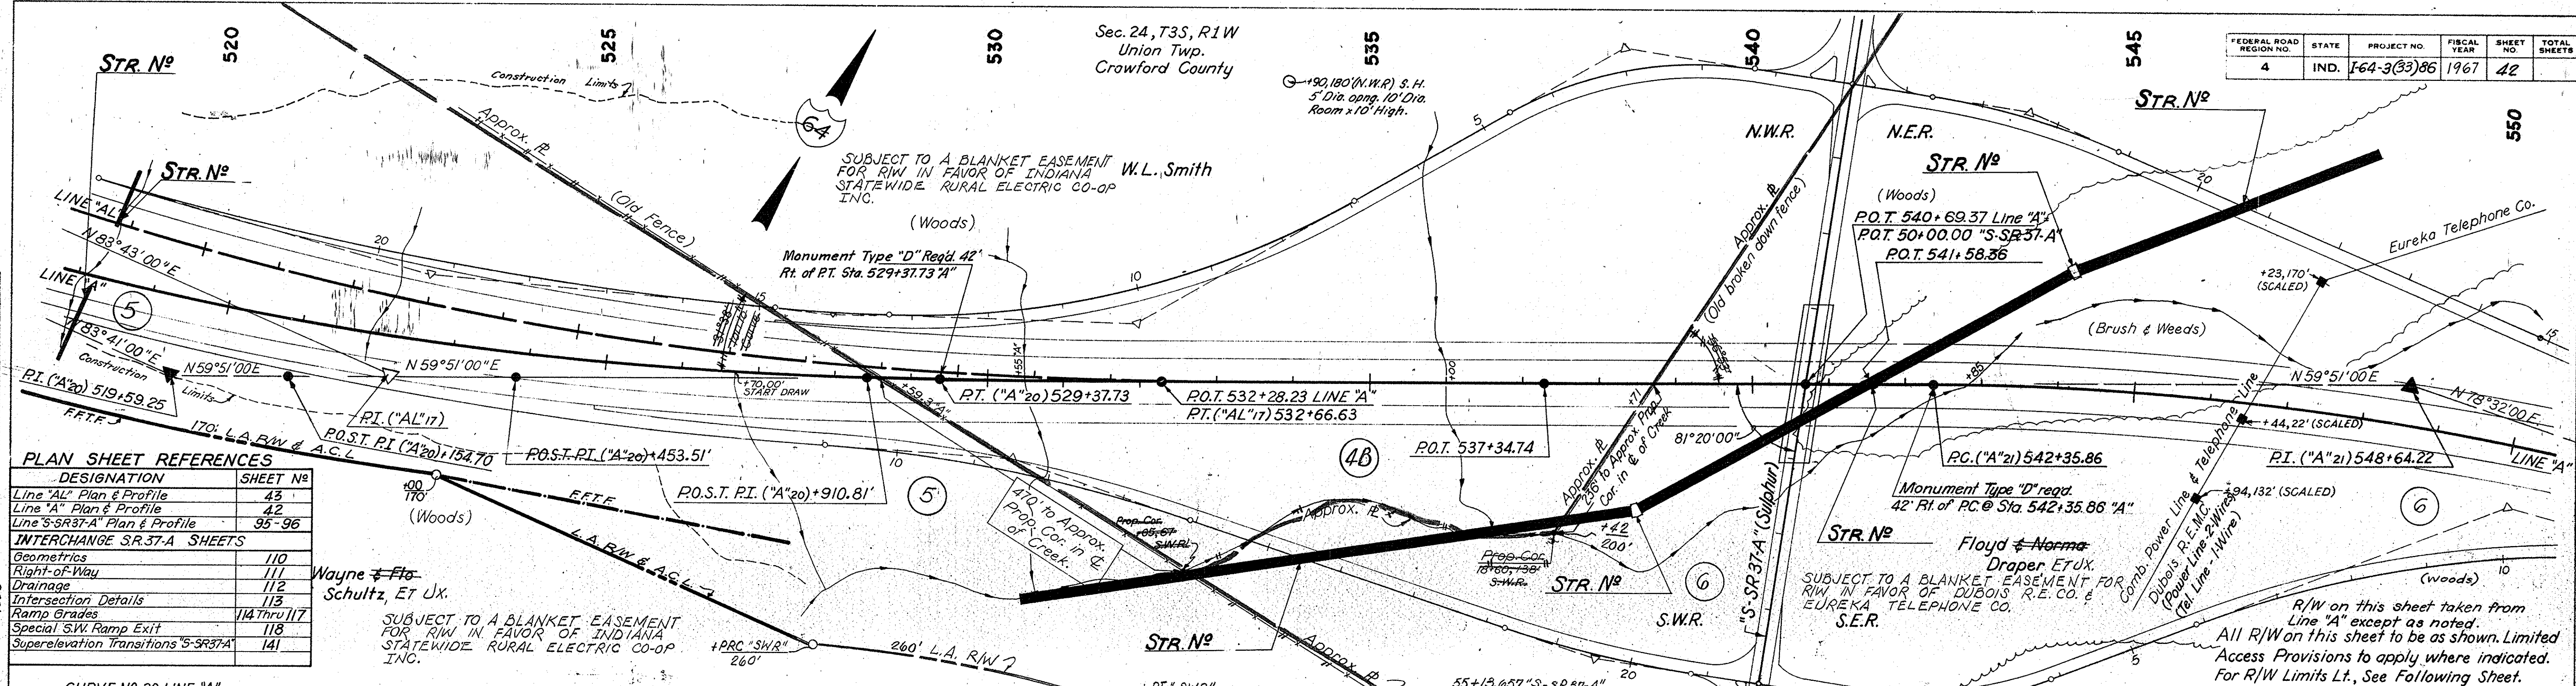

PLAN SHEET REFERENCES

DESIGNATION	SHEET NO.
Line 'AL' Plan & Profile	43
Line 'A' Plan & Profile	42
Line 'S-SR37-A' Plan & Profile	95-96

INTERCHANGE SR37-A SHEETS











Geometrics	110
Right-of-Way	111
Drainage	112
Intersection Details	113
Ramp Grades	114 Thru 117
Special S.W. Ramp Exit	118
Superelevation Transitions 'S-SR37-A'	141

PLAN

DATE	1-66
BY	L.S.H.C.
CHECKED	R.M.C.
DATE	2-66
BY	G.C.C.
CHECKED	R.D.L.
DATE	11-66
BY	
CHECKED	


CURVE NO. 20 LINE "A"

$\Delta = 23^{\circ}50'00''$ Lt.
 $D = 1^{\circ}12'00''$
 $R = 4774.65'$
 $T = 1007.63'$
 $L = 1986.11'$ Rate of S.E.
 $E = 105.17' = 0.028'/ft.$

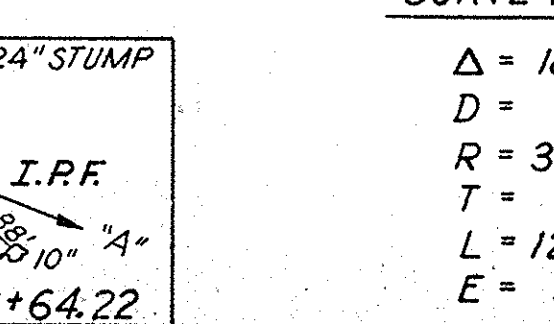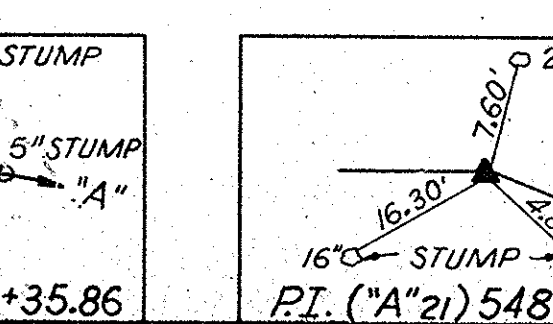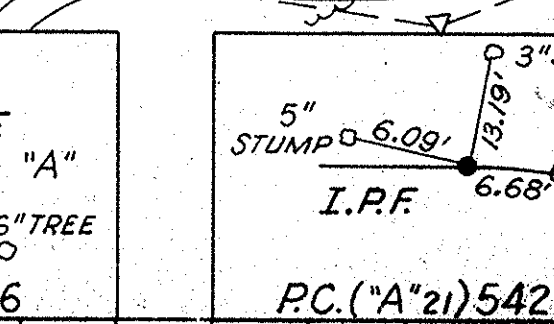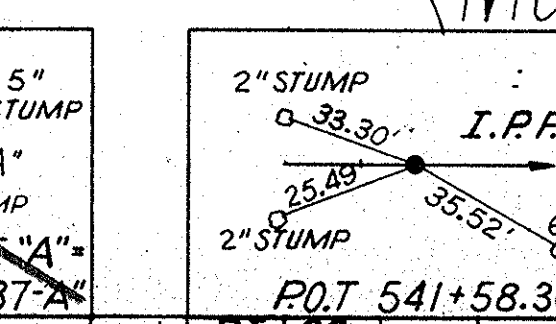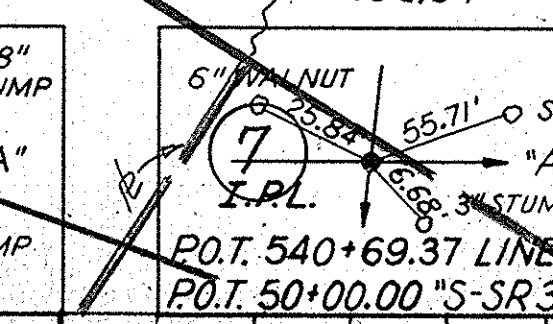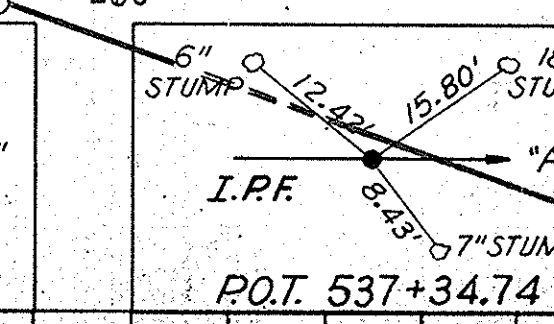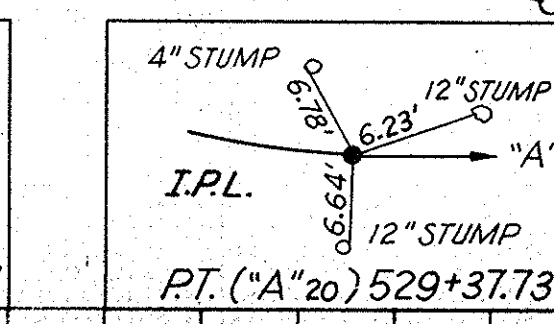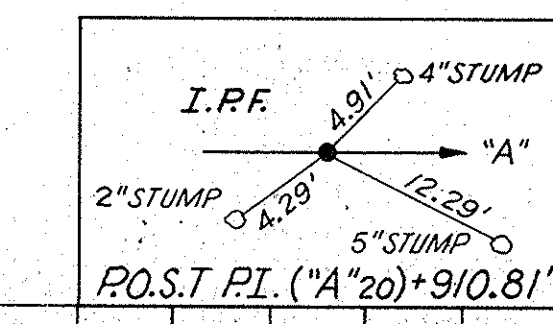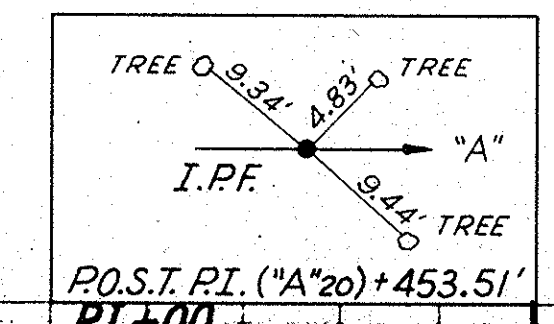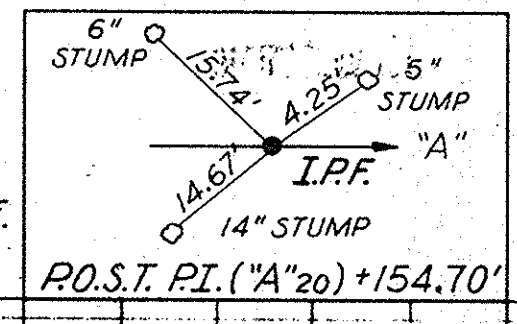

CURVE NO. 21 LINE "A"


$\Delta = 18^{\circ}41'00''$ Rt.
 $D = 1^{\circ}30'00''$
 $R = 3819.72'$
 $T = 628.36'$
 $L = 1245.56'$ Rate of S.E.
 $E = 51.34' = 0.042'/ft.$

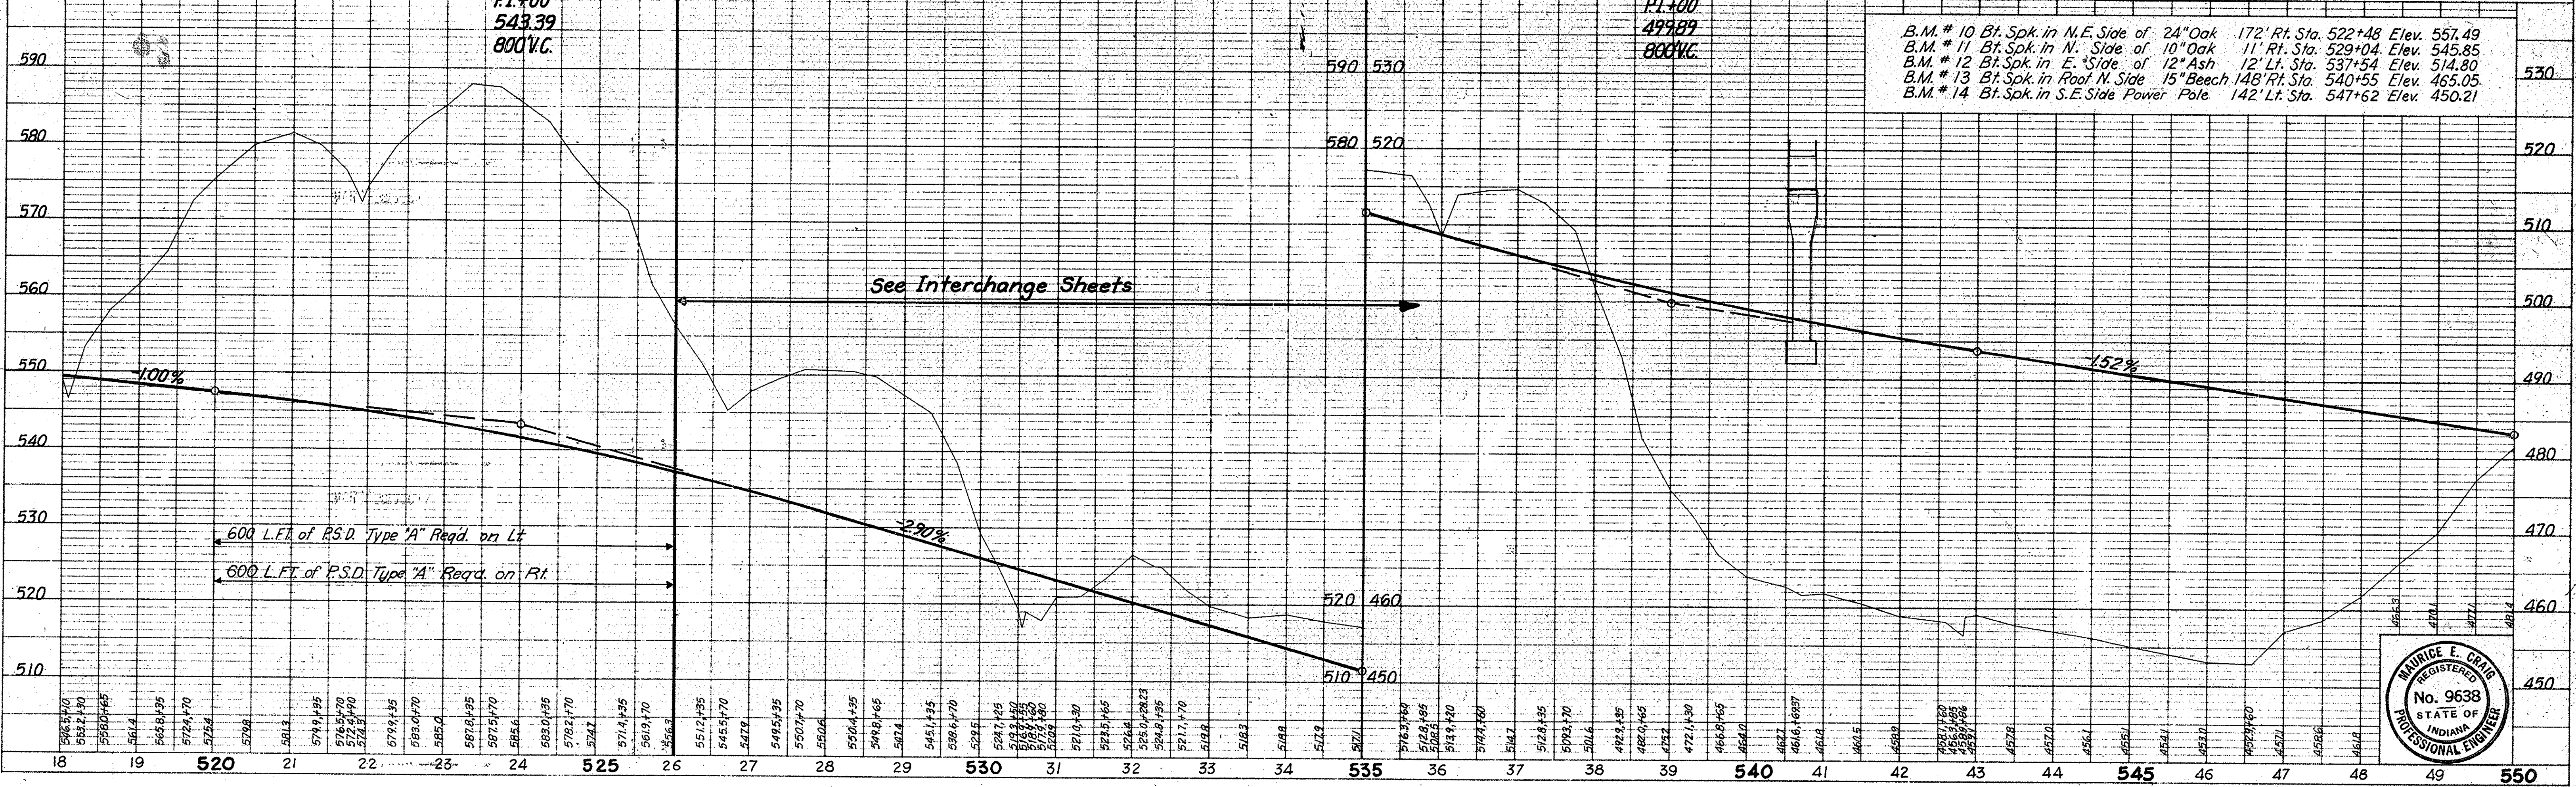



B.M. # 10	Br. Spk. in N.E. Side of 24" Oak	172' Rt. Sta. 522+48	Elev. 557.49
B.M. # 11	Br. Spk. in N. Side of 10" Oak	11' Rt. Sta. 529+04	Elev. 545.85
B.M. # 12	Br. Spk. in E. Side of 12" Ash	12' Lt. Sta. 537+54	Elev. 514.80
B.M. # 13	Br. Spk. in Roof N. Side 15" Beech	148' Rt. Sta. 540+55	Elev. 465.05
B.M. # 14	Br. Spk. in S.E. Side Power Pole	142' Lt. Sta. 547+62	Elev. 450.21

PROFILE

DATE	1-66
BY	L.S.H.C.
CHECKED	R.M.C.
DATE	2-66
BY	G.C.C.
CHECKED	R.D.L.
DATE	11-66
BY	
CHECKED	

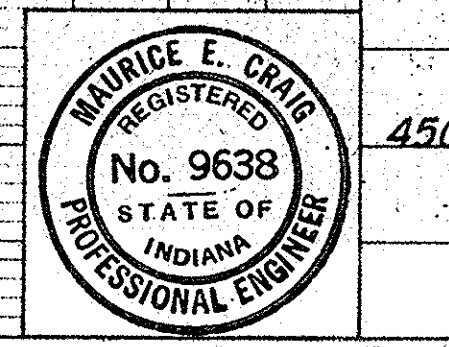

FEDERAL ROAD DISTRICT NO.	STATE	PROJECT NO.	FISCAL YEAR	SHEET NO.	TOTAL SHEETS
4	IND.	I-64-3(33)86	1967	43	43

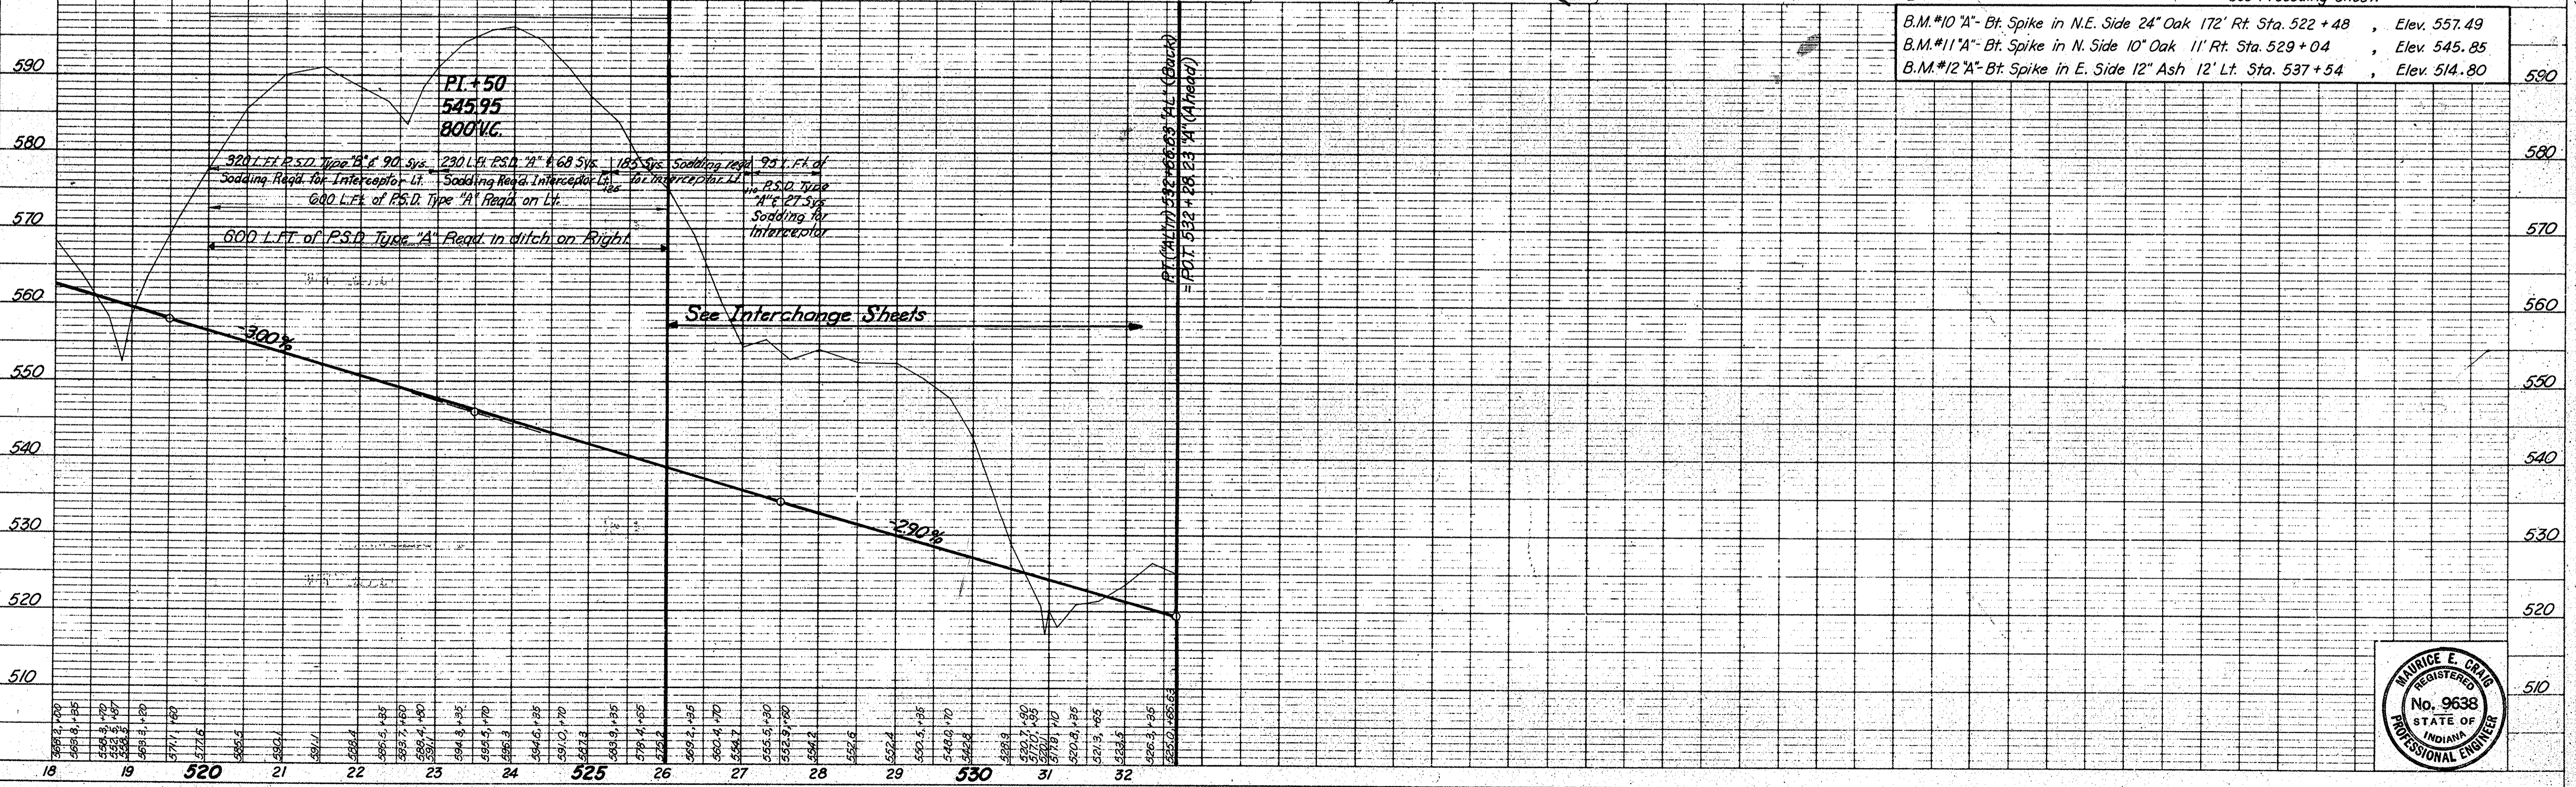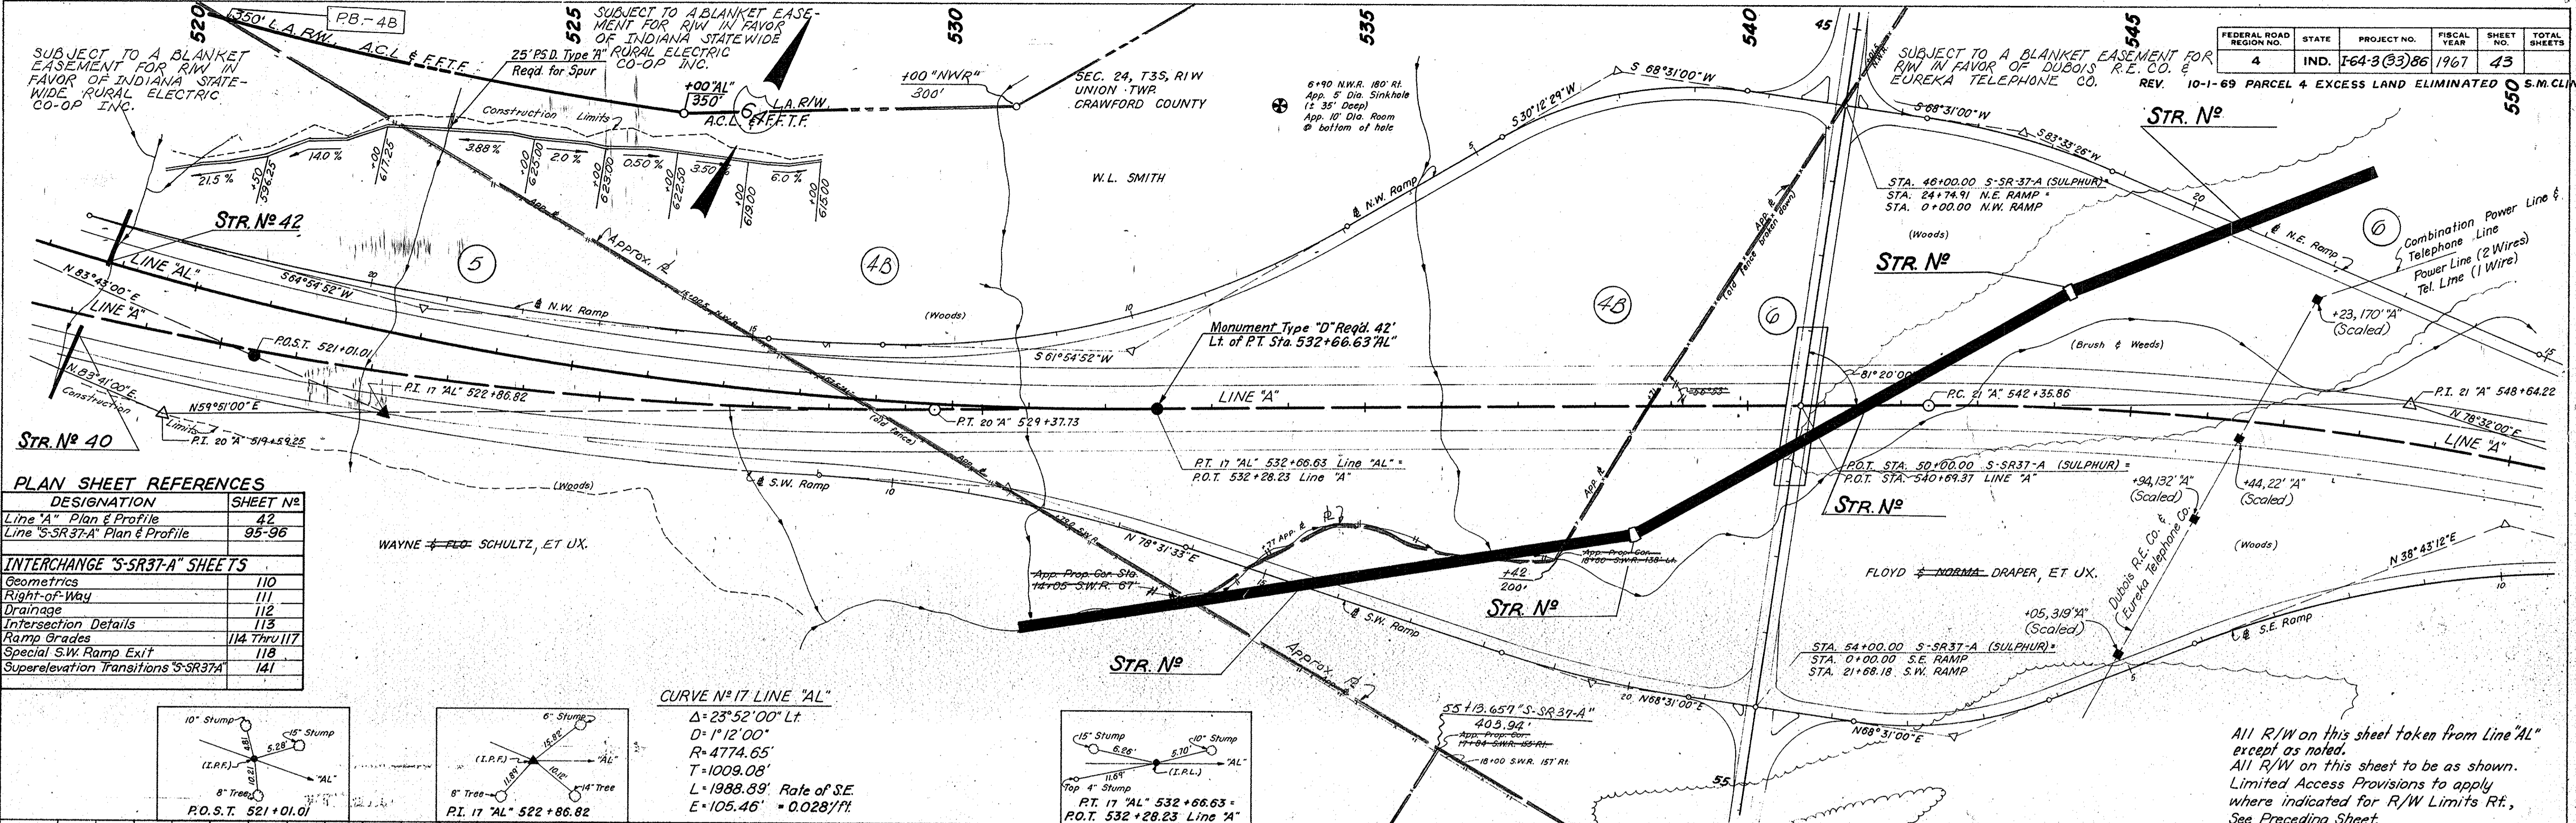

All R/W on this sheet taken from Line "AL" except as noted.
 All R/W on this sheet to be as shown.
 Limited Access Provisions to apply where indicated for R/W Limits Rt.
 See Preceding Sheet.

PLAN


DATE	BY
11-66	F.S.H.C.
11-66	T.M.
11-66	R.D.L.

NO. 9522 L. STRUCTURE MODIFICATIONS CHECKED

PROFILE


DATE	BY
1-68	F.S.H.C.
2-68	T.M.
2-68	R.D.L.

NO. 9522 L. STRUCTURE MODIFICATIONS CHECKED

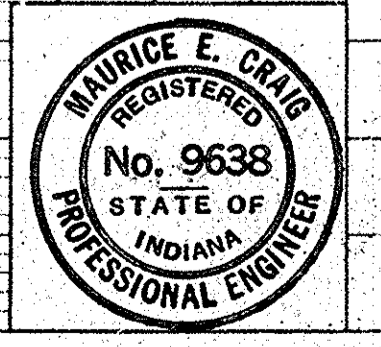


PROJECT NO.	LINE	SHEET NO.	TOTAL SHEETS	FILE
I-64-3(33)86	AL	43		

FEDERAL ROAD DISTRICT NO.	STATE	PROJECT NO.	FISCAL YEAR	SHEET NO.	TOTAL SHEETS
4	IND.	164-3(3)86	1967	44	

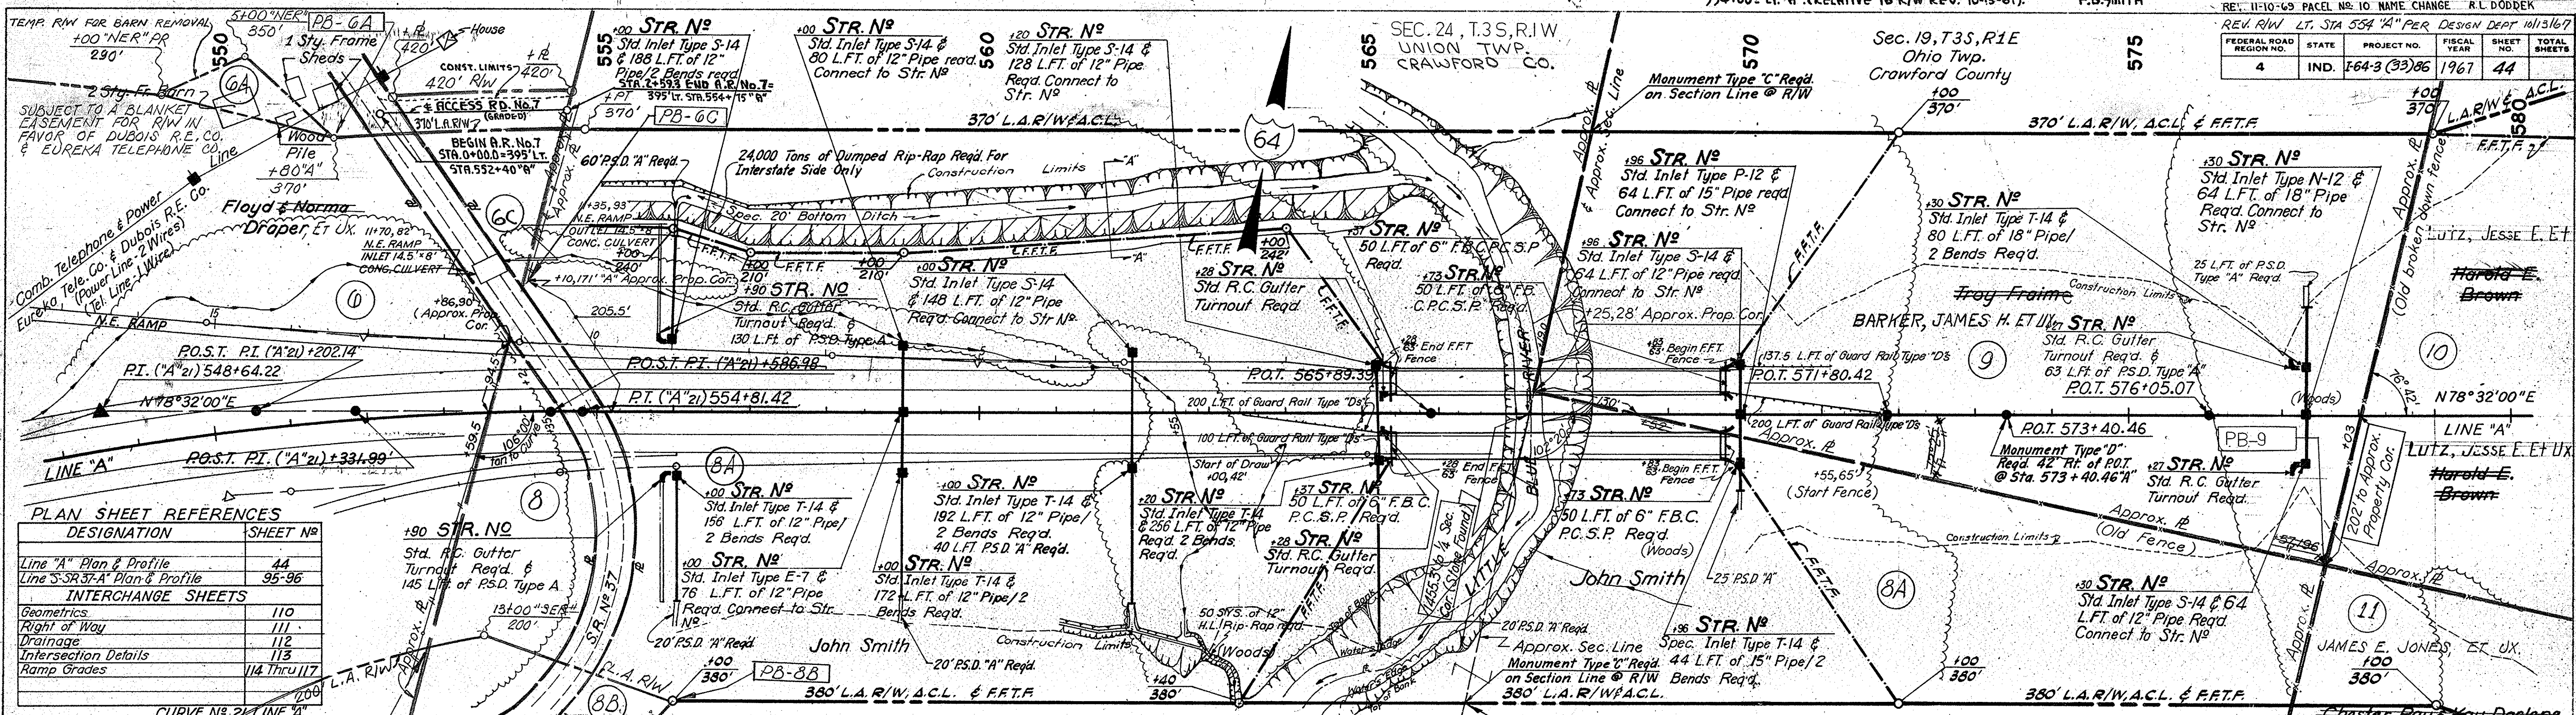

PLAN SHEET REFERENCES

DESIGNATION	SHEET NO.
Line "A" Plan & Profile	44
Line S-373-A Plan & Profile	95-96
INTERCHANGE SHEETS	
Geometrics	110
Right of Way	111
Drainage	112
Intersection Details	113
Ramp Grades	114 Thru 117

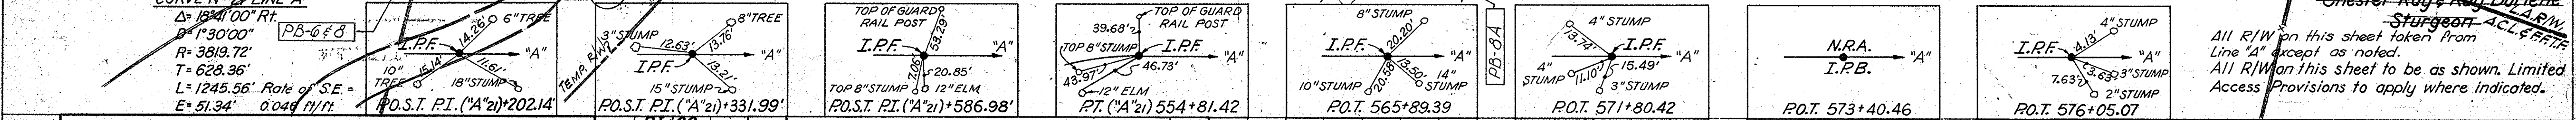

B.M. L-117X Sta. Ind. Flood Control B.M. (Marked CRA 19 1963)
184' Lt. Sta. 553+52 Line "A", Elev. 445.320

B.M. #15 - Bt. Spike in W. Side 12" Walnut 124' Lt. Sta. 557+70, Elev. 434.43
B.M. #16 - Bt. Spike in E. Side 24" Oak 189' Rt. Sta. 564+96, Elev. 440.06
B.M. #17 - Bt. Spike in W. Side 24" Maple 196' Lt. Sta. 569+10, Elev. 455.20
B.M. #18 - Bt. Spike in 12" Oak Stump 5' Lt. Sta. 570+58, Elev. 517.17
B.M. #19 - Bt. Spike in W. Side 15" Oak 213' Rt. Sta. 572+12, Elev. 563.10
B.M. #20 - Bt. Spike in E. Side 18" Walnut 215' Lt. Sta. 576+59, Elev. 547.27
B.M. #21 - Bt. Spike in E. Side 18" Walnut 227' Rt. Sta. 578+67, Elev. 498.04

ACCESS ROAD No. 7

445	445
440	440
435	435

Structure No. 1-64-87-5680 over Little Blue River


Bill of Materials - One Slab:

RC Bridge Approach	Reinforcing Steel	RC Bridge Approach
Width	Weight	Width
24' Entr.	1296 #	54.7'
28' Exit	1513 #	63.8'

* 237.0 Sys. of 9" RC Pymt. Req'd for 4 RC Bridge Approaches
* 5618 Lbs. of Reinf. Steel Req'd for 4 RC Bridge Approaches




FEDERAL ROAD REGION NO.	STATE	PROJECT NO.	FISCAL YEAR	SHEET NO.	TOTAL SHEETS
4	IND.	1-64-3(33)86	1967	45	

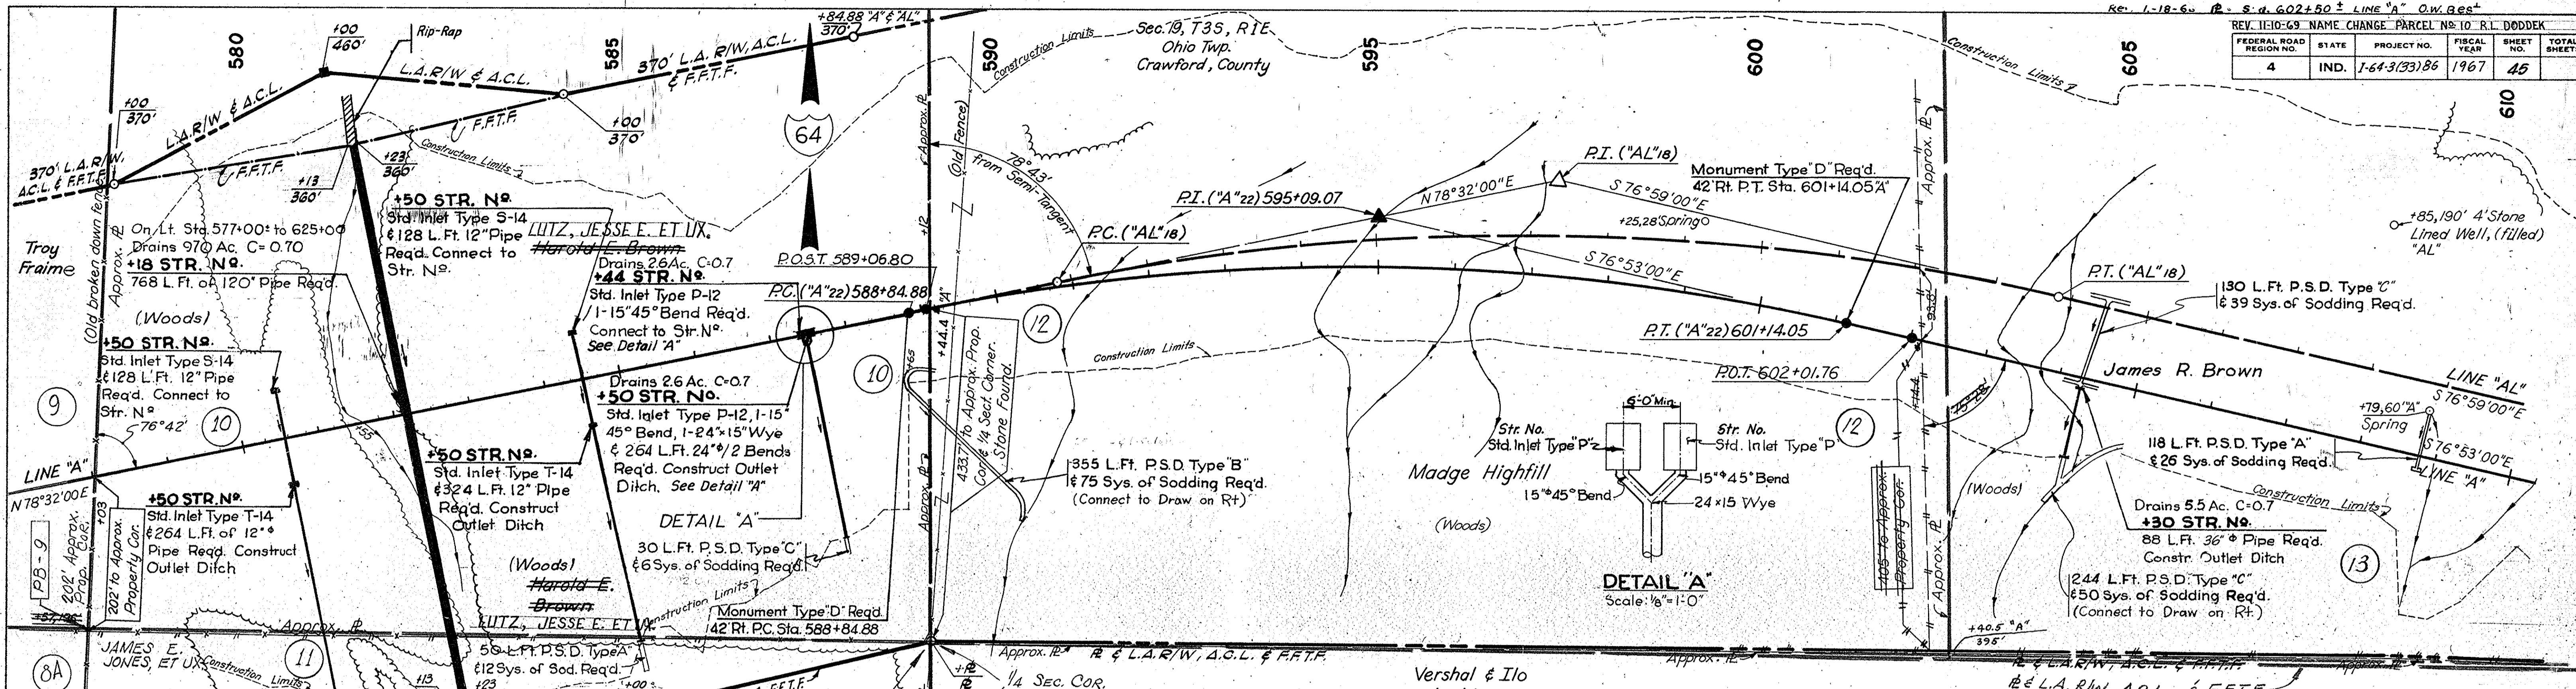


DATE	BY	REVISION
1-5-64	L.S.H.C.	1-66
1-10-64	L.A.W.	1-66
1-10-64	D.F.C.	2-66
1-10-64	R.A.L.	11-66

PLAN
 SURVEYED BY: L.S.H.C., L.A.W., D.F.C., R.A.L.
 NOTE BOOK ALIGNED ORICED: No. 92271
 STRUCTURE NOTATIONS DESCRIBED: 25, 26

CURVE NO. 22 LINE "A"
 $\Delta = 24^\circ 35' 00''$ Rt.
 $D = 2^\circ 00' 00''$
 $R = 2864.79'$
 $T = 624.19'$
 $L = 1229.17'$
 $E = 67.21'$, Rate of S.E. = 0.056 Ft./ft.

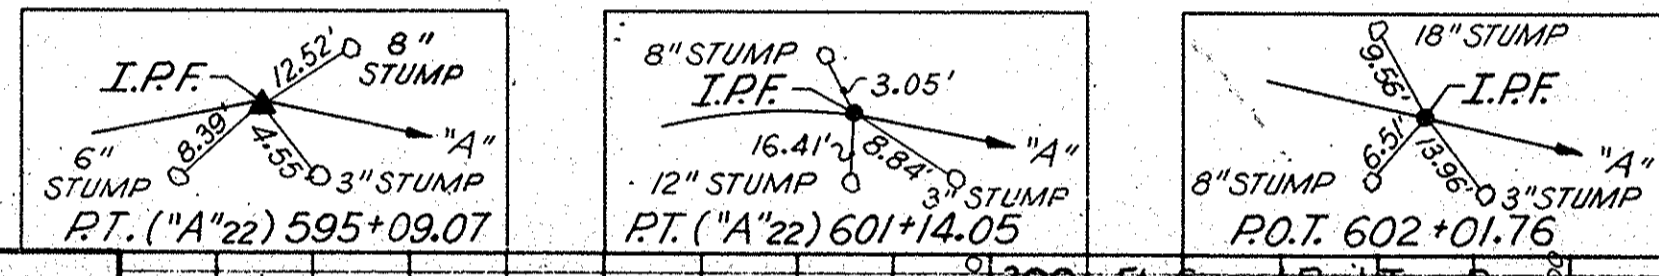


R/W on this sheet to be taken from Line "A" except as noted. All R/W on this sheet to be as shown. Limited Access Provisions to apply where indicated. For R/W Limits Lt., See Following Sheet.

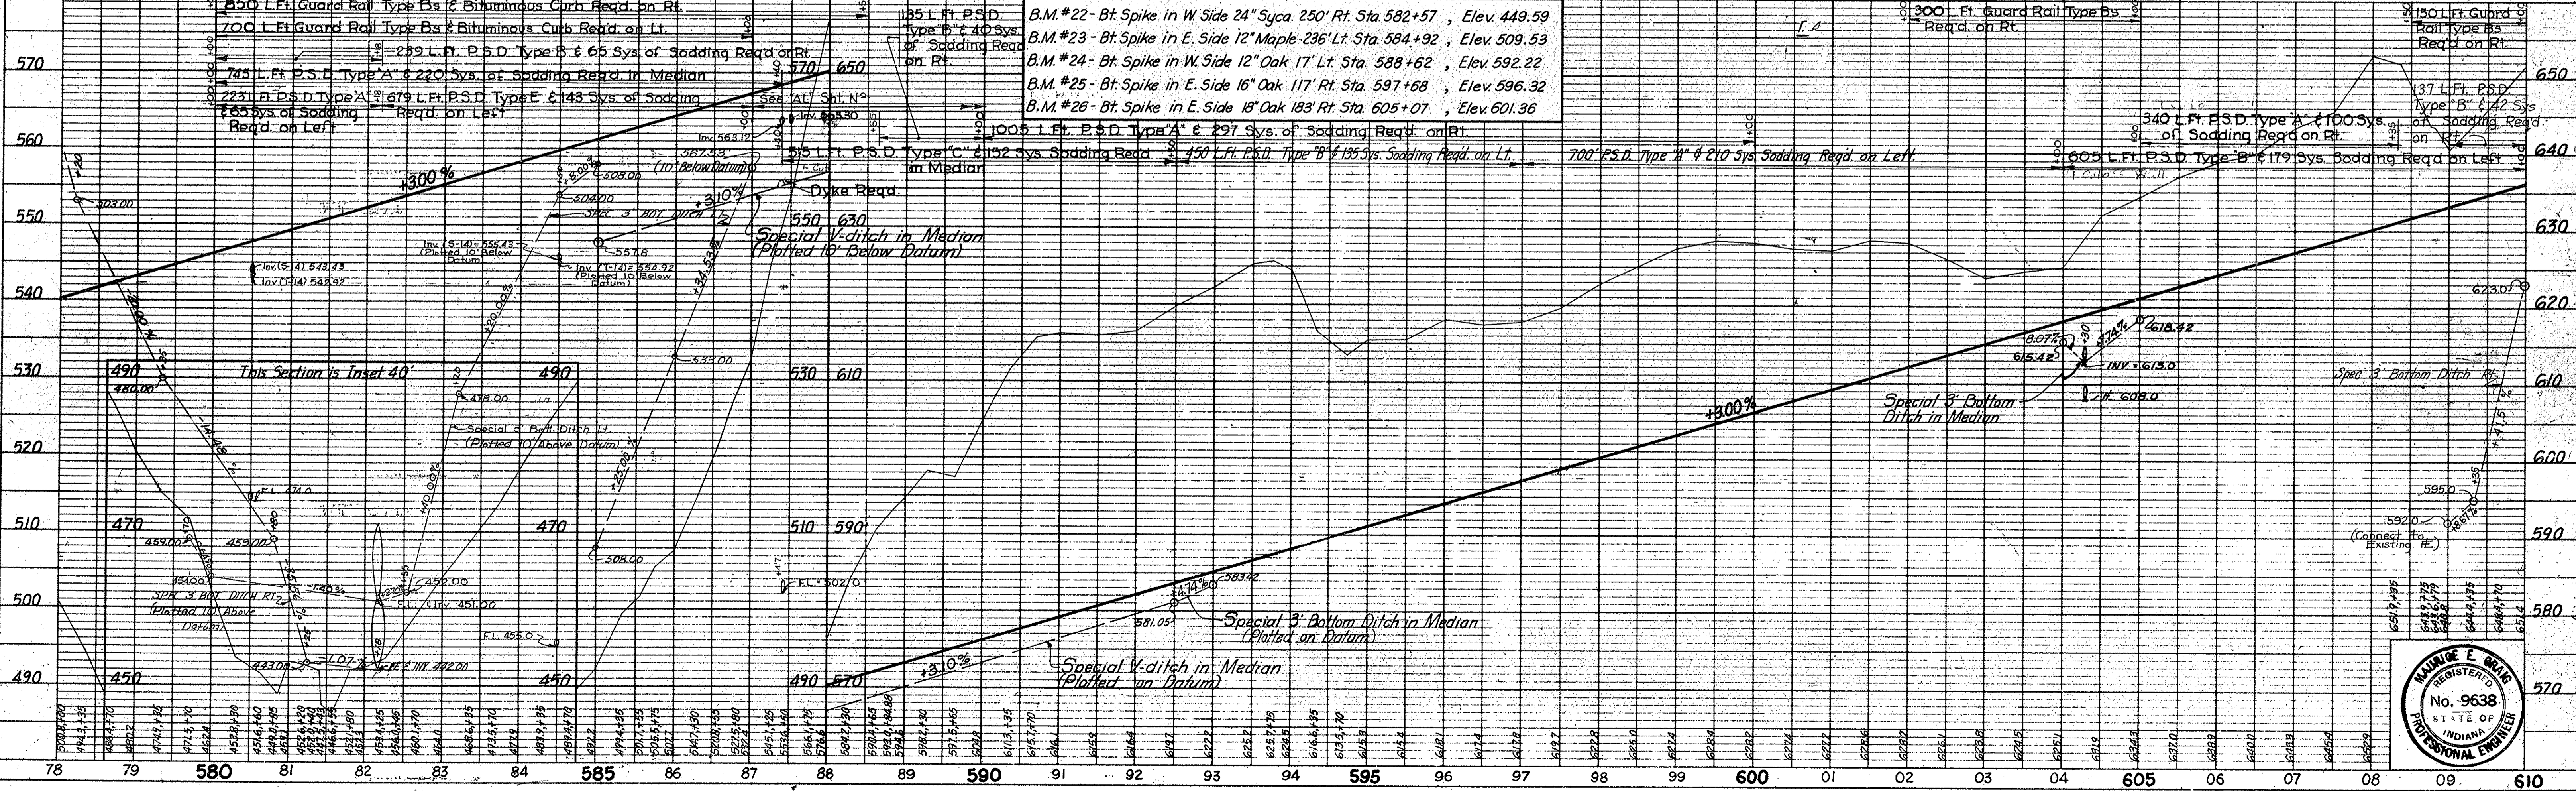

DATE	BY	REVISION
1-5-64	L.S.H.C.	1-66
1-10-64	L.A.W.	1-66
1-10-64	D.F.C.	2-66
1-10-64	R.A.L.	11-66

PROFILE
 SURVEYED BY: L.S.H.C., L.A.W., D.F.C., R.A.L.
 NOTE BOOK ALIGNED ORICED: No. 92271
 STRUCTURE NOTATIONS DESCRIBED: 25, 26

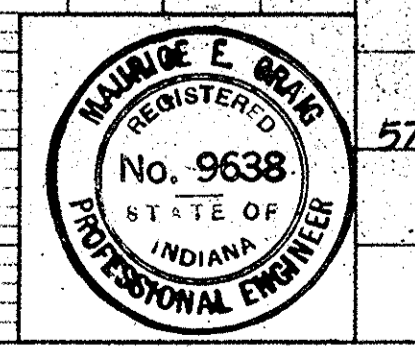



PROJECT NO.	LINE	SHEET NO.	TOTAL SHEETS	FILE
1-64-3(33)86	A	45		

REV. 11-18-68 - P. STA. 602+50± LINE "A" Q.W. BEST		REV. 11-10-69 NAME CHANGE PARCEL NO. 10 R.L. DODDOK	
FEDERAL ROAD REGION NO.	STATE	PROJECT NO.	FISCAL YEAR
4	IND.	1-64-3(3)86	1967
SHEET NO.		TOTAL SHEETS	
46		46	


Sec. 19, T3S, R1E
Ohio Twp.
Crawford County

PLAN
DATE: 1-66
BY: J.S.P.C.
CHECKED: G.E.C.
NOTE BOOK: ALIGNMENT CHECKED
No. 2-64-2, 11-66
STRUCTURE NOTATIONS CHECKED: 9-66

PROFILE
DATE: 1-66
BY: J.S.P.C.
CHECKED: G.E.C.
NOTE BOOK: GRADES CHECKED
B.M. NOTED
No. 8327L
STRUCTURE NOTATIONS CHECKED: P.G.

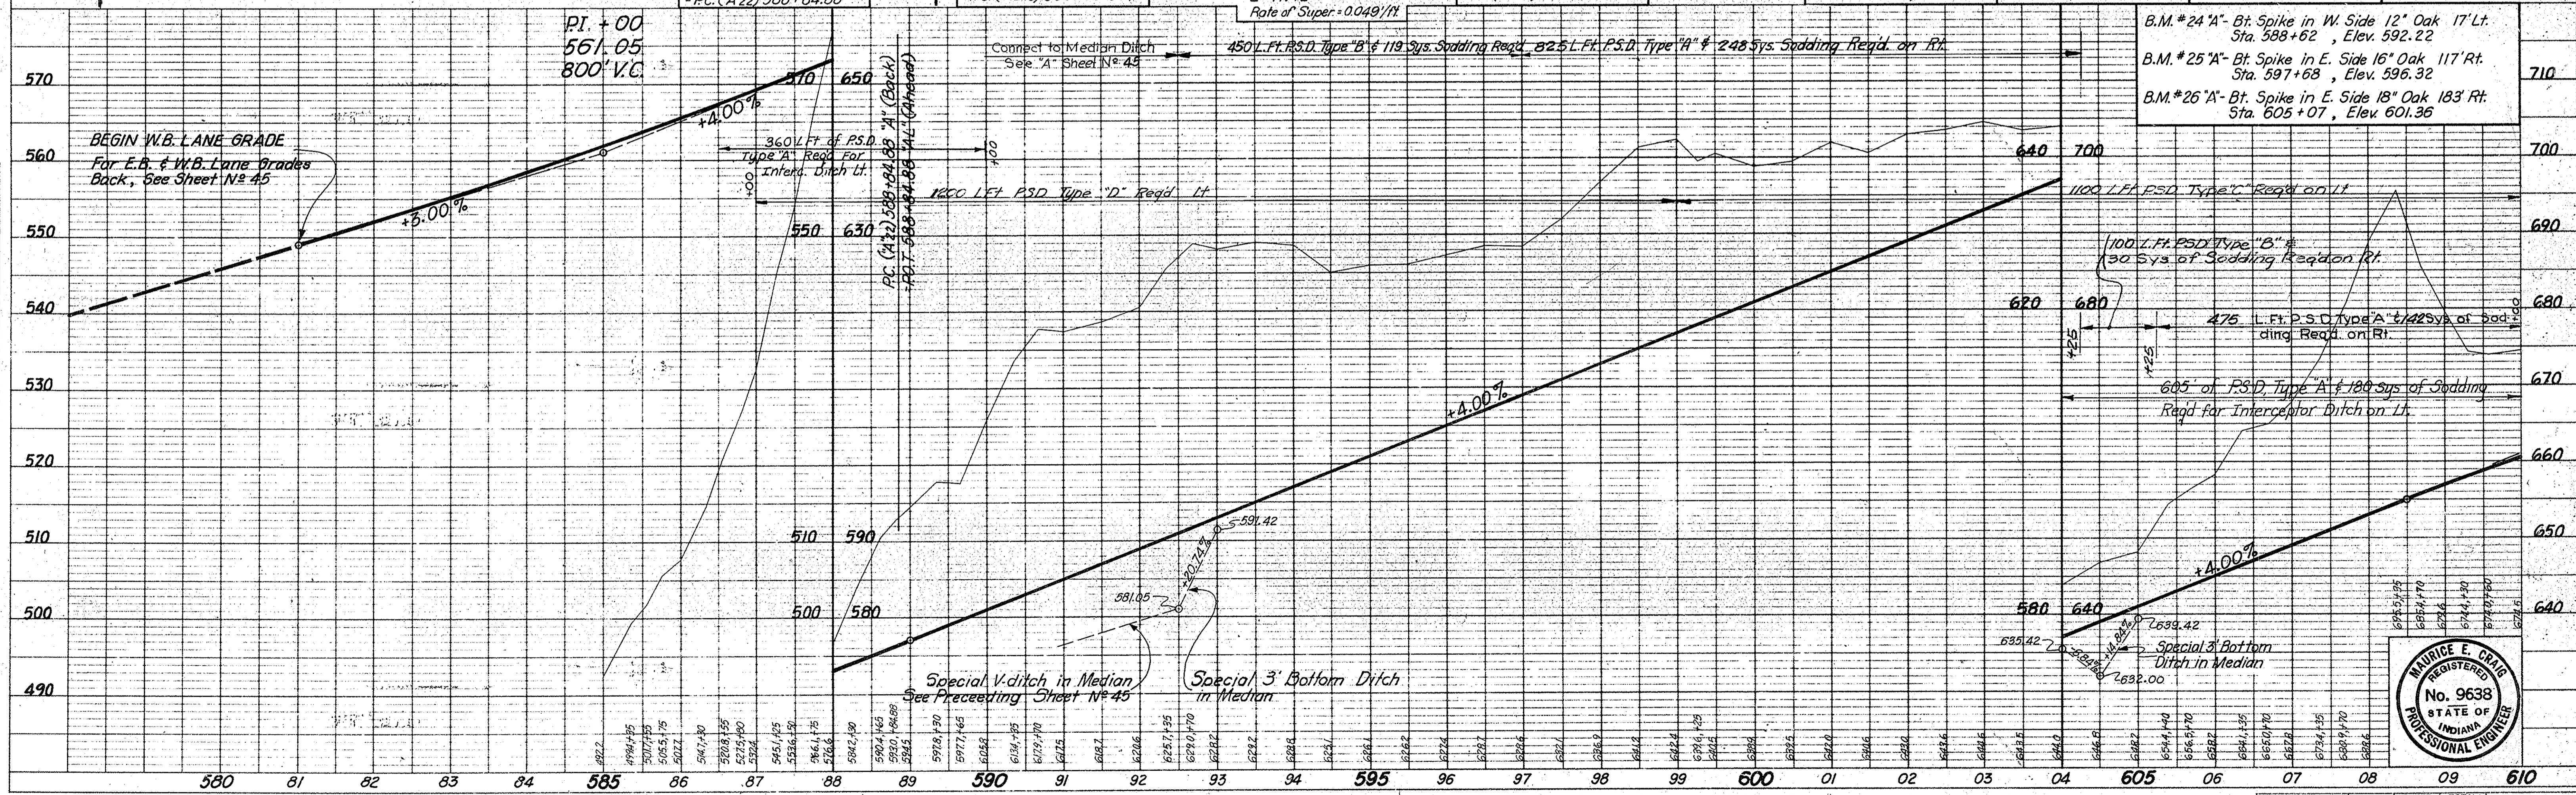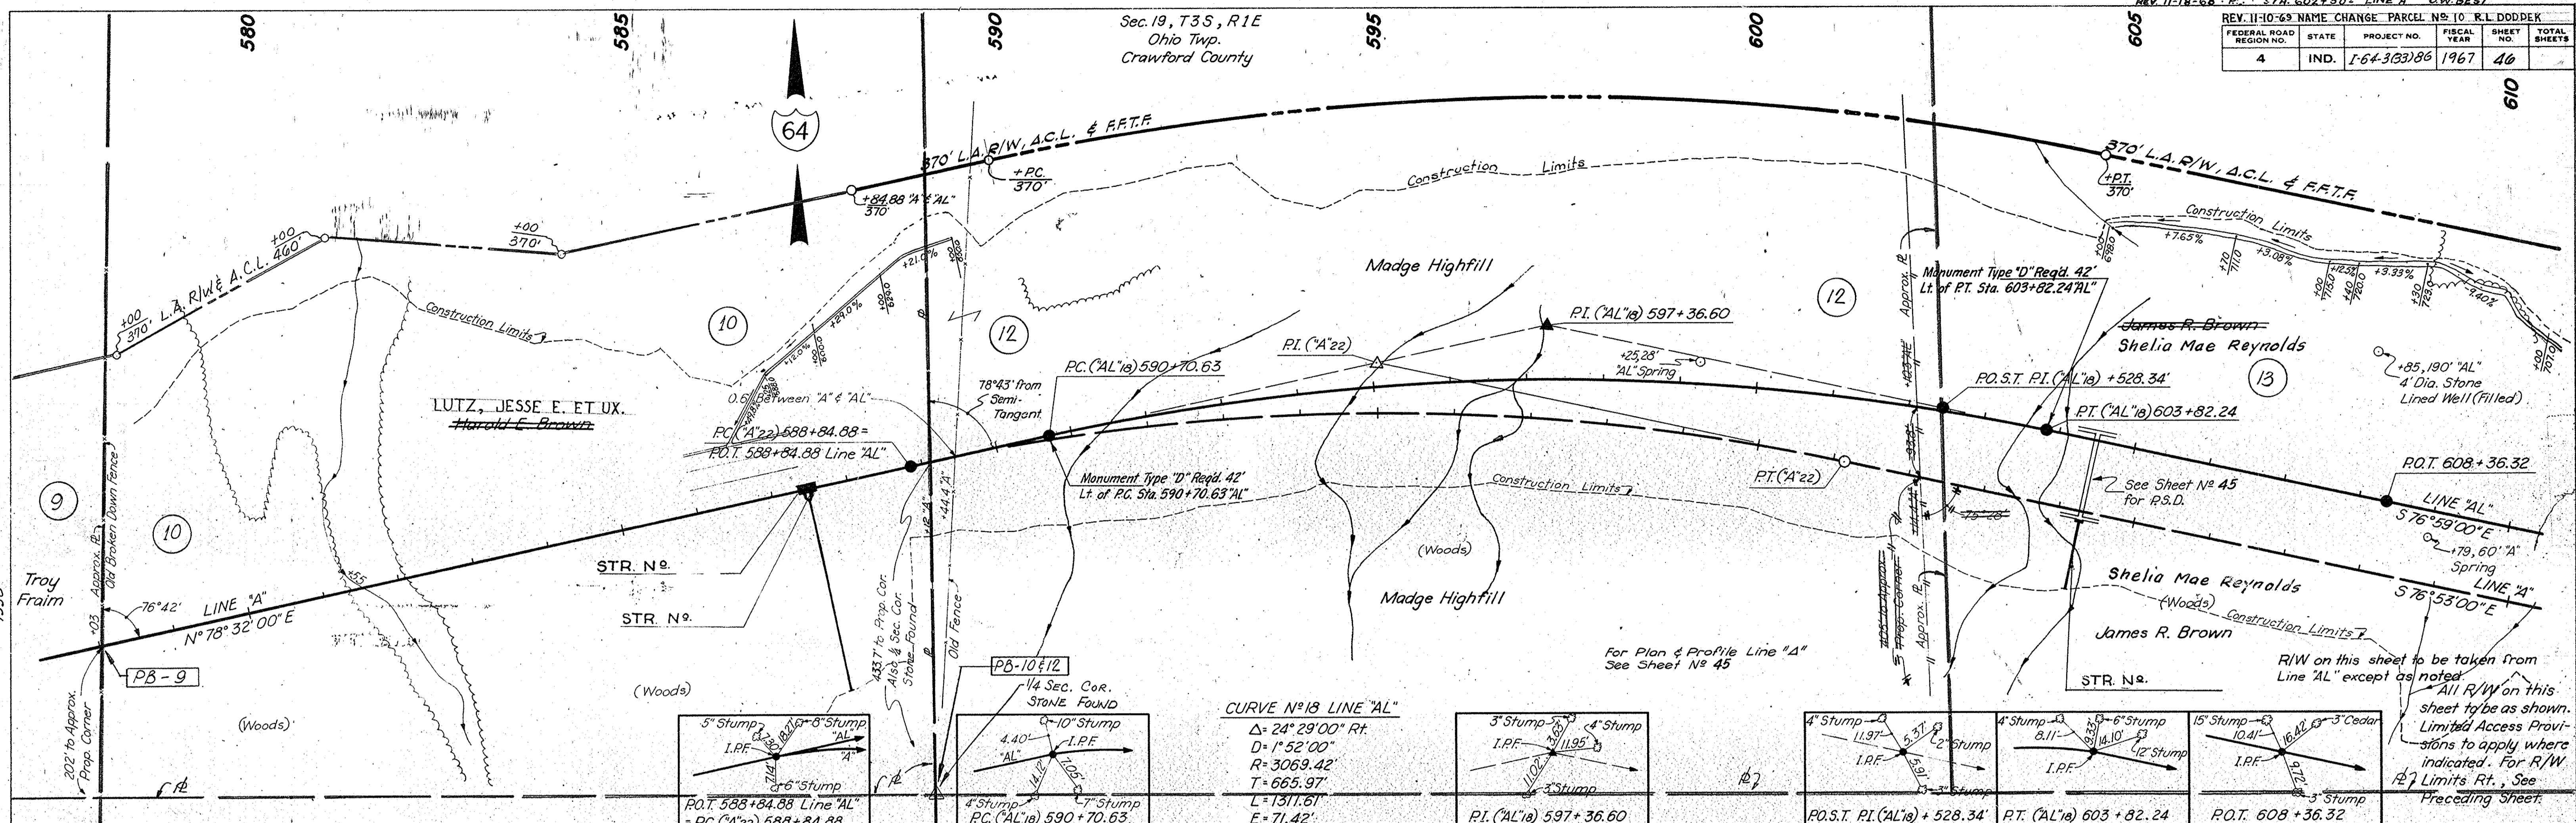

PROJECT NO.	LINE	SHEET NO.	TOTAL SHEETS	FILE
1-64-3(3)86	AL	46	46	


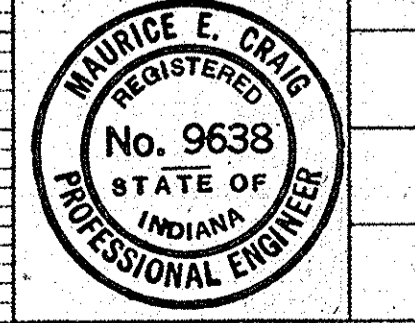


FEDERAL ROAD DISTRICT NO.	STATE	PROJECT NO.	FISCAL YEAR	SHEET NO.	TOTAL SHEETS
4	IND.	I-64-3(33)86	1967	48	


CURVE NO 19-LINE "AL"
 $\Delta = 21^{\circ}57'08''$ Lt.
 $D = 1^{\circ}52'00''$
 $R = 3069.42'$
 $T = 595.31'$
 $L = 1176.01'$
 $E = 57.19'$
 Rate of S.E. = 0.048'/ft.

PLAN
 SURVEYED BY: L.S.H.C.
 DATE: 1-26-66
 NOTE BOOK: 1-66
 CHECKED BY: R.B.L.
 NO. 7-6423
 FT. OF WAY CHECKED: 9999


PROFILE
 SURVEYED BY: L.S.H.C.
 DATE: 1-26-66
 NOTE BOOK: 1-66
 CHECKED BY: R.B.L.
 NO. 92272
 STRUCTURE NOTATIONS CHECKED: R.B.

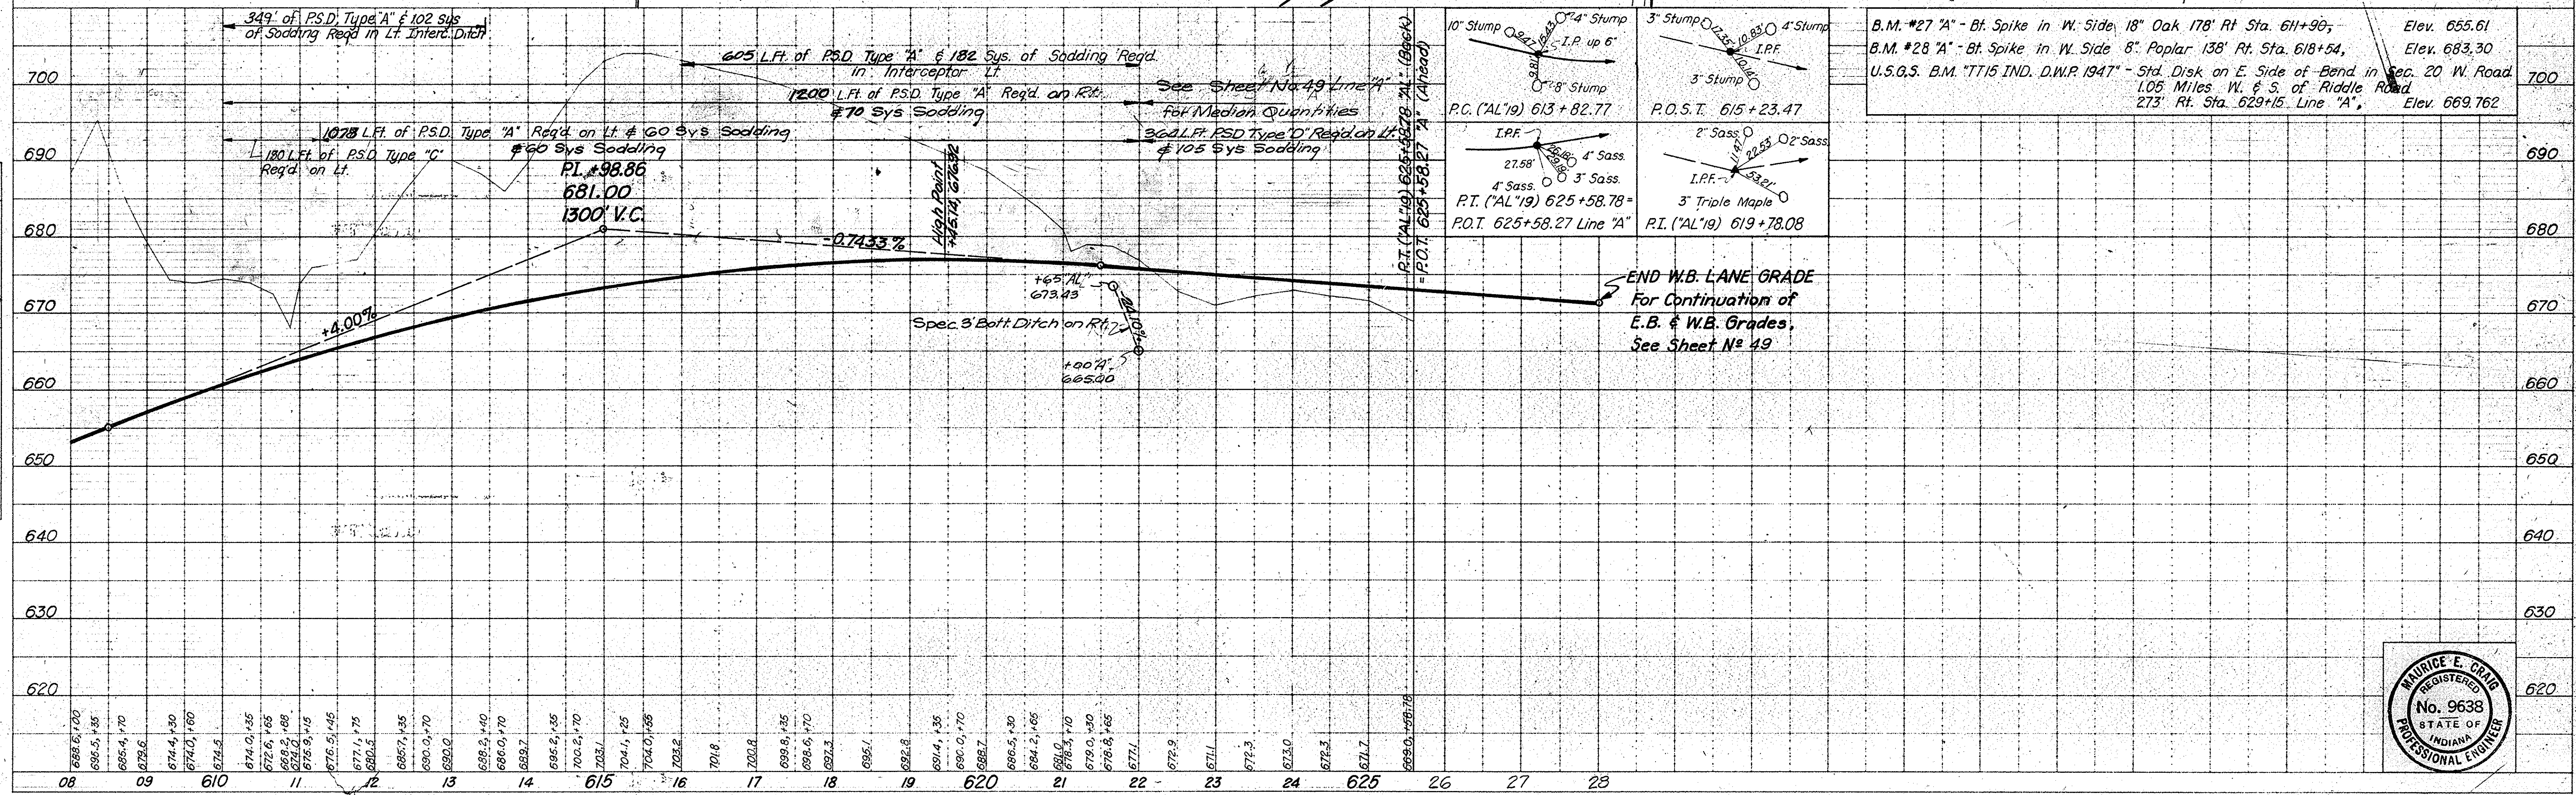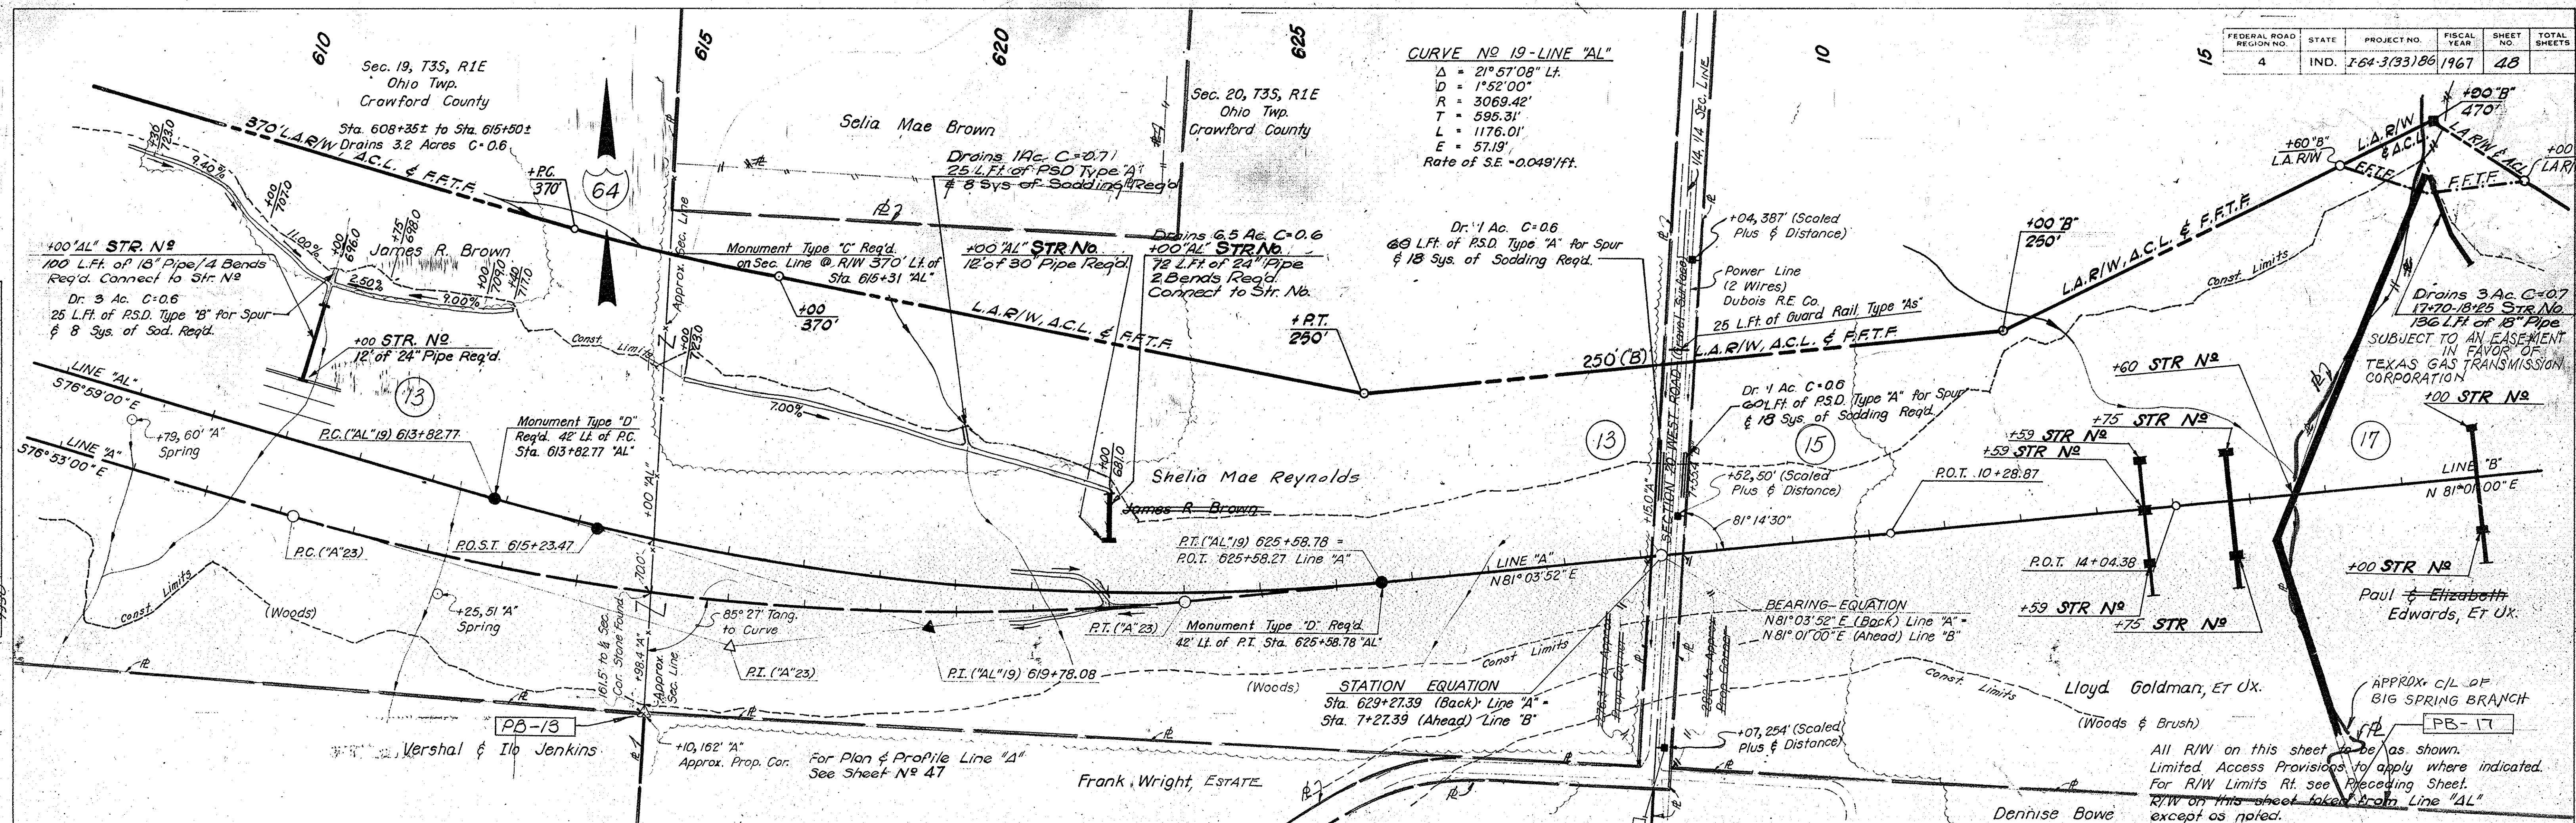



B.M. #27 'A' - Bl. Spike in W. Side 18" Oak 178' Rt. Sta. 618+90, Elev. 655.61
 B.M. #28 'A' - Bl. Spike in W. Side 8" Poplar 138' Rt. Sta. 618+54, Elev. 683.30
 U.S.G.S. B.M. "TT15 IND. D.W.P. 1947" - Std. Disk on E. Side of Bend in Sec. 20 W. Road 1.05 Miles W. & S. of Riddle Road 273' Rt. Sta. 629+15. Line "A", Elev. 669.762

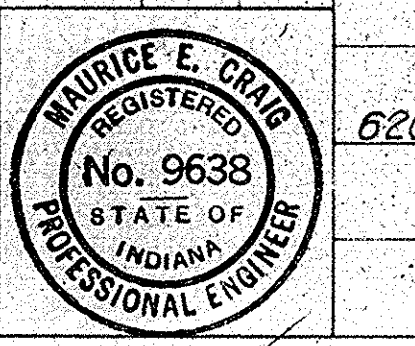



SUBJECT TO A BLANKET EASEMENT FOR R/W IN FAVOR OF TEXAS GAS TRANSMISSION CORP.

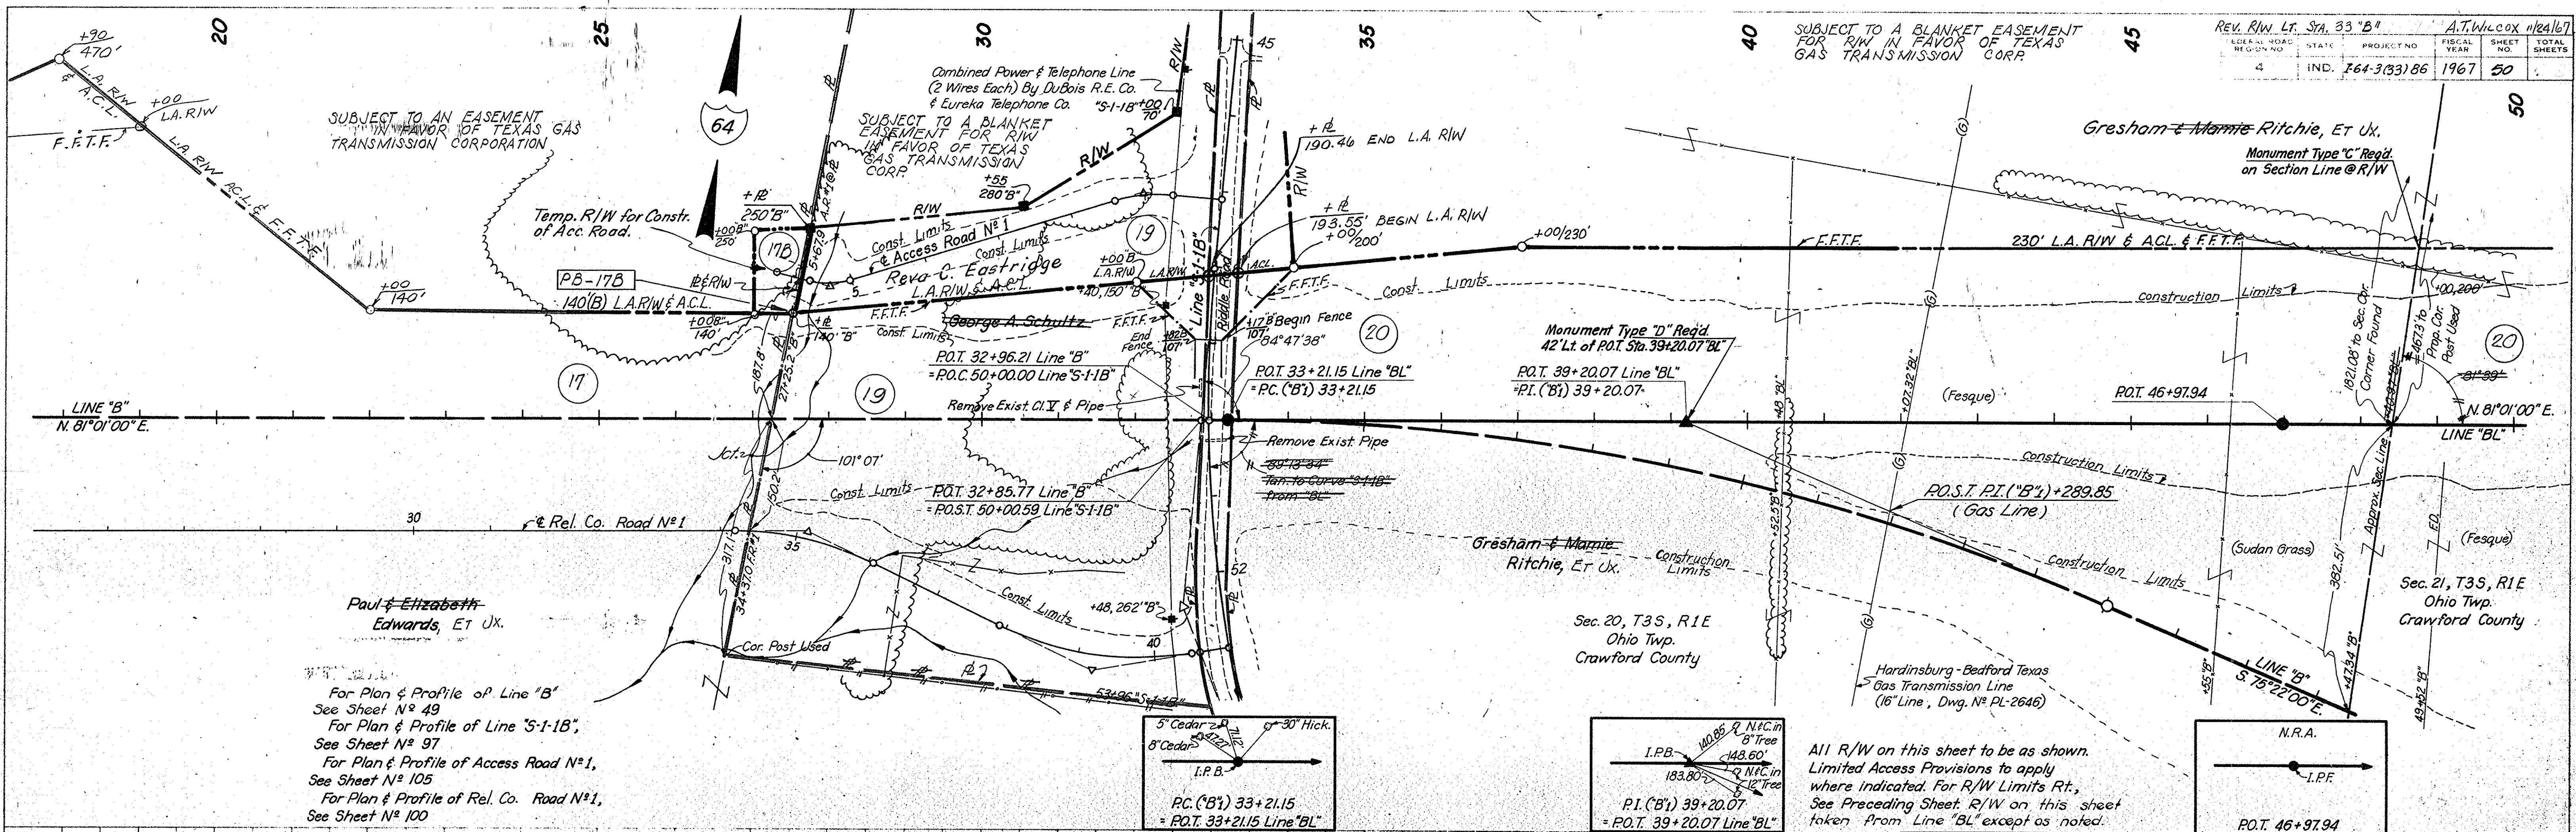

For Plan & Profile of Line "B"
 See Sheet N° 49
 For Plan & Profile of Line "S-1-B",
 See Sheet N° 97
 For Plan & Profile of Access Road N°1,
 See Sheet N° 105
 For Plan & Profile of Rel. Co. Road N°1,
 See Sheet N° 100

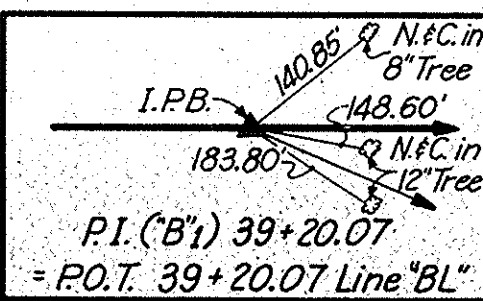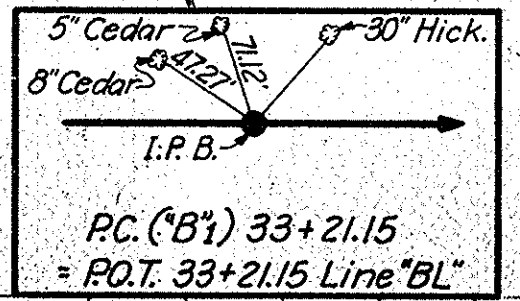


All R/W on this sheet to be as shown.
 Limited Access Provisions to apply where indicated. For R/W Limits Rt., See Preceding Sheet R/W on this sheet taken from Line "BL" except as noted.

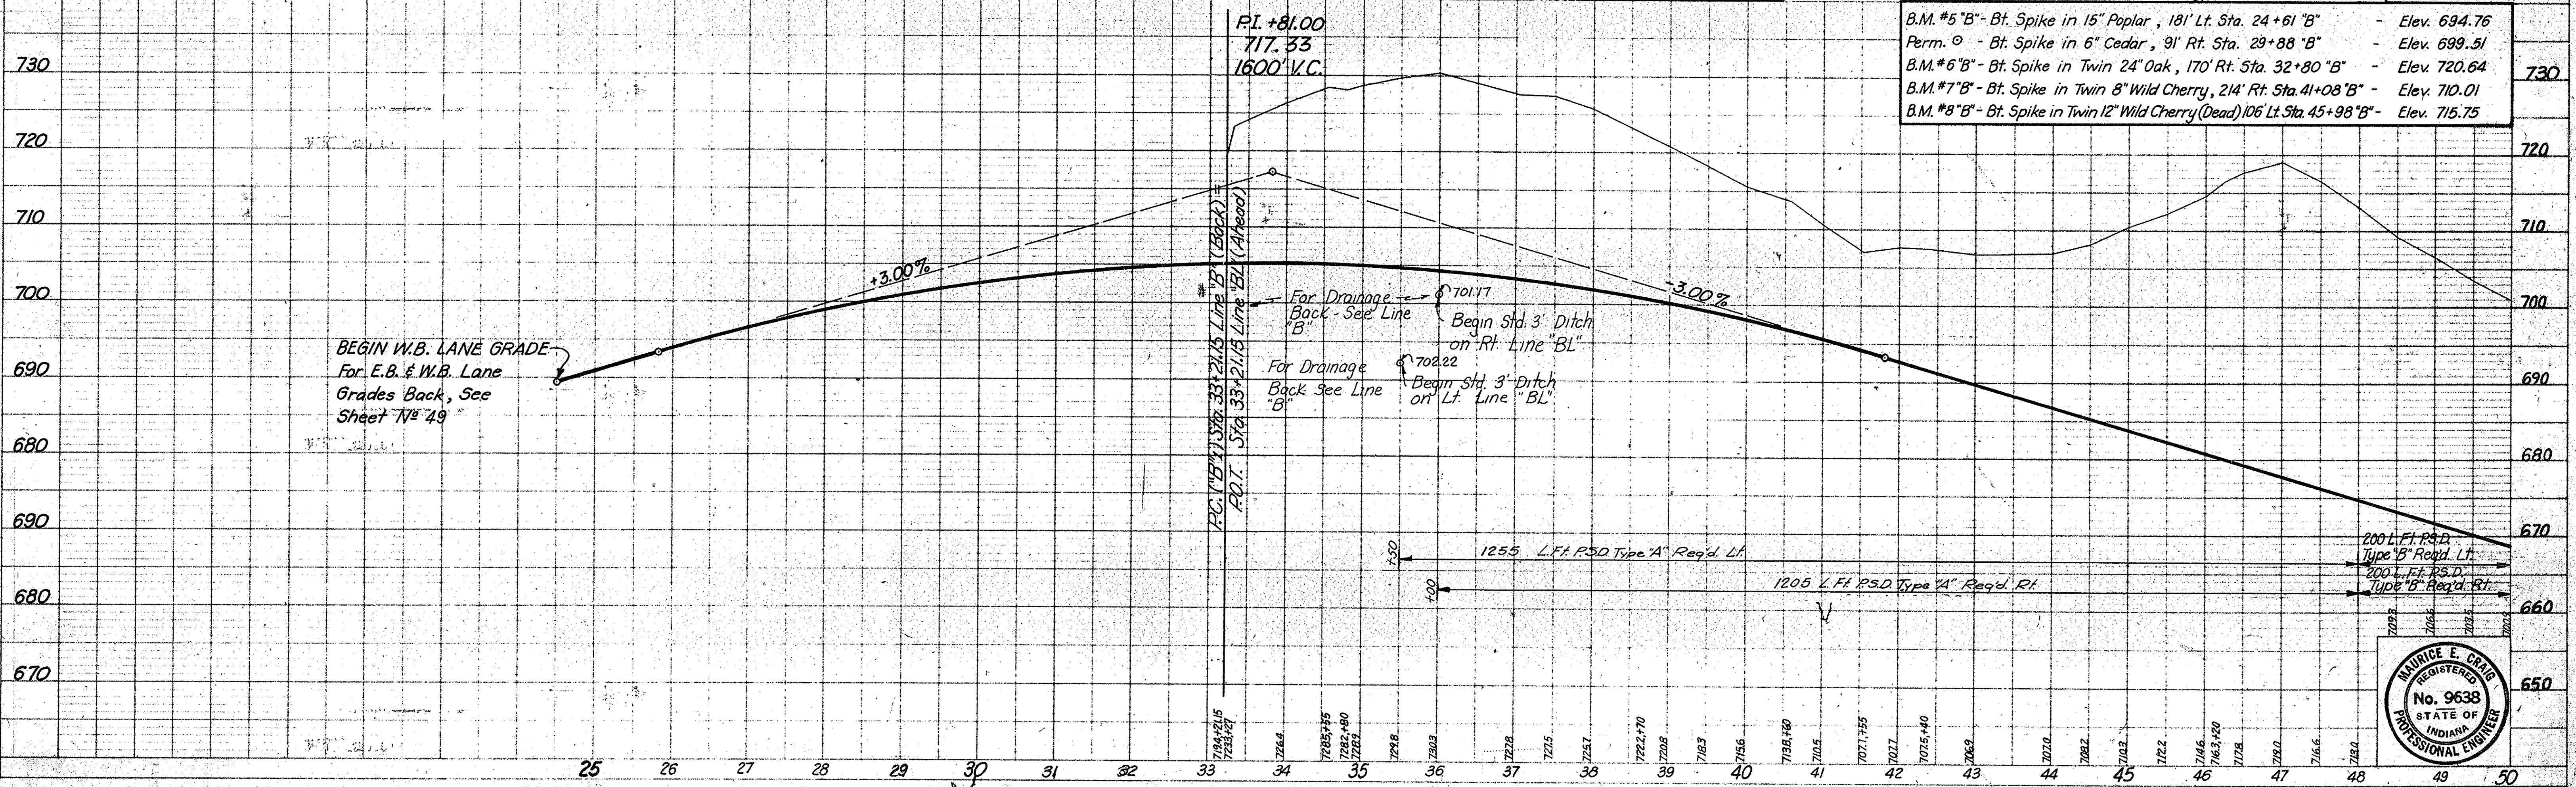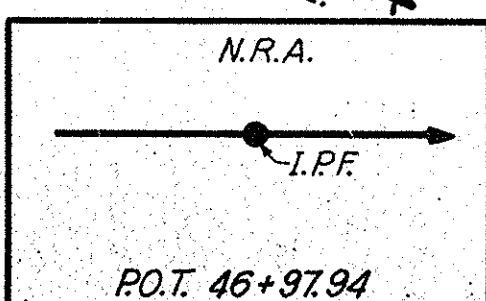

PLAN
 SURVEYED BY: L.S.H.C.
 CHECKED BY: G.E.C.
 DATE: 1/66
 NOTE BOOK NO. 88772
 STRUCTURE NOTATIONS CHECKED BY: P.B.

PROFILE
 SURVEYED BY: L.S.H.C.
 CHECKED BY: G.E.C.
 DATE: 1/66
 NOTE BOOK NO. 88772
 STRUCTURE NOTATIONS CHECKED BY: P.B.

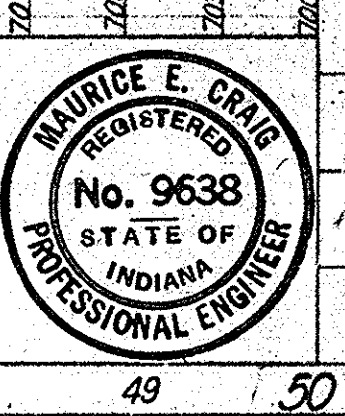


Sec. 22, T3S, R1E
Jennings Twp.
Crawford County


FEDERAL ROAD DISTRICT NO.	STATE	PROJECT NO.	FISCAL YEAR	SHEET NO.	TOTAL SHEETS
4	IND.	1-64-3(3) 86	1967	56	

CURVE NO 2 LINE "BL"
 $\Delta = 38^{\circ}35'00''$ Lt.
 $D = 2^{\circ}30'00''$
 $R = 2291.83'$
 $T = 802.21'$
 $L = 1543.33'$
 $E = 136.34'$
 Rate of S.E. 0.0691'/ft

CURVE NO 3 LINE "BL"
 $\Delta = 8^{\circ}01'00''$ Rt.
 $D = 0^{\circ}48'00''$
 $R = 7161.97'$
 $T = 501.86'$
 $L = 1002.08'$
 $E = 17.56'$
 Rate of S.E. 0.0211'/ft

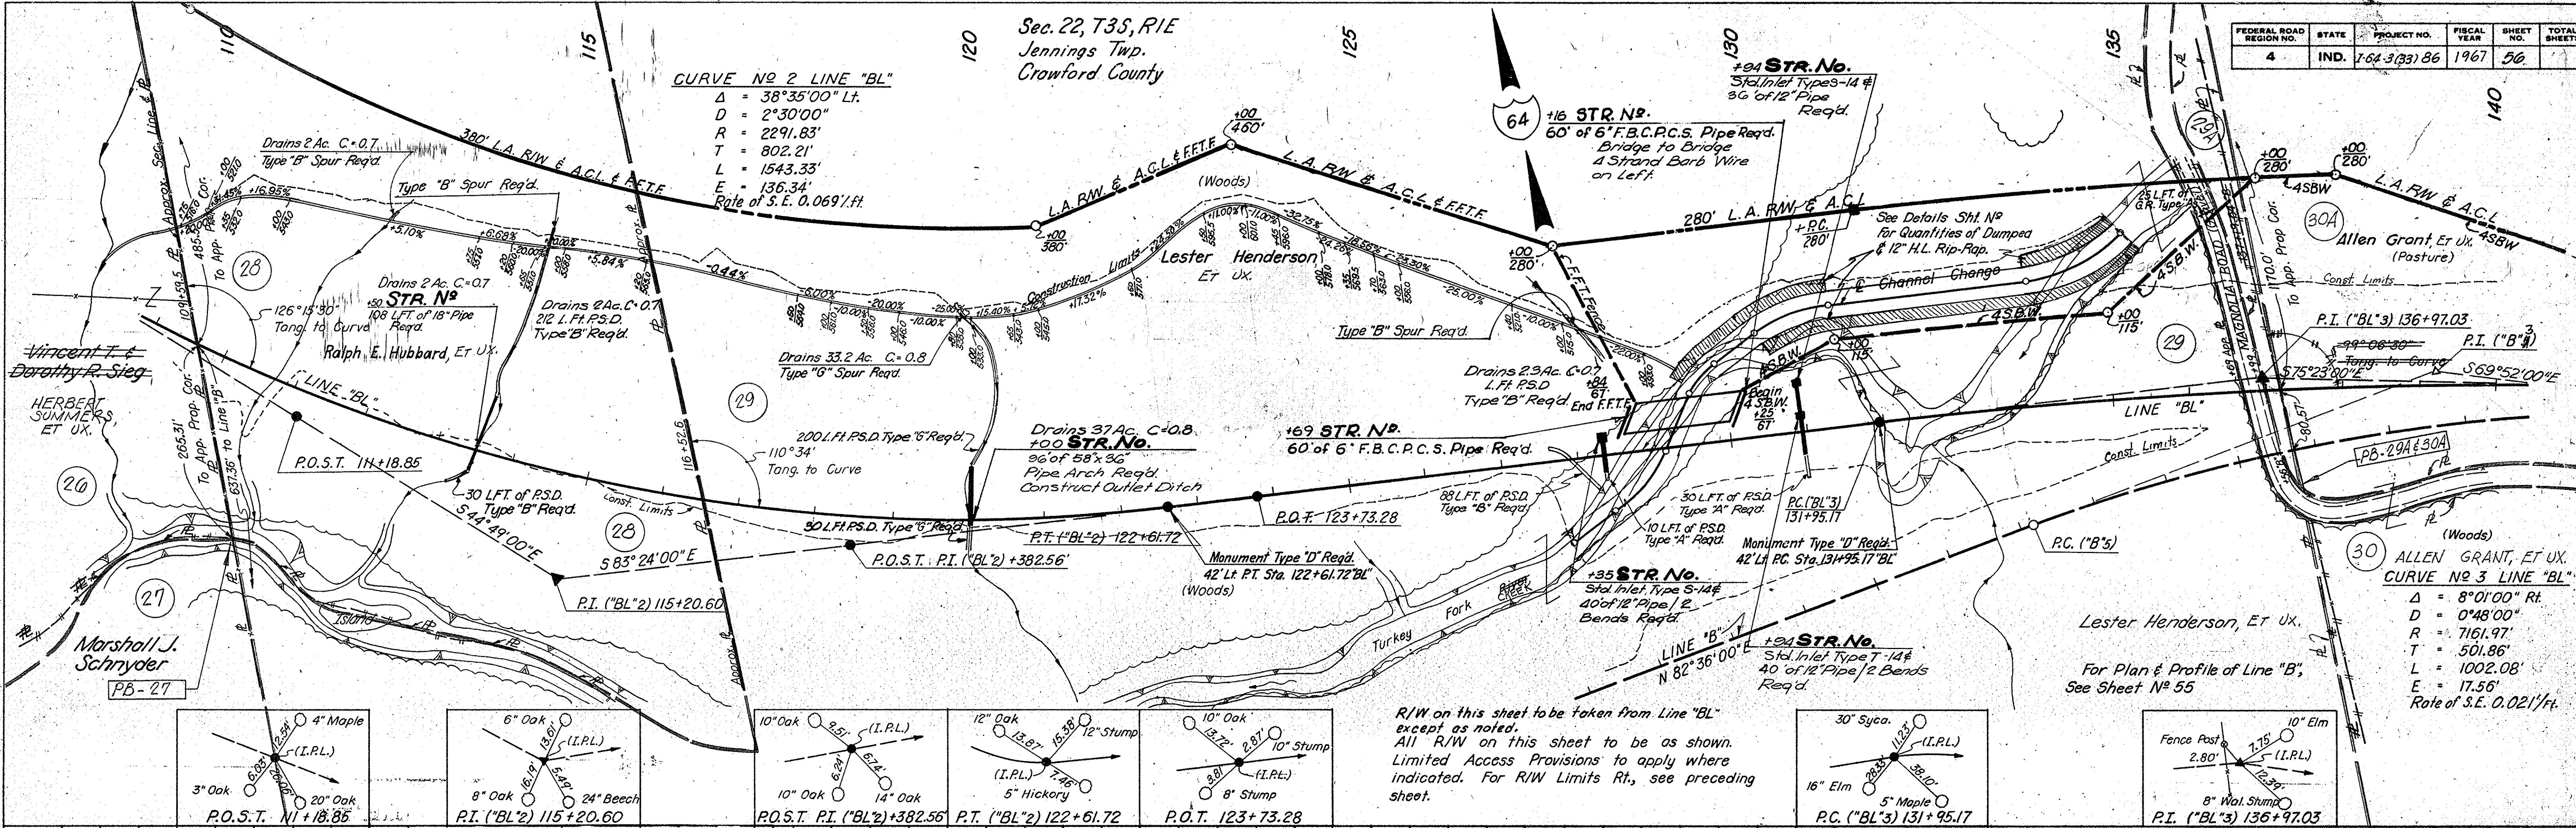



R/W on this sheet to be taken from Line "BL" except as noted.
 All R/W on this sheet to be as shown.
 Limited Access Provisions to apply where indicated. For R/W Limits Rt, see preceding sheet.

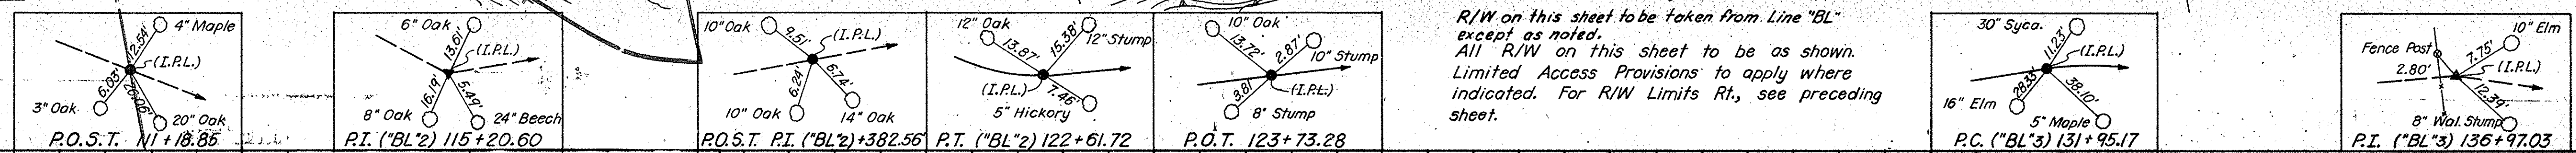


Structure No. 1 - I 64-91-56B2 over Turkey Fork River



Bill of Materials - One Slab			
R.C. BRIDGE APPROACH	LONG BARS	TRANS. BARS	TOTAL APPROACH SQ. YDS.
39'	74	59	2196.4
137.6'			137.6
* Lap 1:2 on a roadway			

B.M. #12 "BL" Bt. Spk. in N. Side 12" Sycamore 185' Rt. Sta. 109+90	= Elev. 469.06
B.M. #13 "BL" Bt. Spk. in N. Side (Root) 14" Oak 183' Rt. Sta. 113+98	= Elev. 476.04
B.M. #24 "B" Bt. Spk. in 20" Sycamore 141' Lt. Sta. 123+36	= Adj. Elev. 473.79
B.M. #25 "B" Bt. Spk. in E. Side 14" Beach 166' Rt. Sta. 129+90	= Adj. Elev. 509.10
B.M. L-130-X Bt. Spk. in Base 48" Sycamore (N. Side & Up 3')	
367' Lt. Sta. 136+00	= Elev. 480.61

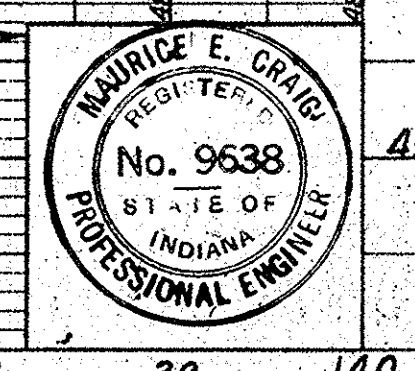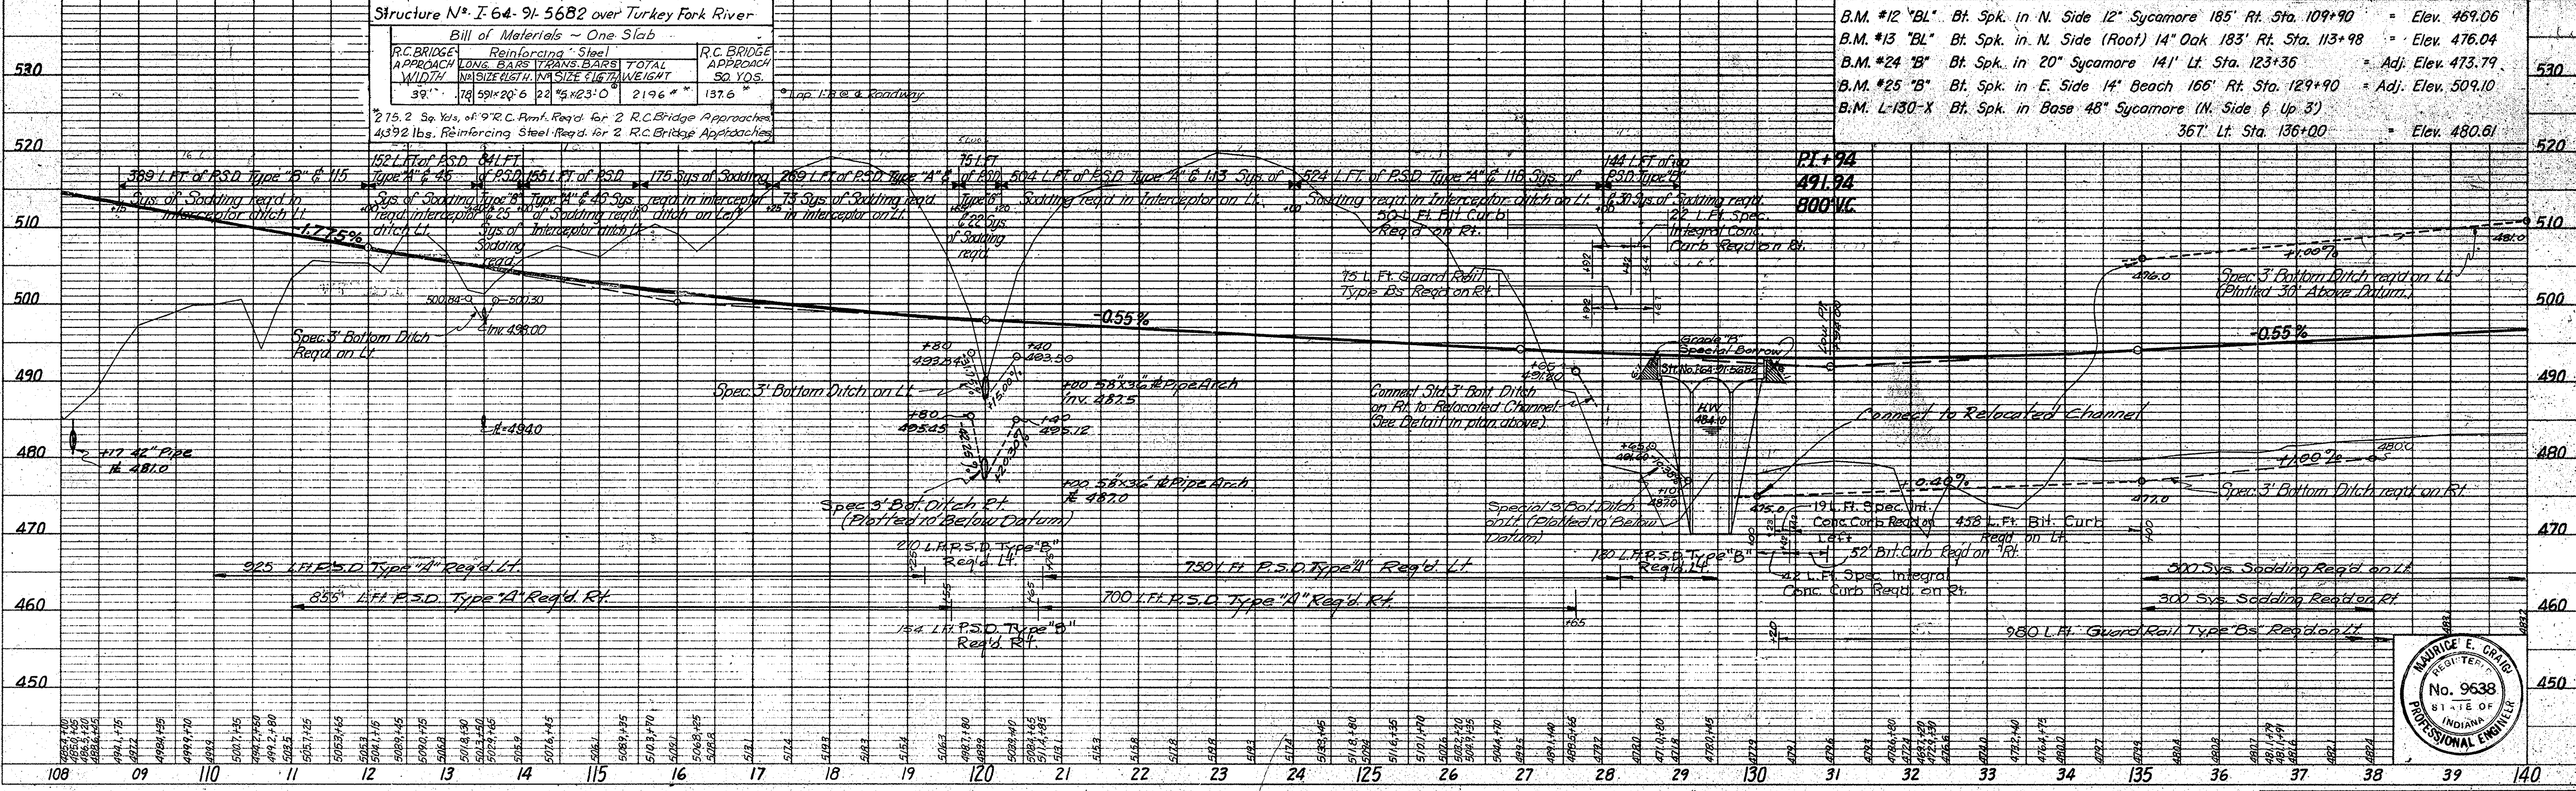

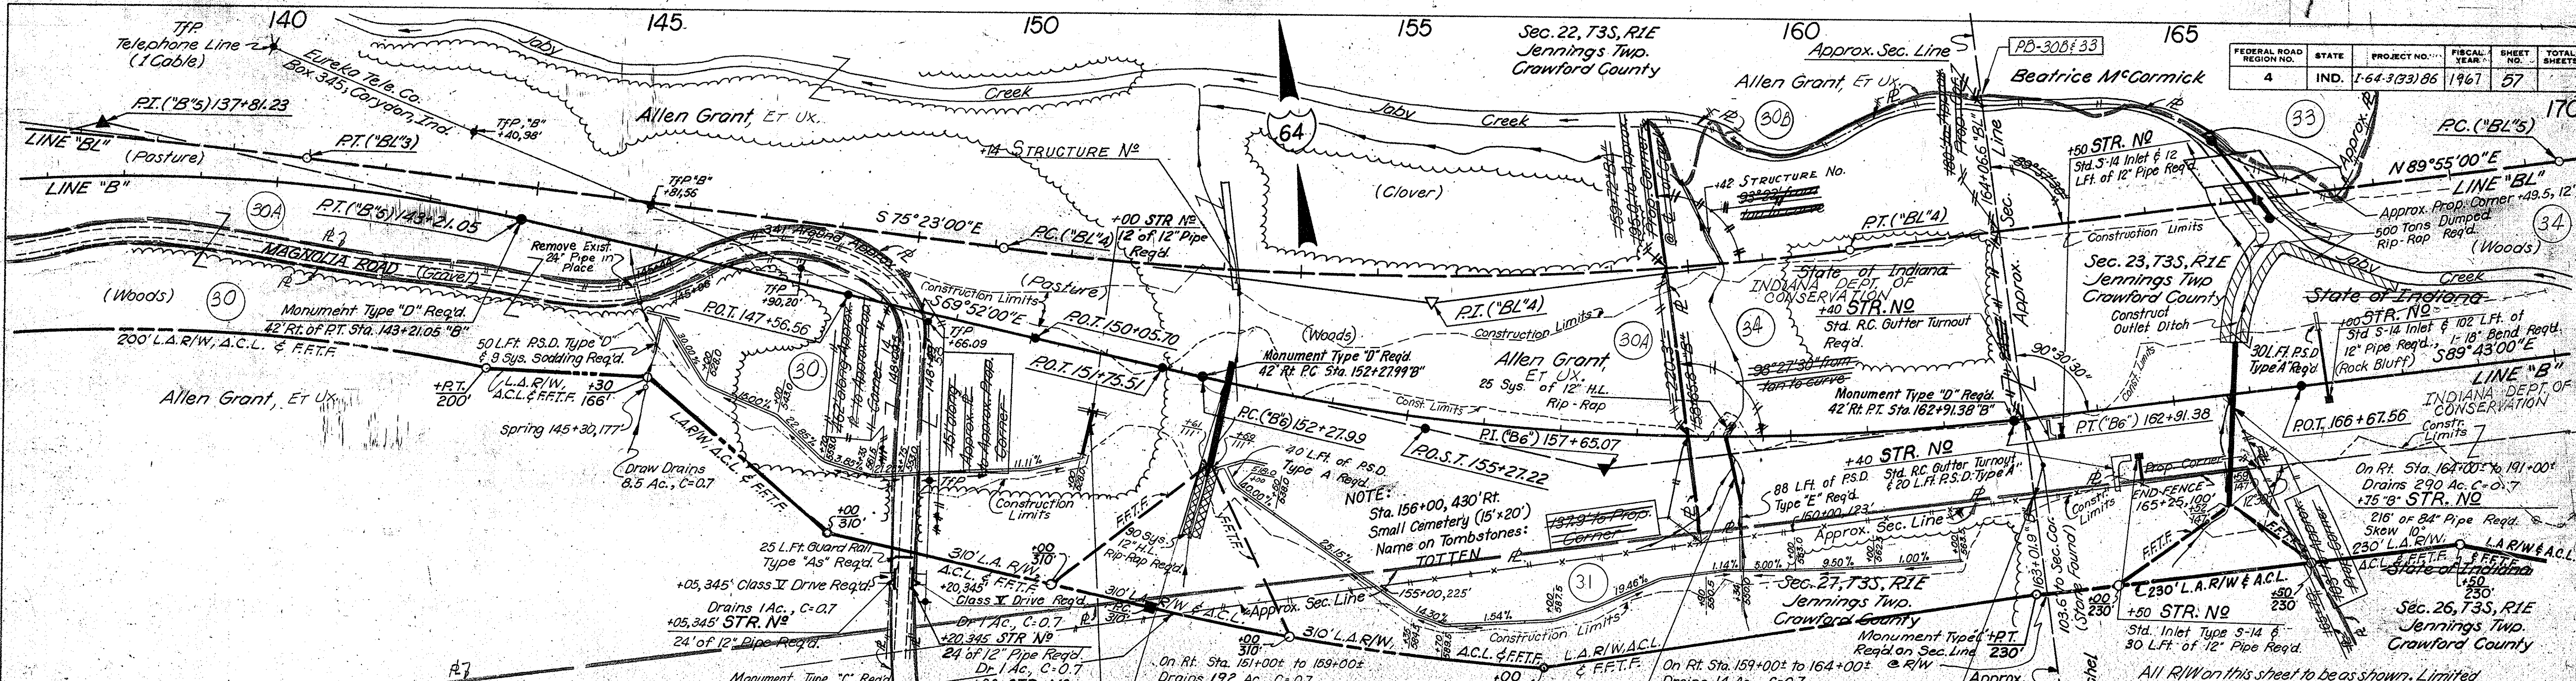


PLAN
 SURVEYED BY: J.F.H.C.
 NOTED BY: J.A.W.
 CHECKED BY: J.A.W.
 DATE: 1-66
 SHEET NO.: 57
 TOTAL SHEETS: 57

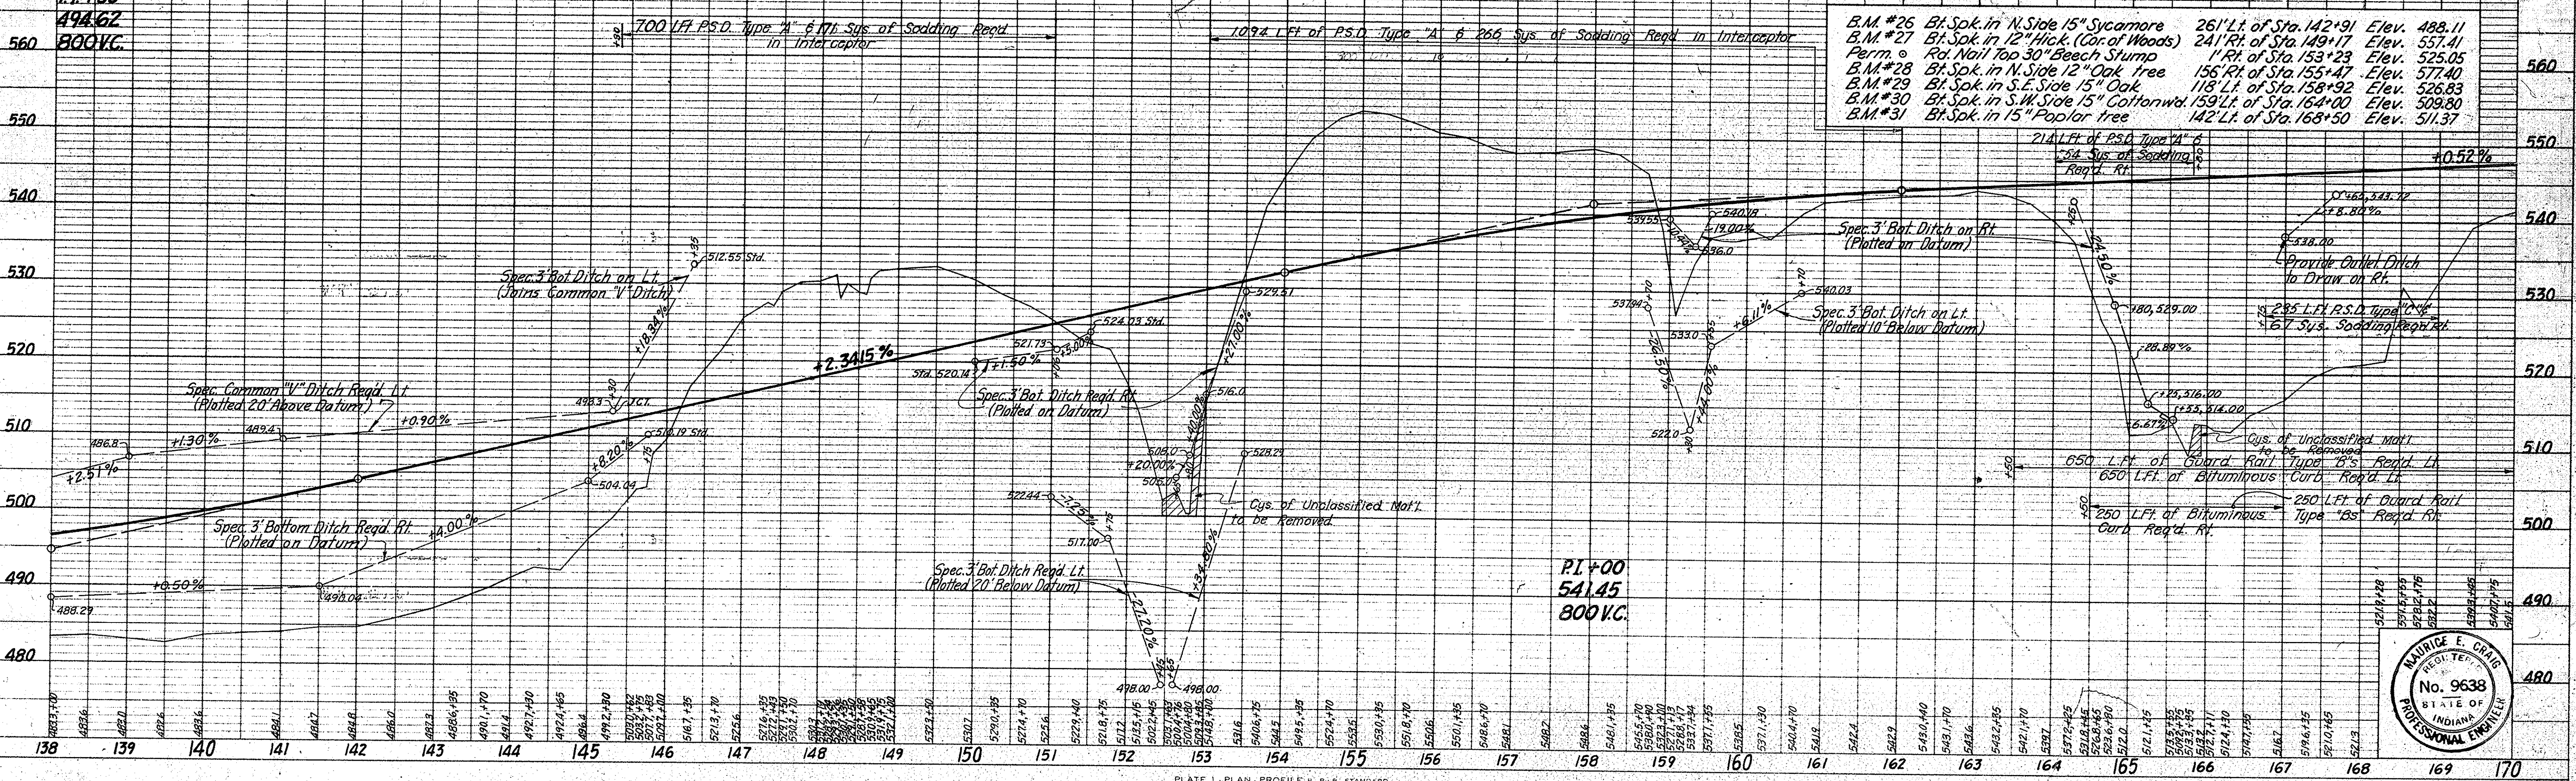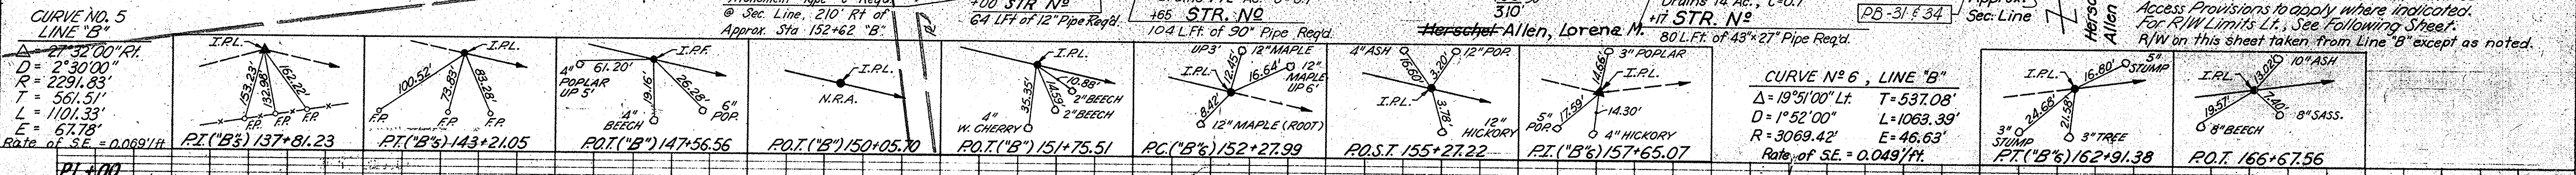

PROFILE
 SURVEYED BY: J.F.H.C.
 NOTED BY: J.A.W.
 CHECKED BY: J.A.W.
 DATE: 1-66
 SHEET NO.: 57
 TOTAL SHEETS: 57

PLATE 1 - PLAN PROFILE - R.R. STANDARD
 November 6, 1961

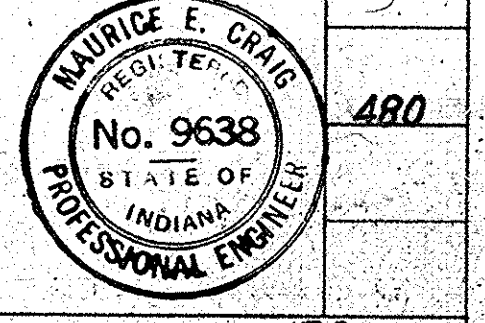

PUBLIC UTILITIES OWNERS

TELEPHONE SERVICE BY:

Eureka Telephone Co.
P.O. Box 345
Corydon, Indiana

ELECTRIC SERVICE BY:

DuBois R.E. Co.
Box 309
Jasper, Indiana

Harrison County R.E.M.C.
Corydon, Indiana

DATE	BY
3/6/66	K.E.L.C.
3/6/66	M.E.C.
3/6/66	P.D.G.
3/6/66	G.E.C.
3/6/66	B.G.C.

LEGEND

L.A. R/W ----- Limited Access Right-of-Way
A.C.L. ----- Access Control Line
R/W ----- Right-of-Way
F.F.T.F. ----- Farm Field Type Fence
C.L.T.F. ----- Chain Link Type Fence
■ ----- Right-of-Way Marker

PLAN SHEET REFERENCES

DESIGNATION	SHEET NO.
Line "B" Plan & Profile	63, 65 & 67
Line "BL" Plan & Profile	64, 66 & 68
Line "S-SR-66-B" Plan & Profile	98

INTERCHANGE SHEETS

DESIGNATION	SHEET NO.
Geometrics	119
Right-of-Way	120
Drainage & Construction	121
Ramp Grades	122 thru 128

PROFILE

DATE	BY
3/6/66	K.E.L.C.
3/6/66	M.E.C.
3/6/66	P.D.G.
3/6/66	G.E.C.
3/6/66	B.G.C.

GENERAL NOTES

Standard Divided Lane Sections for Federal Aid Interstate Projects adopted May 1964 as shown on Sheet N-1 to be used on this Project except Subbase shall be Type II only.

Standard Pavement Section E-11-JR Revised 3-11-61 as shown on Sheet N-2 to be used on this Project.

Standard 10' Pond Section Revised 6-30-65 to be used on this Project (Weight Station only).

Typical Cross Sections as shown on Sheets N-3 to be used on this Project.

Indiana State Highway Commission Standard Specifications dated 1963 to be used with this Project.

Standards under dates as listed in the Index on the Title Sheet to be used on this Project.

Grade Line as shown on Profile represents top of Finished Surface.

Balance N^s is feet long.

Balance S^s is feet long.

The Contractor must accept the plan quantities of Subbase as given on the Estimate of Quantities Sheet (See Special Provisions).

A Keyway Joint is to be constructed on Median side of each pavement.

All Ditches at 1% grade and over shall be sodded except where Ditch is in Rock Cut or where Paved Side Ditch is to be constructed.

All Earth Shoulders, Cut, and Fill slopes shall be plain or mulched seeded except where sodding is specified.

Sodding shall be placed along Paved Side Ditch as shown on Misc. Standard Sheet "B".

Excavation Quantities as shown on Plan and Profile sheets include estimated excavation for Public and Private Approaches. (See Table on Sheet N-148).

Curves on Mainline shall be Super-elevated as shown on Sheet N-140.

Curves on Wyoandotte Cave Rd, Beloit Co. Eas. N^s 2, 3 & 4 shall be Super-elevated as shown on Sheets N-143, 145, 146 & 147.


Quantities for Pipe Culvert Headwalls are based on using Standard Headwalls for retaining 2:1 or 3:1 slopes and Private Drive Headwalls for retaining 4:1 or flatter slopes.

For "Kinds of Pipe" permitted for each size and classification as shown on the Structure Data Sheet, see Misc. Standard Sheet "D".


All Limited Access R/W (L.A. R/W) to be fenced with Farm Field Type Fence (F.F.T.F.) as specified in the plans.

The minimum grade for "Subsurface Drains" shall be 0.20%. Where the profile grade is less than 0.20%, special grades for Subsurface Drains shall be established by the Engineer.

The final Cross Sections of the "Grading Contract" shall be the original Cross Sections of the "Paving Contract" except that partial or complete cross-sections shall be taken if necessary to determine the actual quantities of Excavation.

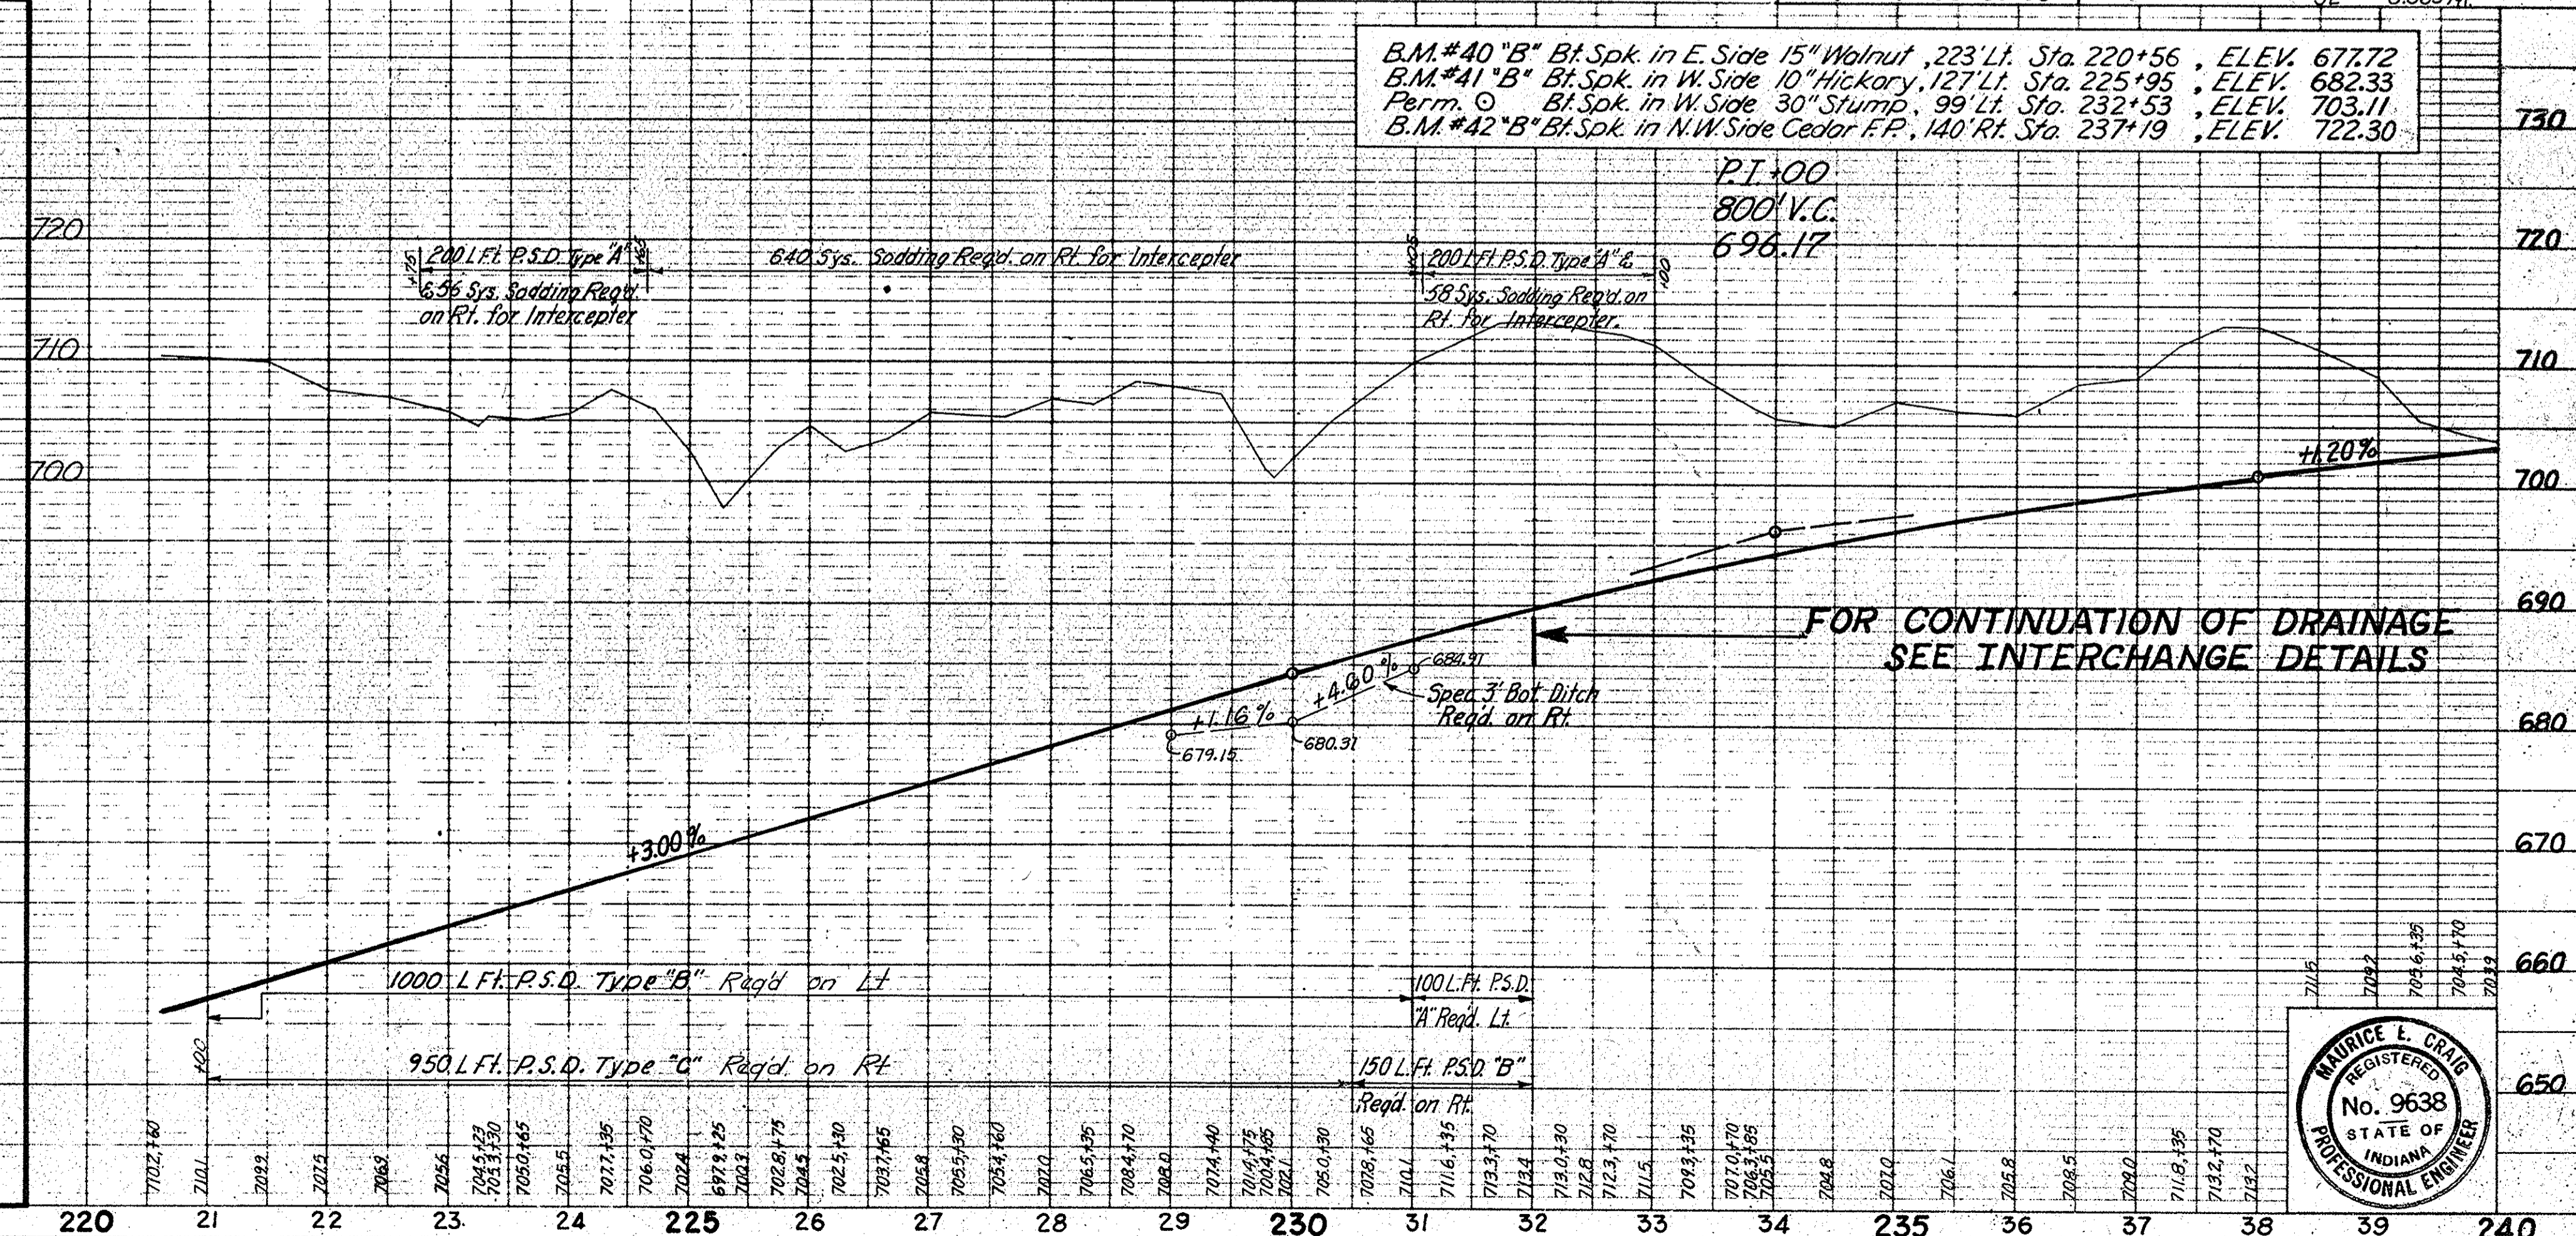

FEDERAL ROAD DISTRICT NO.	STATE	PROJECT NO.	FISCAL YEAR	SHEET NO.	TOTAL SHEETS
4	IND.	1-64-3(33)86	1967	63	240

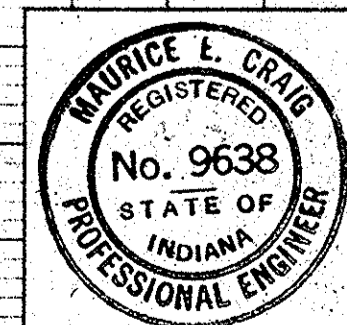

PROJECT NO.	LINE	SHEET NO.	TOTAL SHEETS	FILE
1-64-3(33)86	"B"	63		

FEDERAL ROAD REGION NO.	STATE	PROJECT NO.	FISCAL YEAR	SHEET NO.	TOTAL SHEETS
4	IND.	I-64-3(33)85	1967	64	

PUBLIC UTILITY OWNERS

TELEPHONE SERVICE BY:
Eureka Telephone Co.
P.O. Box 345
Corydon, Indiana

ELECTRIC SERVICE BY:
DuBois R.E. Co.
Box 309
Jasper, Indiana

Harrison County R.E.M.C.
Corydon, Indiana


DATE	BY	REVISION
7-1-66	M.E.C.	3-C.L.
7-1-66	M.E.C.	2-L.C.
7-1-66	M.E.C.	1-M.C.

PLAN SHEET REFERENCES	
DESIGNATION	SHEET NO.
Line "B" Plan & Profile	63, 65 & 67
Line "BL" Plan & Profile	64, 66 & 68
Line "S-S" 66-B" Plan & Profile	98
INTERCHANGE SHEETS	
DESIGNATION	SHEET NO.
Geometrics	119
Right-of-Way	120
Drainage & Construction	121
Intersection Details	122
Ramp Grooves	123 thru 128

GENERAL NOTES
SEE "B" LINE SHEET NO. 63

DATE	BY	REVISION
7-1-66	M.E.C.	3-C.L.
7-1-66	M.E.C.	2-L.C.
7-1-66	M.E.C.	1-M.C.

B.M. #40 "B" Bl. Spk. in E. Side 15" Walnut 223' Lt. Sta. 220+56	ELEV. 677.72
B.M. #41 "B" Bl. Spk. in W. Side 10" Hickory 127' Lt. Sta. 225+95	ELEV. 682.33
Perm. 0 Bl. Spk. in W. Side 30" Stump 99' Lt. Sta. 232+53	ELEV. 703.11
B.M. #42 "B" Bl. Spk. in N. Side Cedar F.P. 140' Rt. Sta. 237+19	ELEV. 722.30

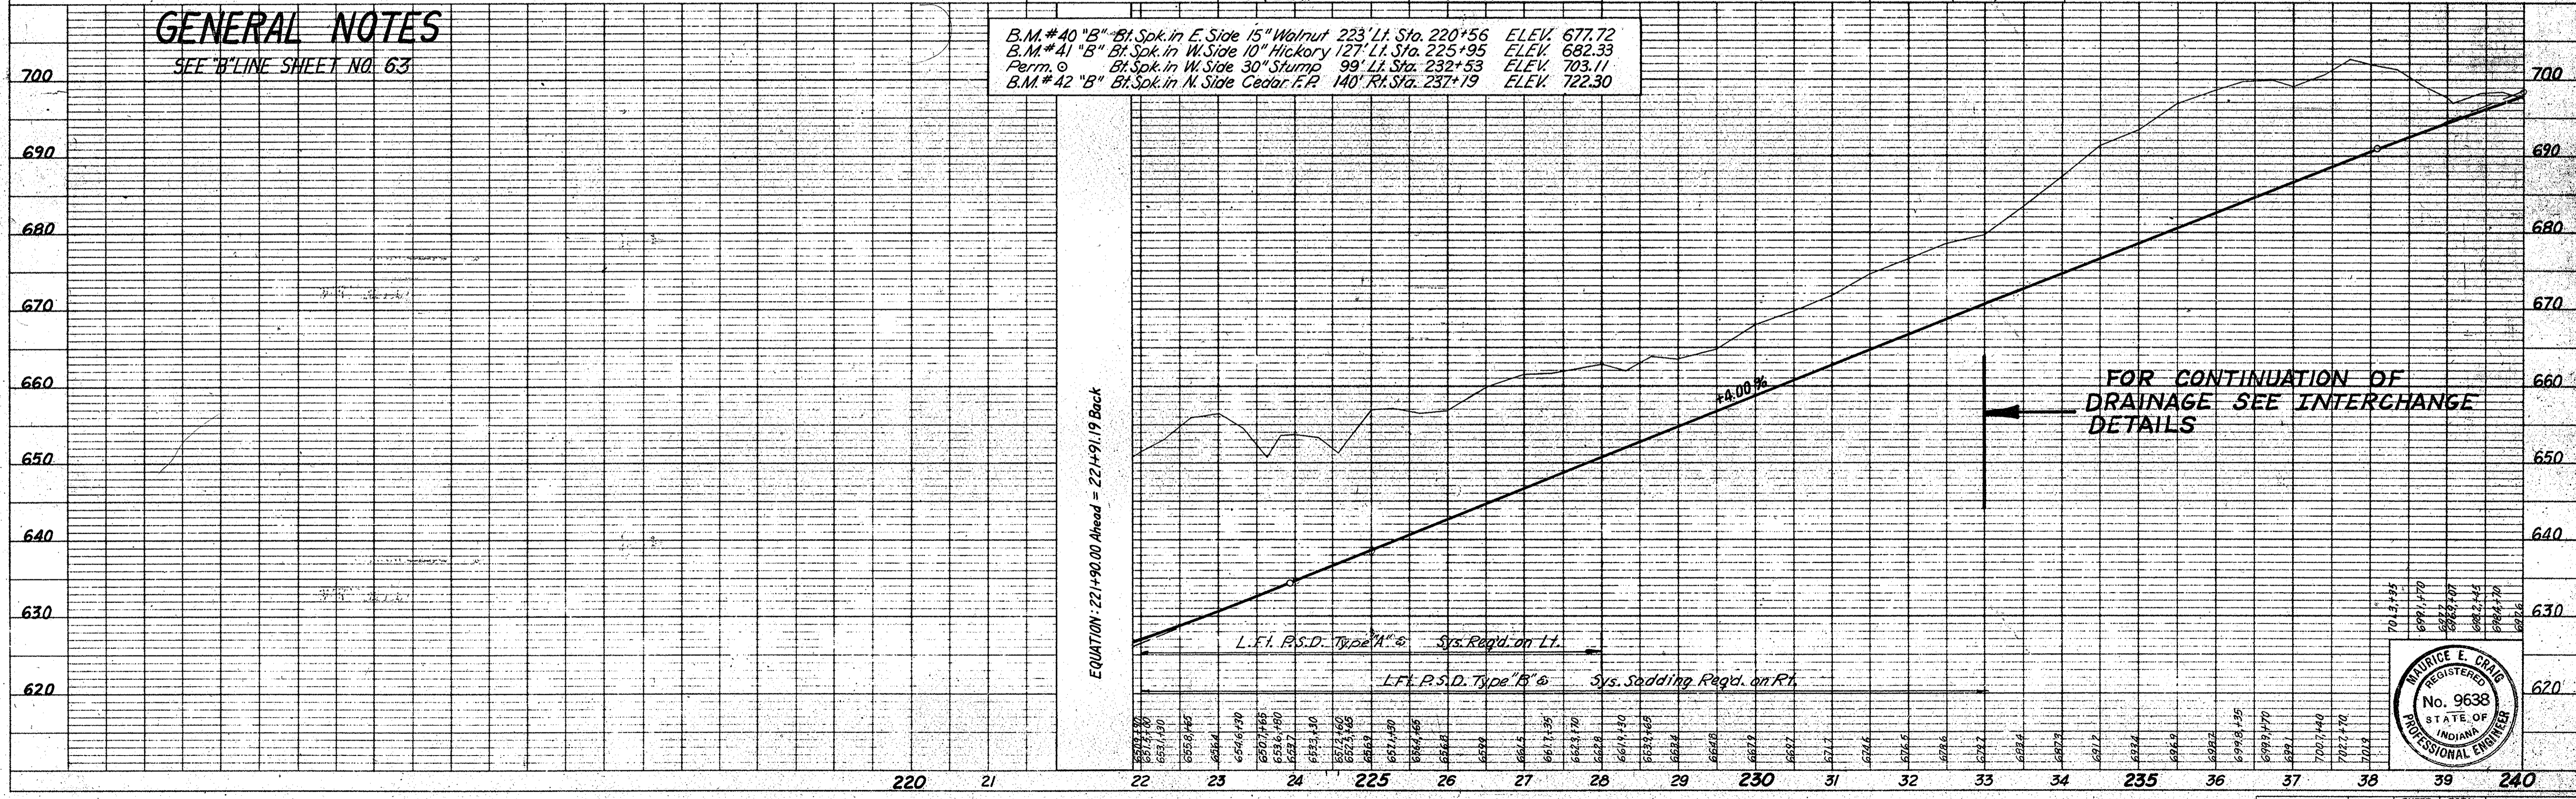

EQUATION: 221+90.00 Ahead = 224+91.19 Back



FEDERAL ROAD DISTRICT NO.	STATE	PROJECT NO.	FISCAL YEAR	SHEET NO.	TOTAL SHEETS
4	IND.	I-64-3(33)86	1967	65	


CURVE NO 10 LINE "B"
 $\Delta = 16^{\circ}43'00''$ Lt.
 $D = 1^{\circ}08'00''$
 $R = 5055.51'$
 $T = 742.78'$
 $L = 1475.00'$
 $E = 54.21'$
 Rate of Superlev. 0.028/ft.

All R/W on this sheet to be as shown. Limited Access Provisions to apply where indicated. For R/W Limits Lt., see following sheet. R/W on this sheet taken from Line "B" except as noted.


Towers Inc.
THE TOWER ORCHARDS, INC.

PLAN
 SURVEYED BY: J. S. H. C.
 DATE: 4-66
 CHECKED BY: P. M. C.
 DATE: 4-66
 NOTE BOOK NO. 9553-4
 STRUCTURE NOTATIONS CHECKED BY: G. E. C.
 DATE: 7-66


PLAN SHEET REFERENCES	
DESIGNATION	SHEET NO.
Line "B" Plan & Profile	63, 65, 66, 67
Line "BL" Plan & Profile	64, 66 & 68
Line "S-SR 66-B" Plan & Profile	98
INTERCHANGE SHEETS	
DESIGNATION	SHEET NO.
Geometrics	119
Right-of-Way	120
Drainage & Construction	121
Intersection Details	122
Ramp Grades	123 thru 128
Special N.E. Ramp Exit	129

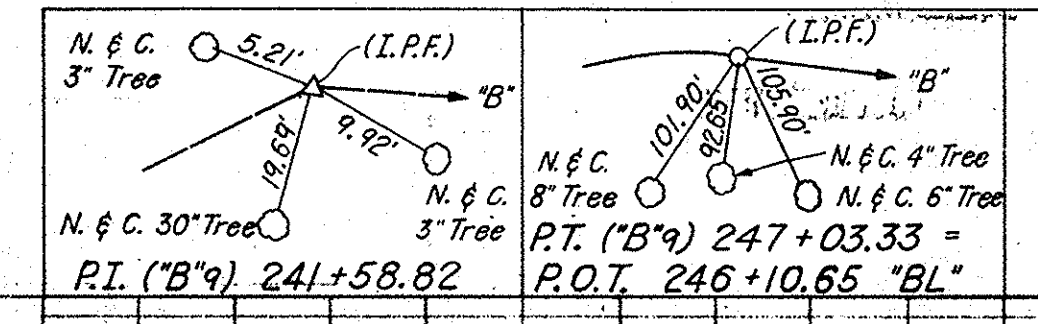

PROFILE
 SURVEYED BY: J. S. H. C.
 DATE: 4-66
 CHECKED BY: P. M. C.
 DATE: 4-66
 NOTE BOOK NO. 9553-4
 STRUCTURE NOTATIONS CHECKED BY: G. E. C.
 DATE: 7-66

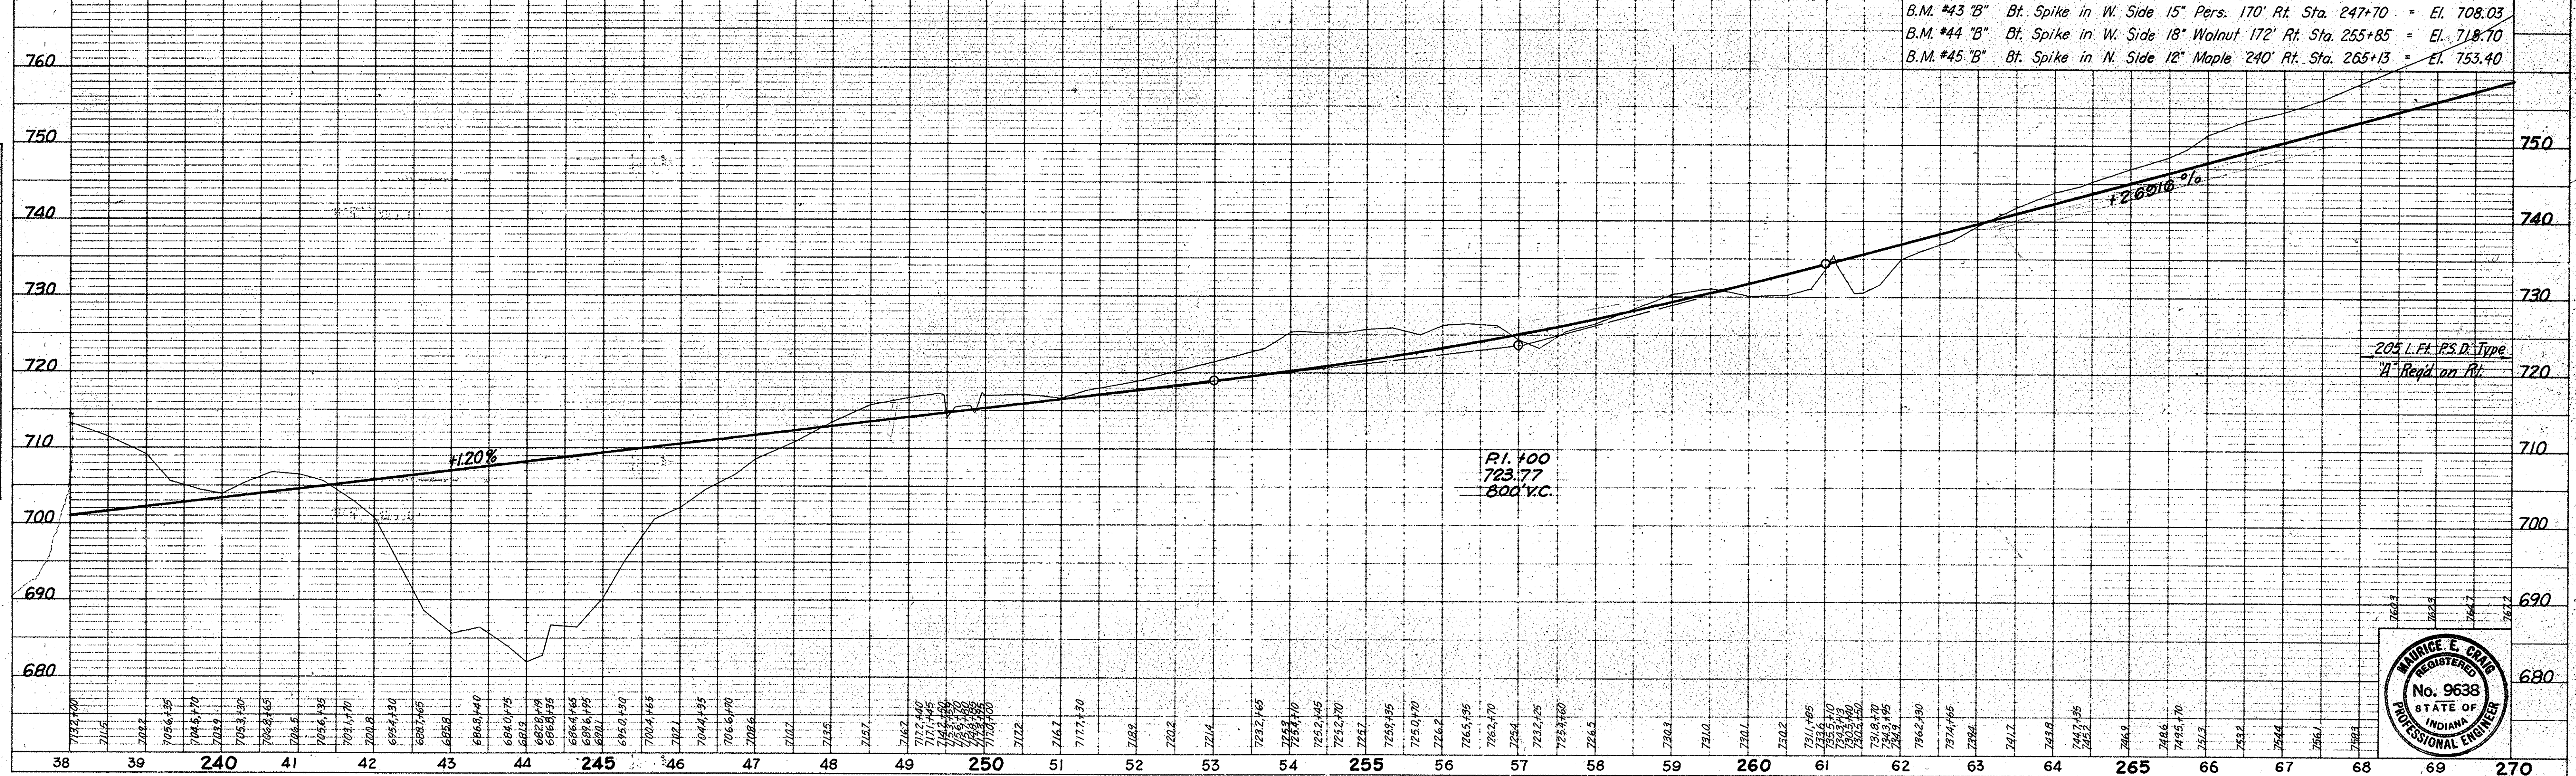

B.M. #43 "B" Bt. Spike in W. Side 15' Pers. 170' Rt. Sta. 247+70 = El. 708.03
 B.M. #44 "B" Bt. Spike in W. Side 18' Walnut 172' Rt. Sta. 255+85 = El. 718.70
 B.M. #45 "B" Bt. Spike in N. Side 12' Maple 240' Rt. Sta. 265+13 = El. 753.40

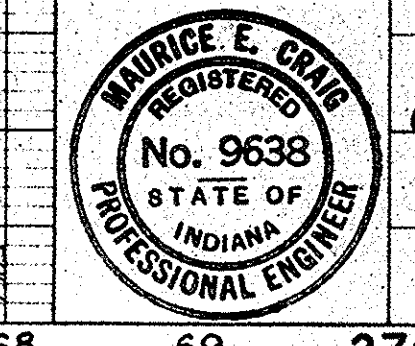


PROJECT NO.	LINE	SHEET NO.	TOTAL SHEETS	FILE
I-64-3(33)86	"B"	65		

FEDERAL ROAD REGION NO.	STATE	PROJECT NO.	FISCAL YEAR	SHEET NO.	TOTAL SHEETS
4	IND.	1-64-3(33)86	1967	66	

CURVE NO 8 LINE "BL"
 $\Delta = 17^{\circ}38'00''$ Lt
 $D = 1^{\circ}08'00''$
 $R = 5055.51'$
 $T = 784.14'$
 $L = 1555.88'$
 $E = 60.45'$
 Rate of Superelev. 0.028/ft.



All R/W on this sheet to be as shown. Limited Access Provisions to apply where indicated. For R/W Limits Rt. see preceding sheet. R/W on this sheet taken from Line "BL" except as noted.

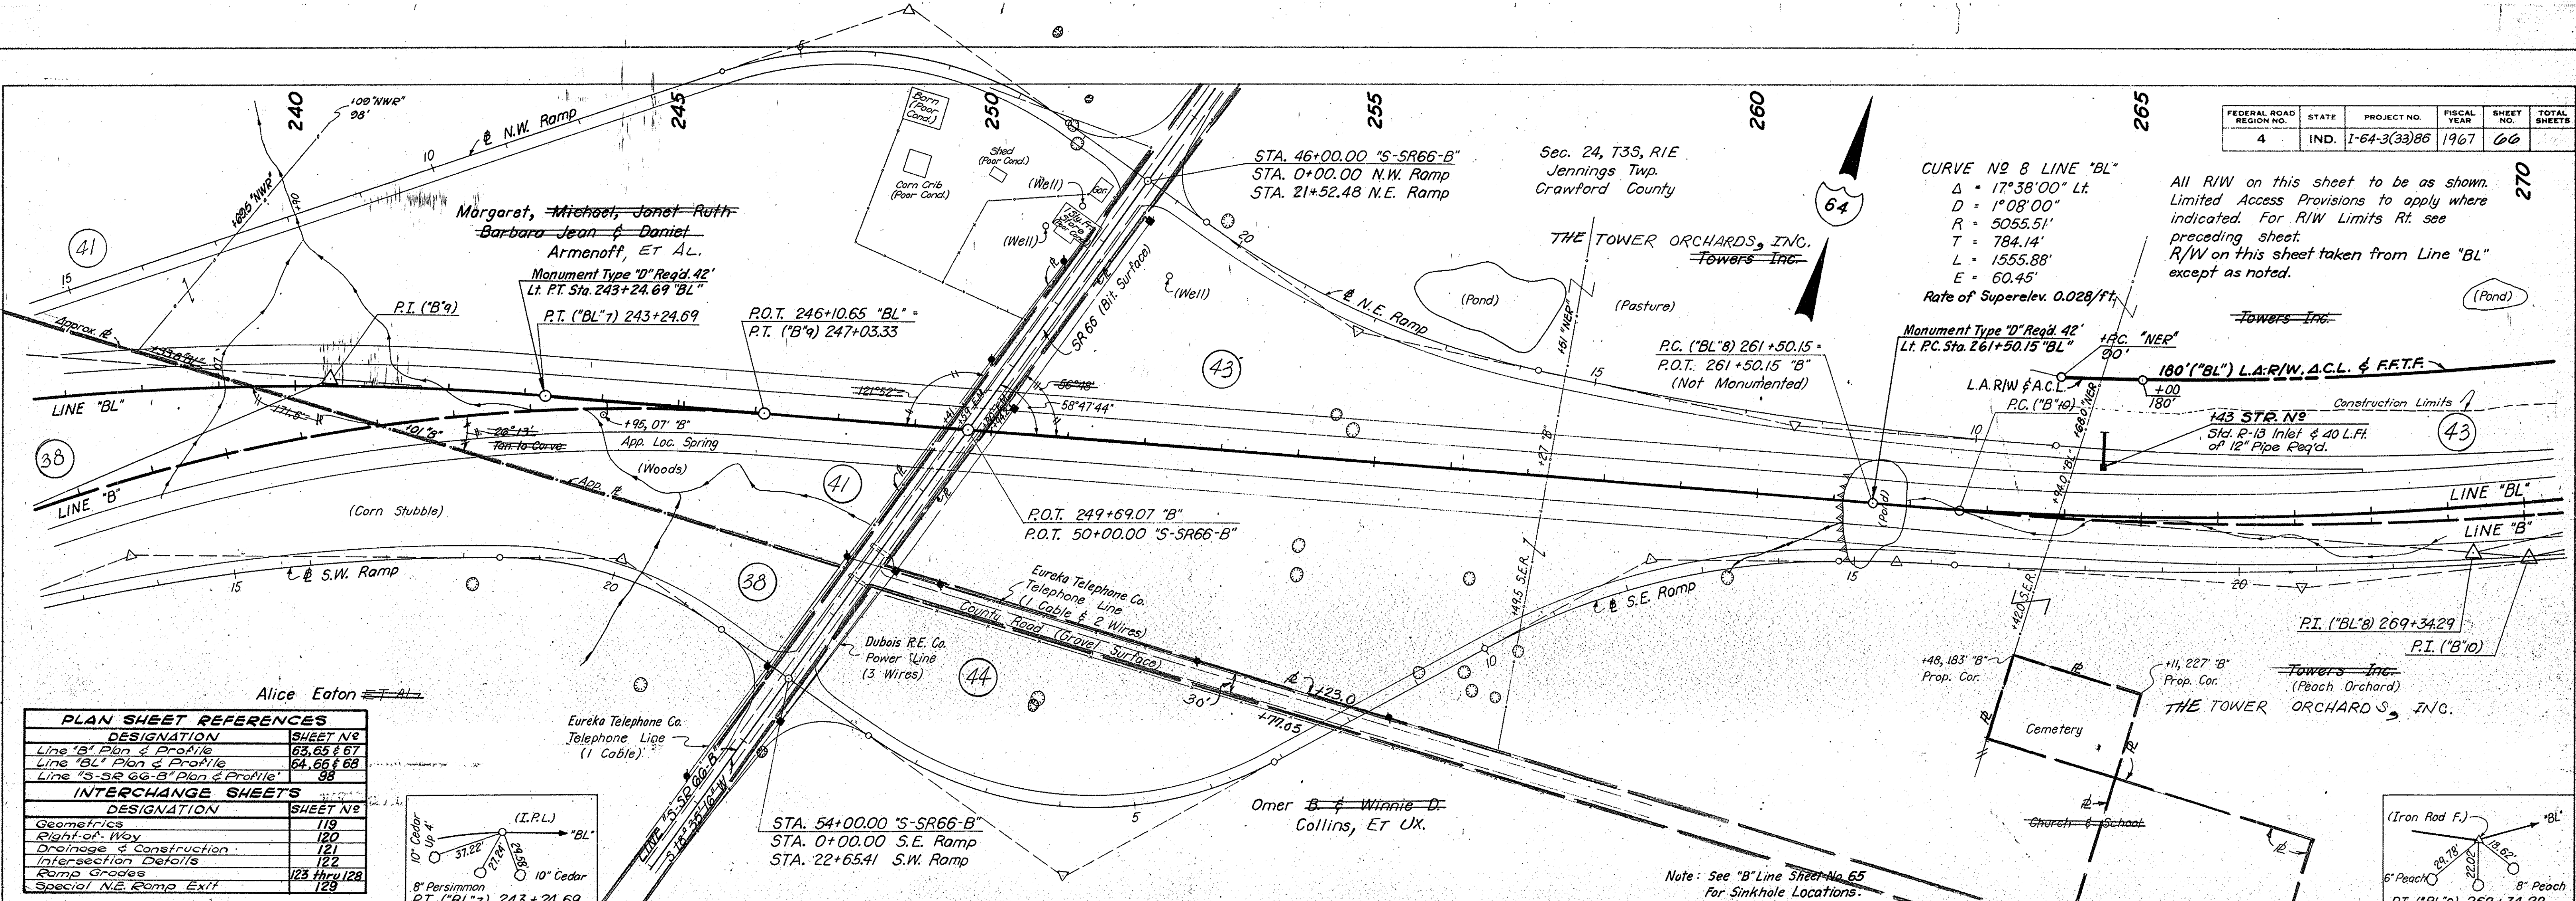

PLAN SHEET REFERENCES	
DESIGNATION	SHEET NO.
Line "B" Plan & Profile	63, 65 & 67
Line "BL" Plan & Profile	64, 66 & 68
Line "S-SR 66-B" Plan & Profile	98
INTERCHANGE SHEETS	
DESIGNATION	SHEET NO.
Geometrics	119
Right-of-Way	120
Drainage & Construction	121
Intersection Details	122
Ramp Grades	123 thru 128
Special N.E. Ramp Exit	129

DATE: 1-26-66
 BY: J.S.H.C.
 CHECKED: P.E.D.
 NO. 9283-1-1 STRUCTURE NOTATIONS CHECKED: M.E.C.

DATE: 1-26-66
 BY: J.S.H.C.
 CHECKED: P.E.D.
 NO. 9283-1-1 STRUCTURE NOTATIONS CHECKED: M.E.C.

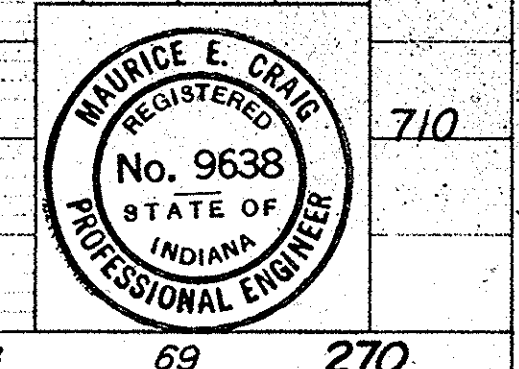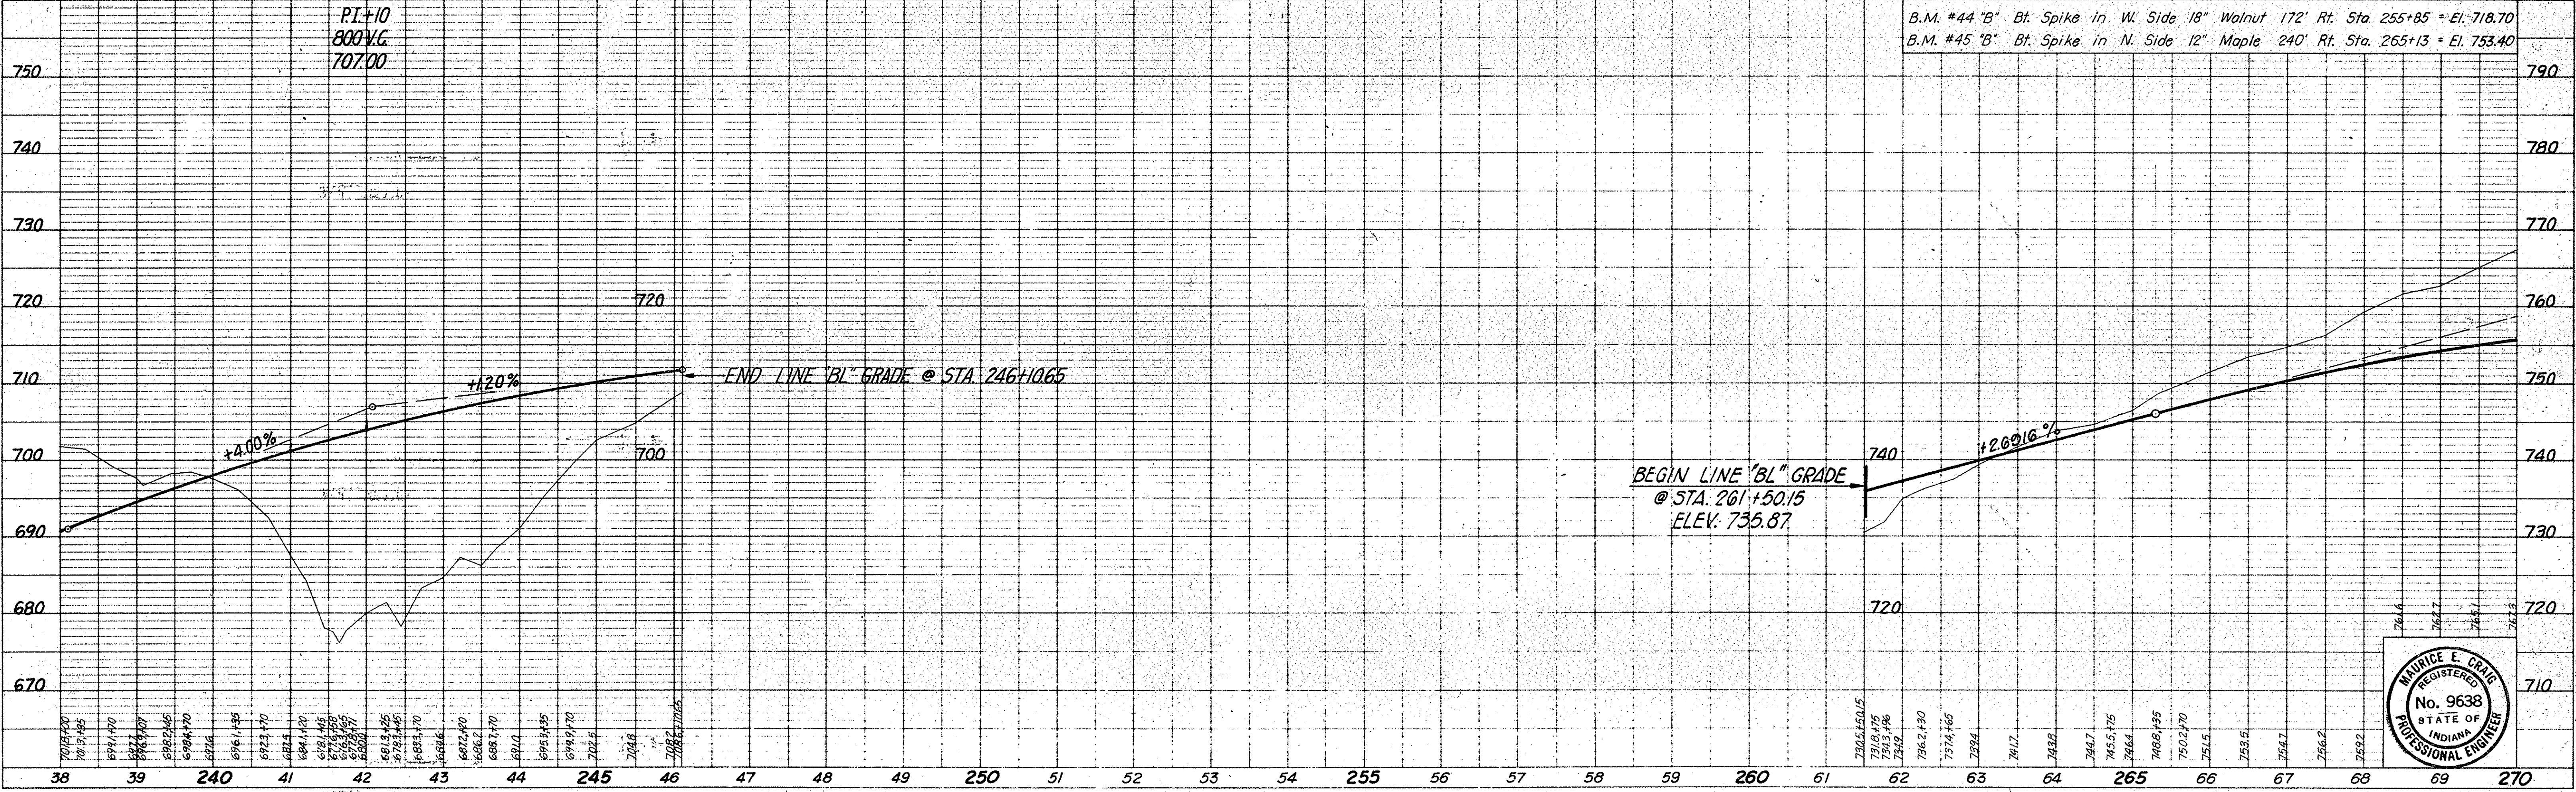


PROJECT NO.	LINE	SHEET NO.	TOTAL SHEETS	FILE
1-64-3(33)86	BL	66		

FEDERAL ROAD REGION NO.	STATE	PROJECT NO.	FISCAL YEAR	SHEET NO.	TOTAL SHEETS
4	IND.	F-64-3 (33) 86	1967	67	












PLAN
SURVEYED BY: F. B. SMITH
NOTED BY: J. L. G.
NOTE BOOK NO. 53522-4
DATE: 11/66

PROFILE
SURVEYED BY: F. B. SMITH
NOTED BY: J. L. G.
NOTE BOOK NO. 53522-4
DATE: 11/66

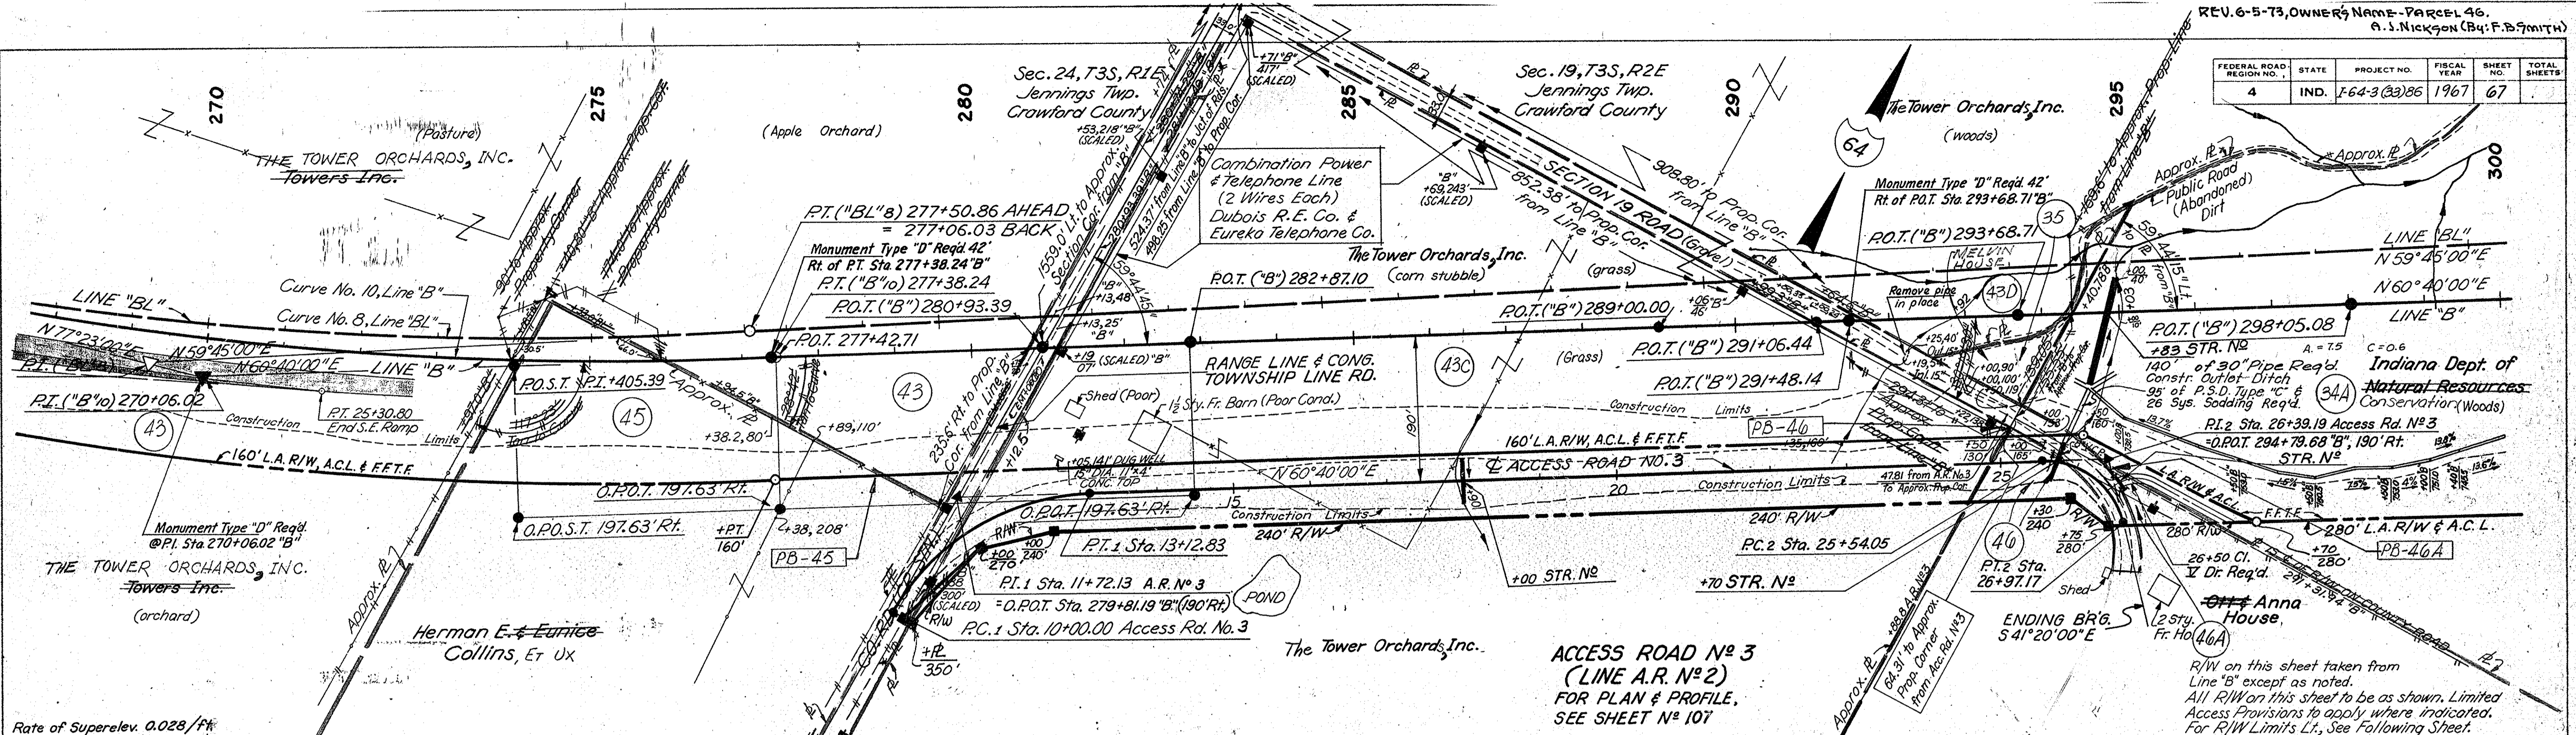

Rate of Superlev. 0.028/Ft
CURVE NO. 10, LINE "B"

$\Delta = 16^{\circ}43'00''$ Lt.
 $D = 1^{\circ}08'00''$
 $R = 5055.51'$
 $T = 742.78'$
 $L = 1475.00'$
 $E = 54.27'$

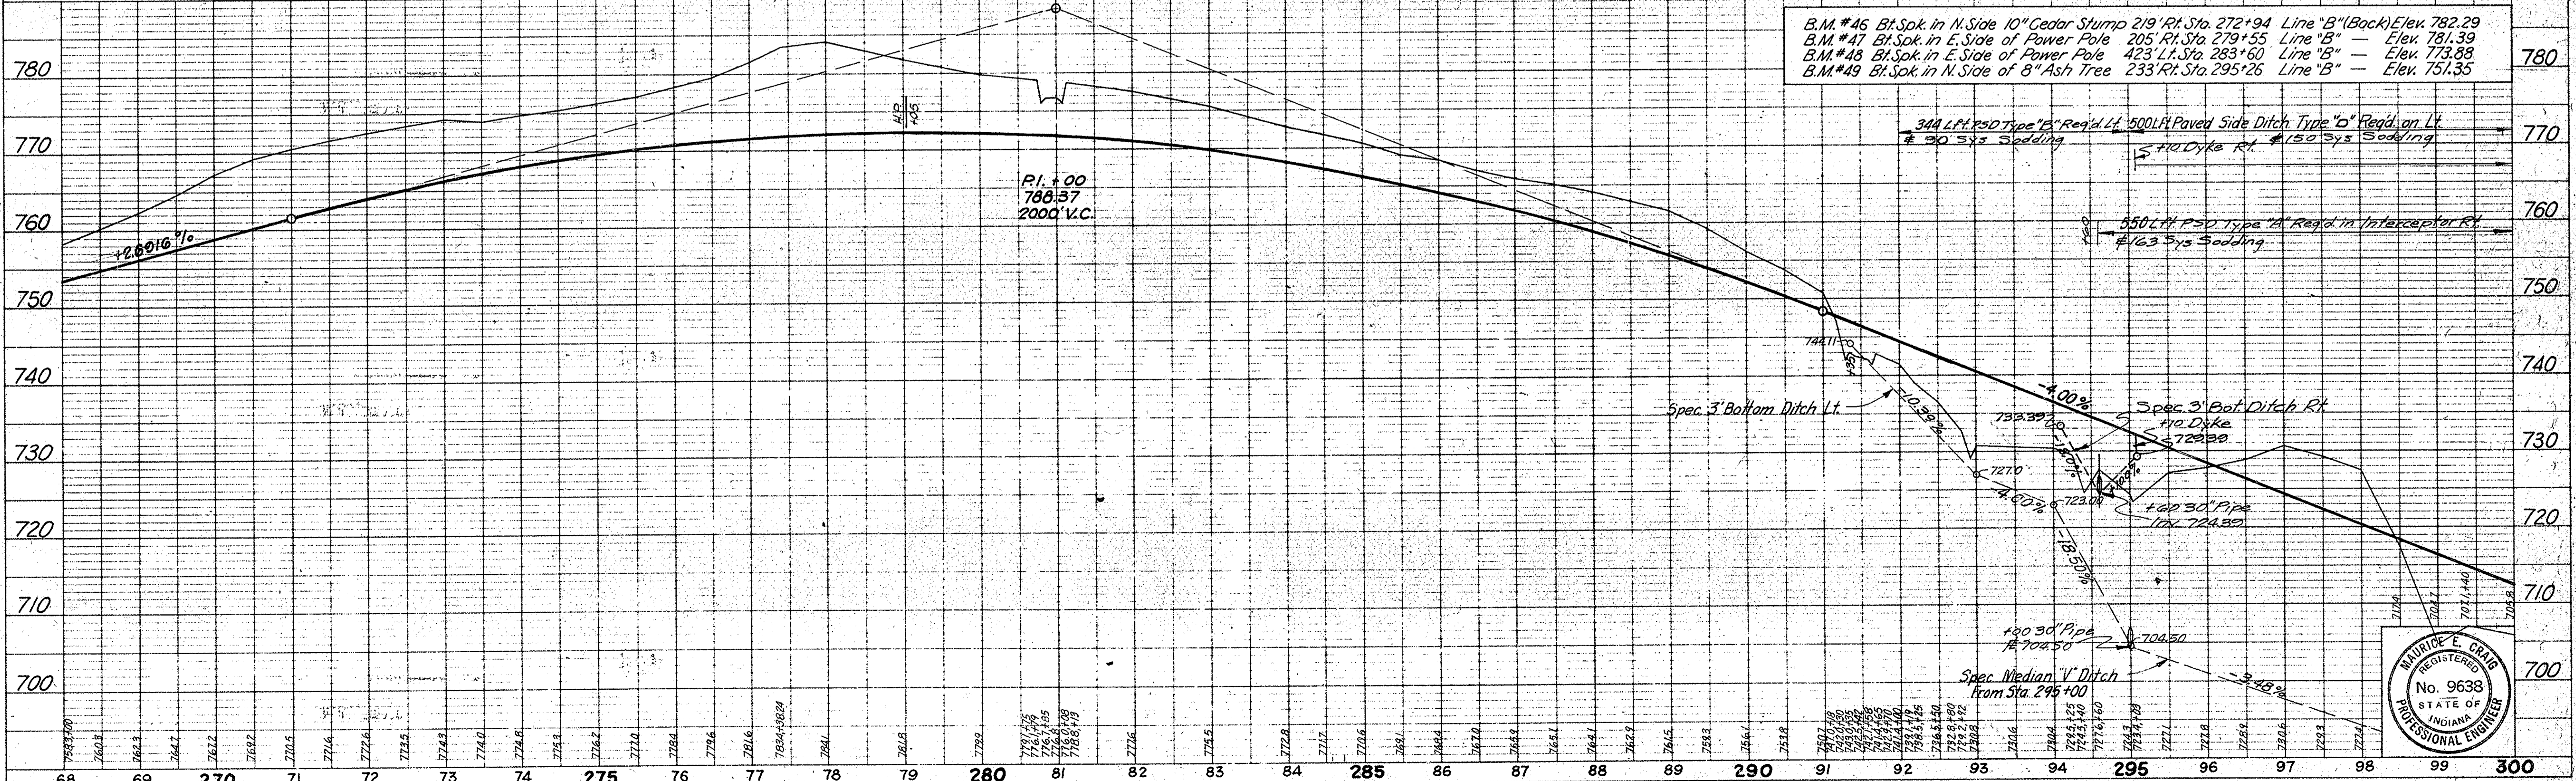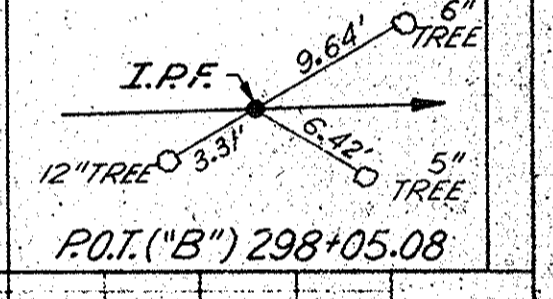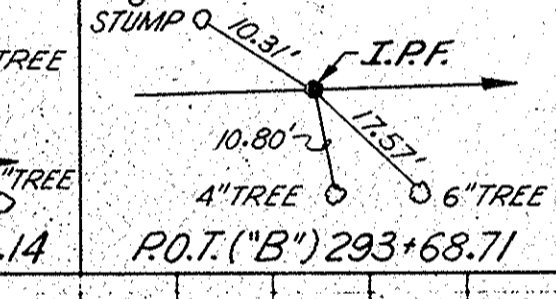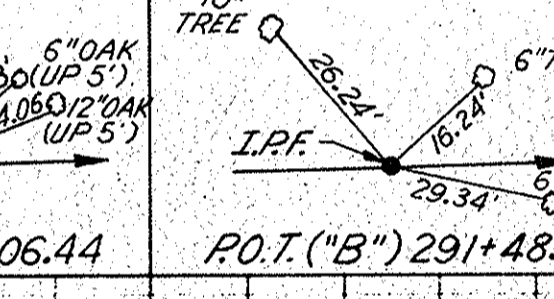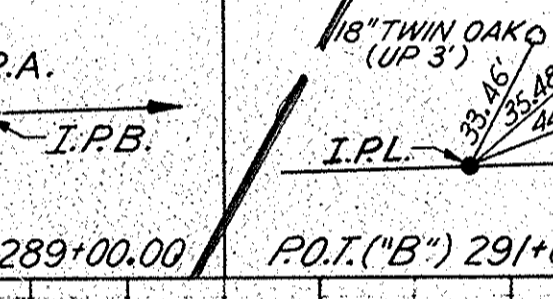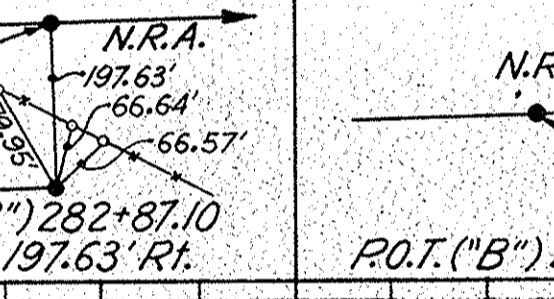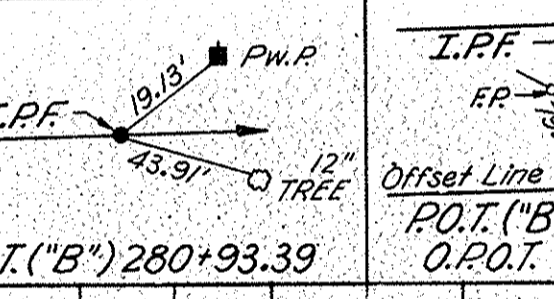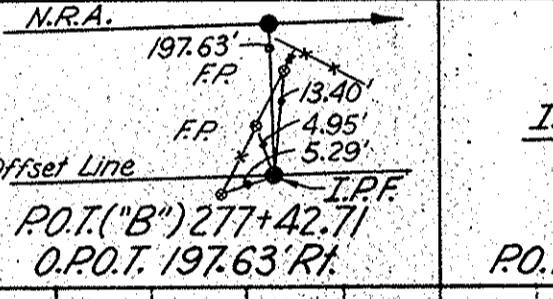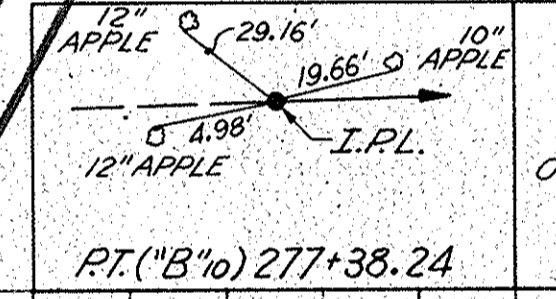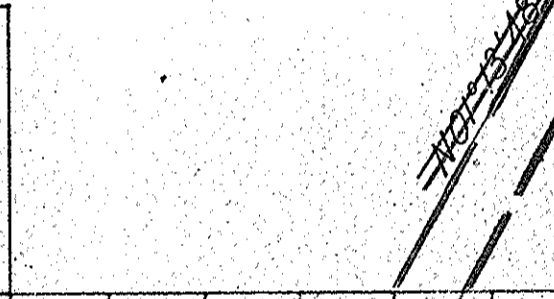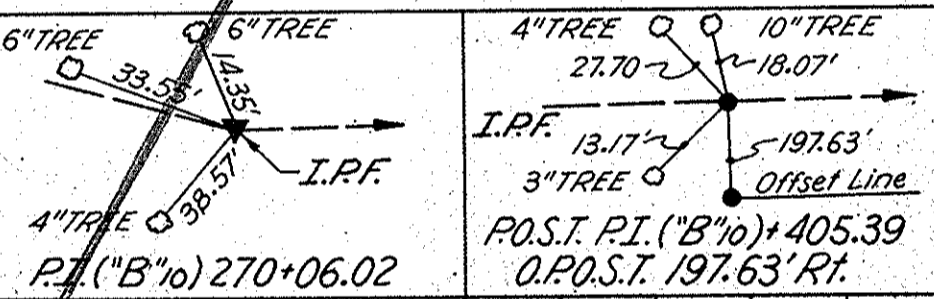

B.M. #46 Bl. Spk. in N. Side 10" Cedar Stump 219' Rt. Sta. 272+94 Line "B" (Back) Elev. 782.29
B.M. #47 Bl. Spk. in E. Side of Power Pole 205' Rt. Sta. 279+55 Line "B" - Elev. 781.39
B.M. #48 Bl. Spk. in E. Side of Power Pole 423' Lt. Sta. 283+60 Line "B" - Elev. 773.88
B.M. #49 Bl. Spk. in N. Side of 8" Ash Tree 233' Rt. Sta. 295+26 Line "B" - Elev. 751.35




MATRICE E. GRAB
REGISTERED
STATE OF INDIANA
PROFESSIONAL ENGINEER
No. 9638

PROJECT NO.	LINE	SHEET NO.	TOTAL SHEETS	FILE
F-64-3 (33) 86	"B"	67		

FEDERAL ROAD DISTRICT NO.	STATE	PROJECT NO.	FISCAL YEAR	SHEET NO.	TOTAL SHEETS
4	IND.	I-64-3(33)86	1967	68	

PLAN
 SURVEYED BY: G. S. L. C.
 DATE: 7-66
 NOTE BOOK: 7-66
 NO. 2-43-347 OF WAY CHECKED: M. E. C.
 NO. 2-43-347 OF WAY CHECKED: R. D. L.

PROFILE
 SURVEYED BY: G. S. L. C.
 DATE: 7-66
 NOTE BOOK: 7-66
 NO. 2-43-347 OF WAY CHECKED: M. E. C.
 NO. 2-43-347 OF WAY CHECKED: R. D. L.

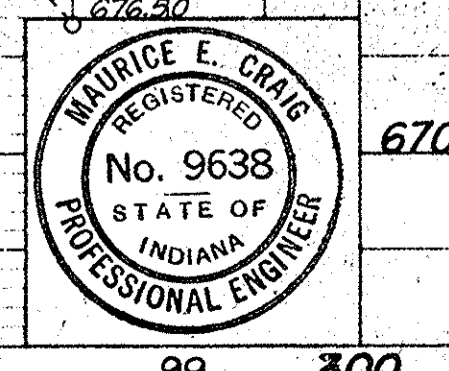
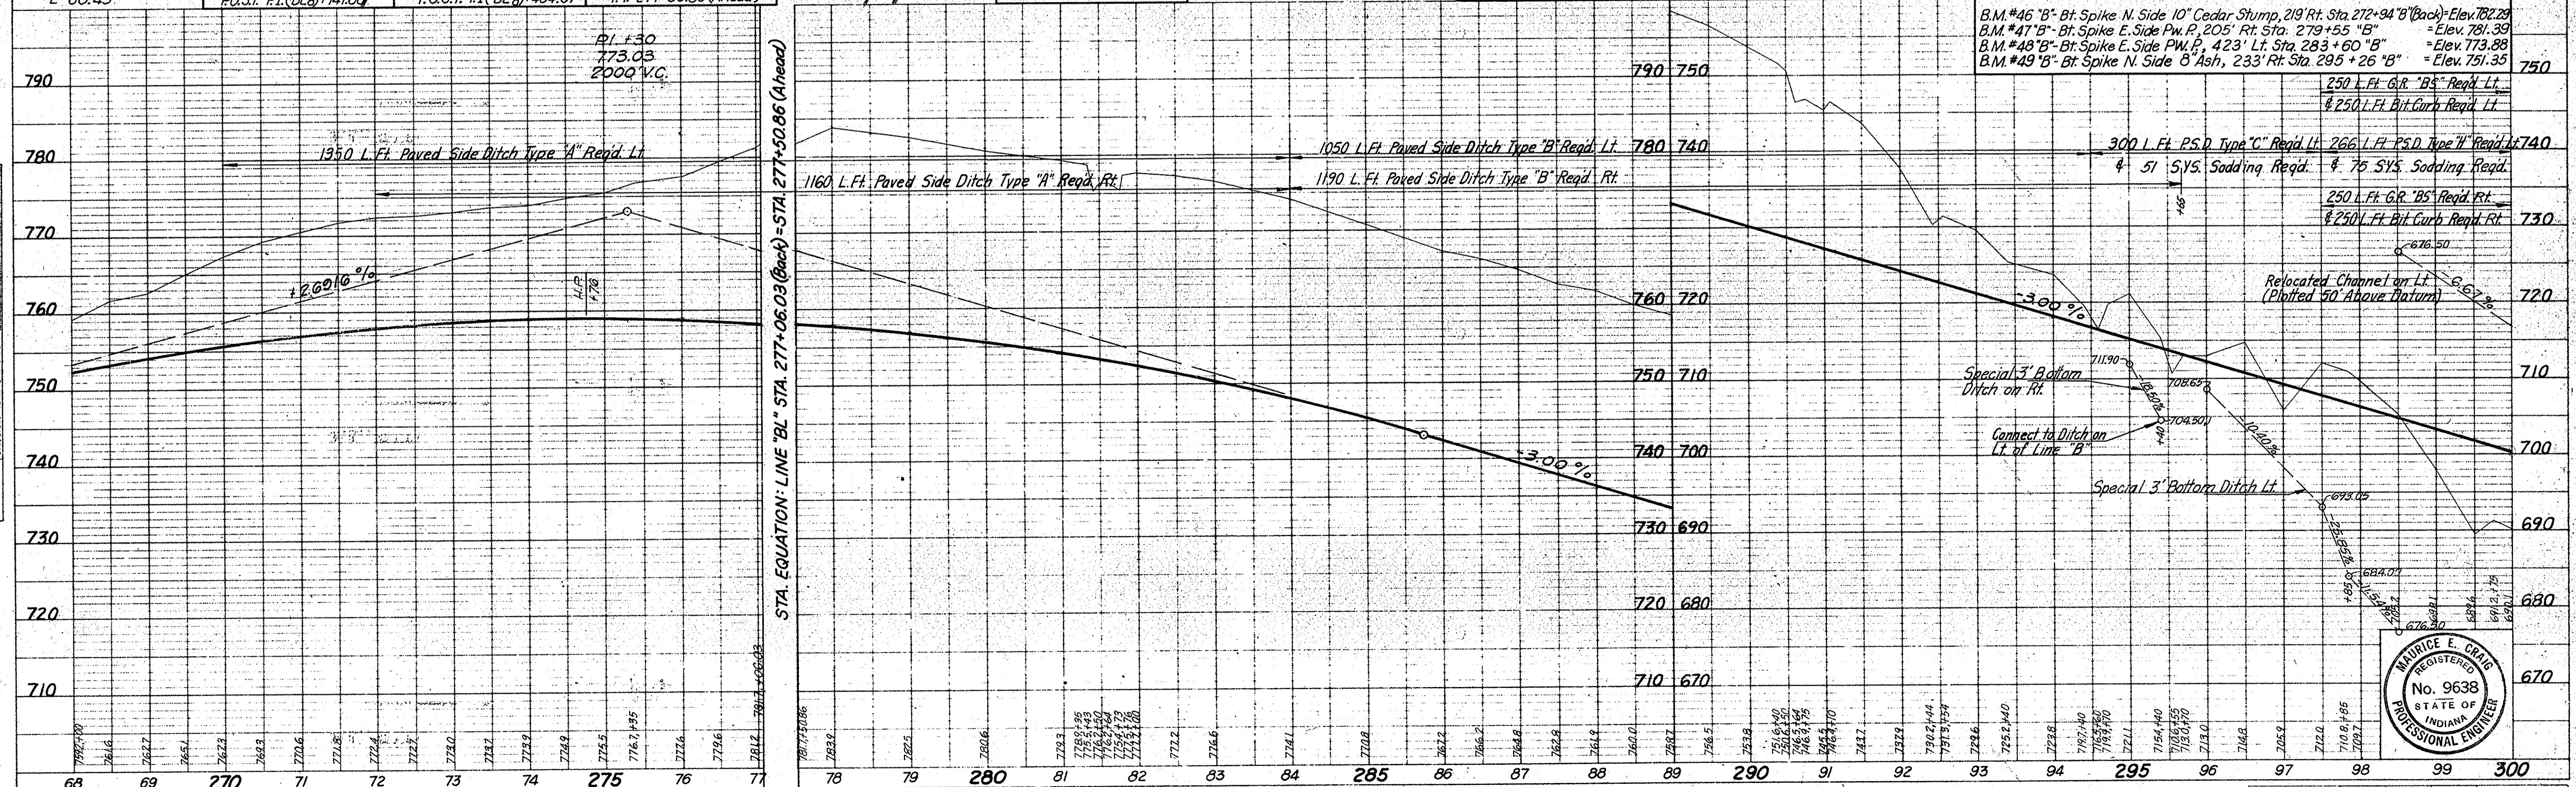
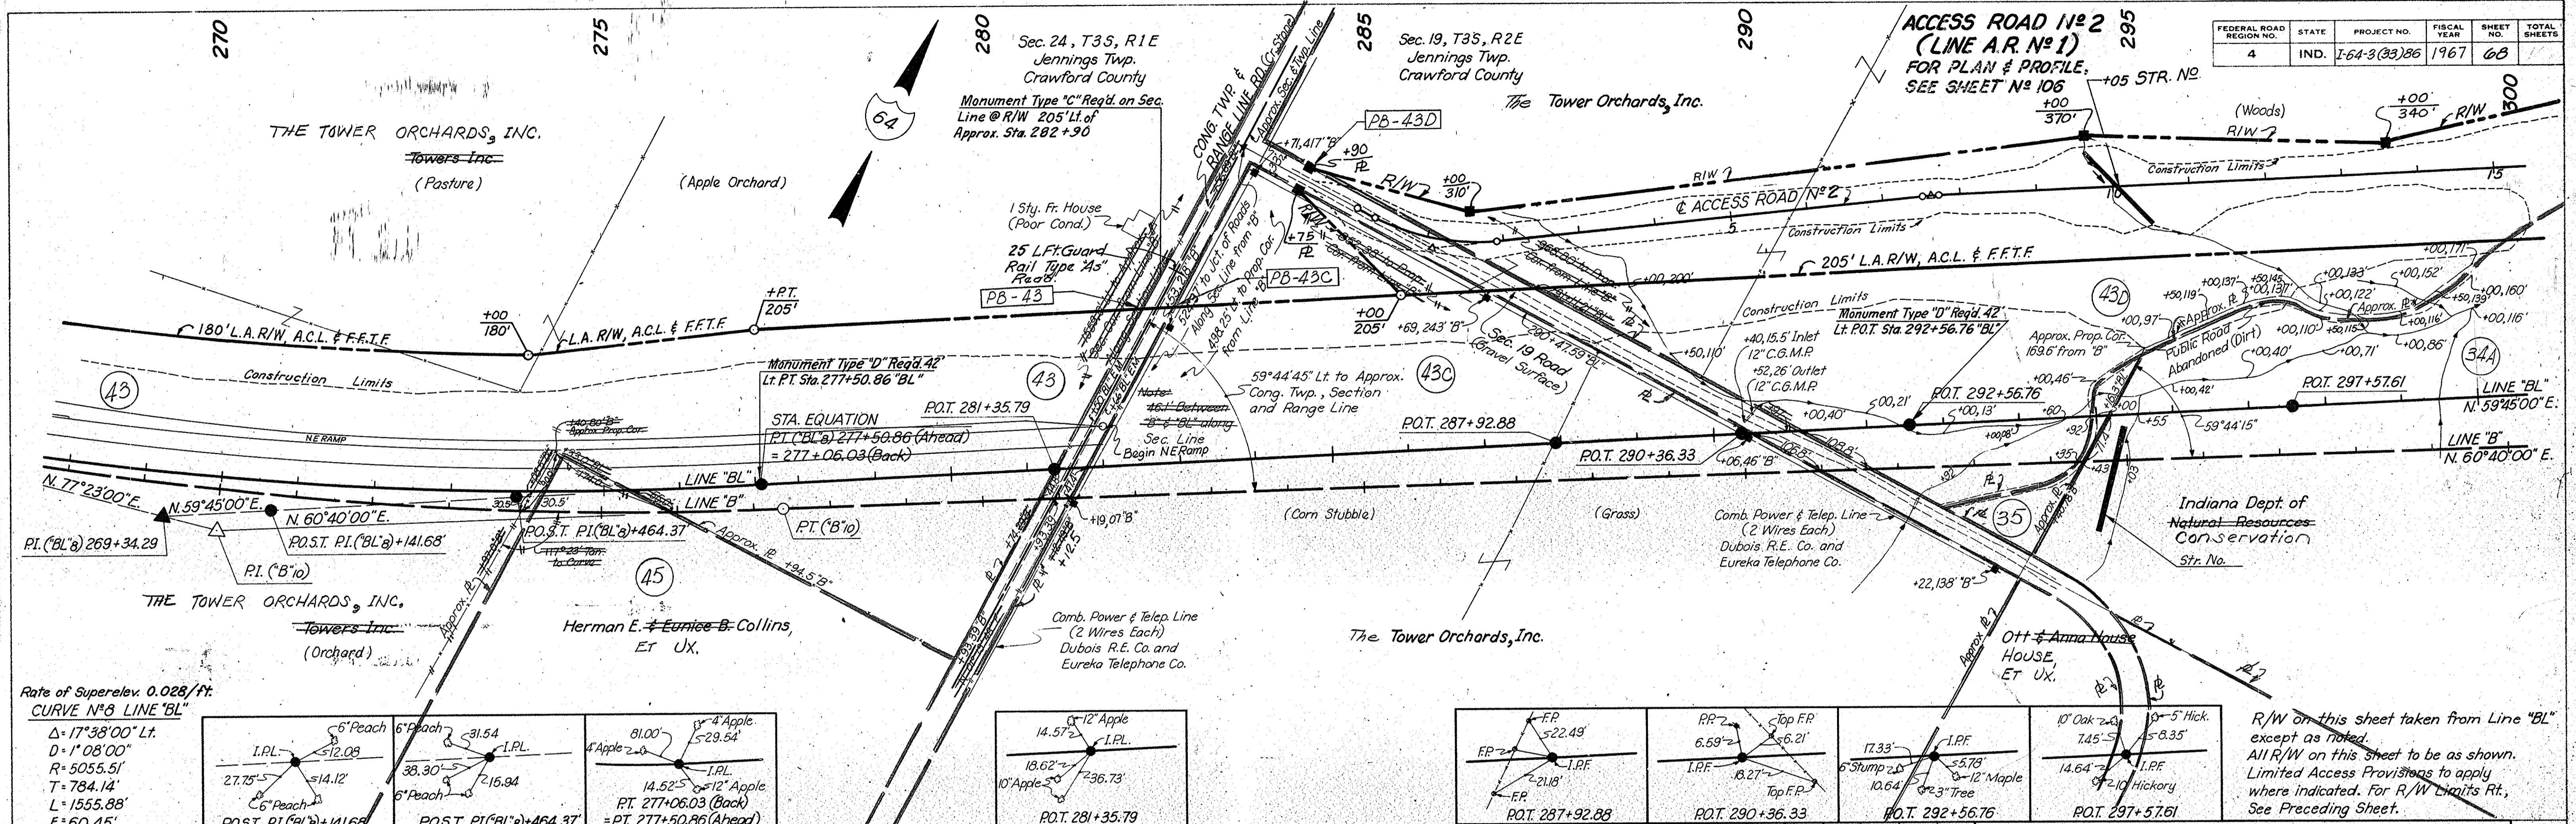


PROJECT NO.	LINE	SHEET NO.	TOTAL SHEETS	FILE
I-64-3(33)86	"BL"	68		

FEDERAL ROAD REGION NO.	STATE	PROJECT NO.	FISCAL YEAR	SHEET NO.	TOTAL SHEETS
4	IND.	164-3(3)86	1967	70	

DATE	BY	REVISION
5-6-66	A.P.C.	1. P.L.C.
7-6-66	A.P.C.	2. P.L.C.
7-6-66	A.P.C.	3. P.L.C.

DATE	BY	REVISION
5-6-66	A.P.C.	1. P.L.C.
7-6-66	A.P.C.	2. P.L.C.
7-6-66	A.P.C.	3. P.L.C.

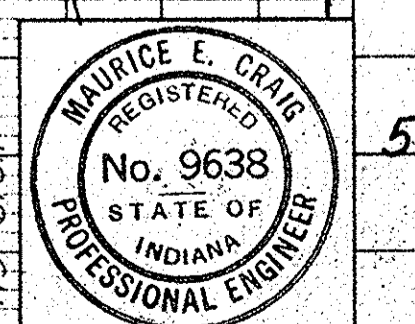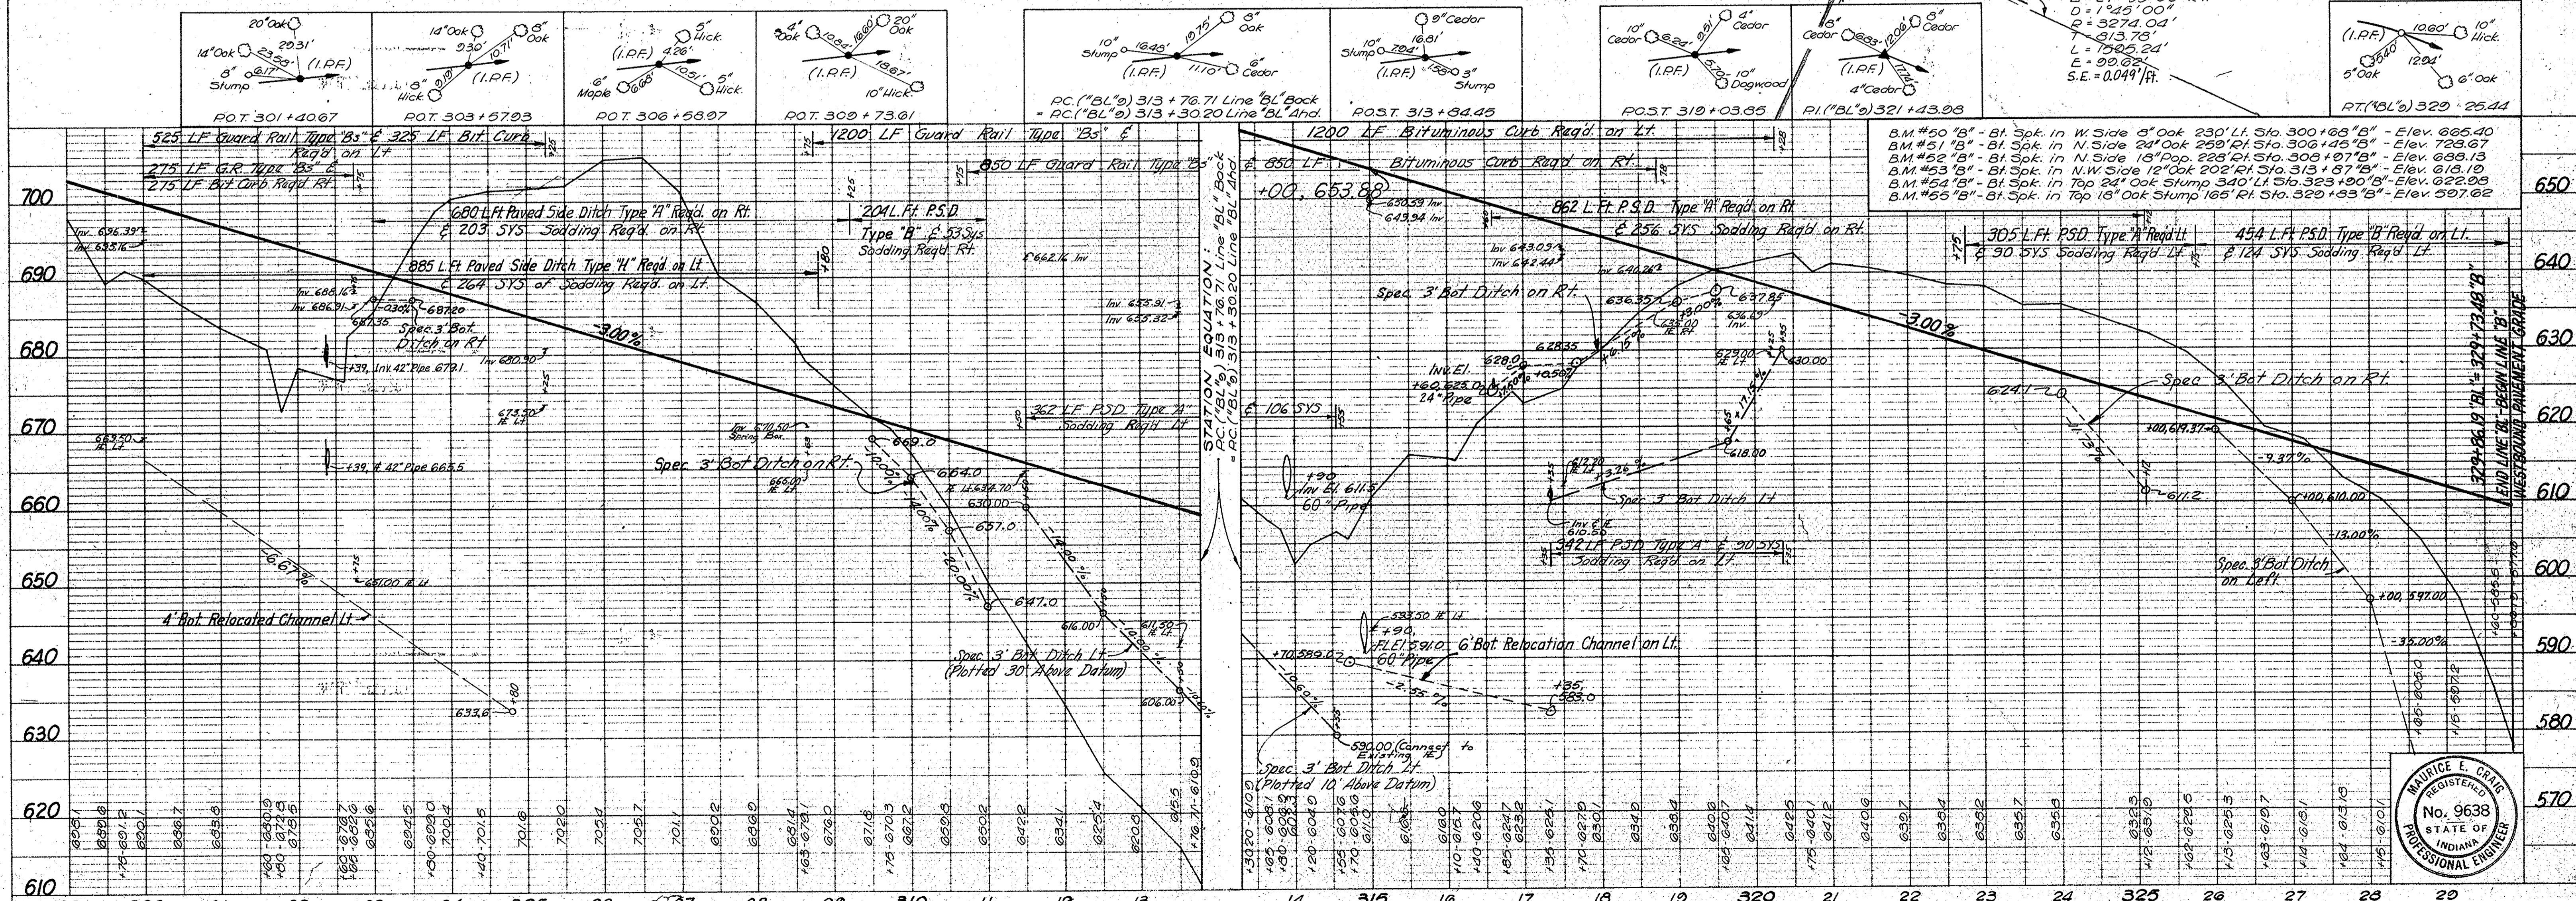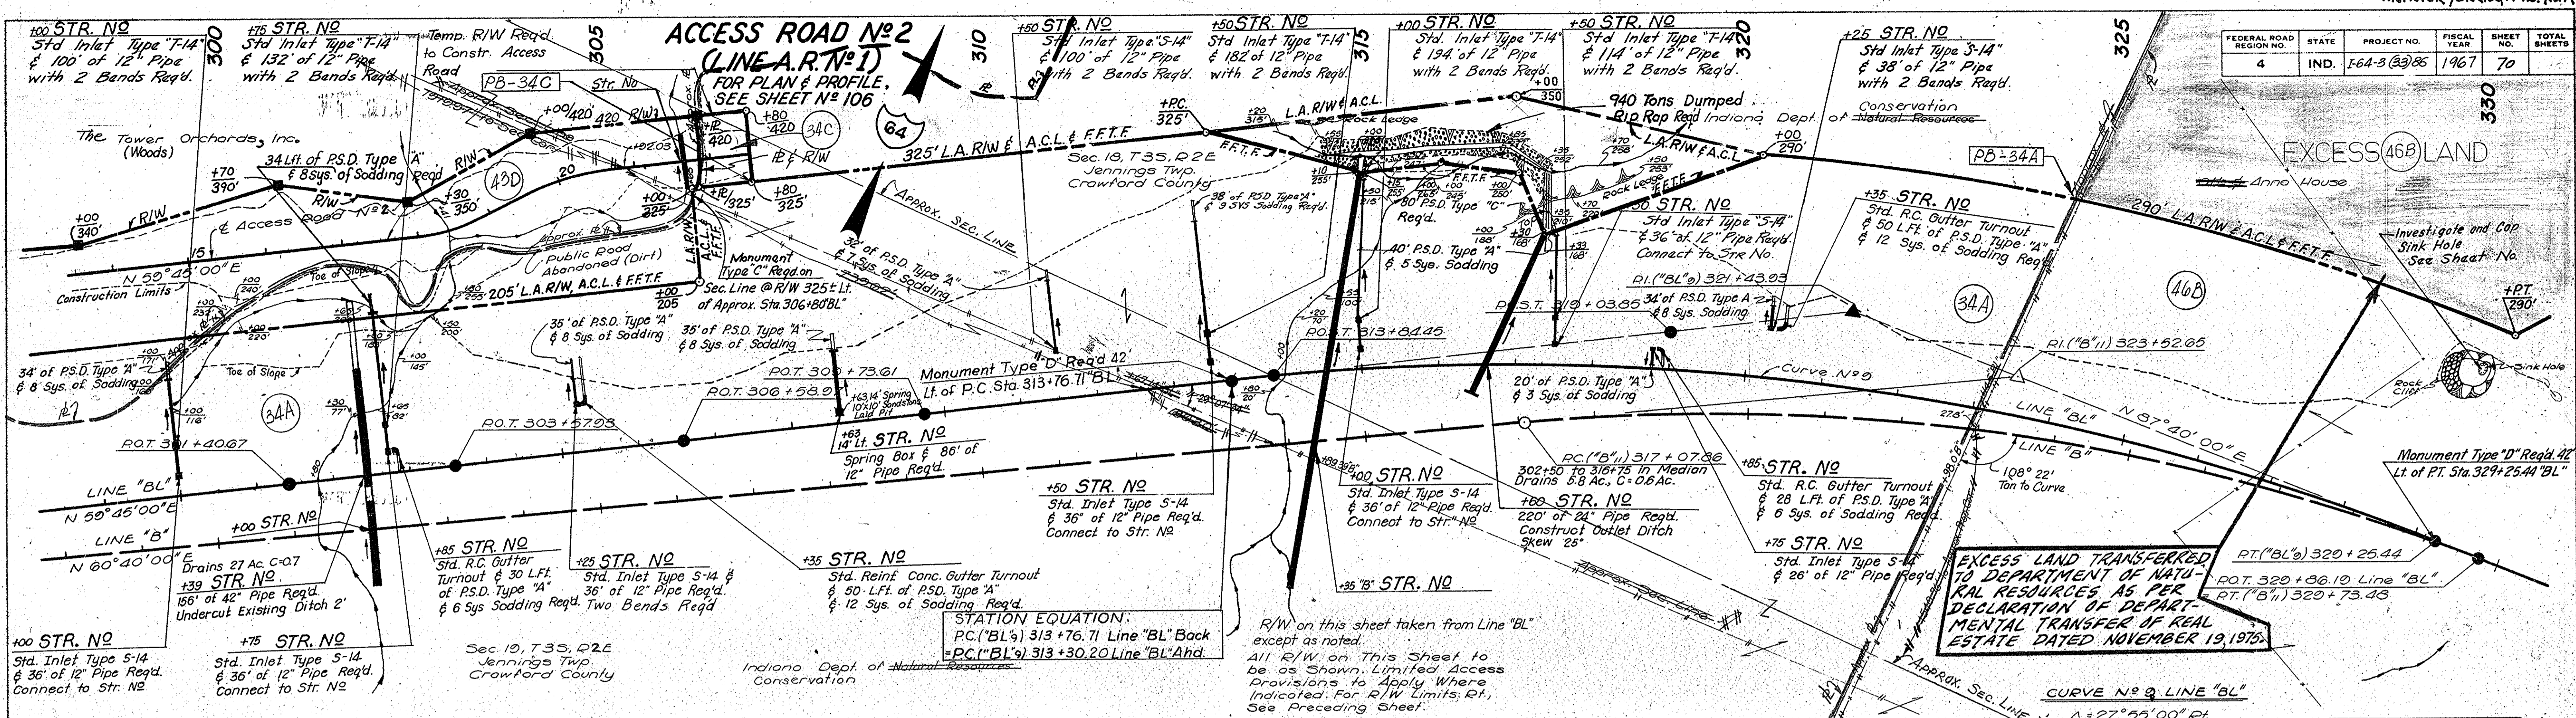




Rev. 12-18-75, Add EXCESS LAND TRANSFERRAL
NOTE: A. PERRY

REV. E.G-5-73, OWNER'S NAME - PARCEL 46.
A.J. Nickson (By: F. B. Smith)


FEDERAL ROAD REGION NO.	STATE	PROJECT NO.	FISCAL YEAR	SHEET NO.	TOTAL SHEETS
4	IND.	I-64-3(2)86	1967	71	

DATE	BY	REVISION
11/24/67	A.T. Wilcox	1/24/67
11/24/67	A.T. Wilcox	1/24/67
11/24/67	A.T. Wilcox	1/24/67
11/24/67	A.T. Wilcox	1/24/67
11/24/67	A.T. Wilcox	1/24/67

DATE	BY	REVISION
11/24/67	A.T. Wilcox	1/24/67
11/24/67	A.T. Wilcox	1/24/67
11/24/67	A.T. Wilcox	1/24/67
11/24/67	A.T. Wilcox	1/24/67
11/24/67	A.T. Wilcox	1/24/67

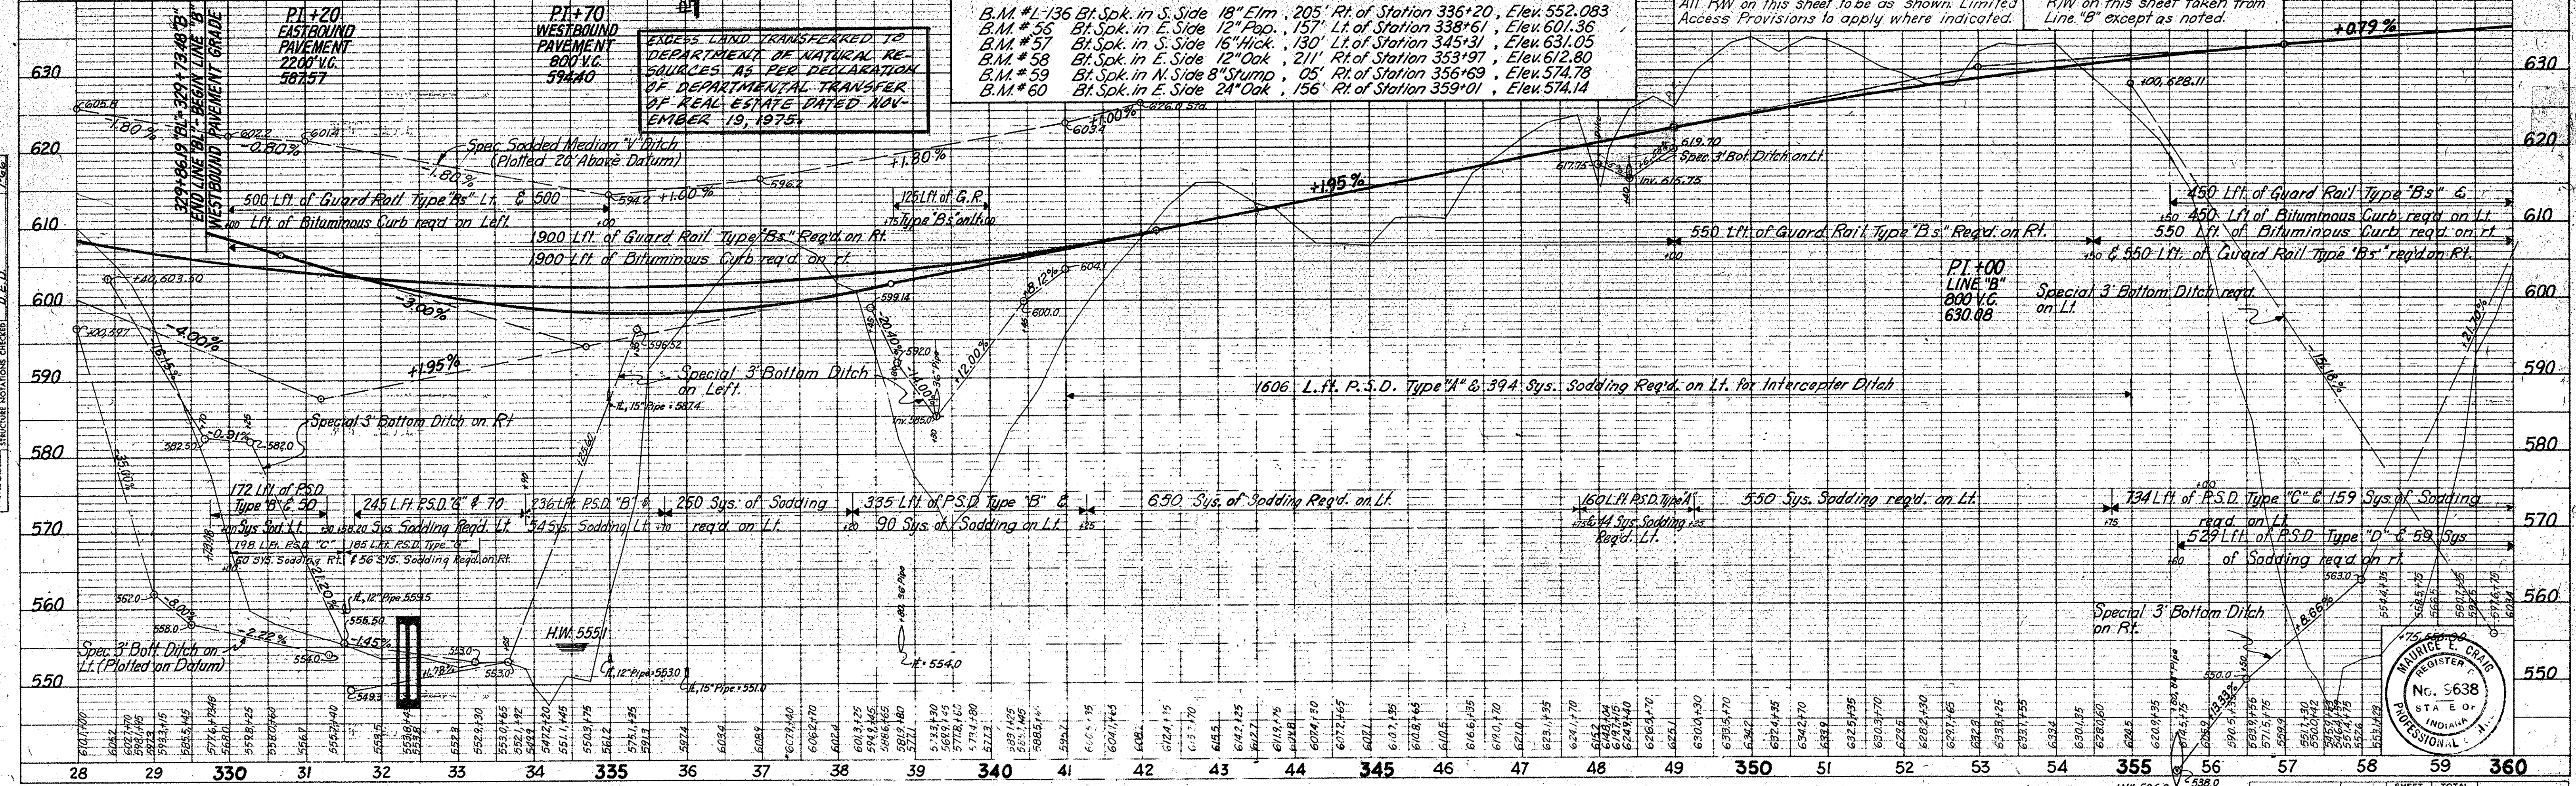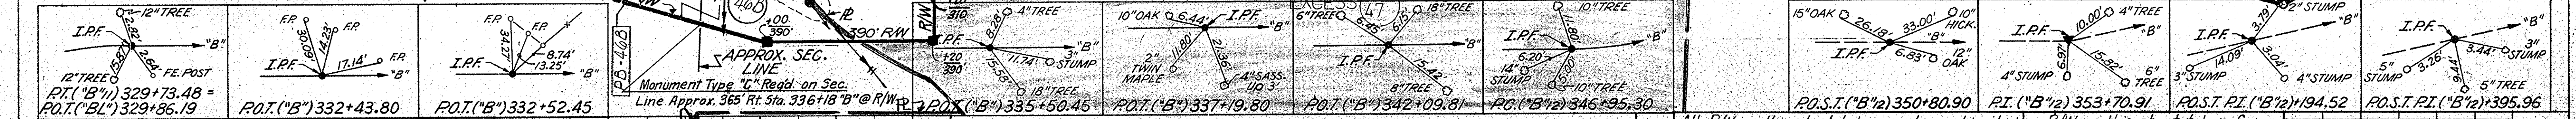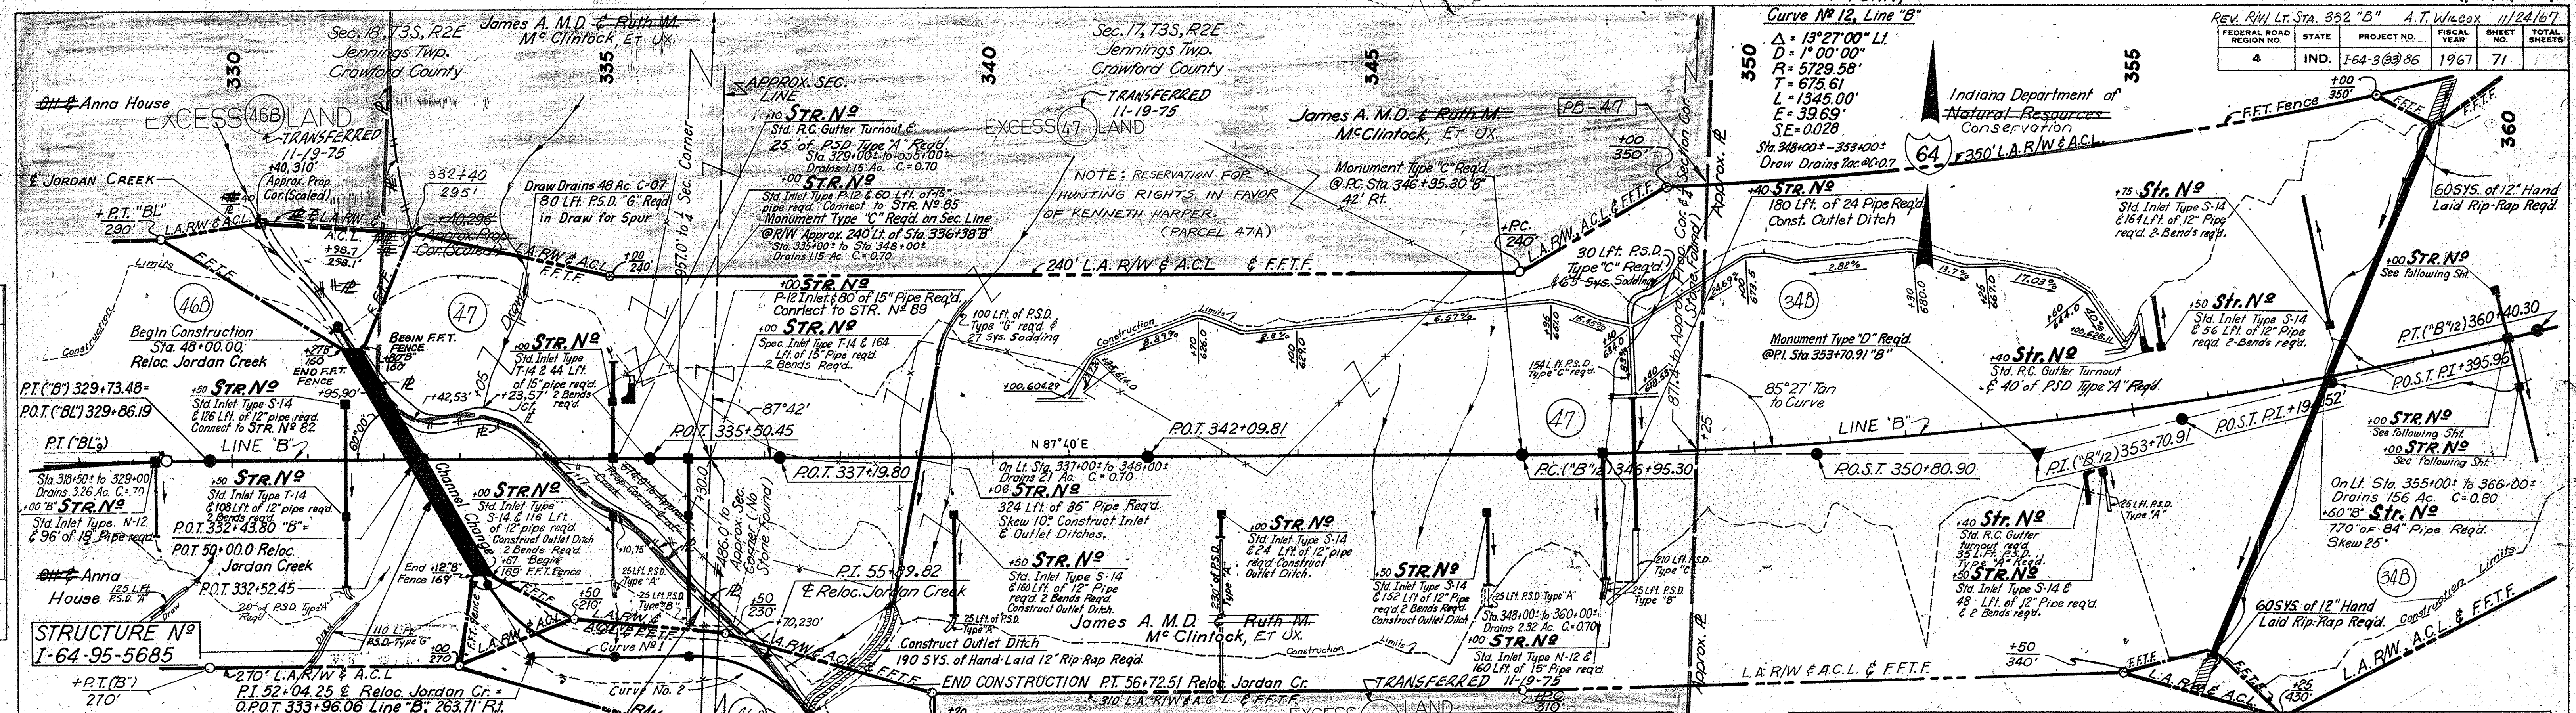

STATION	ELEVATION	GRADE	REMARKS
28	560.00		
29	560.00		
30	560.00		
31	560.00		
32	560.00		
33	560.00		
34	560.00		
35	560.00		
36	560.00		
37	560.00		
38	560.00		
39	560.00		
40	560.00		
41	560.00		
42	560.00		
43	560.00		
44	560.00		
45	560.00		
46	560.00		
47	560.00		
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51	560.00		
52	560.00		
53	560.00		
54	560.00		
55	560.00		
56	560.00		
57	560.00		
58	560.00		
59	560.00		
360	560.00		

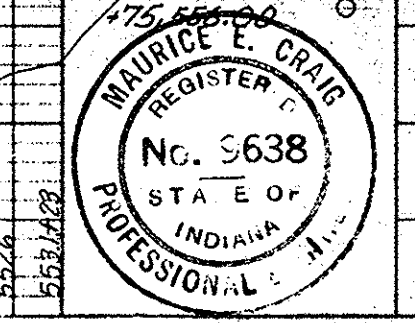

November 6, 1961









PROJECT NO.	LINE	SHEET NO.	TOTAL SHEETS	FILE
I-64-3(2)86	"B"	71		

FEDERAL ROAD REGION NO.	STATE	PROJECT NO.	FISCAL YEAR	SHEET NO.	TOTAL SHEETS
4	IND.	I-64-3(3)86	1967	72	1

SUBJECT TO A BLANKET EASEMENT FOR RW IN FAVOR OF STATEWIDE RURAL ELECTRIC COOP. INC.


DATE	BY	REVISION
1-66	C.C.	1.00
4-66	C.C.	1.01
7-66	C.C.	1.02
1-66	C.C.	1.03
7-66	C.C.	1.04

DATE	BY	REVISION
1-66	C.C.	1.00
4-66	C.C.	1.01
7-66	C.C.	1.02
1-66	C.C.	1.03
7-66	C.C.	1.04

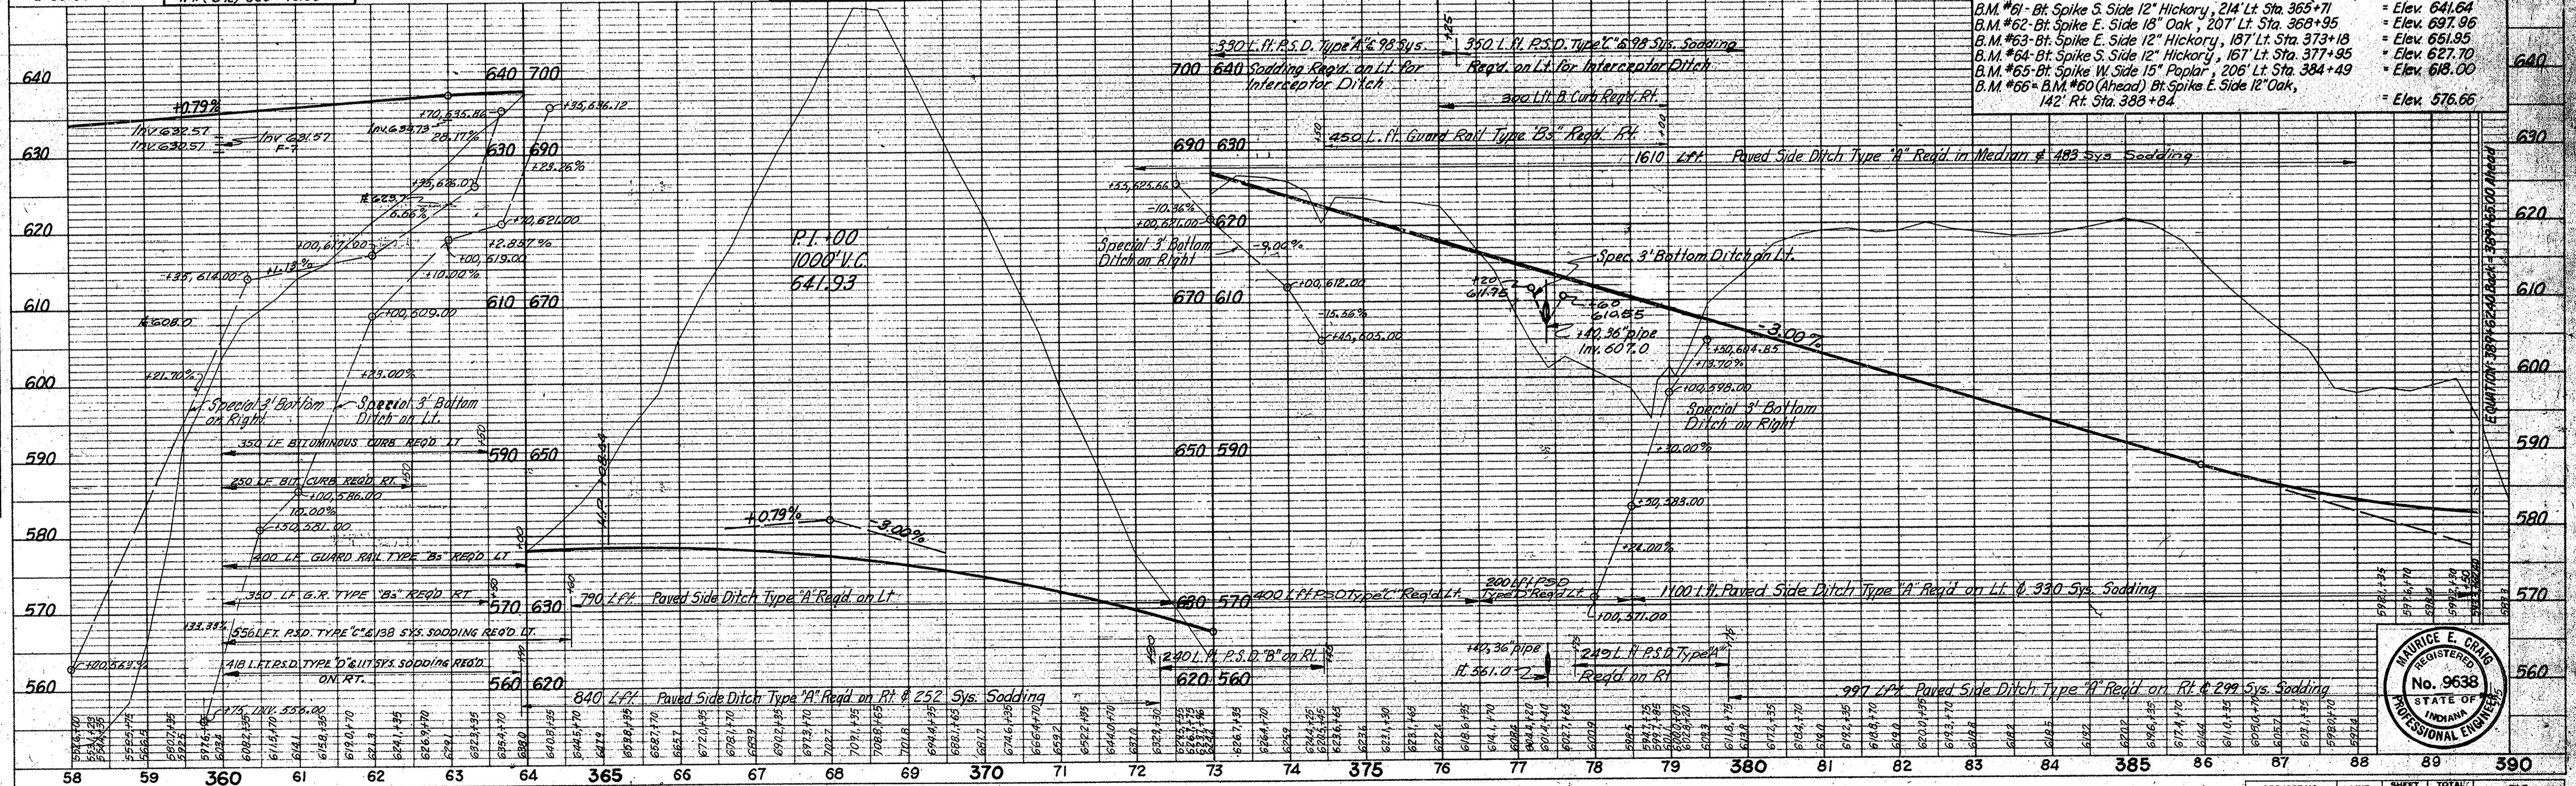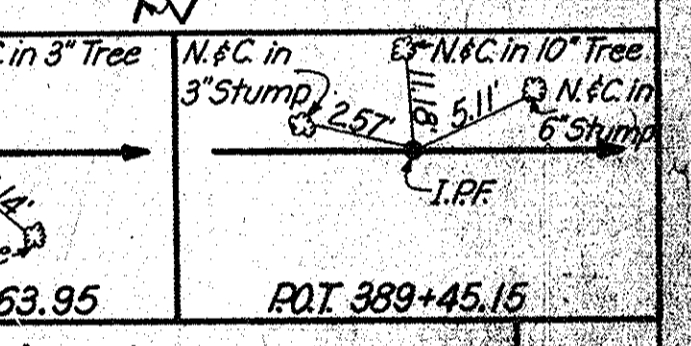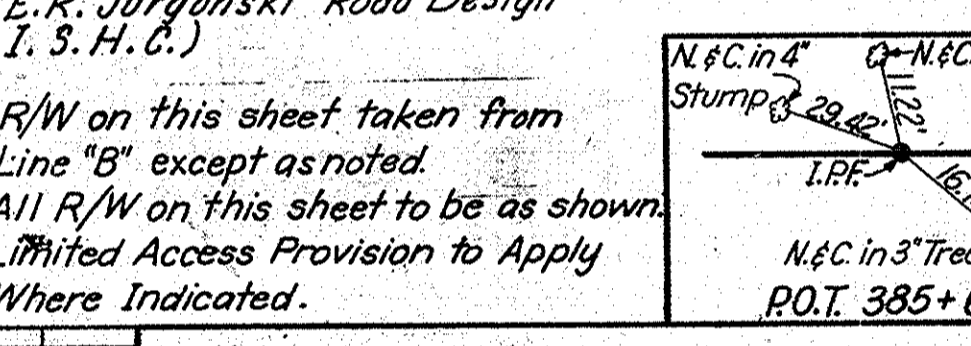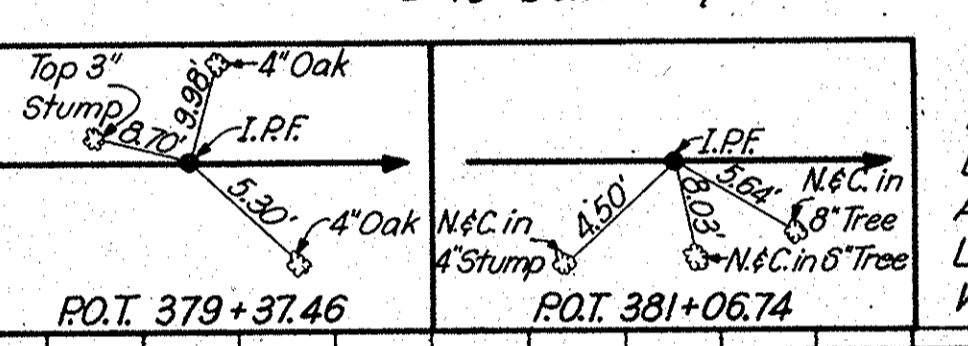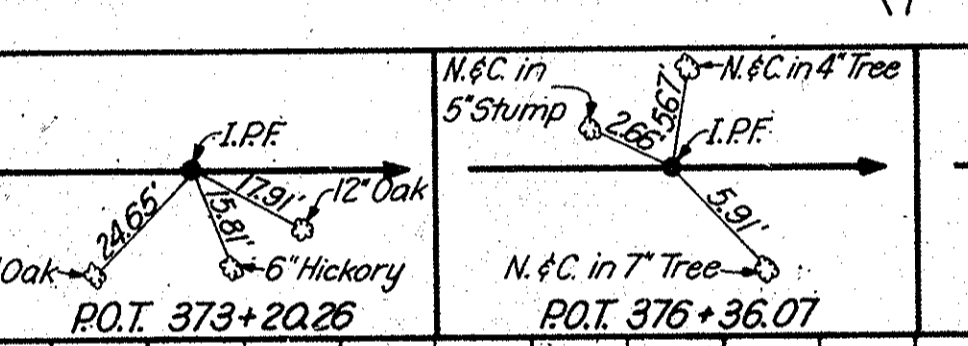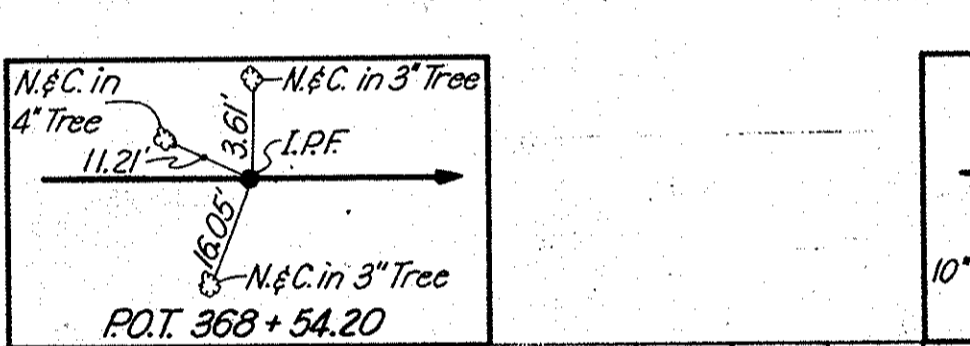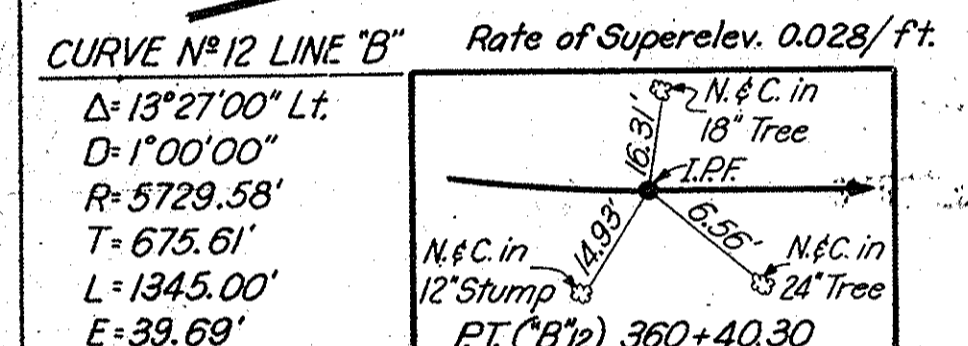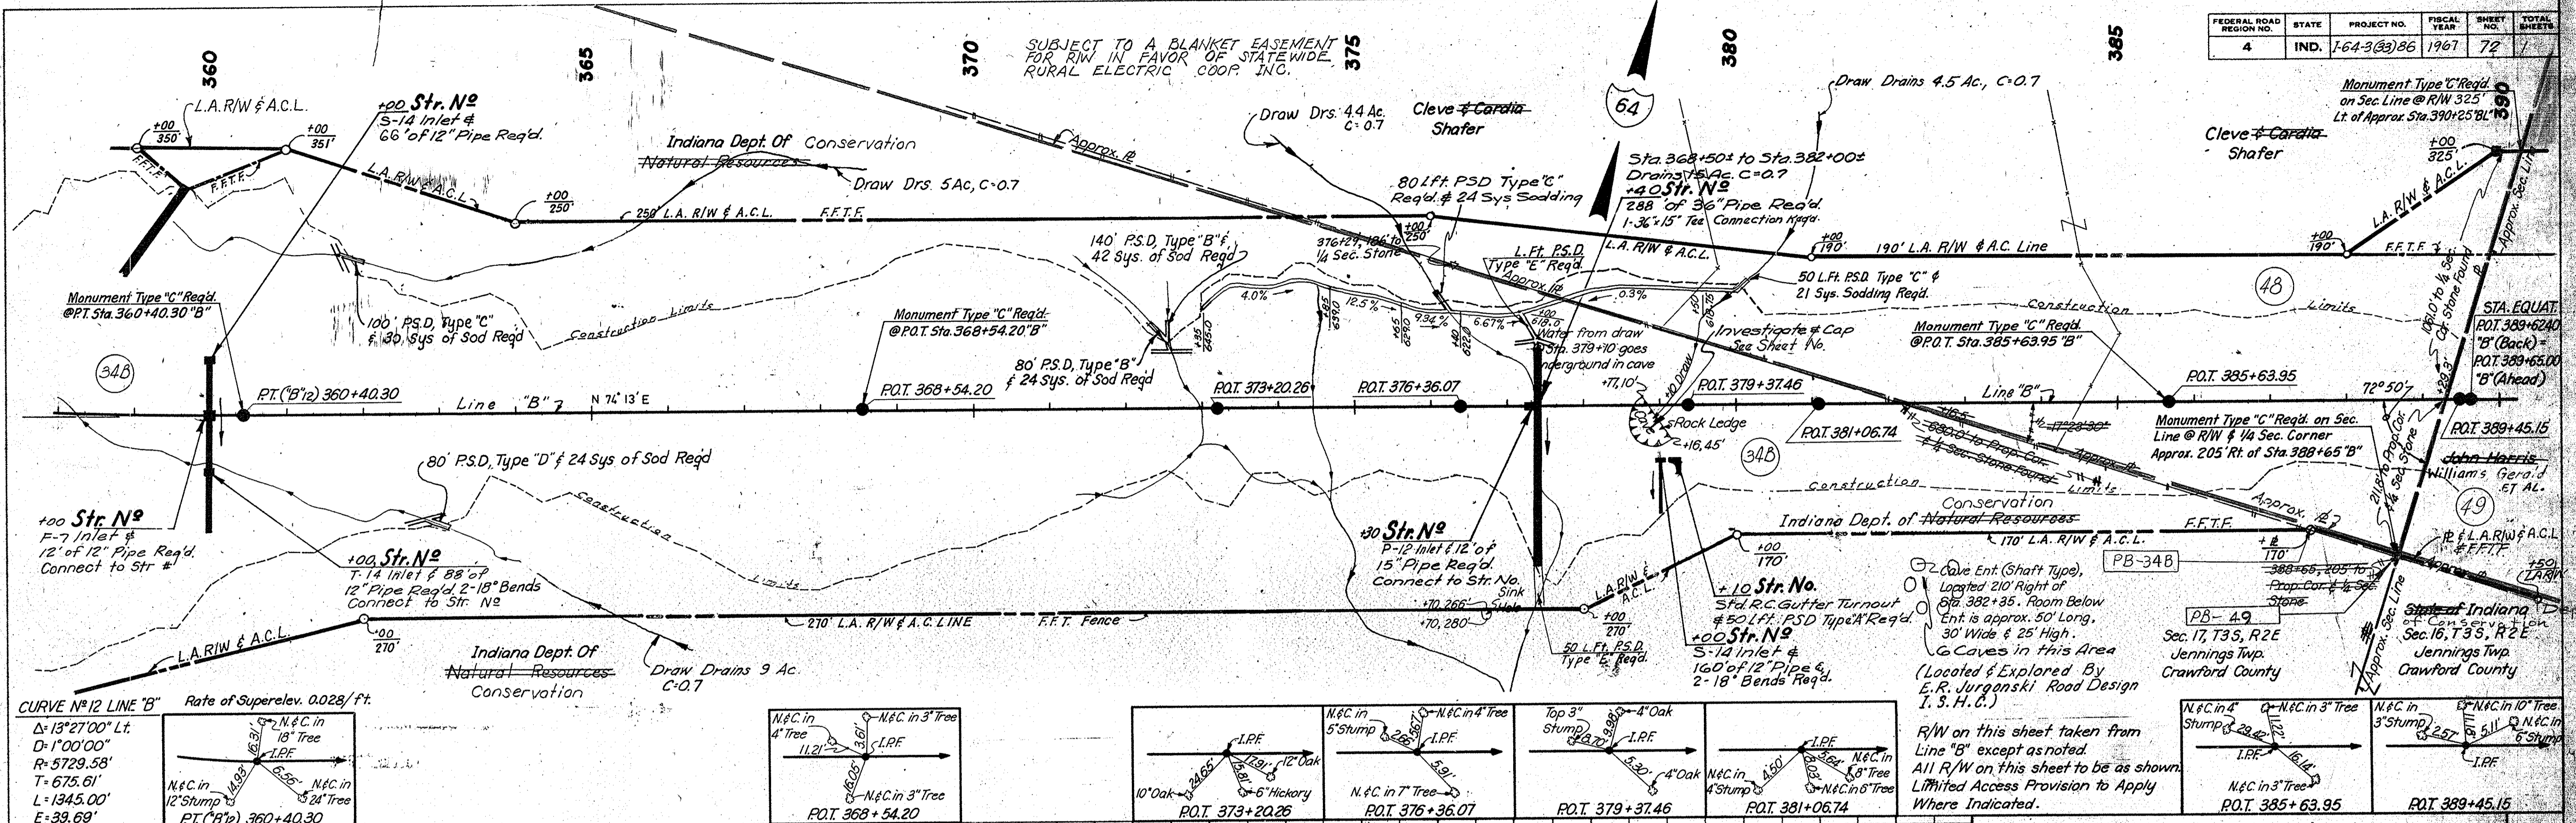

R/W on this sheet taken from Line "B" except as noted. All R/W on this sheet to be as shown. Limited Access Provision to Apply Where Indicated.

Point	Structure	Elevation
B.M. #61 - Bt. Spike S. Side 12" Hickory, 214' Lt. Sta. 365+71		Elev. 641.64
B.M. #62 - Bt. Spike E. Side 18" Oak, 207' Lt. Sta. 368+95		Elev. 697.96
B.M. #63 - Bt. Spike E. Side 12" Hickory, 187' Lt. Sta. 373+18		Elev. 651.95
B.M. #64 - Bt. Spike S. Side 12" Hickory, 167' Lt. Sta. 377+95		Elev. 627.70
B.M. #65 - Bt. Spike W. Side 15" Poplar, 206' Lt. Sta. 384+49		Elev. 618.00
B.M. #66 - B.M. #60 (Ahead) Bt. Spike E. Side 12" Oak, 142' Rt. Sta. 388+84		Elev. 576.66

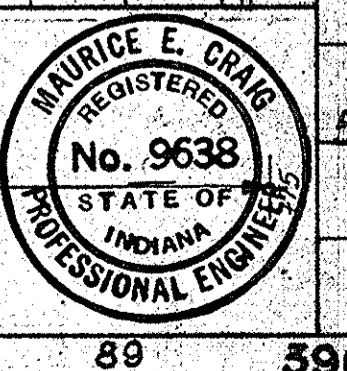

PROJECT NO.	LINE	SHEET NO.	TOTAL SHEETS	FILE
I-64-3(3)86	"B"	72		

FEDERAL ROAD REGION NO.	STATE	PROJECT NO.	FISCAL YEAR	SHEET NO.	TOTAL SHEETS
4	IND.	I-64-3(33)86	1967	74	

PLAN




DATE	BY
4-56	S.B.C.
5-56	P.P.C.
6-56	M.E.C.
7-56	L.E.M.

NOTE BOOK GRADES CHECKED
NO. 9316 L. ENCLOSURE NOTATIONS CHECKED

PROFILE

DATE	BY
4-56	S.B.C.
5-56	P.P.C.
6-56	M.E.C.
7-56	L.E.M.


NOTE BOOK GRADES CHECKED
NO. 9316 L. ENCLOSURE NOTATIONS CHECKED

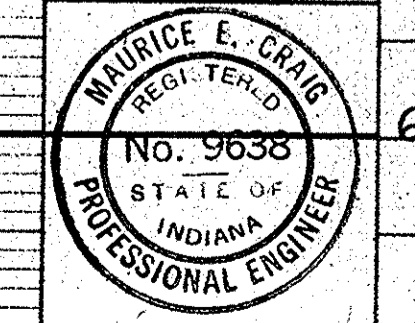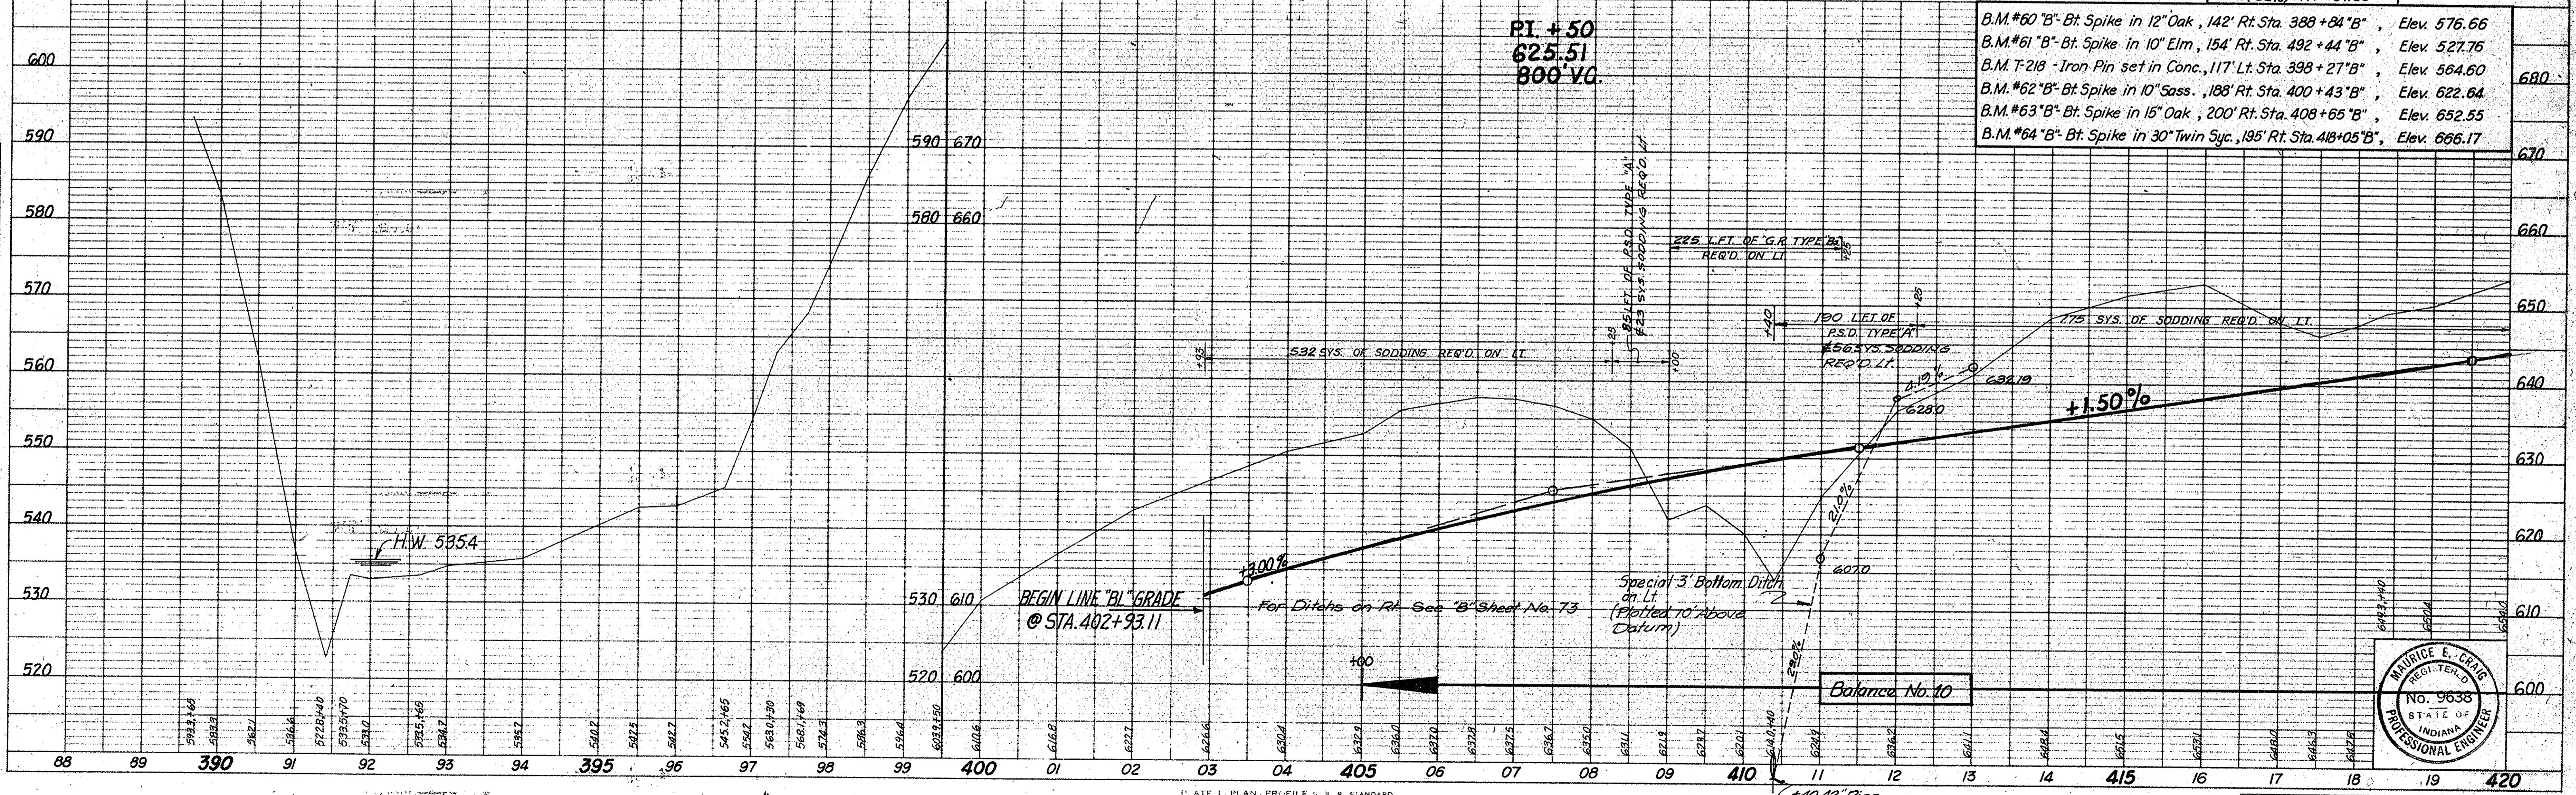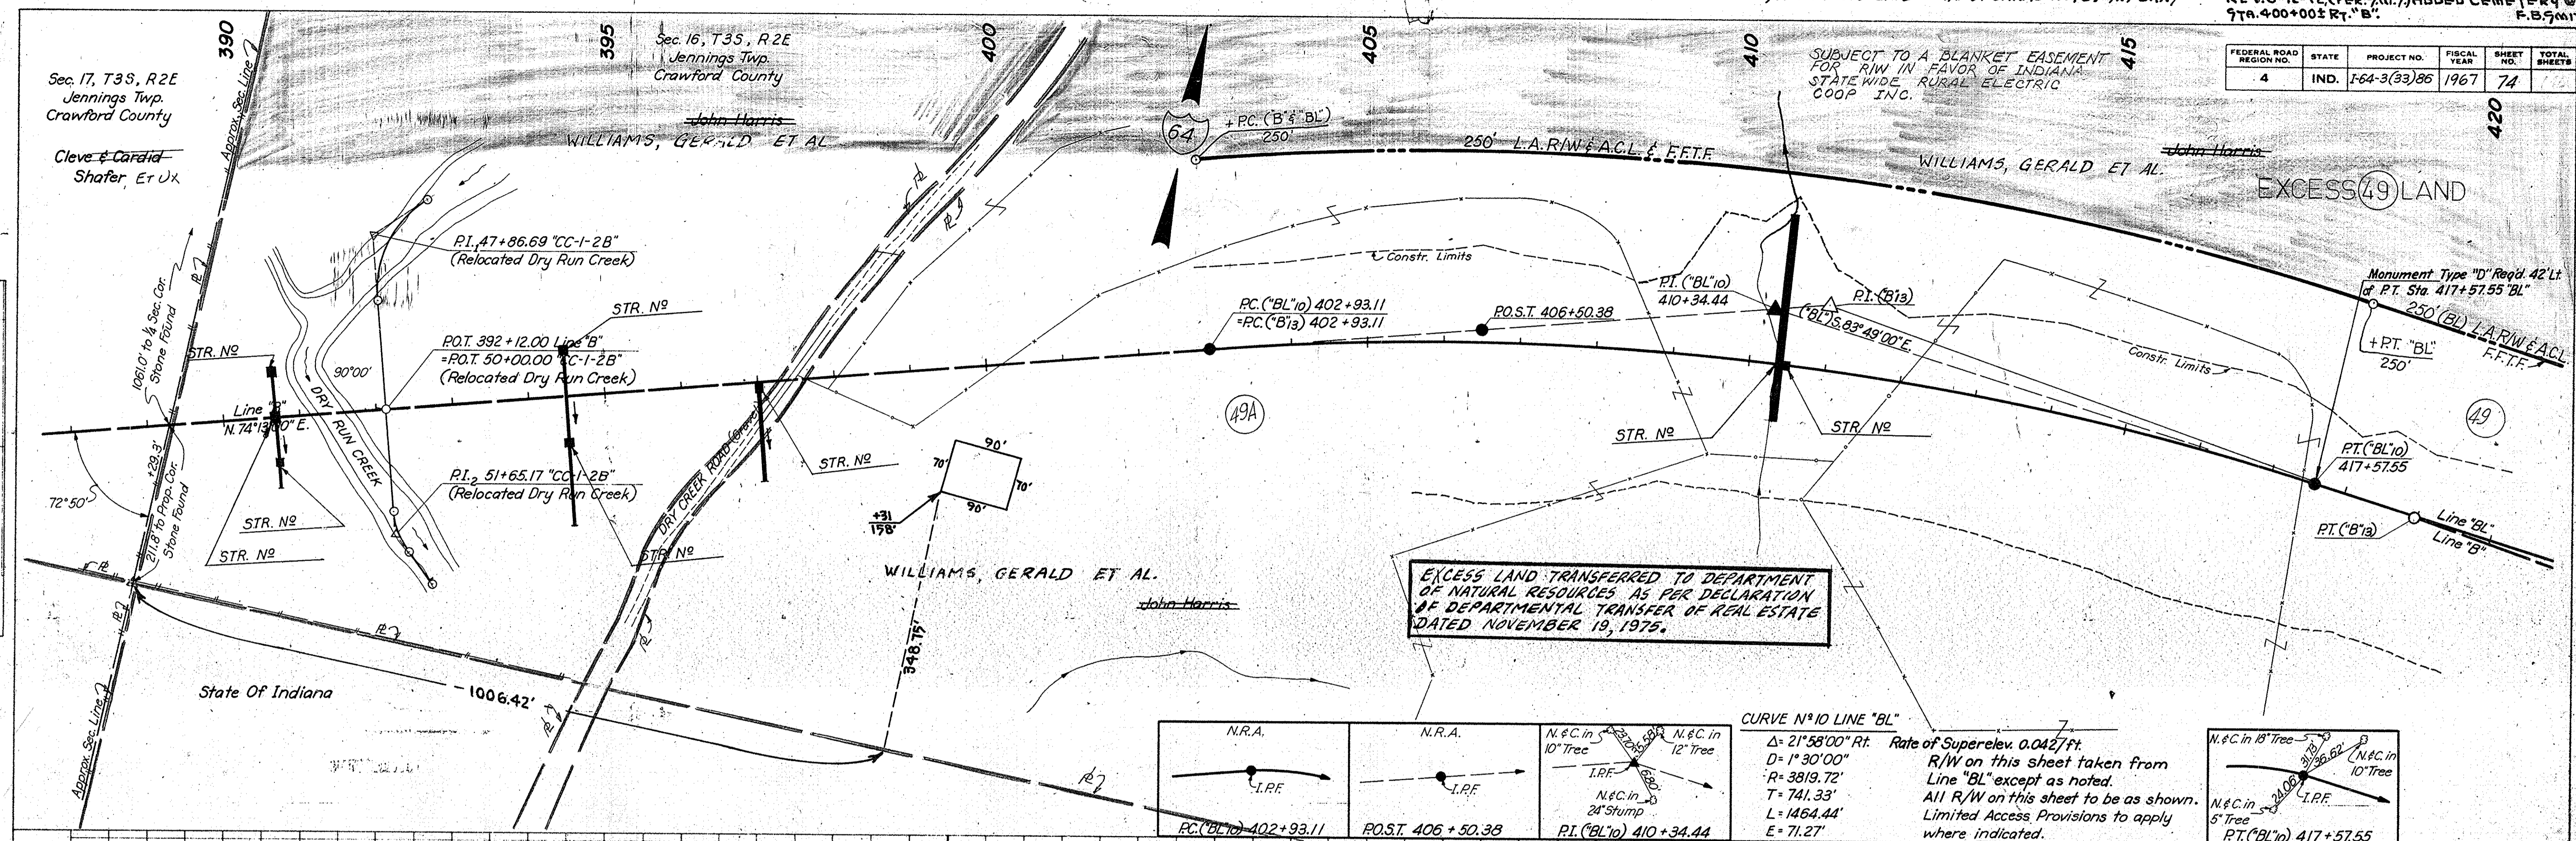

FEDERAL ROAD DISTRICT NO.	STATE	PROJECT NO.	FISCAL YEAR	SHEET NO.	TOTAL SHEETS
4	IND.	164-3(83)86	1967	76	



DATE	BY
4-26-66	G.E.C.
4-26-66	M.E.C.
4-26-66	R.D.L.

PLAN
NOTE BOOK
NO. 9518-1
ALIGNMENT CHECKED
STRENGTH LOCATIONS CHECKED

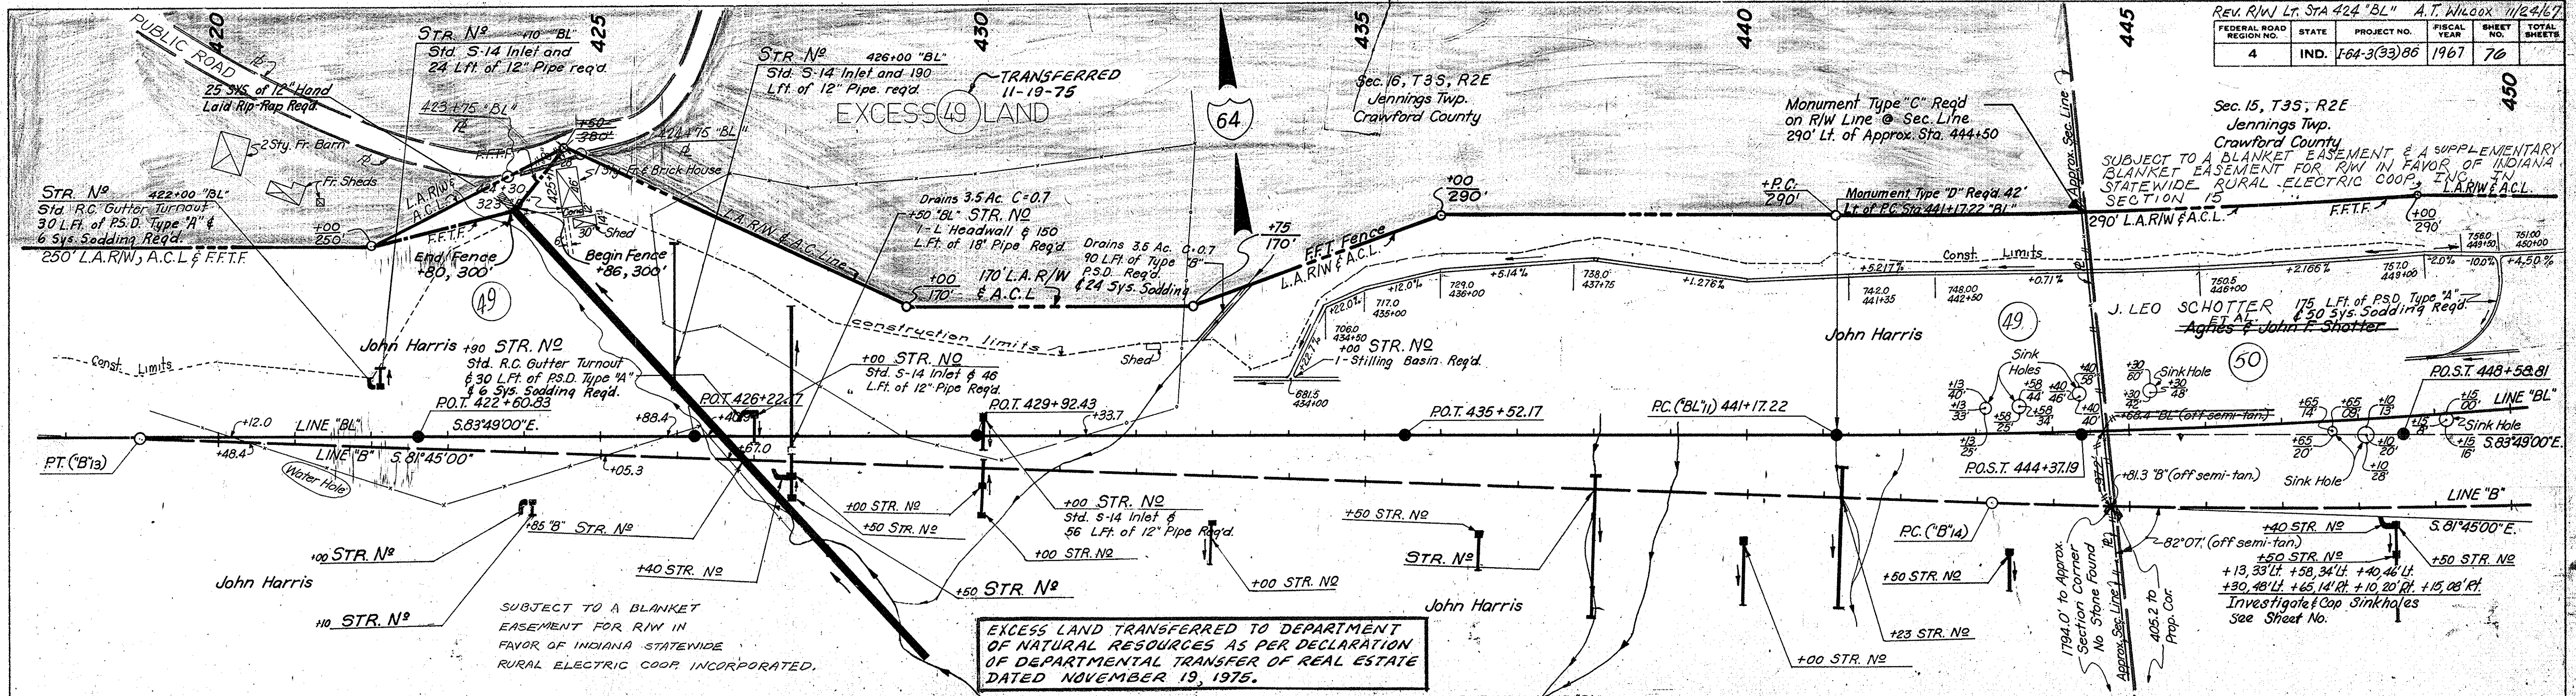


DATE	BY
4-26-66	G.E.C.
4-26-66	M.E.C.
4-26-66	R.D.L.

PROFILE
NOTE BOOK
NO. 9518-1
GRADES CHECKED
E. A. 1. NOTED
STRENGTH LOCATIONS CHECKED

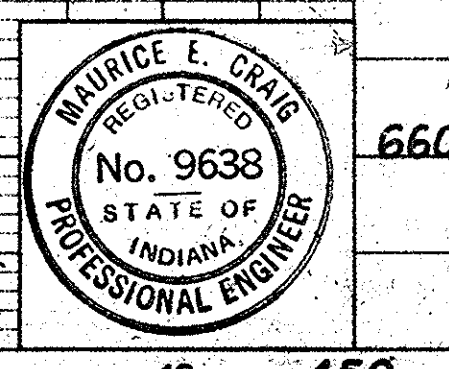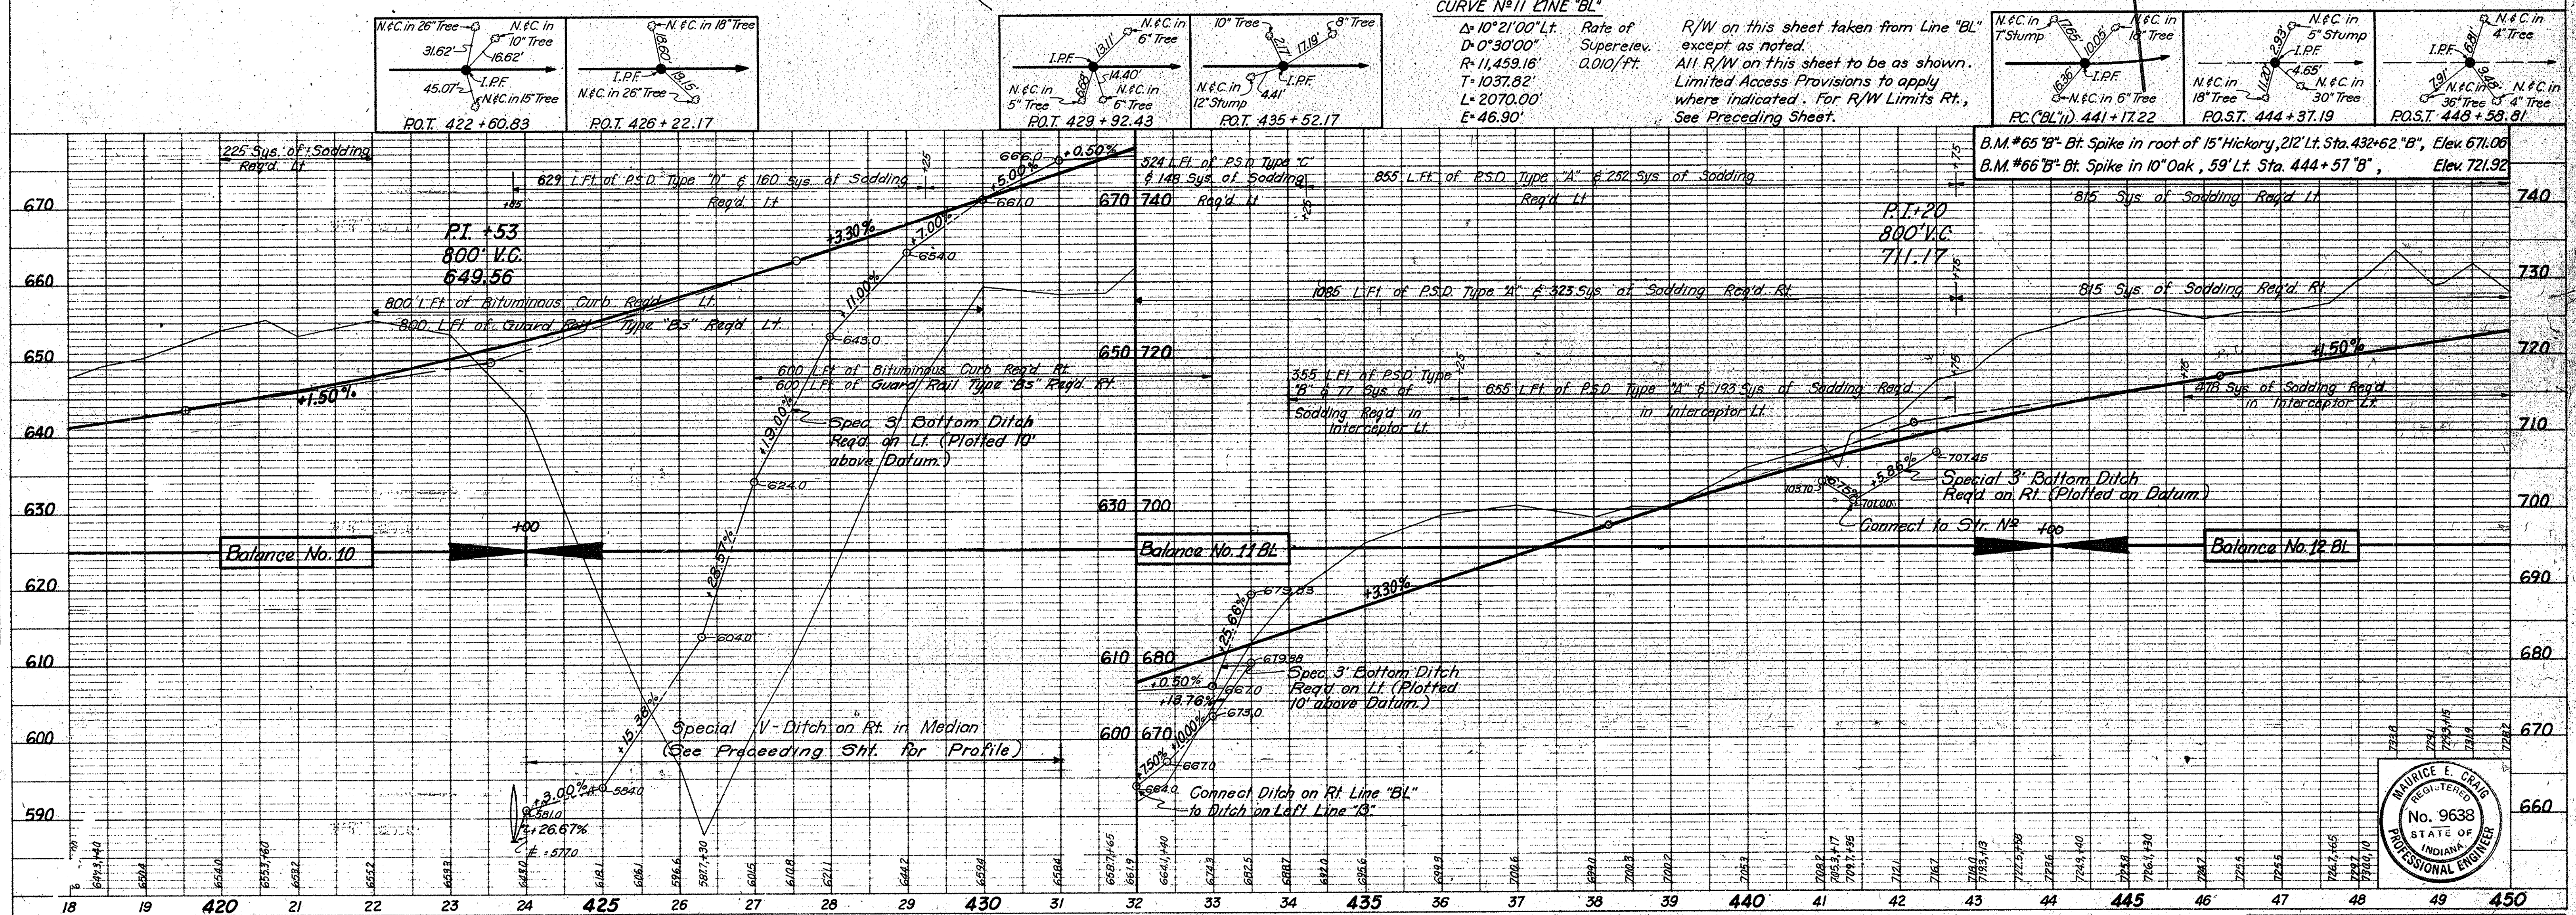

PROJECT NO.	LINE	SHEET NO.	TOTAL SHEETS	FILE
164-3(83)86	BL	76	103	


FEDERAL ROAD REGION NO.	STATE	PROJECT NO.	FISCAL YEAR	SHEET NO.	TOTAL SHEETS
4	IND.	16438386	1967	79	

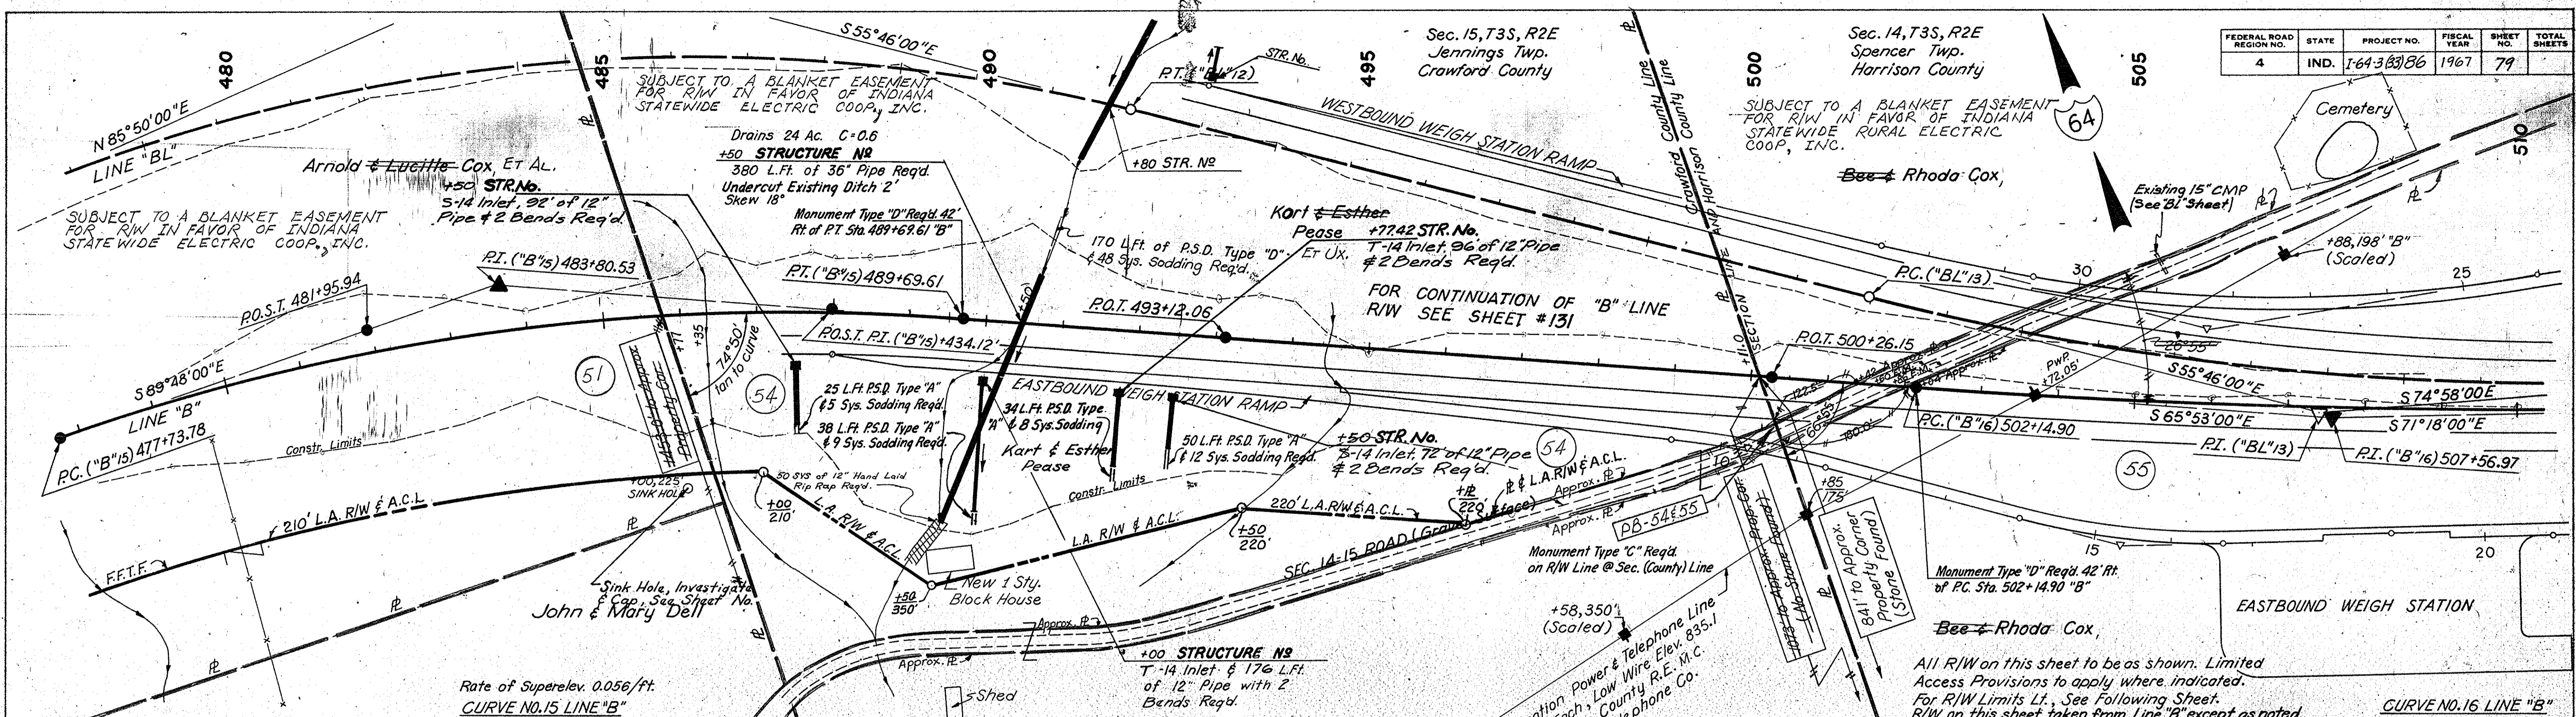

PLAN
 SURVEYED BY J.S.L.C.
 PLOTTED BY D.E.D.
 CHECKED BY G.E.C.
 DATE 7-66
 NOTE BOOK NO. 54338487 OF WEST CHICAGO
 No. 54338487 OF WEST CHICAGO

PROFILE
 SURVEYED BY J.S.L.C.
 PLOTTED BY D.E.D.
 CHECKED BY G.E.C.
 DATE 7-66
 NOTE BOOK NO. 54338487 OF WEST CHICAGO
 No. 54338487 OF WEST CHICAGO

<p>N.R.A. "B"</p> <p>I.P.F.</p> <p>PC. ("B") 477+73.78</p>	<p>24" STUMP</p> <p>5.71'</p> <p>I.P.F.</p> <p>PO.S.T. 481+95.94</p>	<p>10" TREE</p> <p>11.43'</p> <p>I.P.F.</p> <p>RI. ("B") 483+80.53</p>	<p>10" STUMP</p> <p>7.62'</p> <p>I.P.F.</p> <p>PO.S.T. PI. ("B") 434.12'</p>	<p>10" TREE</p> <p>7.502'</p> <p>I.P.F.</p> <p>RT. ("B") 489+69.61</p>	<p>5" TREE</p> <p>3.88'</p> <p>I.P.F.</p> <p>PO.T. 493+12.06</p>	<p>FOR ACCESS ROAD No. 4, SEE SHEET No. 108</p>	<p>6" STUMP</p> <p>2.55'</p> <p>I.P.F.</p> <p>PO.T. 500+26.15</p>	<p>N.R.A.</p> <p>I.P.</p> <p>PC. ("B") 502+14.90</p>	<p>N.R.A.</p> <p>I.P.</p> <p>RI. ("B") 507+56.97</p>	<p>Rate of Superelev. 0.010/ft.</p>	<p>CURVE NO. 16 LINE "B"</p> <p>$\Delta = 5^{\circ}25'00''$ Lt.</p> <p>$D = 0^{\circ}30'00''$</p> <p>$R = 11,459.16'$</p> <p>$T = 542.07'$</p> <p>$L = 1083.34'$</p> <p>$E = 72.81'$</p>
--	--	--	--	--	--	---	---	--	--	---	--


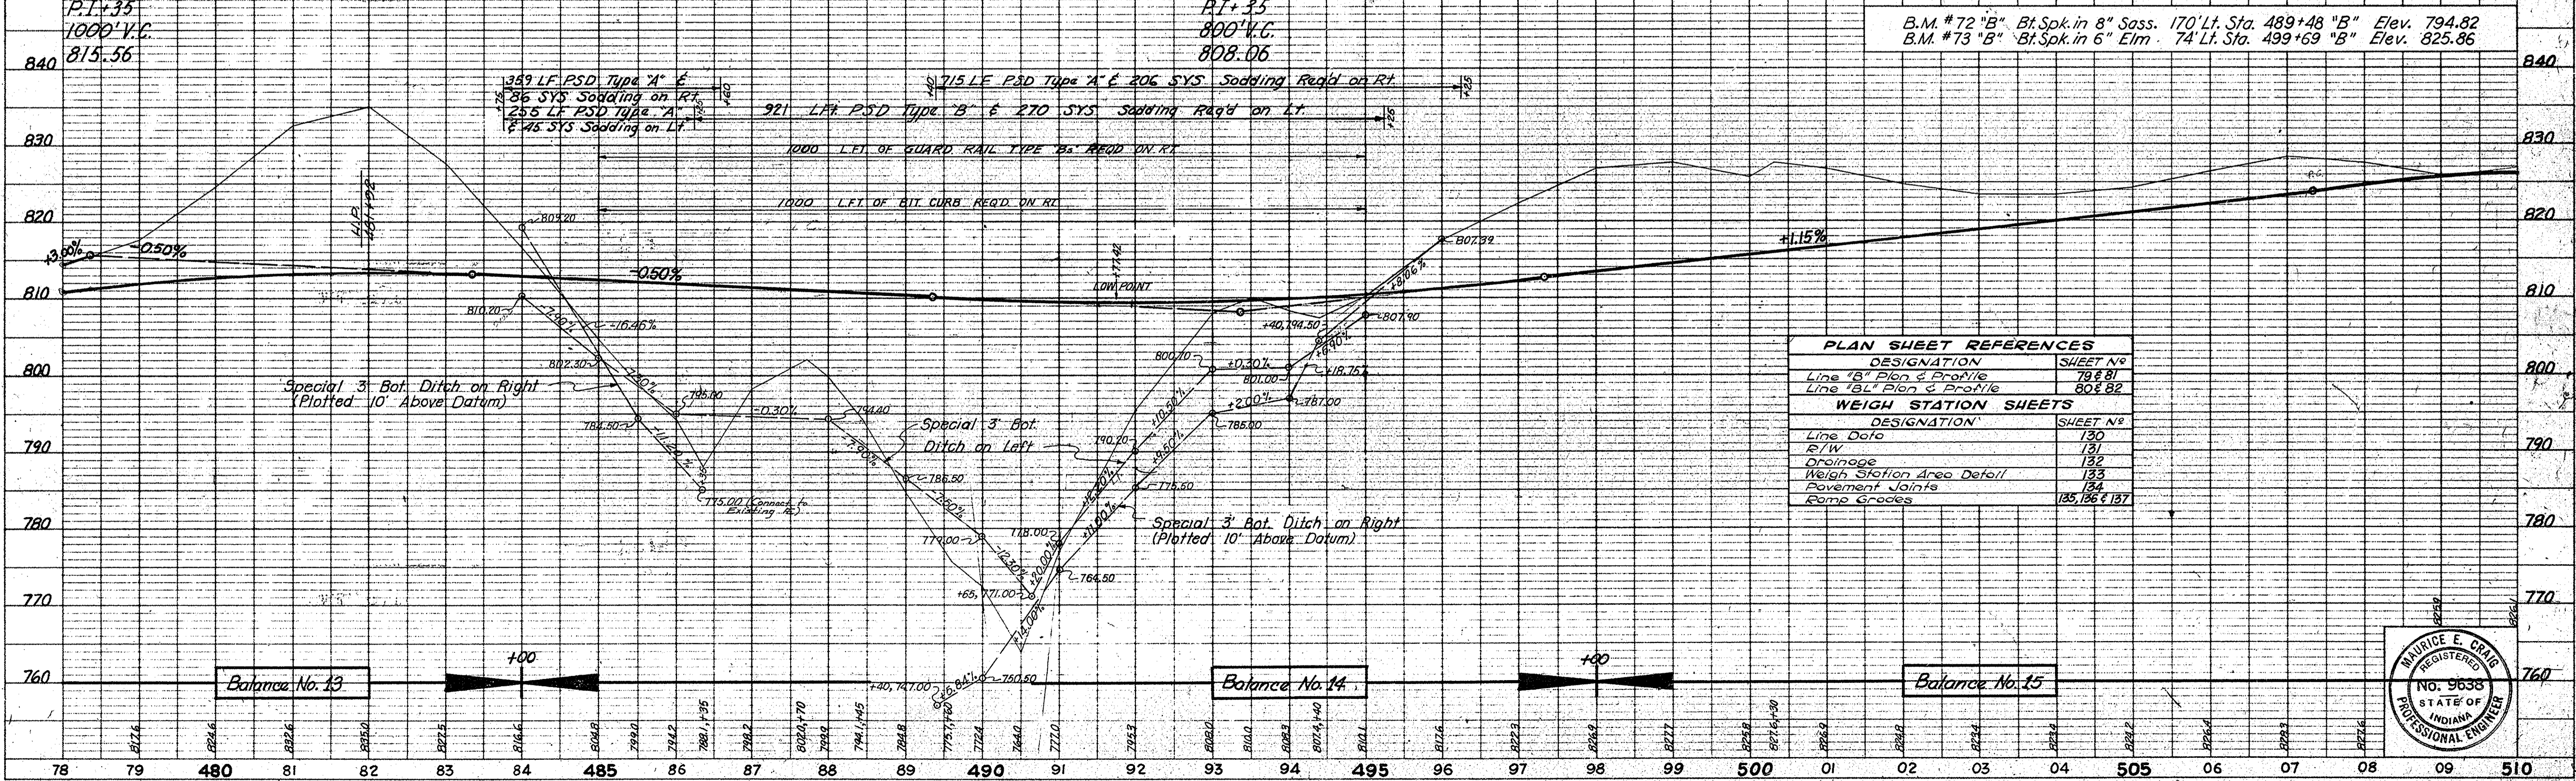


PLAN SHEET REFERENCES	
DESIGNATION	SHEET No.
Line "B" Plan & Profile	78 & 81
Line "BL" Plan & Profile	80 & 82
WEIGH STATION SHEETS	
DESIGNATION	SHEET No.
Line Data	130
R/W	131
Drainage	132
Weigh Station Area Detail	133
Pavement Joints	134
Ramp Grades	135, 136 & 137



PLAN
 SURVEYED BY J.S.H.C.
 NOTED BY G.F.C.
 NO. 54-3(83)86 PART OF WAY CHECKED 11/24/67

PROFILE
 SURVEYED BY J.S.H.C.
 NOTED BY G.F.C.
 NO. 54-3(83)86 STRUCTURE NOTATIONS CHECKED 11/24/67

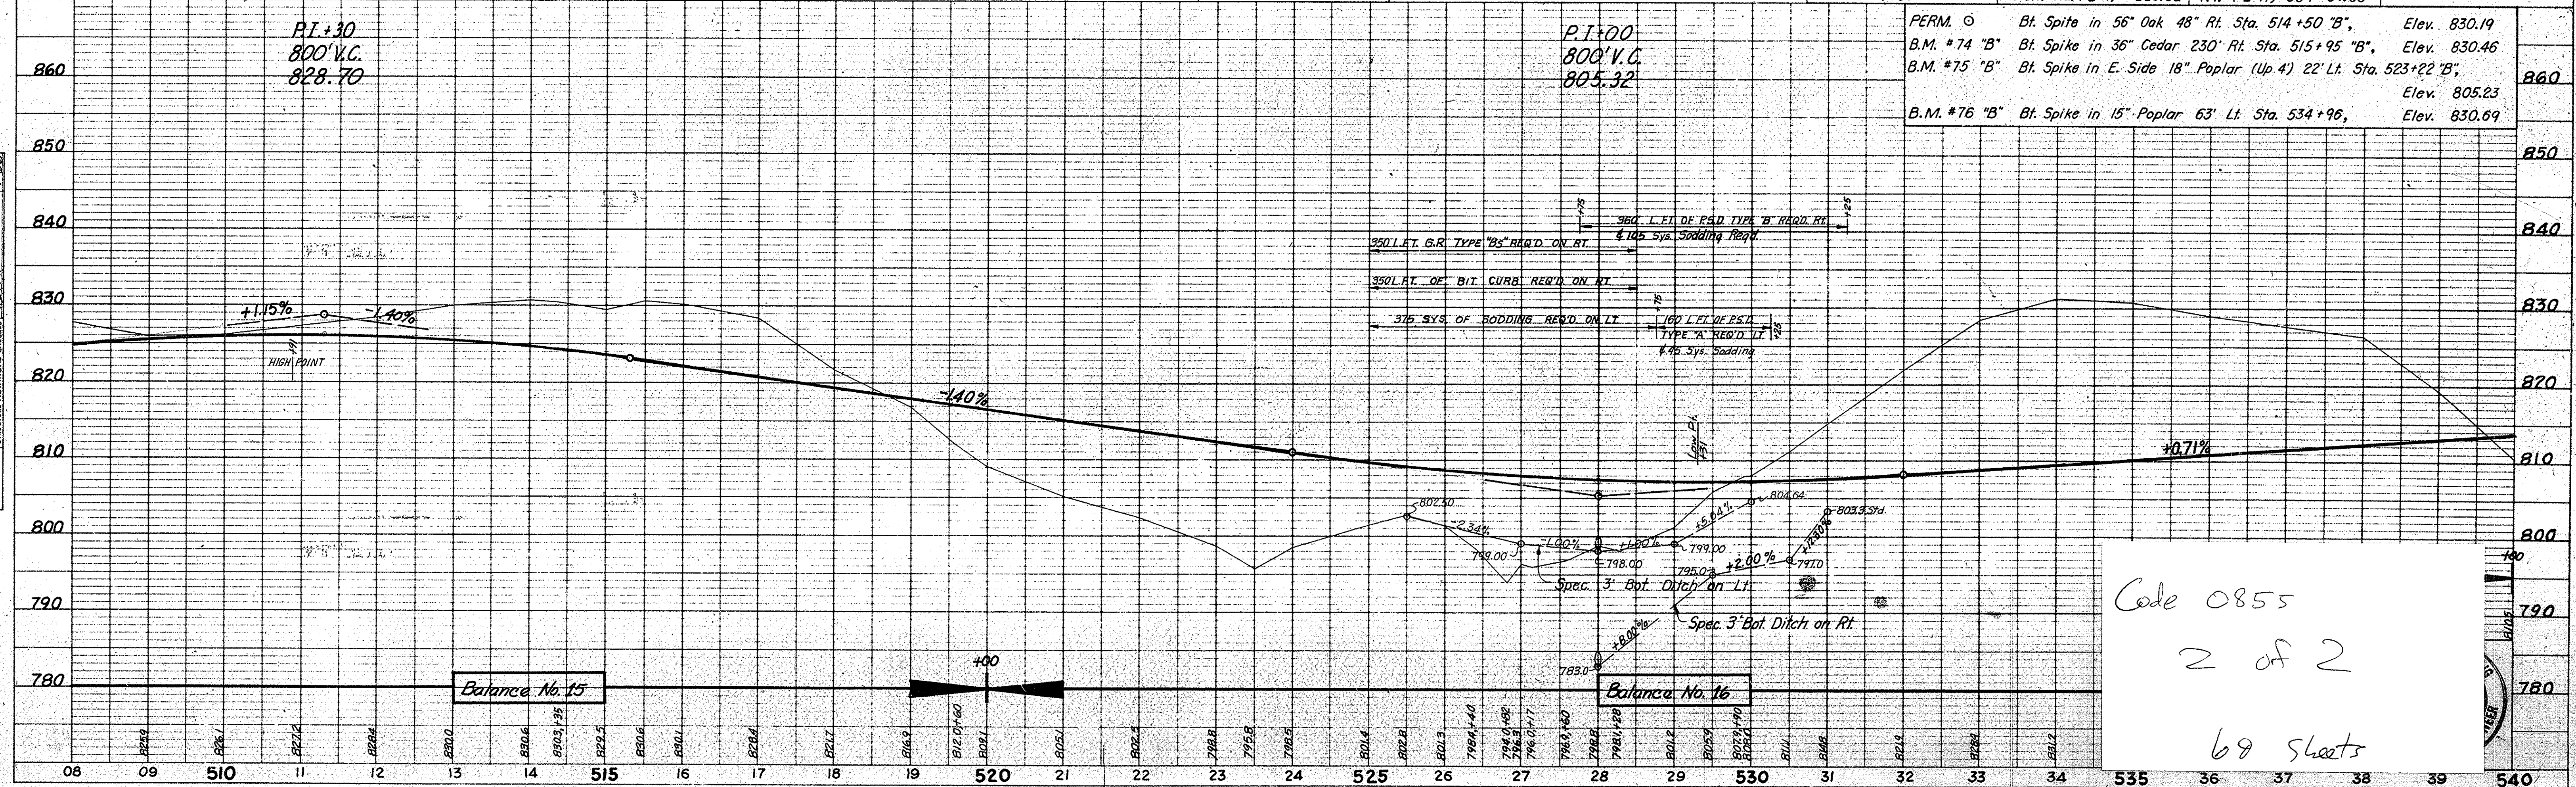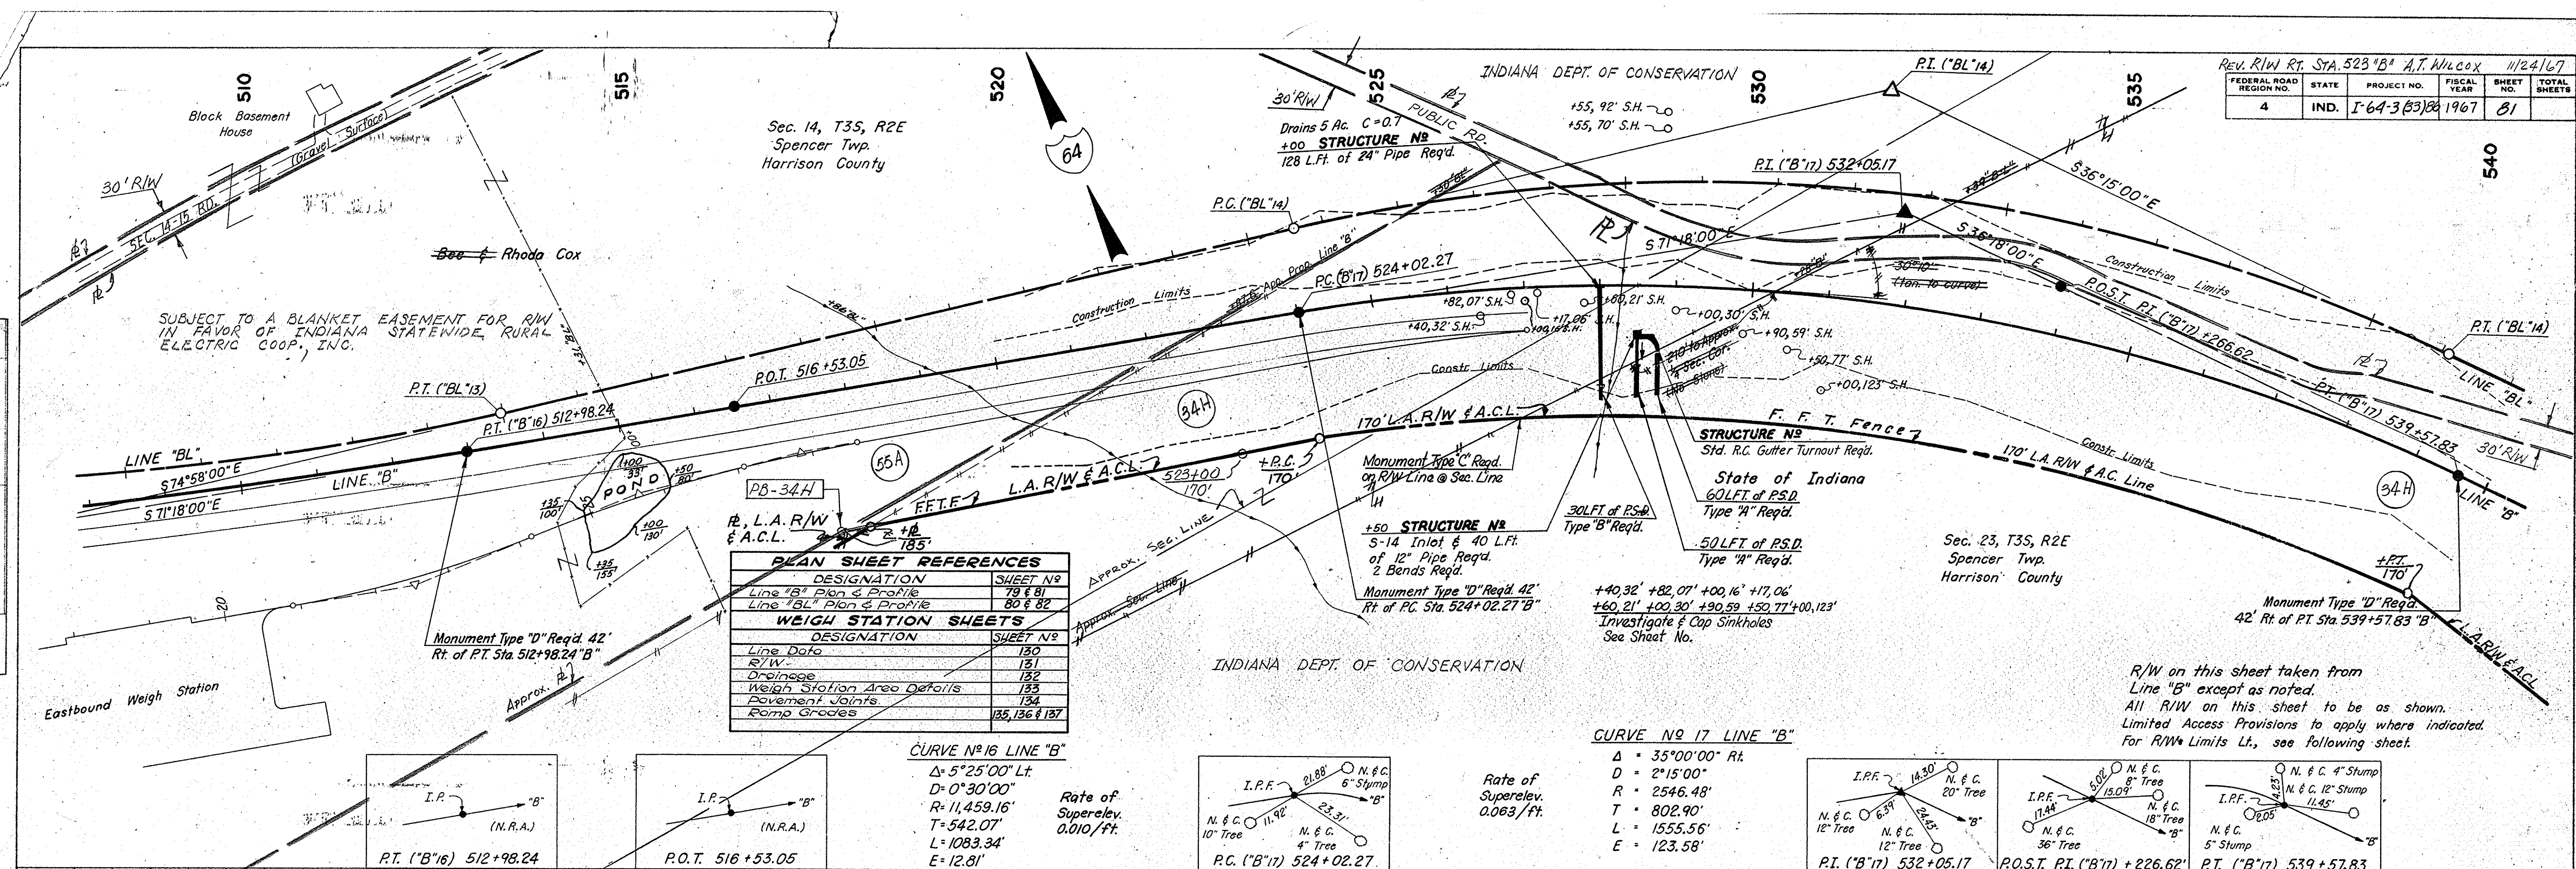


Code 0855
 2 of 2
 69 sheets


FEDERAL ROAD REGION NO.	STATE	PROJECT NO.	FISCAL YEAR	SHEET NO.	TOTAL SHEETS
4	IND.	I-64-3(3)86	1967	82	

DATE	BY	REVISION
11-66	J.S.L.C.	1. L.S.L.C. CHECKED
11-66	D.F.D.	2. P.E.C. CHECKED
11-66	P.B.G.	3. P.B.G. CHECKED

DATE	BY	REVISION
7-66	J.S.L.C.	1. L.S.L.C. CHECKED
6-66	D.F.D.	2. P.E.C. CHECKED
7-66	P.B.G.	3. P.B.G. CHECKED

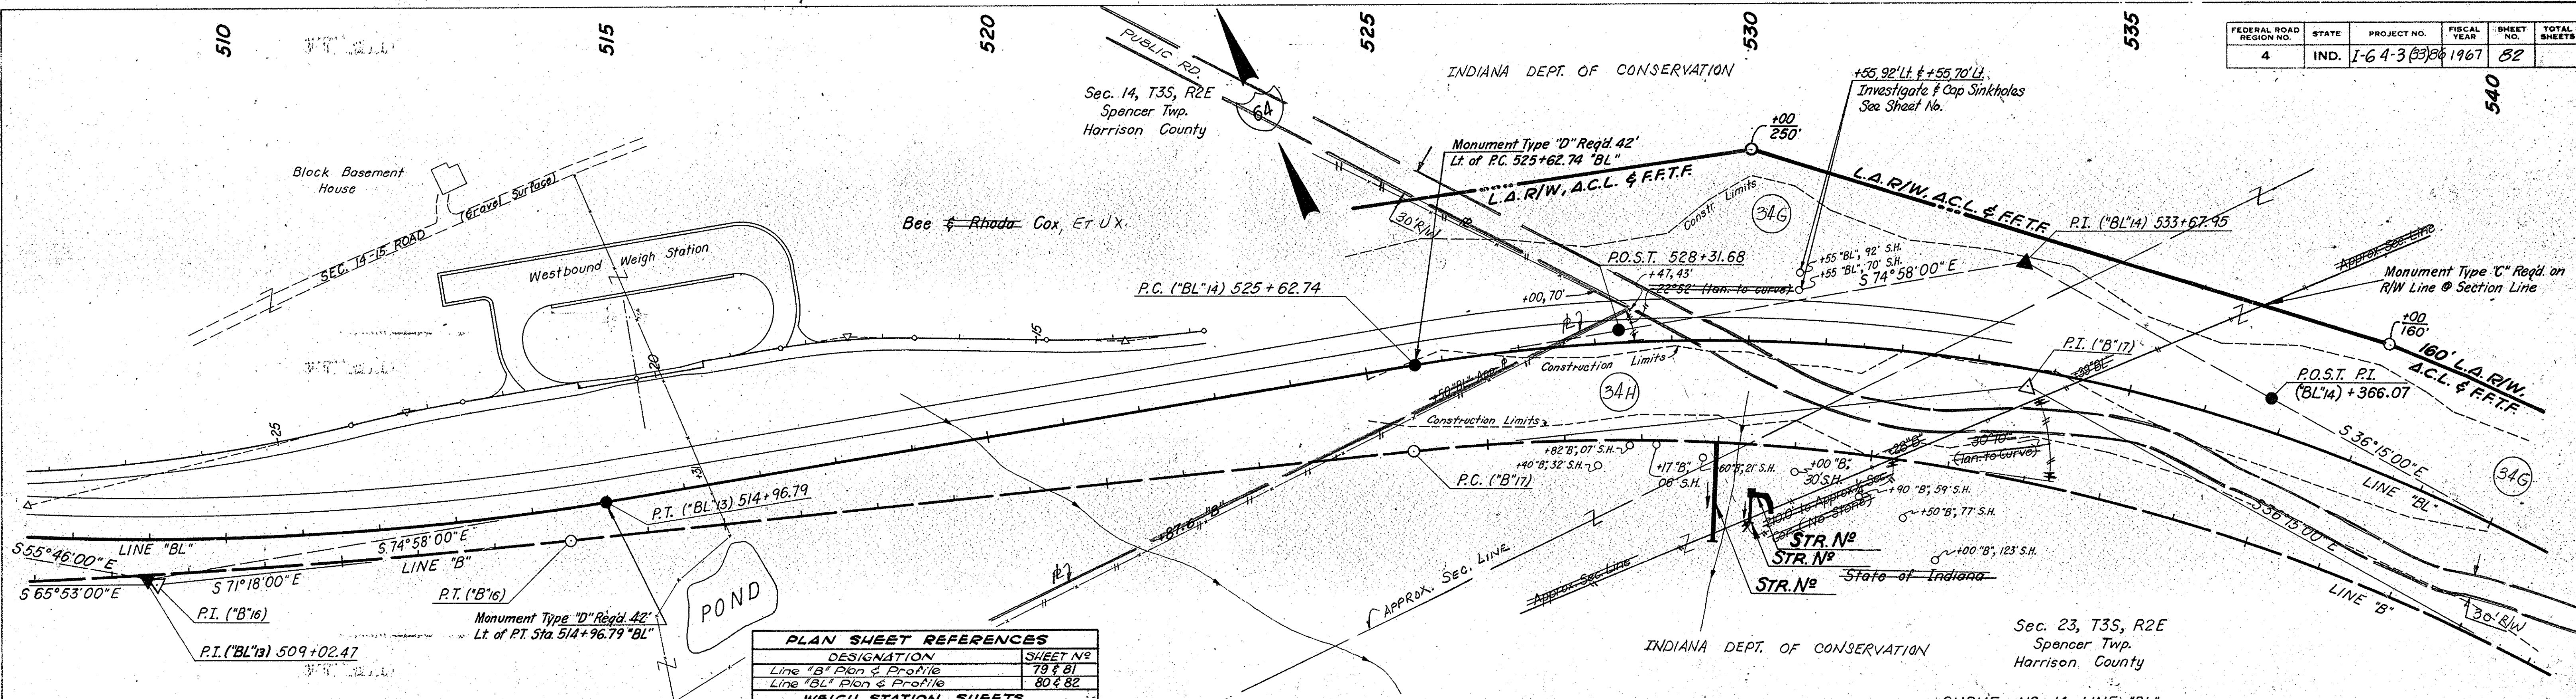


CURVE NO 13 LINE "BL"
 $\Delta = 19^{\circ}12'00''$ Lt
 $D = 1^{\circ}36'00''$
 $R = 3580.99'$
 $T = 605.68'$
 $L = 1200.00'$
 $E = 50.86'$
 Rate of Superlev. 0.042/ft.

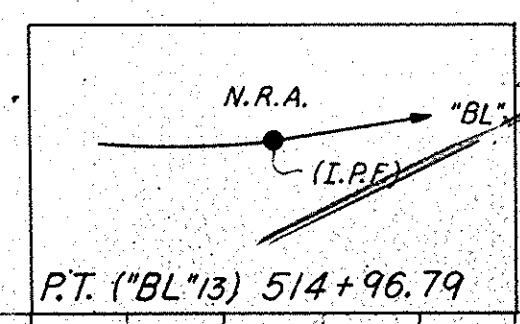

PLAN SHEET REFERENCES	
DESIGNATION	SHEET NO.
Line 'B' Plan & Profile	79 & 81
Line 'BL' Plan & Profile	80 & 82



WEIGH STATION SHEETS	
DESIGNATION	SHEET NO.
Line Data	130
R/W	131
Drainage	132
Weigh Station Area Details	133
Pavement Joints	134
Special W.B. Exit	135
Ramp Grades	135, 136 & 137

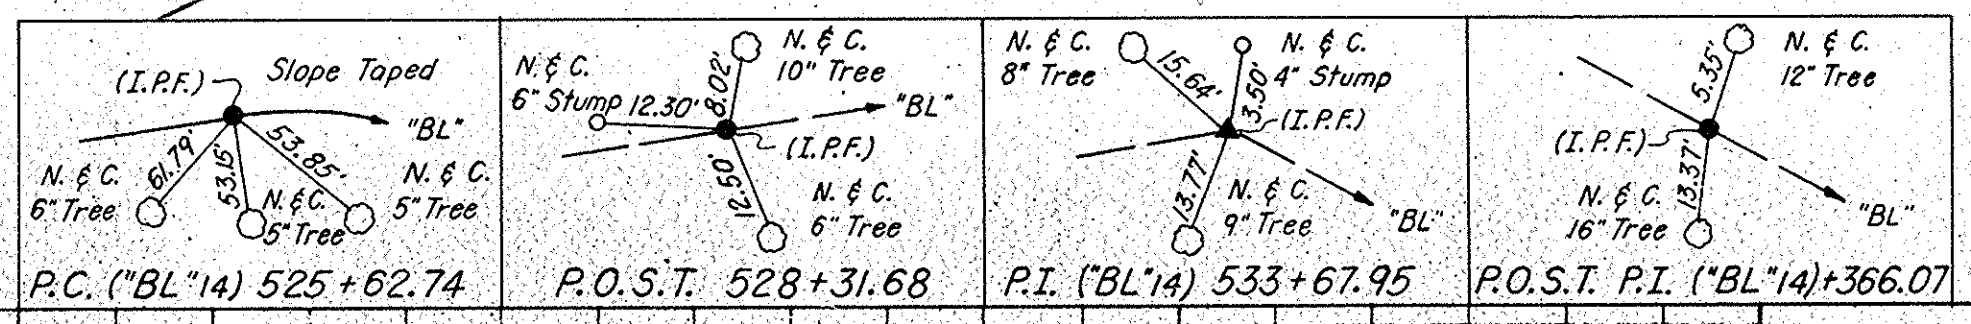

CURVE NO 14 LINE "BL"
 $\Delta = 38^{\circ}43'00''$ Rt
 $D = 2^{\circ}30'00''$
 $R = 2291.83'$
 $T = 805.21'$
 $L = 1548.67'$
 $E = 137.34'$
 Rate of Superlev. 0.069/ft.

R/W on this sheet taken from Line "BL" except as noted. All R/W on this sheet to be as shown. Limited Access Provisions to apply where indicated. For R/W Limits Rt. see preceding sheet.

Perm. 0	Bt. Spike in 56" Oak 48" Rt. Sta. 514+50 "B"	= El. 830.19
B.M. #74 "B"	Bt. Spike in 36" Cedar 230' Rt. Sta. 515+95 "B"	= El. 830.46
B.M. #75 "B"	Bt. Spike in E. Side 18" Poplar. (Up 4') 22' Lt. Sta. 523+22 "B"	= El. 805.23
B.M. #76 "B"	Bt. Spike in 15' Poplar 63' Lt. Sta. 534+96 "B"	= El. 830.69

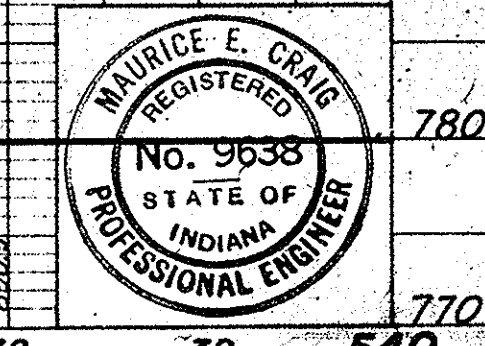
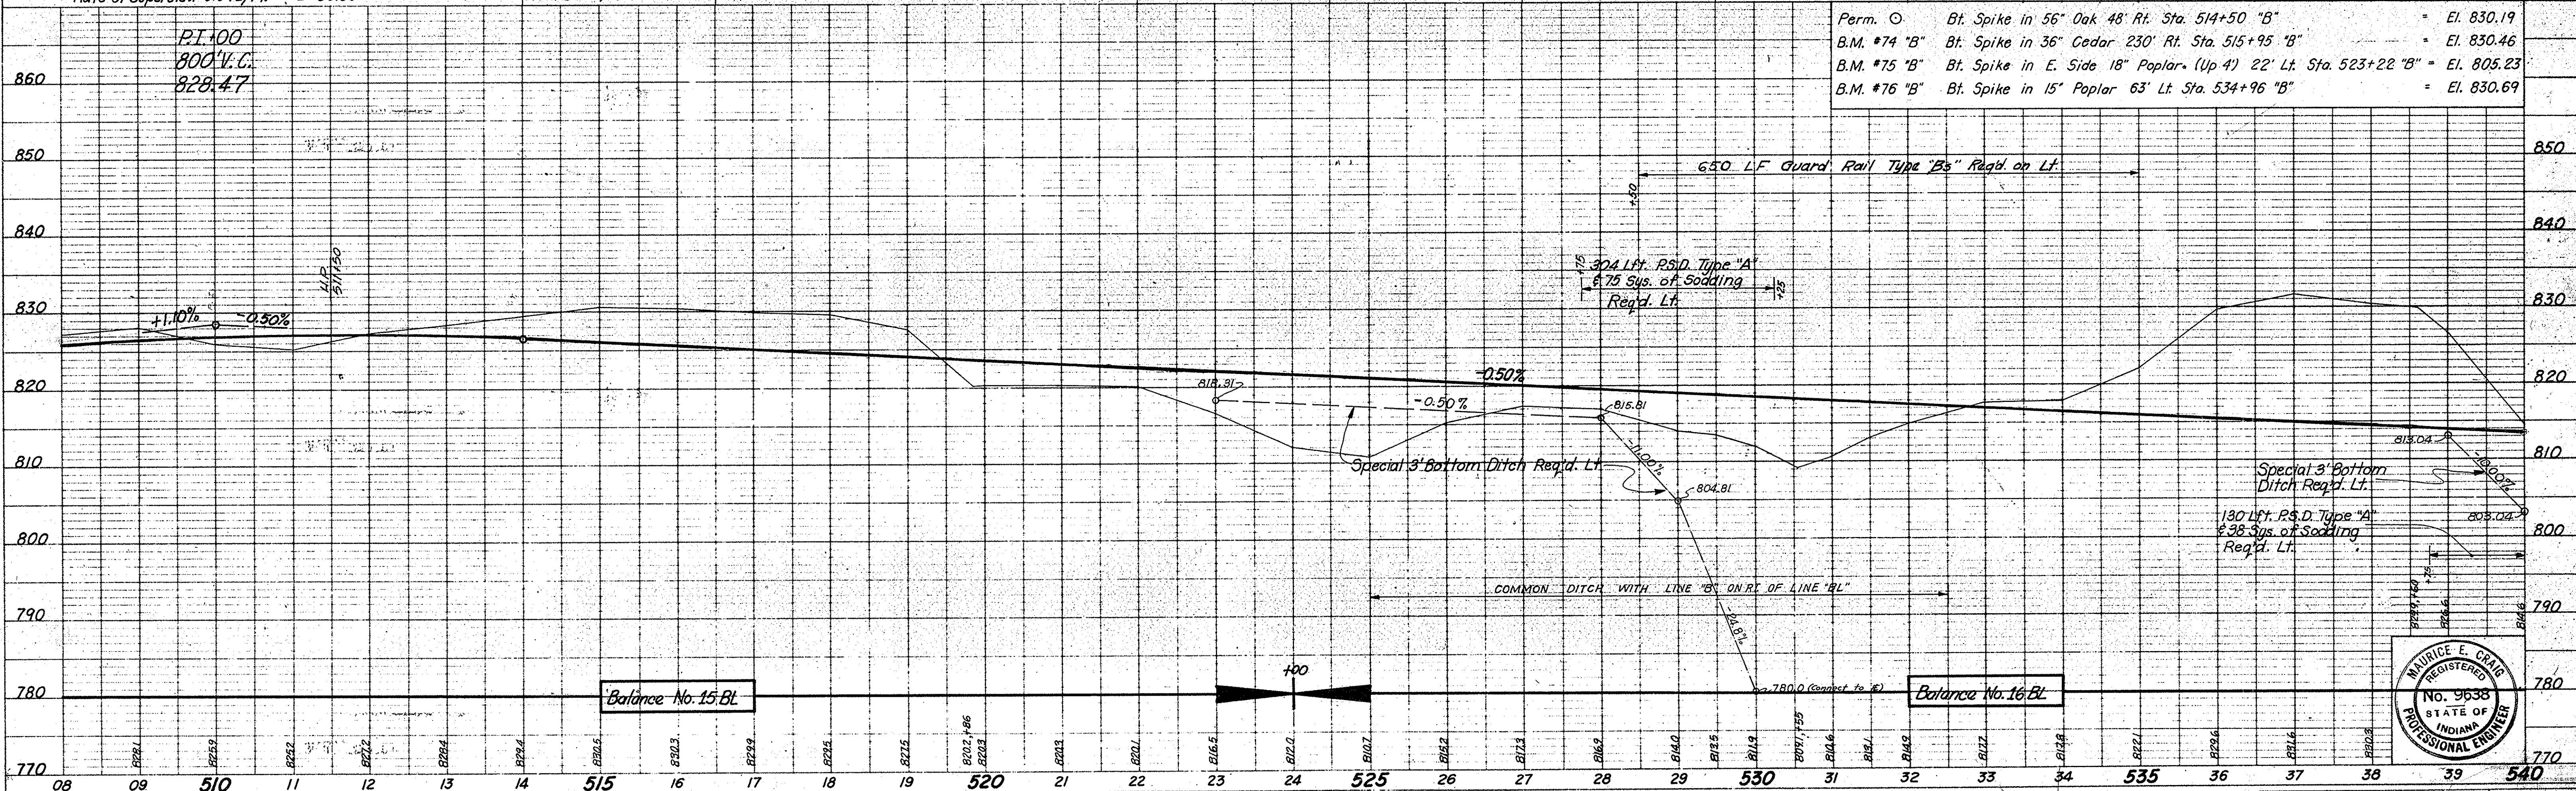


PROJECT NO.	LINE	SHEET NO.	TOTAL SHEETS	FILE
I-64-3(3)86	"BL"	82		

FEDERAL ROAD REGION NO.	STATE	PROJECT NO.	FISCAL YEAR	SHEET NO.	TOTAL SHEETS
4	IND.	I-64-3(3)BL	1967	84	


PLAN
 SURVEYED BY: J. S. H. C.
 CHECKED BY: J. S. H. C.
 DATE: 1/16/66
 NOTE BOOK: 1-166
 NO. 23164
 STRUCTURE NOTATIONS CHECKED: J.E.C.
 DATE: 7-66

PROFILE
 SURVEYED BY: J. S. H. C.
 CHECKED BY: J. S. H. C.
 DATE: 1/16/66
 NOTE BOOK: 1-166
 NO. 23164
 STRUCTURE NOTATIONS CHECKED: J.E.C.
 DATE: 7-66

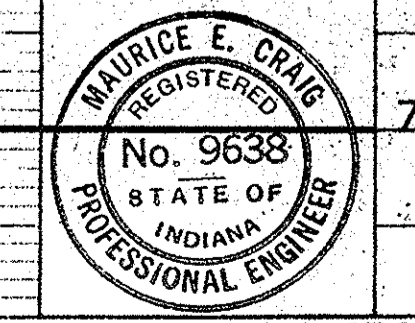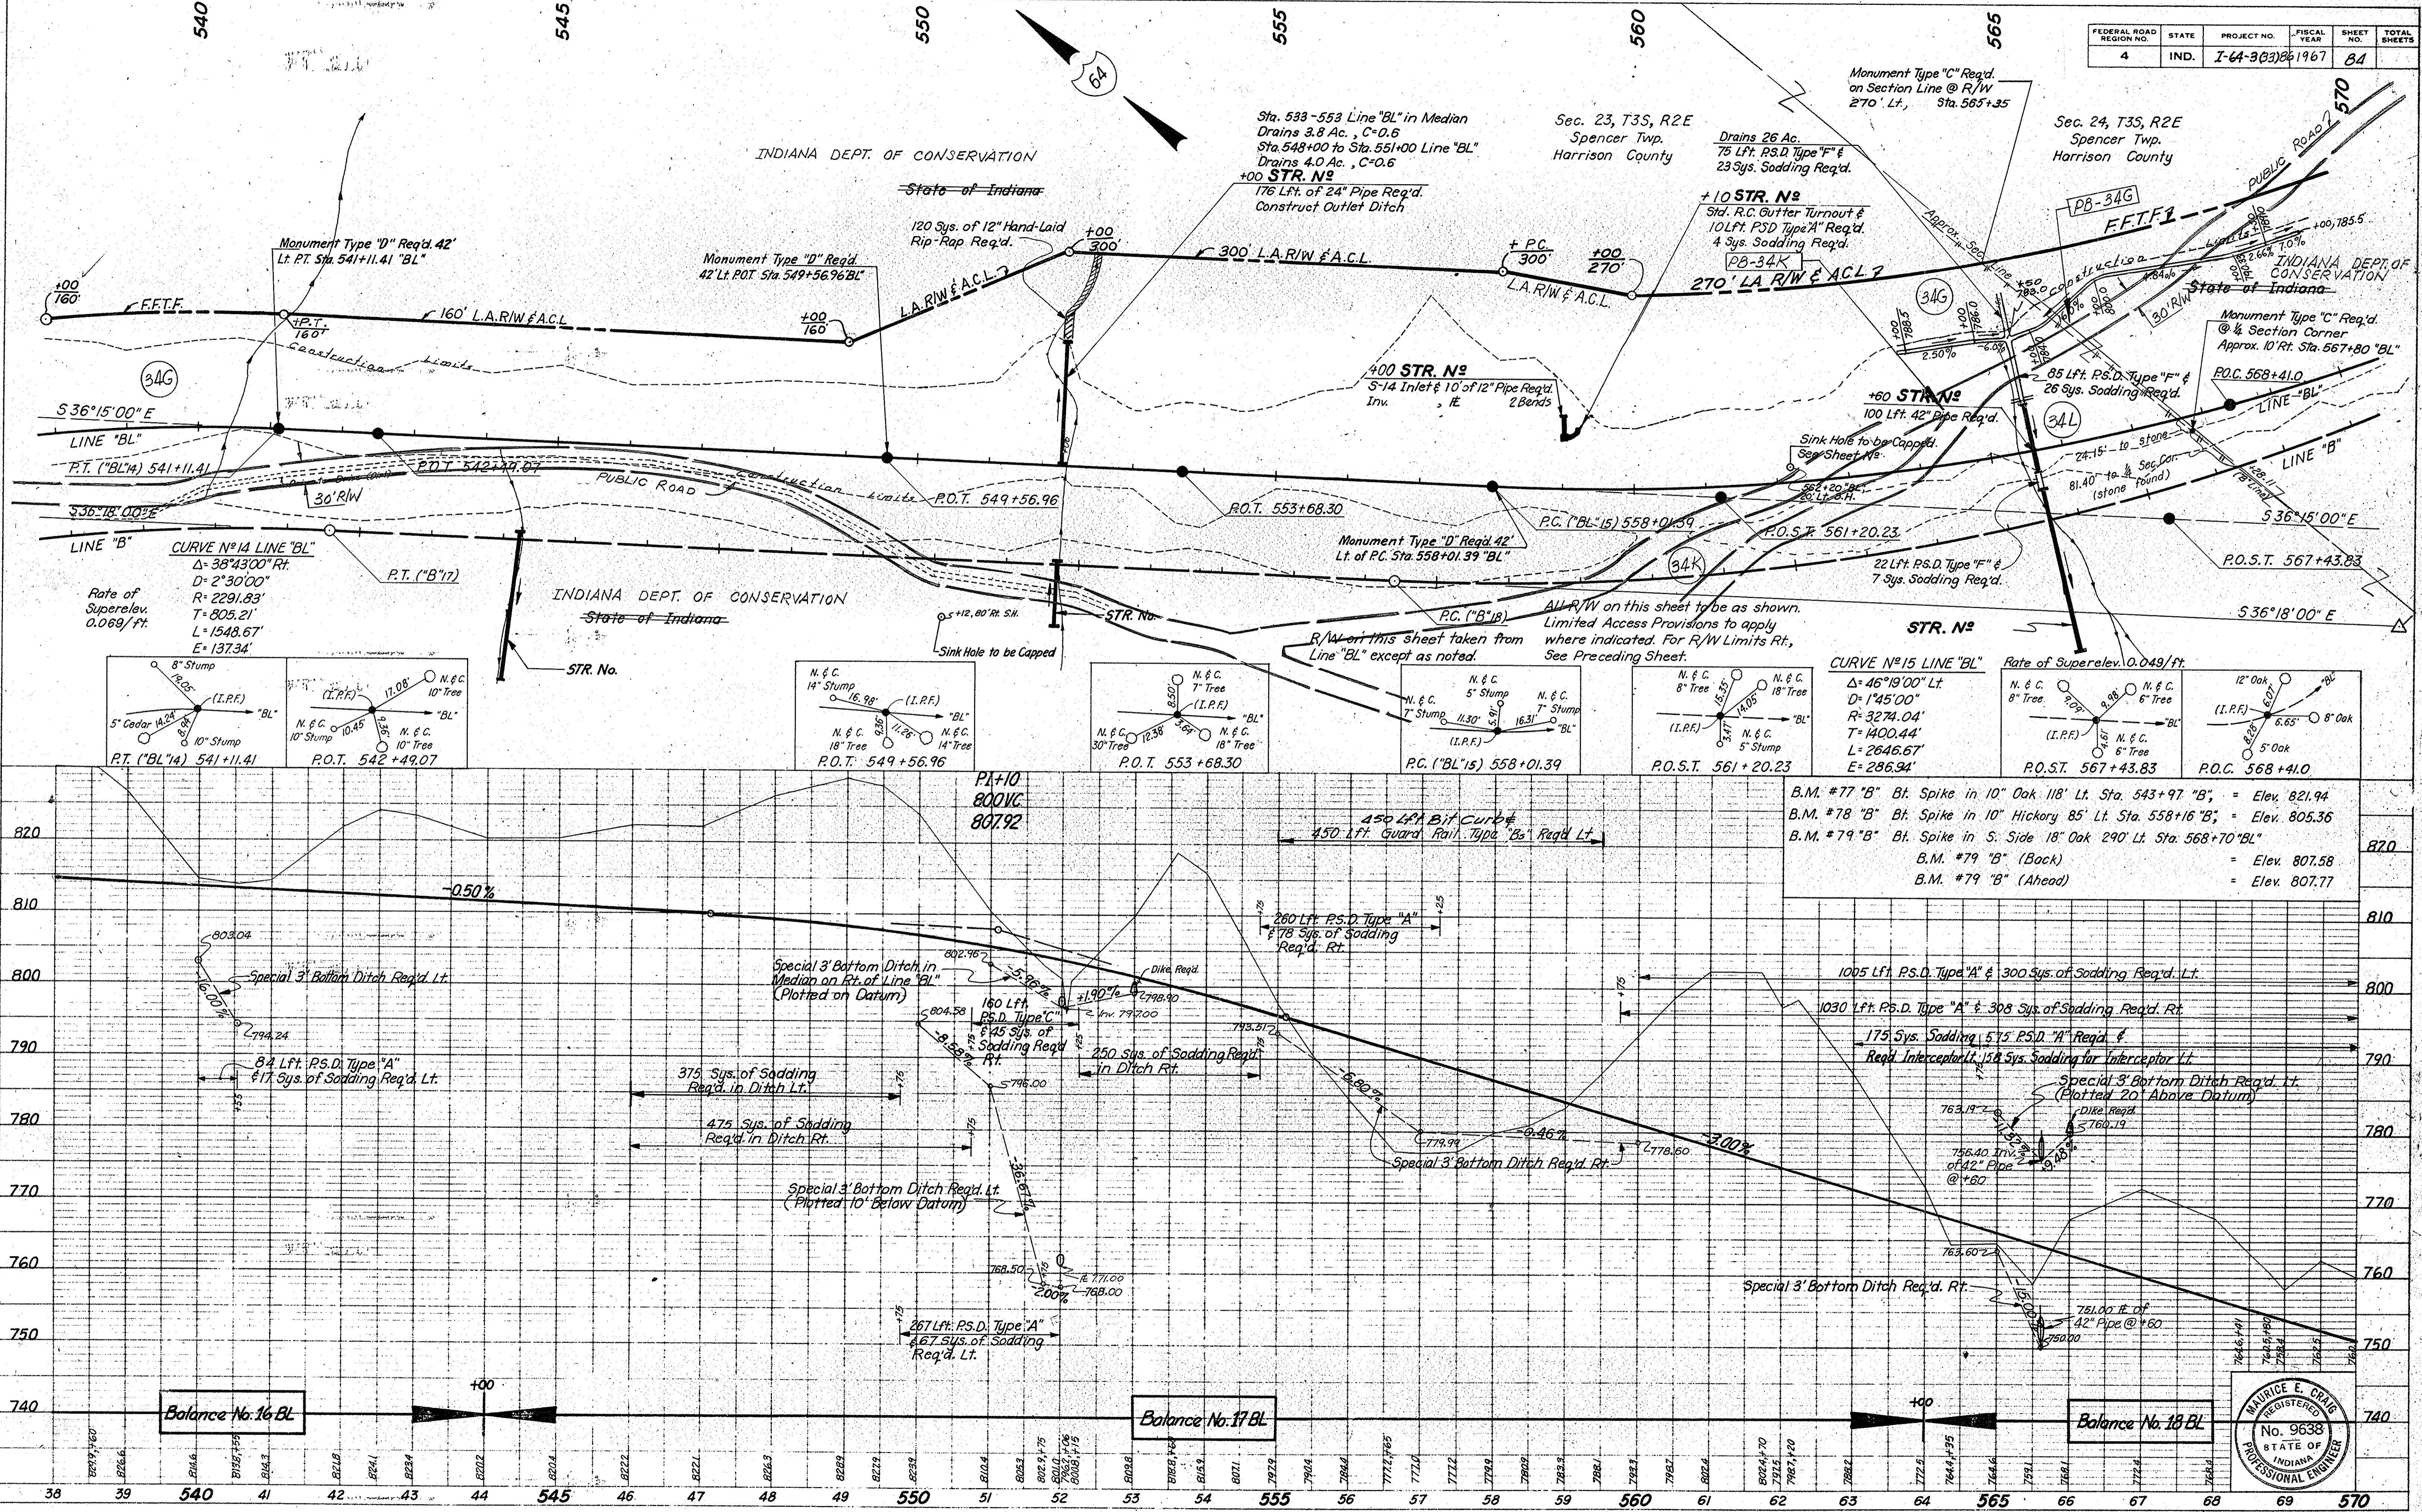


PROJECT NO.	LINE NO.	SHEET NO.	TOTAL SHEETS	FILE
I-64-3(3)BL	"BL"	84		

FEDERAL ROAD REGION NO.	STATE	PROJECT NO.	FISCAL YEAR	SHEET NO.	TOTAL SHEETS
4	IND.	I-64-3(33)85	1967	83	88

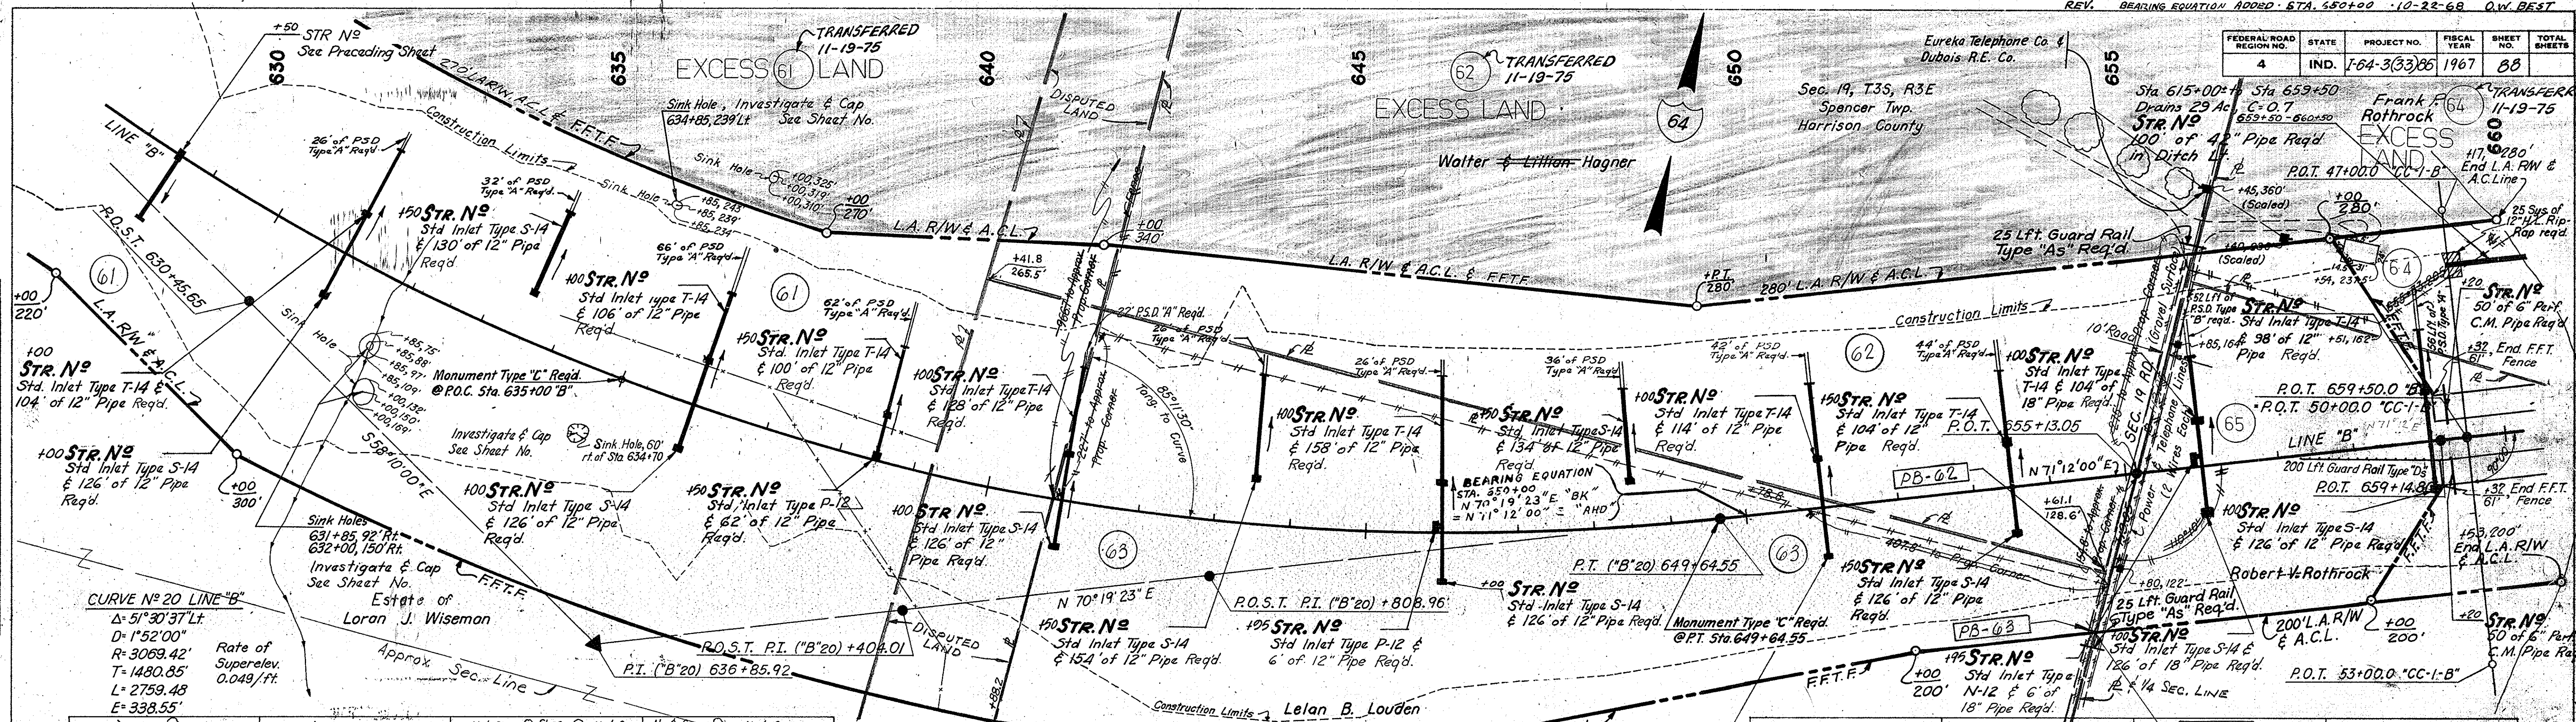

PLAN
 SHEETED BY: S.E.L.C.
 DATE: 11-19-75
 NOTE BOOK ALIGNMENT CHECKED
 NO. 23171, STRUCTURE NOTATIONS CHECKED

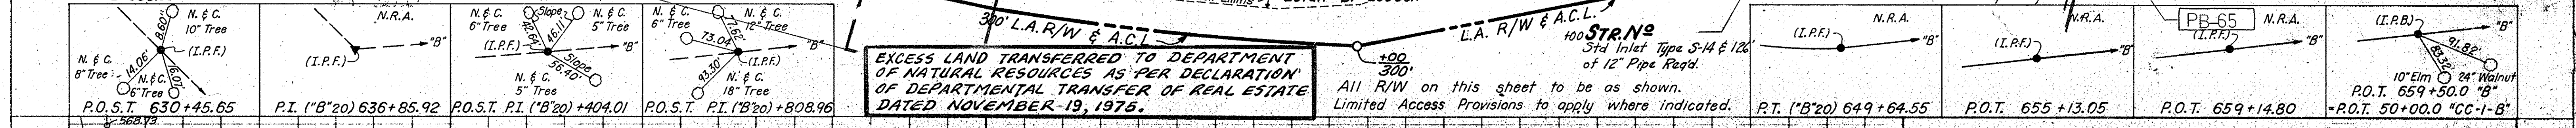

PROFILE
 SHEETED BY: S.E.L.C.
 DATE: 11-19-75
 NOTE BOOK GRADES CHECKED
 NO. 23171, STRUCTURE NOTATIONS CHECKED


EXCESS LAND TRANSFERRED TO DEPARTMENT OF NATURAL RESOURCES AS PER DECLARATION OF DEPARTMENTAL TRANSFER OF REAL ESTATE DATED NOVEMBER 13, 1975.

All R/W on this sheet to be as shown.
 Limited Access Provisions to apply where indicated.

- B.M. #90 Bt. Spike in 18" Walnut 340' Lt. Sta. 636+50 = El. 480.25
- B.M. #91 Bt. Spike in 12" Box Elder 344' Lt. Sta. 644+92 = El. 454.75
- B.M. #92 Bt. Spike in Pwp. 364' Lt. Sta. 656+53 = El. 454.53
- B.M. #93 Bt. Spike in 14" Walnut 348' Lt. Sta. 659+65 = El. 445.77

Balance No. 21

Balance No. 22

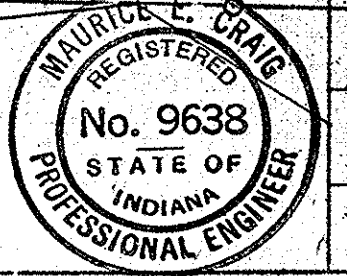


PROJECT NO.	LINE	SHEET NO.	TOTAL SHEETS	FILE
I-64-3(33)85	"B"	83	88	

FEDERAL ROAD DISTRICT NO.	STATE	PROJECT NO.	FISCAL YEAR	SHEET NO.	TOTAL SHEETS
4	IND.	1-64-3(33)86	1967	89	

Sec. 19, T35, R3E
Spencer Twp.
Harrison County

Sec. 20, T35, R3E
Spencer Twp.
Harrison County


EXCESS LAND TRANSFERRED TO DEPARTMENT OF NATURAL RESOURCES AS PER DECLARATION OF DEPARTMENTAL TRANSFER OF REAL ESTATE DATED NOVEMBER 13, 1975.

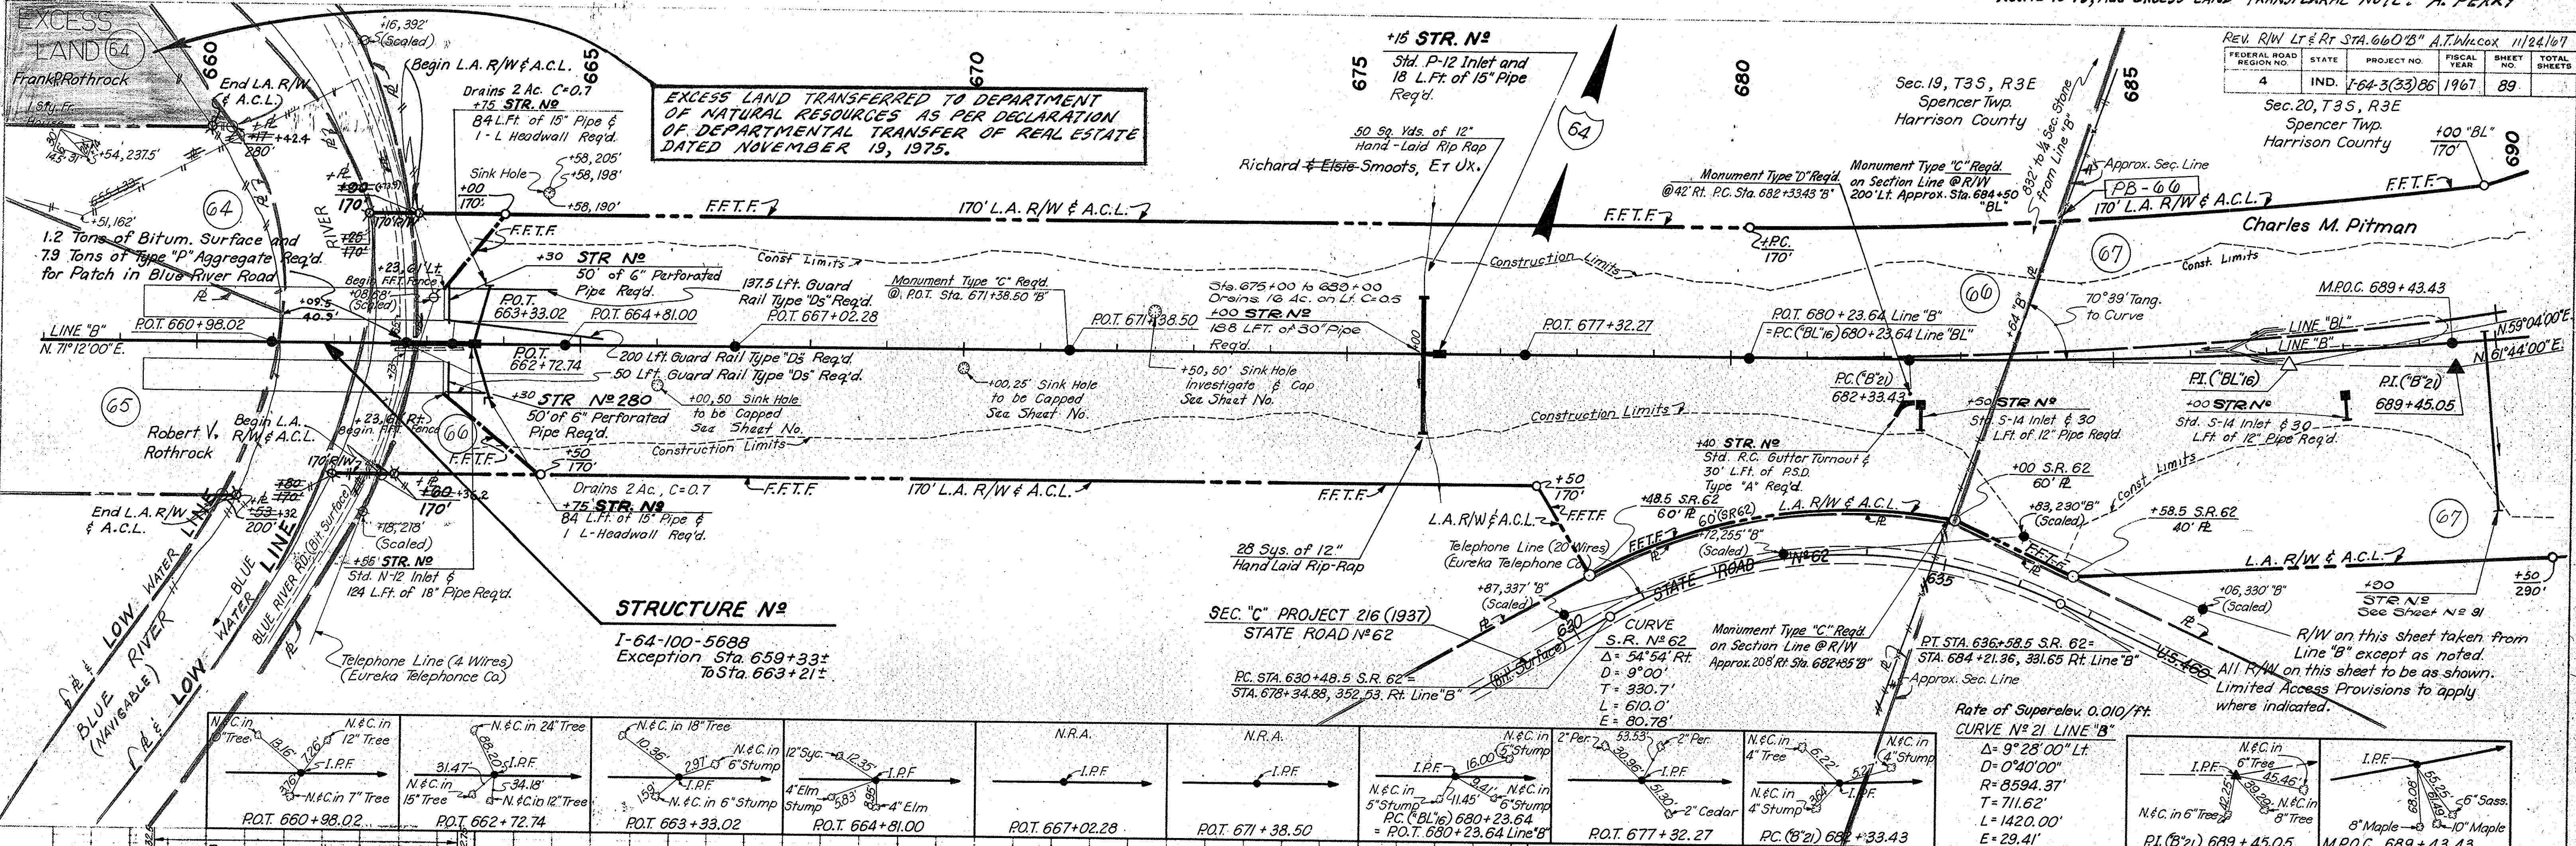

PLAN
DATE: 11/66
BY: J.P.G.
CHECKED: M.E.C.
NOTED: M.E.C.
NO. 99771

PROFILE
DATE: 11/66
BY: J.P.G.
CHECKED: M.E.C.
NOTED: M.E.C.
NO. 99771

Station	Notes
P.O.T. 660+98.02	N. & C. in 7" Tree
P.O.T. 662+72.74	N. & C. in 12" Tree
P.O.T. 663+33.02	N. & C. in 18" Tree
P.O.T. 664+81.00	N. & C. in 12" Tree
P.O.T. 667+02.28	N.R.A.
P.O.T. 671+38.50	N.R.A.
P.O.T. 677+32.27	N. & C. in 4" Stump
P.C. (B'2) 682+33.43	N. & C. in 4" Stump

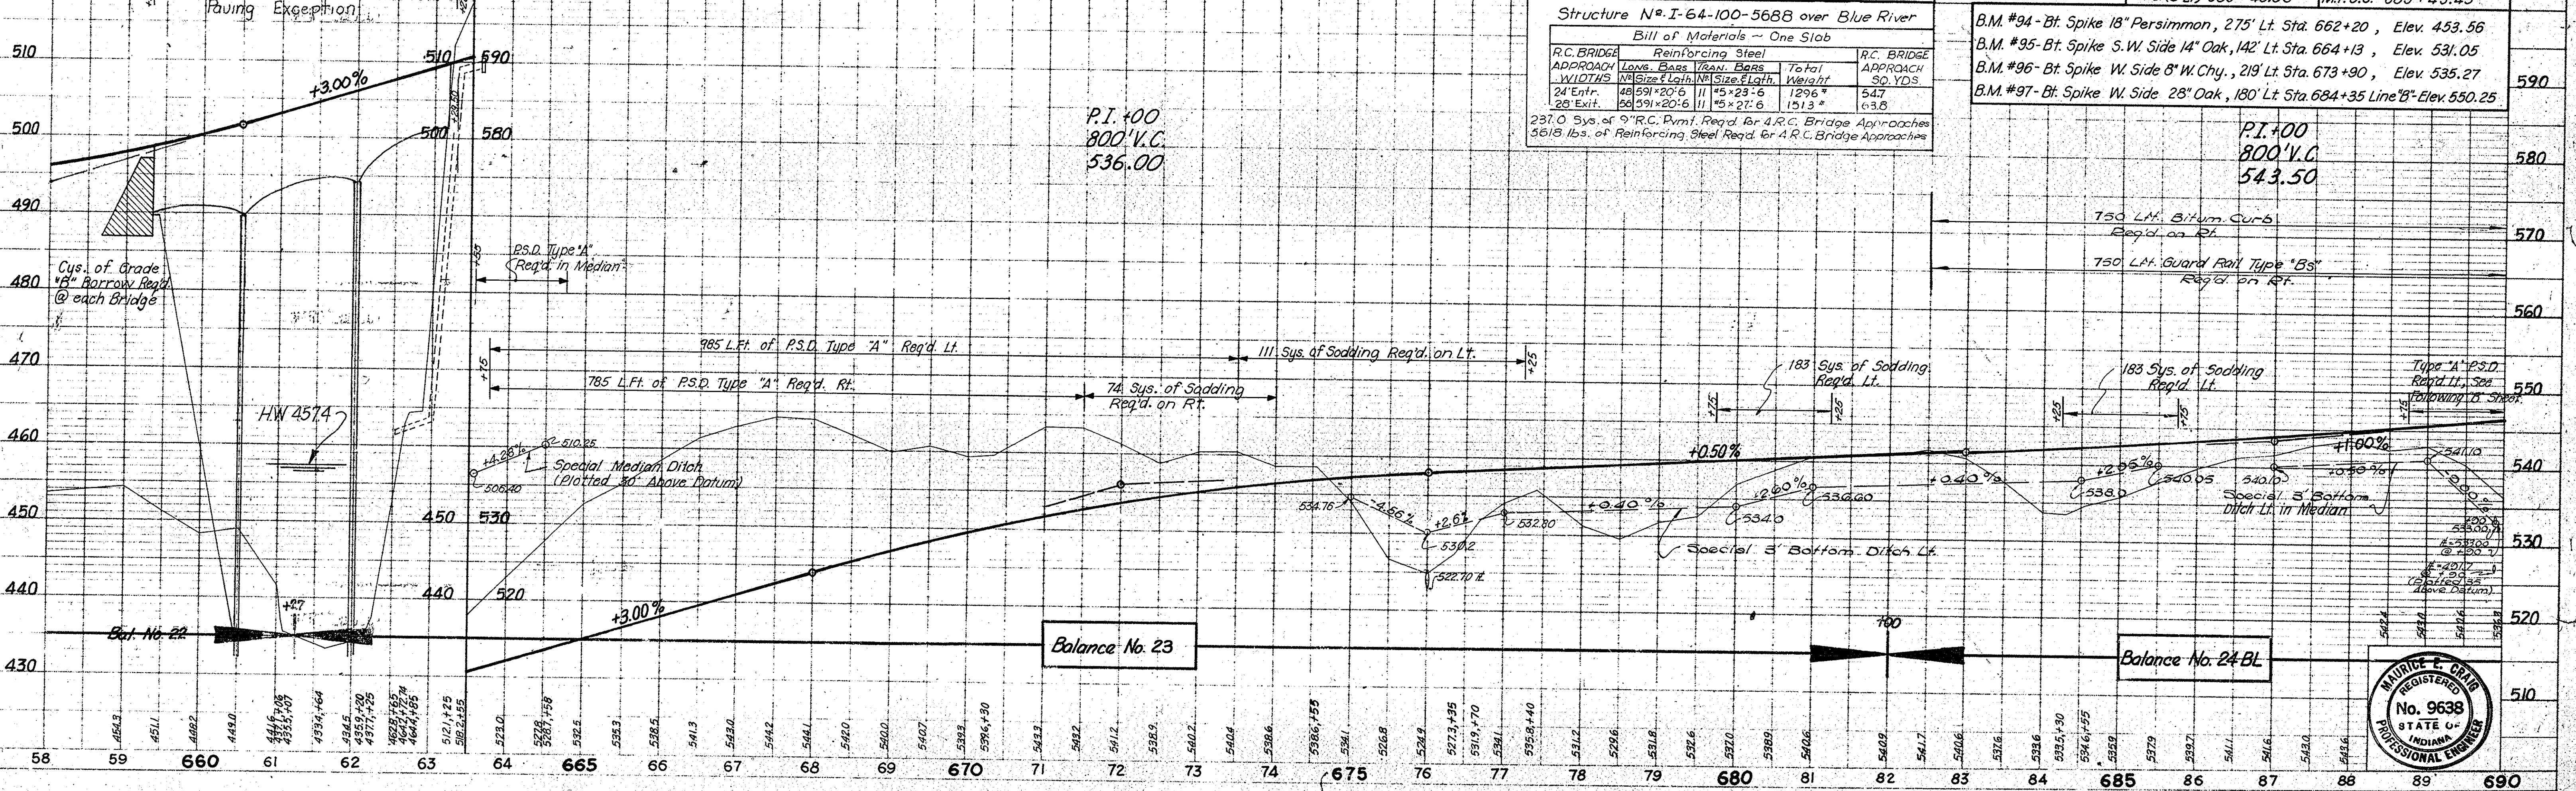


Structure No. I-64-100-5688 over Blue River

APPROACH	LONG. BARS	TRANS. BARS	Total Weight	APPROACH SO. YDS.
24' Entr.	48 5/8" x 20' 6"	11 5/8" x 23' 6"	1296*	547
28' Exit.	60 5/8" x 20' 6"	11 5/8" x 23' 6"	1513*	638

237.0 Sys. of 9" R.C. Pymt. Req'd for 4 R.C. Bridge Approaches
5618 lbs. of Reinforcing Steel Req'd for 4 R.C. Bridge Approaches

B.M. #	Description	Station	Elevation
#94	Bt. Spike 18" Persimmon	275' Lt. Sta. 662+20	Elev. 453.56
#95	Bt. Spike S.W. Side 14" Oak	142' Lt. Sta. 664+13	Elev. 531.05
#96	Bt. Spike W. Side 8" W. Chy.	219' Lt. Sta. 673+90	Elev. 535.27
#97	Bt. Spike W. Side 28" Oak	180' Lt. Sta. 684+35 Line 'B'	Elev. 550.25

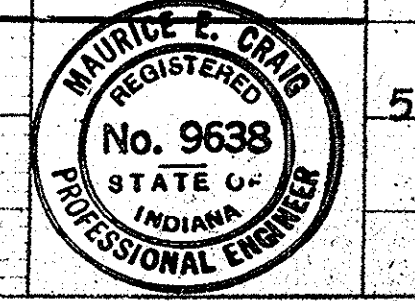




FEDERAL ROAD REGION NO.	STATE	PROJECT NO.	FISCAL YEAR	SHEET NO.	TOTAL SHEETS
4	IND.	1-64-3(33)86	1967	90	

Sec. 19, T.3S, R.3E.
Spencer Twp.
Harrison County

Sec. 20, T.3S, R.3E.
Spencer Twp.
Harrison County.



PLAN	DATE	BY
NOTED	3-66	J.S.C.
NOTED	7-66	G.E.C.
NOTED	7-66	P.D.G.
NOTED	7-66	D.F.D.

PROFILE	DATE	BY
NOTED	3-66	J.S.C.
NOTED	7-66	G.E.C.
NOTED	7-66	P.D.G.
NOTED	7-66	D.F.D.

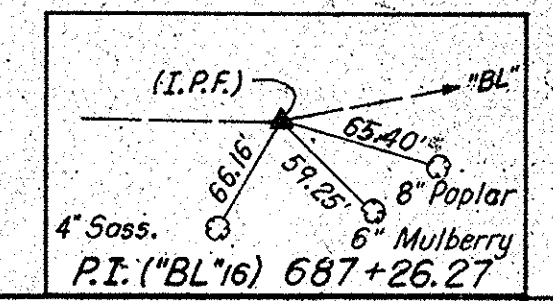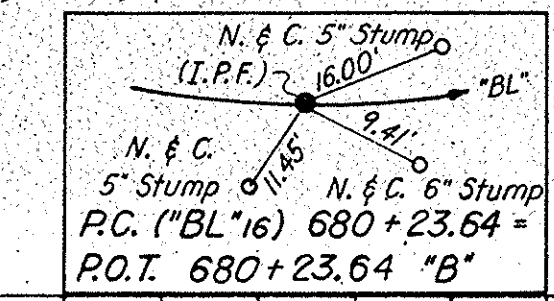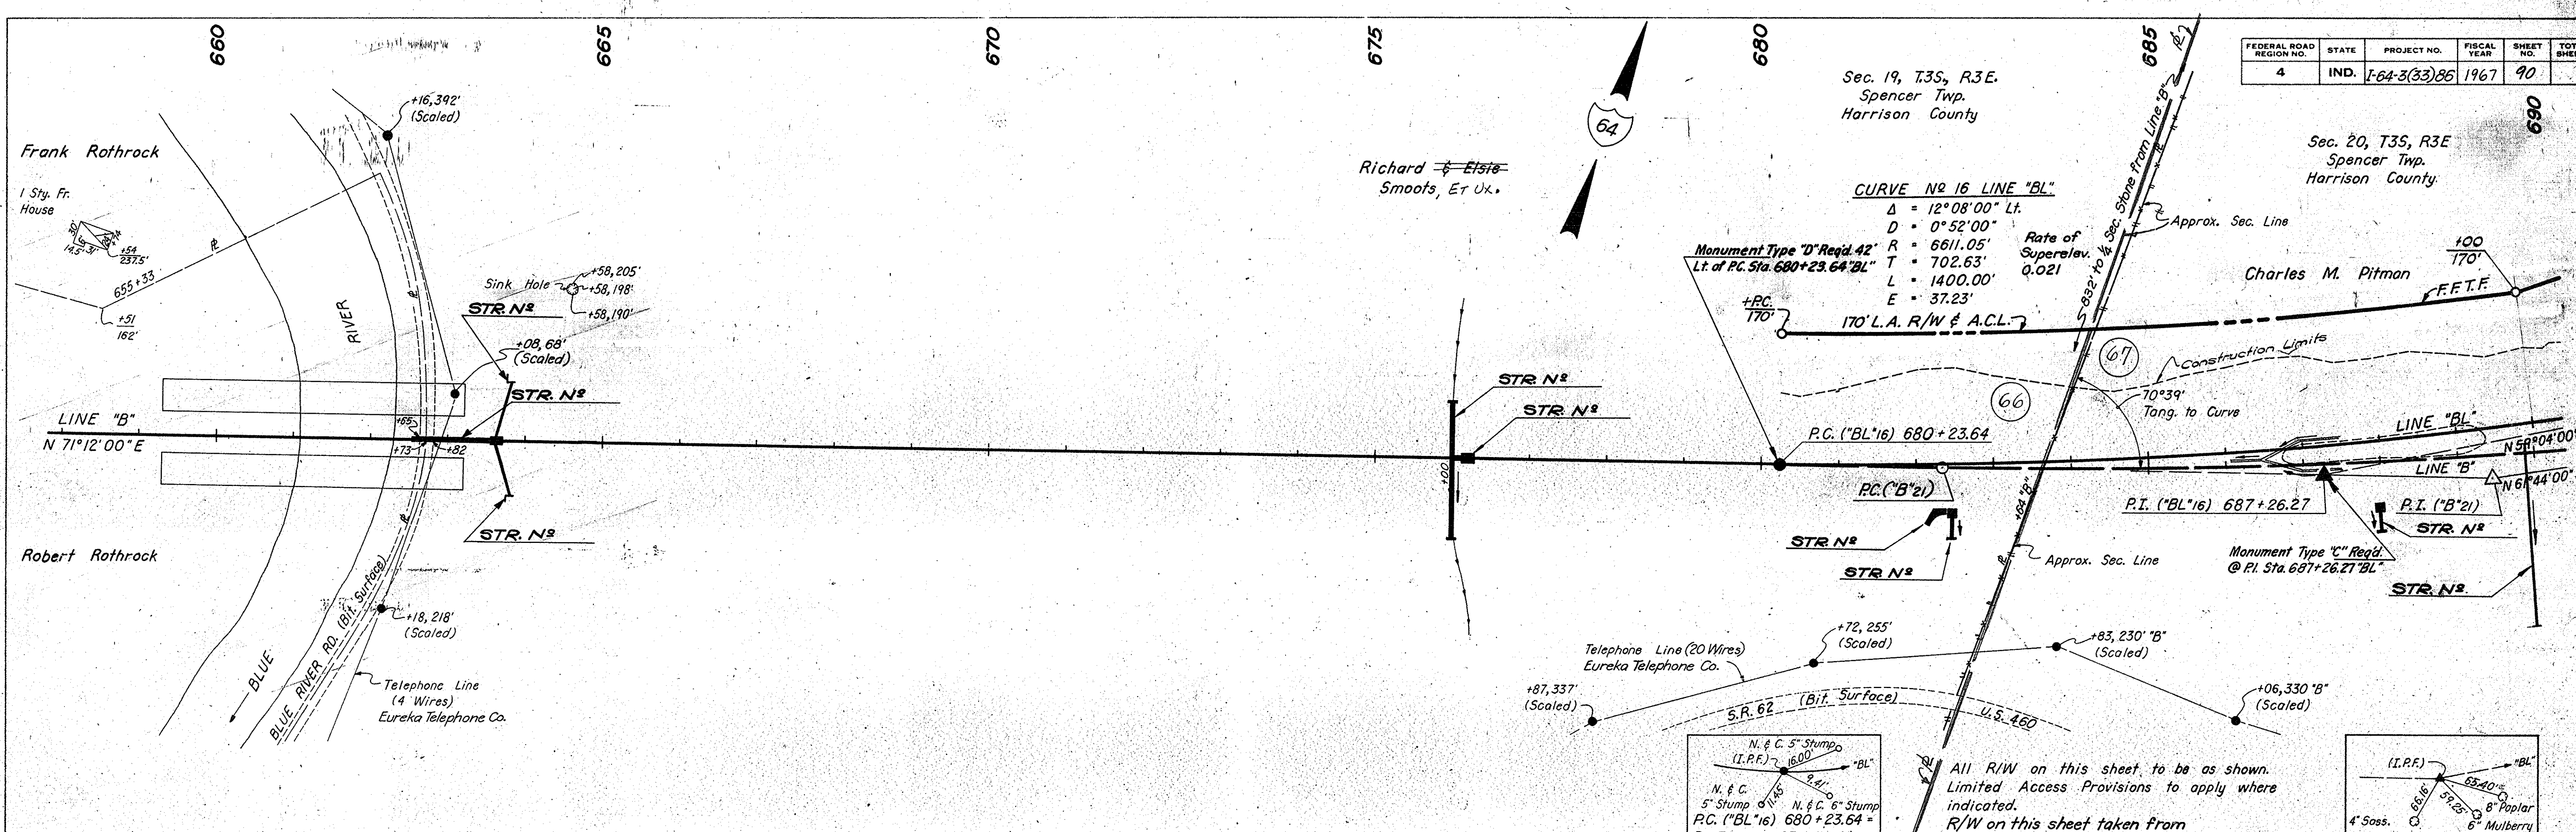


All R/W on this sheet to be as shown. Limited Access Provisions to apply where indicated.
 R/W on this sheet taken from Line "BL" except as noted.

- B.M. #94 Bt. Spike in 18" Persimmon 275' Lt. Sta. 662+20 Elev. 453.56
- B.M. #95 Bt. Spike in S.W. Side 14" Oak 142' Lt. Sta. 664+13 Elev. 531.05
- B.M. #96 Bt. Spike in W. Side 8" W. Cherry 219' Lt. Sta. 673+90 Elev. 535.27
- B.M. #97 Bt. Spike in W. Side 28" Oak 180' Lt. Sta. 684+35 "B" Elev. 550.25

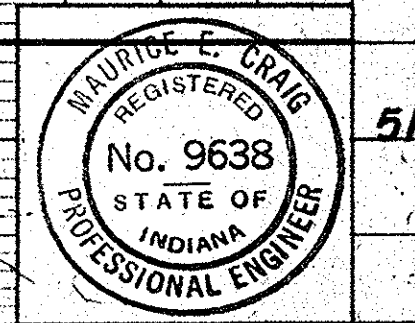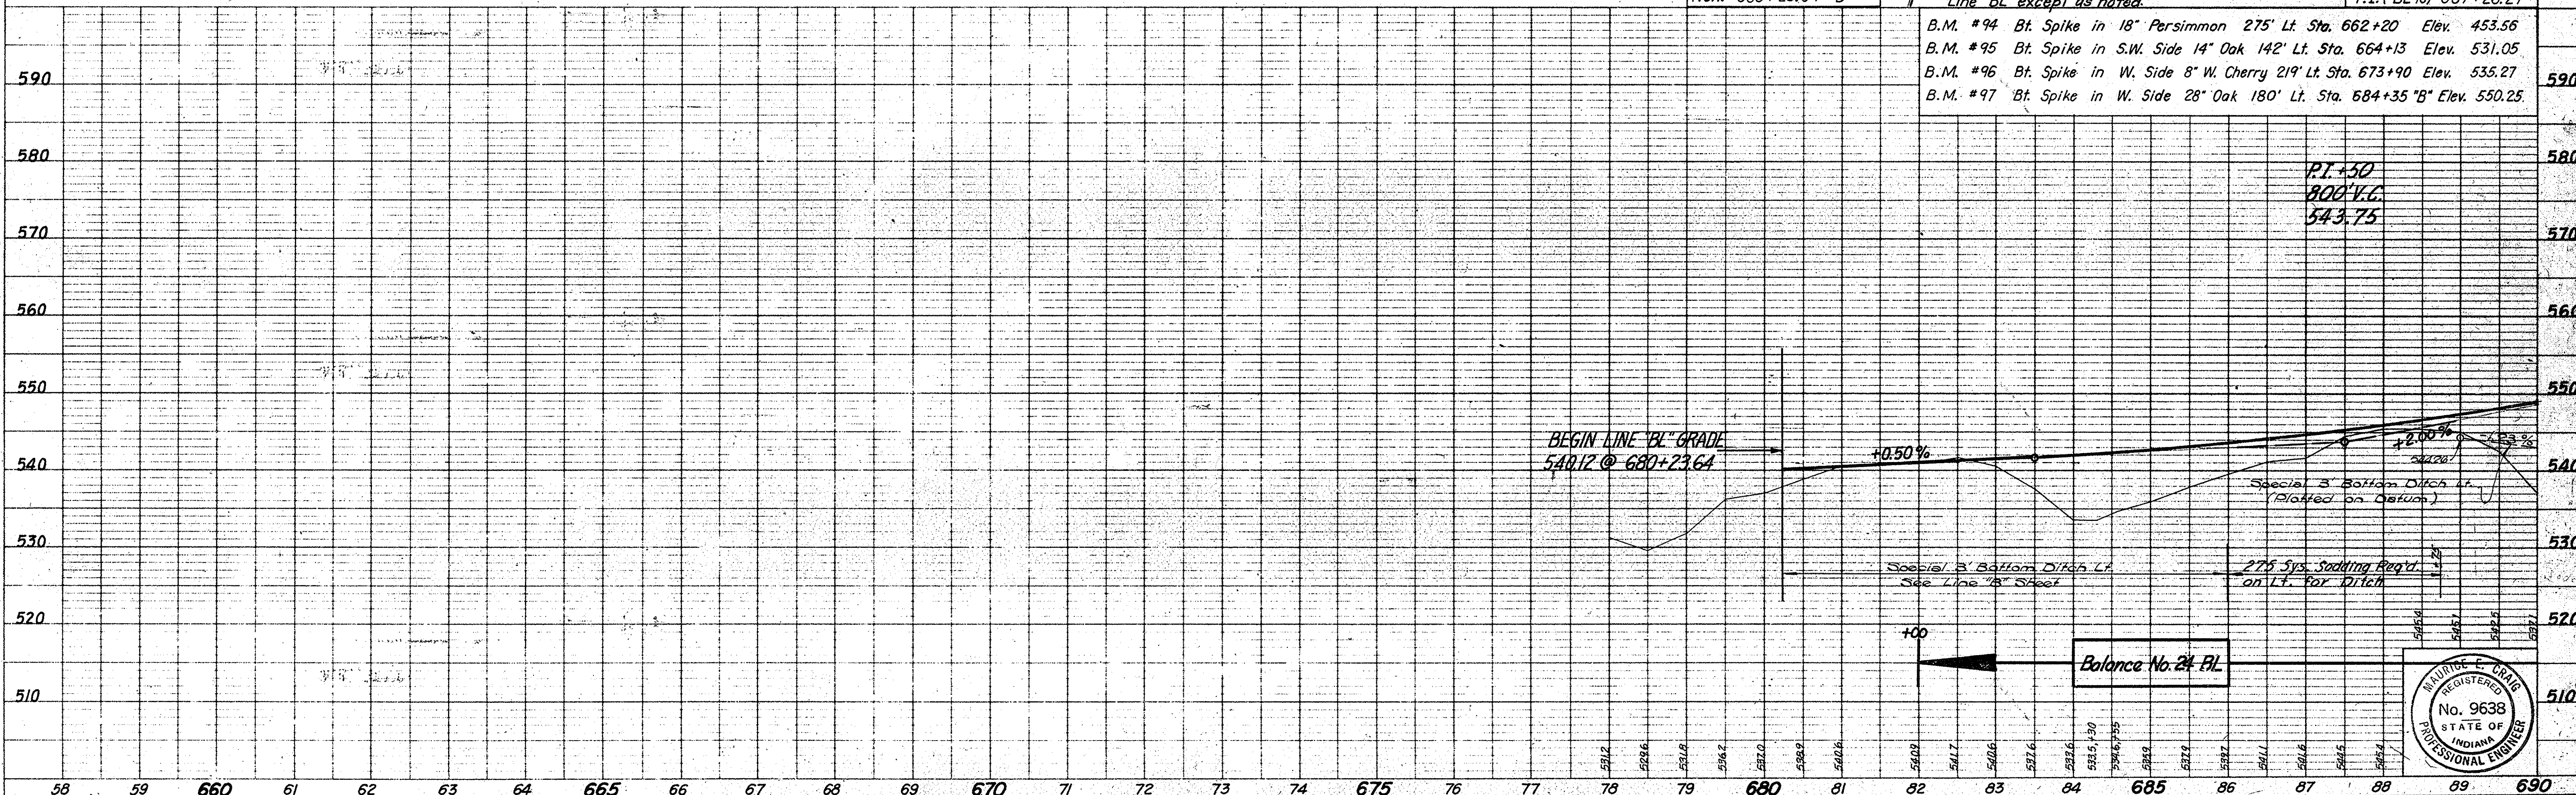

PROJECT NO.	LINE	SHEET NO.	TOTAL SHEETS	FILE
1-64-3(33)86	BL	90		

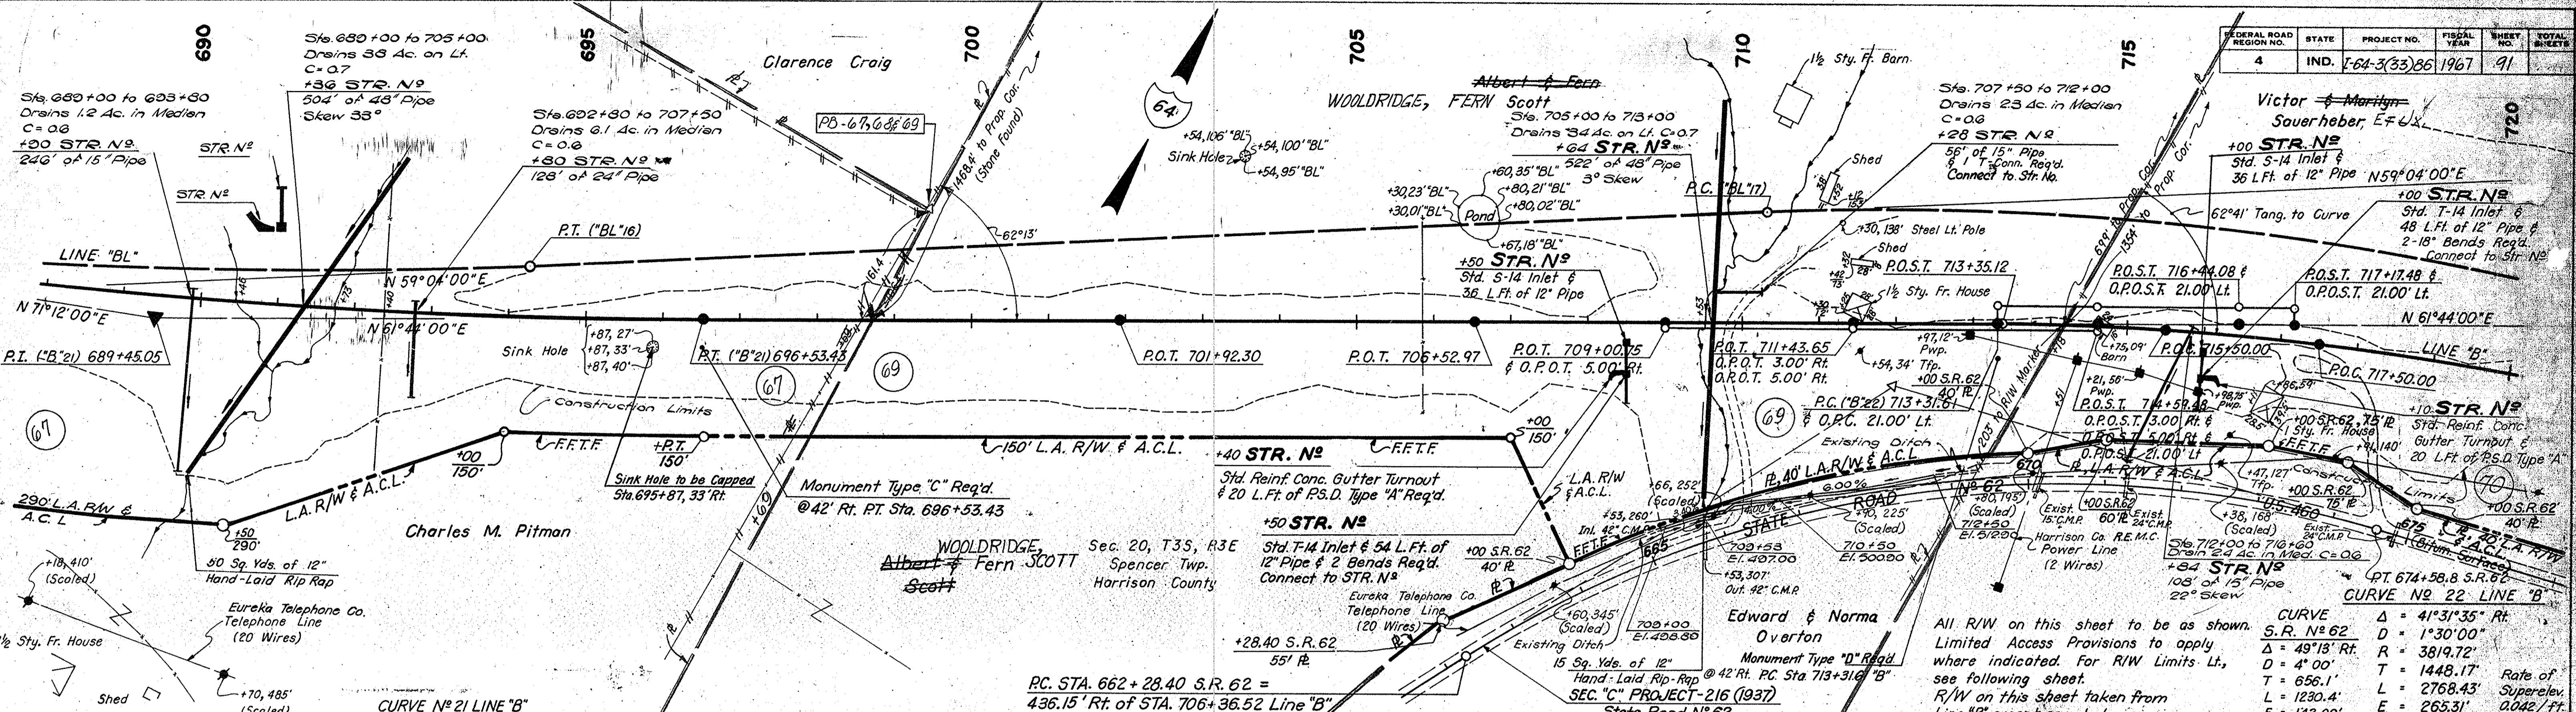


CURVE No 21 LINE "B"
 $\Delta = 9^{\circ}28'00''$ Lt
 $D = 0^{\circ}40'00''$
 $R = 8594.37'$
 $T = 711.62'$
 $L = 1420.00'$
 $E = 29.41'$
 Rate of Superlev. 0.010/ft.

PC. STA. 662+28.40 S.R. 62 = 436.15' Rt. of STA. 706+36.52 Line "B"


All R/W on this sheet to be as shown. Limited Access Provisions to apply where indicated for R/W Limits Lt., see following sheet. R/W on this sheet taken from Line "B" except as noted.


CURVE No 22 LINE "B"
 $\Delta = 41^{\circ}31'35''$ Rt
 $D = 1^{\circ}30'00''$
 $\Delta = 49'13''$ Rt. R = 3819.72
 $D = 4'00''$ T = 1448.17
 $L = 656.1'$ L = 2768.43
 $L = 1230.4'$ E = 265.31
 Rate of Superlev. 0.042/ft.

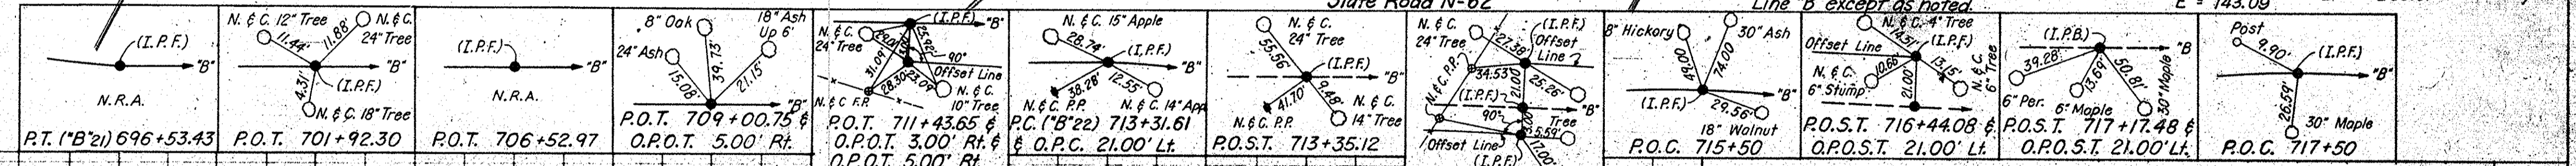

PLAN
 SHEET NO. 91
 DATE 11/2/66
 BY J.E.C.
 CHECKED J.E.C.
 IN CHARGE J.E.C.
 NO. 2817/L

PROFILE
 SHEET NO. 91
 DATE 11/2/66
 BY J.E.C.
 CHECKED J.E.C.
 IN CHARGE J.E.C.
 NO. 2817/L

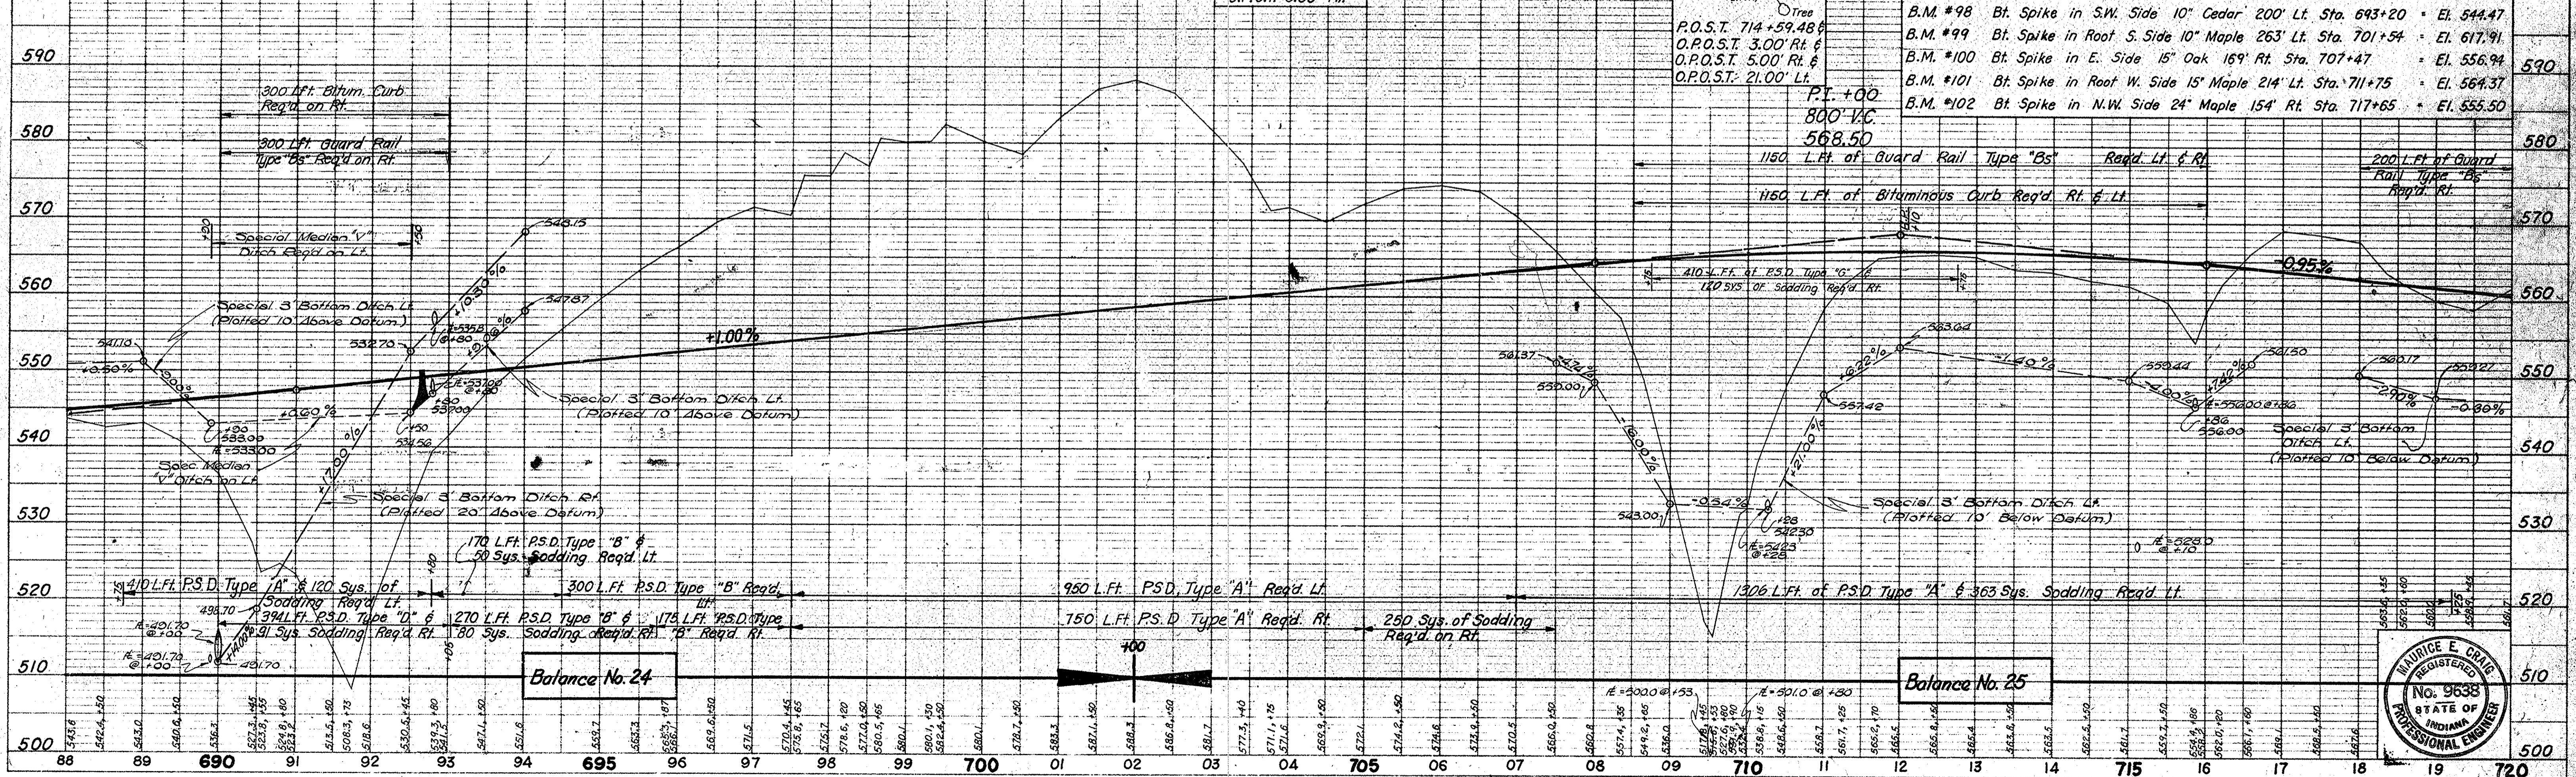


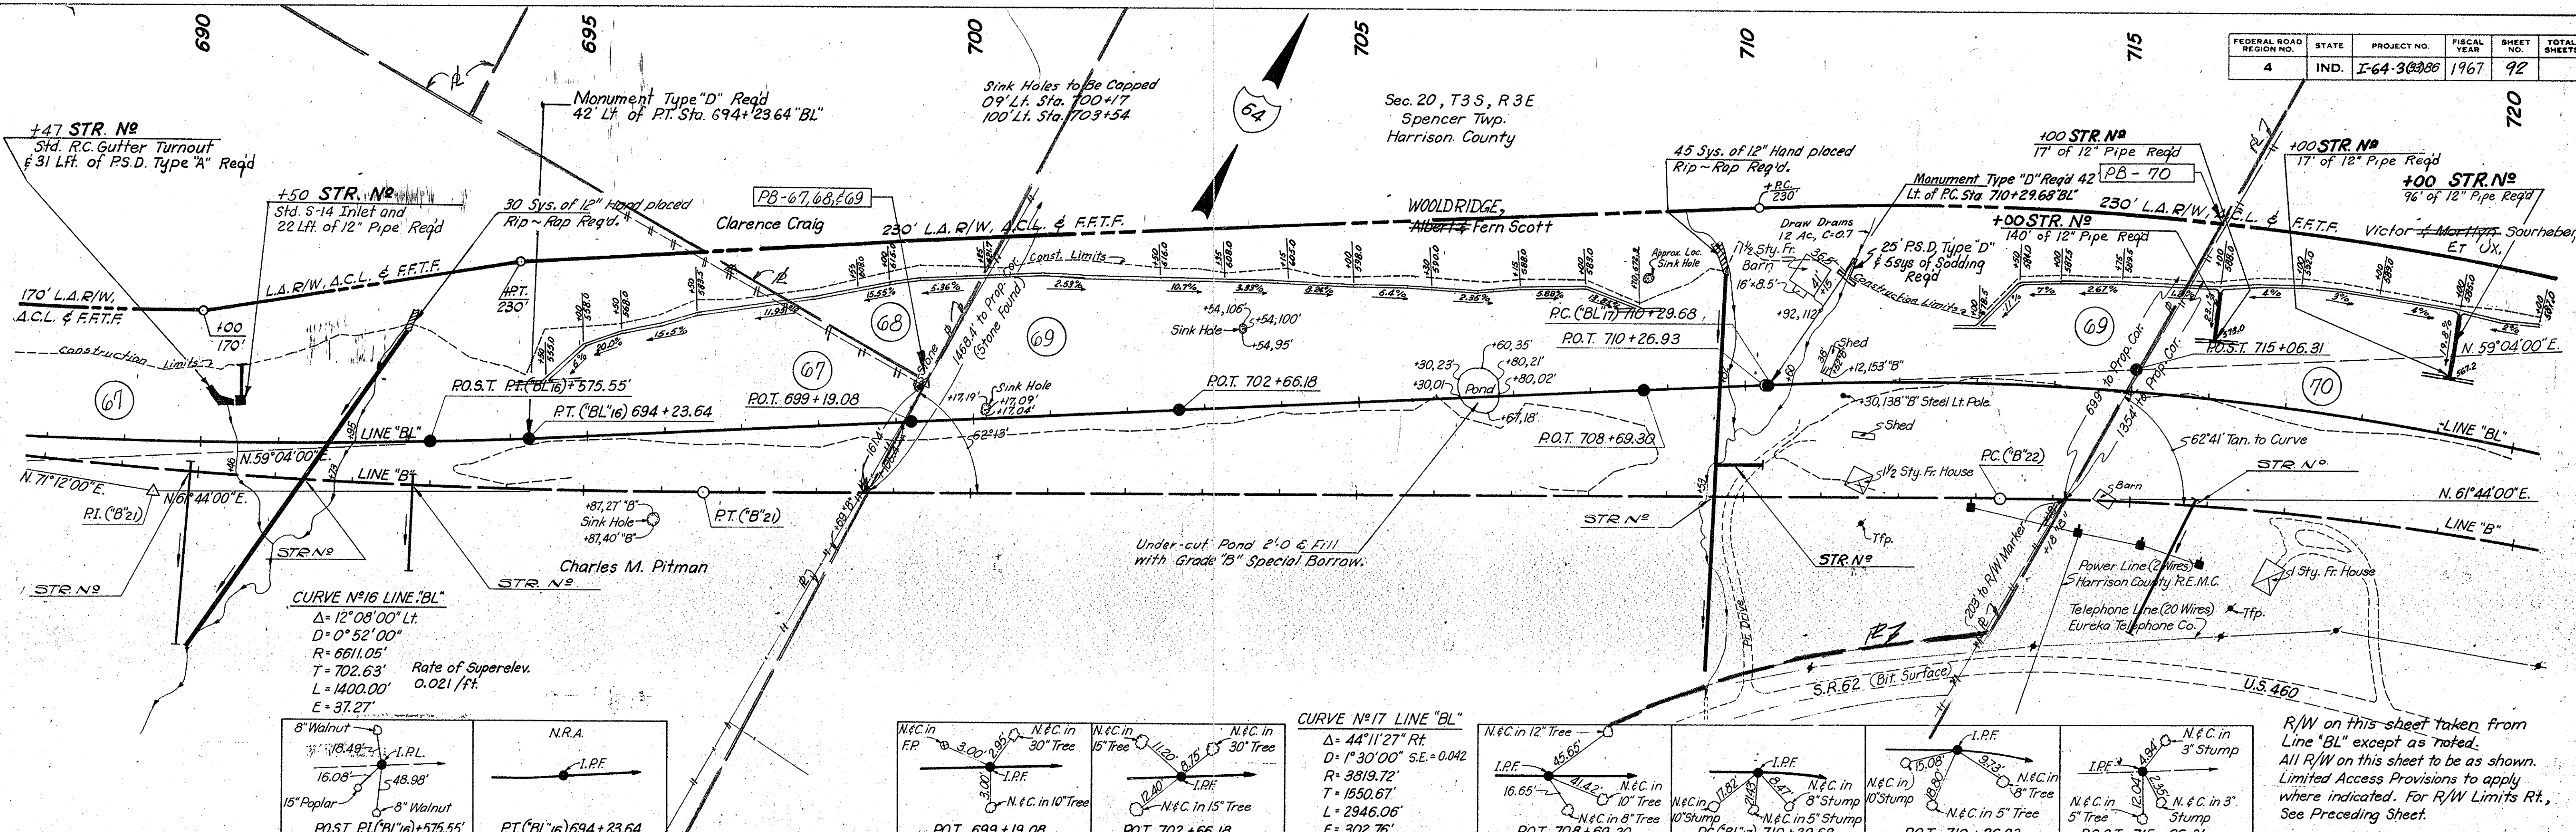

CURVE NO. 16 LINE "BL"
 $\Delta = 12^{\circ}08'00''$ Lt.
 $D = 0^{\circ}52'00''$
 $R = 6611.05'$
 $T = 702.63'$ Rate of Superelev. 0.021/ft.
 $L = 1400.00'$
 $E = 37.27'$


CURVE NO. 17 LINE "BL"
 $\Delta = 44^{\circ}11'27''$ Rt.
 $D = 1^{\circ}30'00''$ S.E. = 0.042
 $R = 3819.72'$
 $T = 1550.67'$
 $L = 2946.06'$
 $E = 302.76'$

R/W on this sheet taken from Line "BL" except as noted. All R/W on this sheet to be as shown. Limited Access Provisions to apply where indicated. For R/W Limits Rt. See Preceding Sheet.

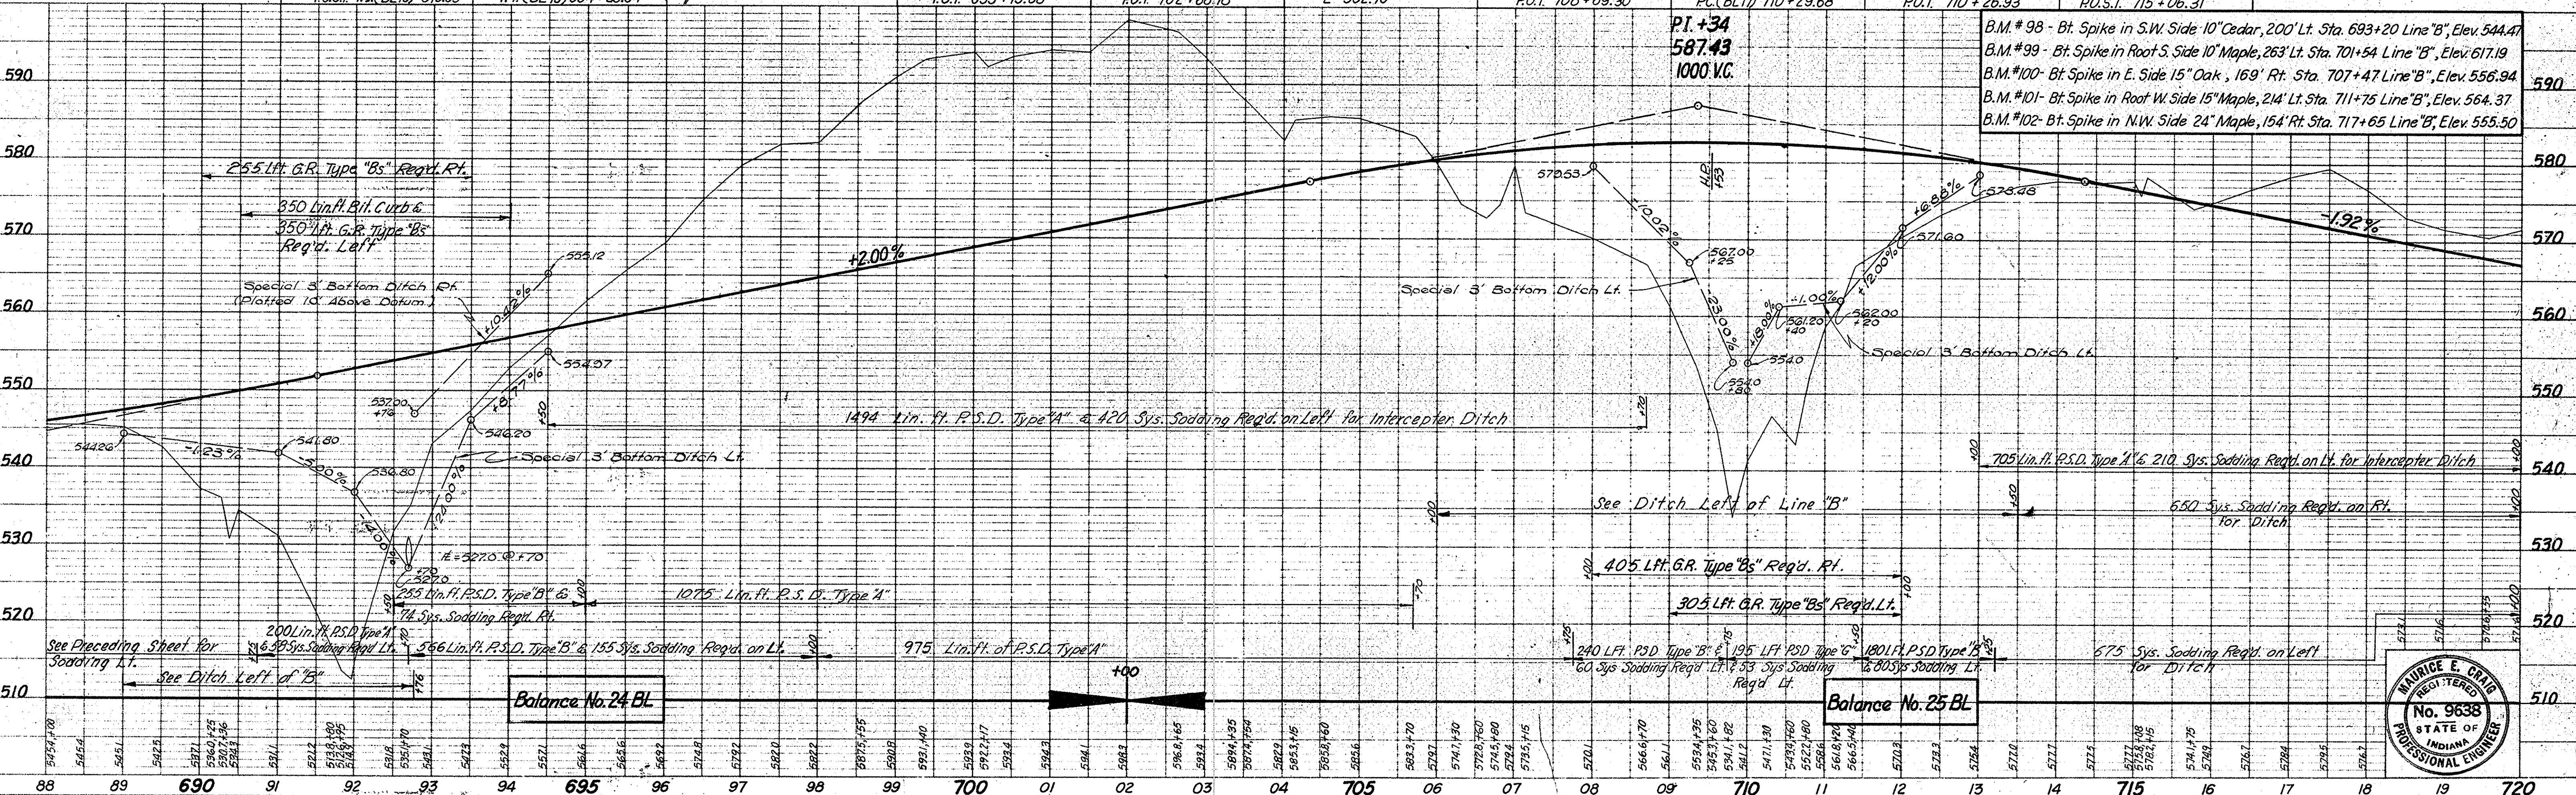

Balance No. 24 BL

Balance No. 25 BL

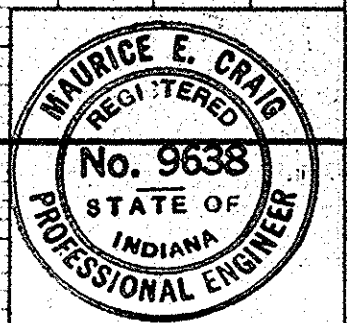


PLAN
 DATE: 4-16-66
 DESIGNED: J.E.C.
 CHECKED: J.E.C.
 IN CHARGE: J.E.C.

PROFILE
 DATE: 4-16-66
 DESIGNED: J.E.C.
 CHECKED: J.E.C.
 IN CHARGE: J.E.C.


FEDERAL ROAD REGION NO.	STATE	PROJECT NO.	FISCAL YEAR	SHEET NO.	TOTAL SHEETS
4	IND.	I-64-3(3)86	1967	93	150

DATE	BY	REVISION
11/66	M.E.C.	AS-C
11/66	M.E.C.	AS-C
11/66	M.E.C.	AS-C
11/66	M.E.C.	AS-C

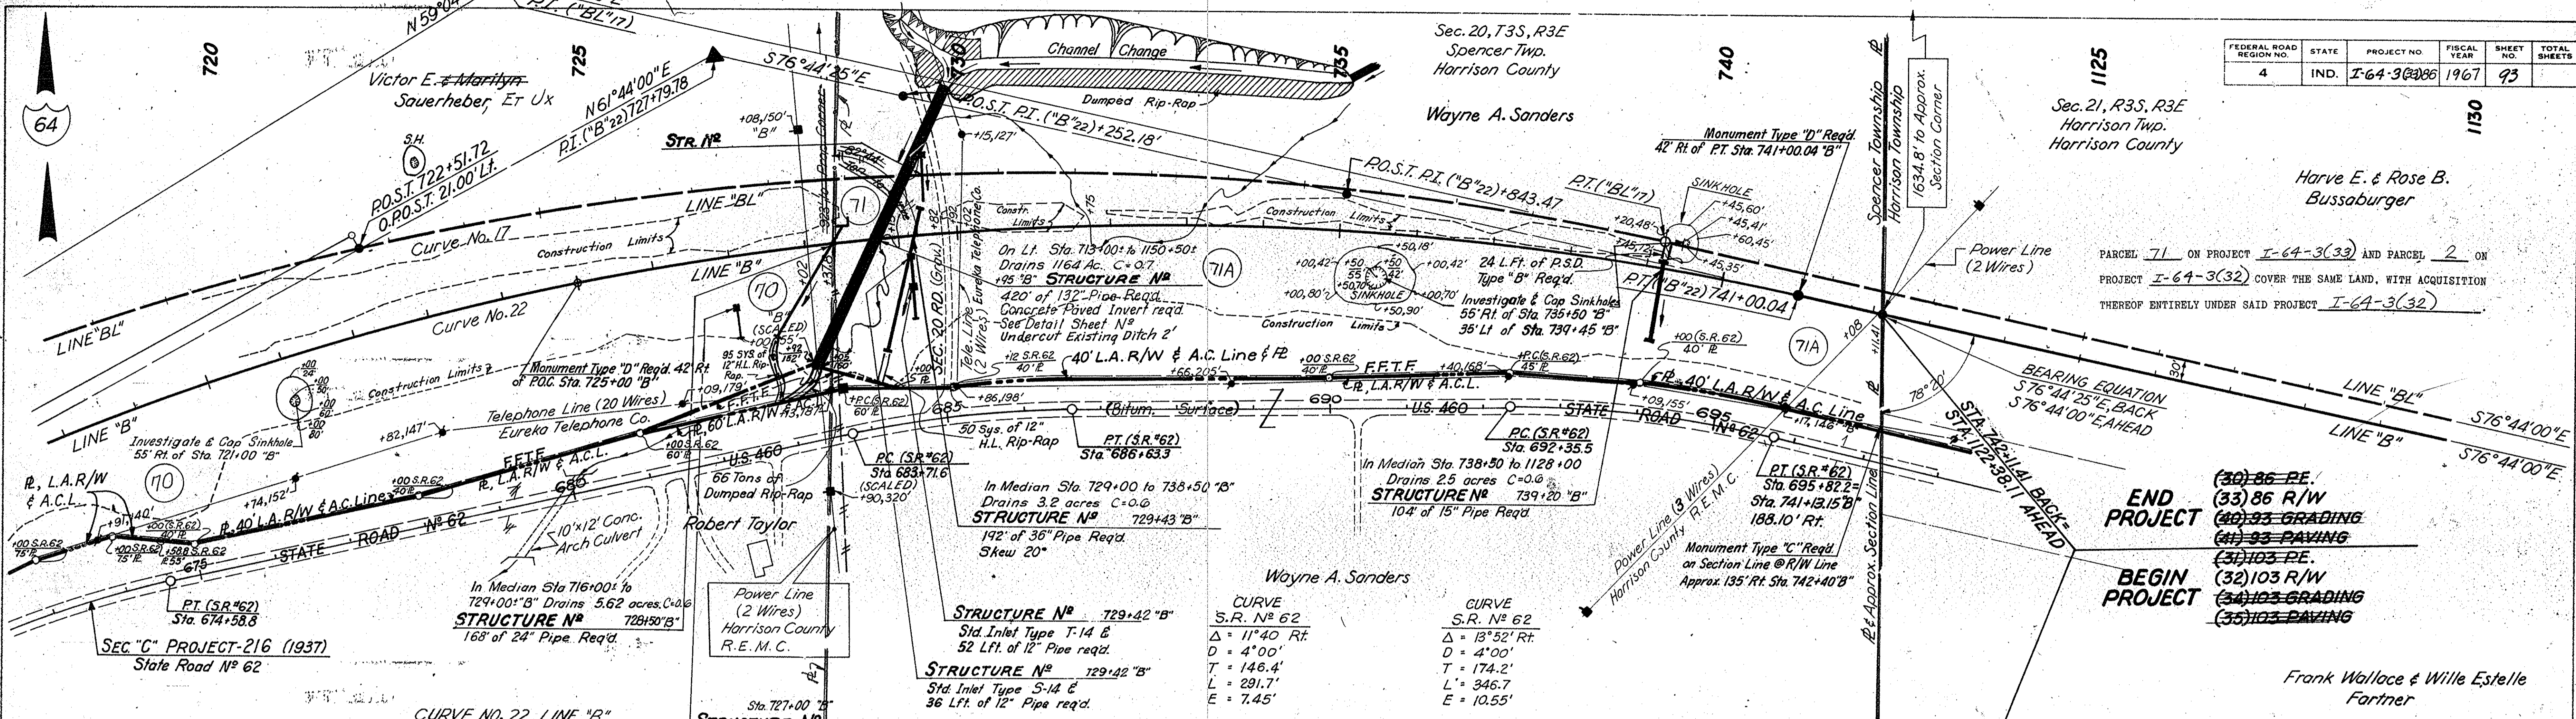


CURVE NO. 22, LINE "B"
 $\Delta = 41^{\circ}31'35''$ Rt.
 $D = 1^{\circ}30'00''$
 $R = 3819.72'$
 $T = 1448.17'$
 $L = 2763.43'$
 $E = 265.31'$
 Rate of Superelev. 0.042 / ft.

STATION	POINT	BEARING	ANGLE	ANGLE	ANGLE
722+51.72	P.O.S.T. 722+51.72 "B"	N. 59° 04' 00" E	N.R.A.	I.P.B.	I.P.B.
727+79.78	P.I. ("B" 22) 727+79.78	N. 61° 44' 00" E	N.R.A.	I.P.B.	I.P.B.
729+252.18	P.O.S.T. P.I. ("B" 22) +252.18'	S. 76° 44' 35" E	N.R.A.	I.P.F.	I.P.B.
741+843.47	P.O.S.T. P.I. ("B" 22) +843.47'	S. 76° 44' 35" E	N.R.A.	I.P.B.	I.P.B.
741+00.04	P.T. ("B" 22) 741+00.04	S. 76° 44' 00" E	N.R.A.	I.P.B.	I.P.B.

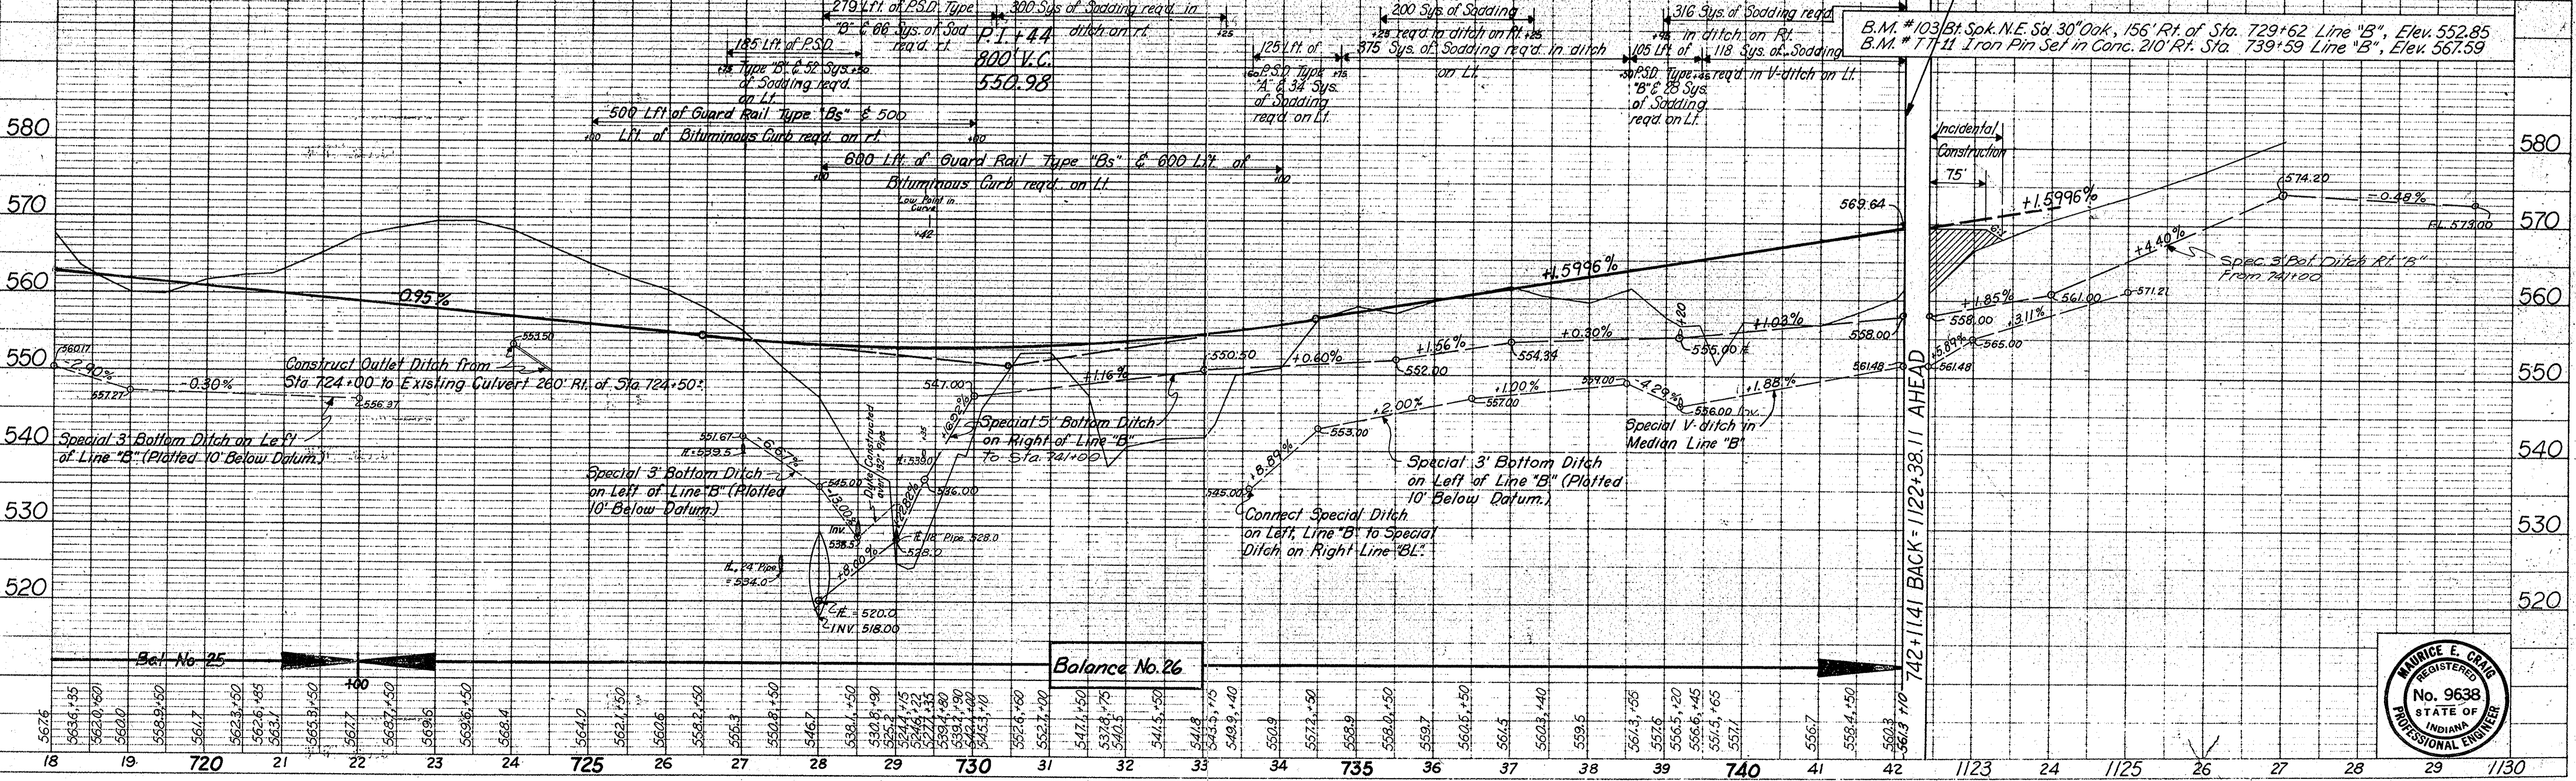


END PROJECT
 (30) 86 PE.
 (33) 86 R/W
 (40) 93 GRADING
 (41) 93 PAVING
BEGIN PROJECT
 (31) 103 PE.
 (32) 103 R/W
 (34) 103 GRADING
 (35) 103 PAVING

R/W on this sheet taken from State Road No. 62. Line except as noted. All R/W on this sheet to be as shown. Limited Access Provisions to apply where indicated. For R/W Left, See Following Sheet.

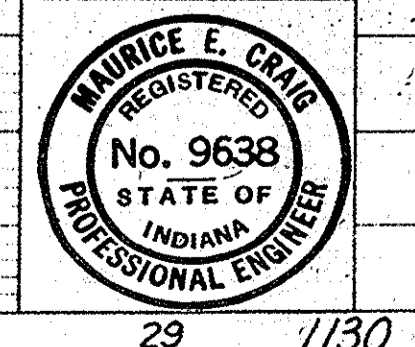

FEDERAL ROAD REGION NO.	STATE	PROJECT NO.	FISCAL YEAR	SHEET NO.	TOTAL SHEETS
4	IND.	I-64-3(33)86	1967	94	

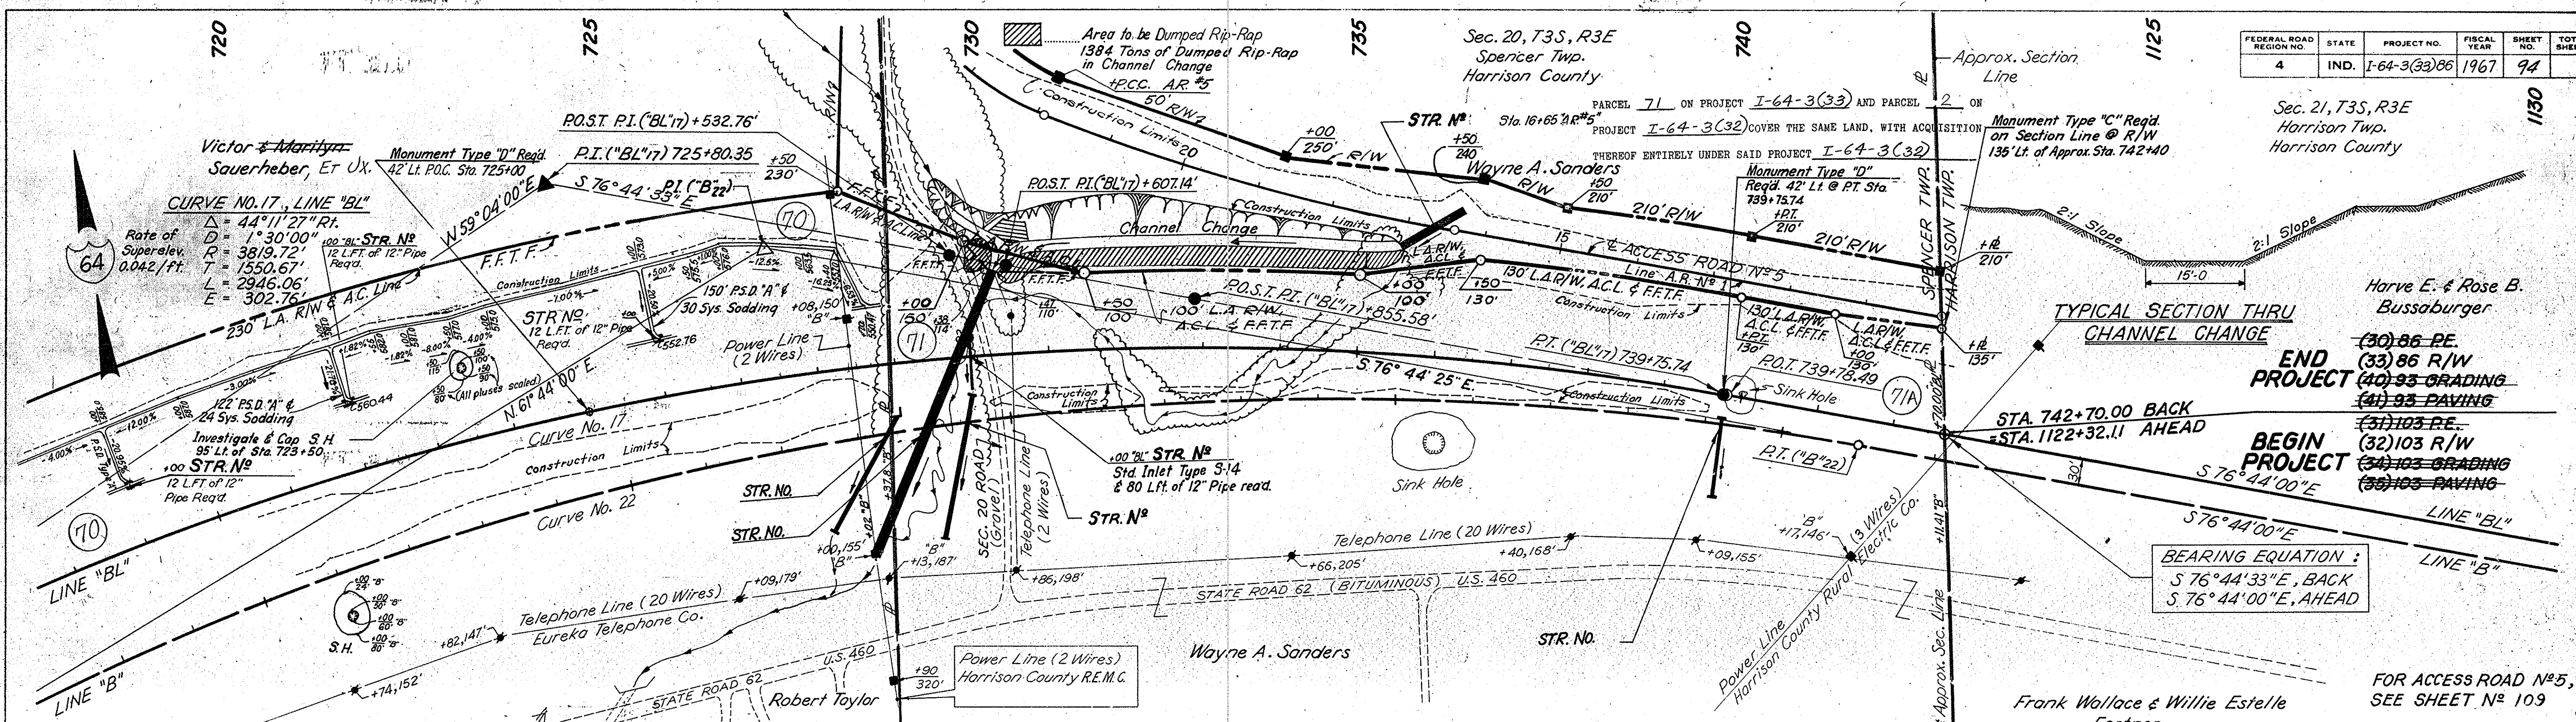

BEARING EQUATION:
 S 76° 44' 33" E, BACK
 S 76° 44' 00" E, AHEAD

FOR ACCESS ROAD No. 5,
 SEE SHEET No. 109



R/W on this sheet taken from
 Line "BL" except as noted.
 All R/W on this sheet to be as shown. Limited
 Access Provisions to apply where indicated.
 For R/W Limits Rt., See Preceding Sheet.

PLAN

DATE	11/11/61
BY	J.S.H.C.
CHECKED	J.S.H.C.
IN CHARGE	J.S.H.C.
SCALE	AS SHOWN
PROJECT NO.	I-64-3(33)86
SHEET NO.	94
TOTAL SHEETS	94


PROFILE

DATE	11/11/61
BY	J.S.H.C.
CHECKED	J.S.H.C.
IN CHARGE	J.S.H.C.
SCALE	AS SHOWN
PROJECT NO.	I-64-3(33)86
SHEET NO.	94
TOTAL SHEETS	94

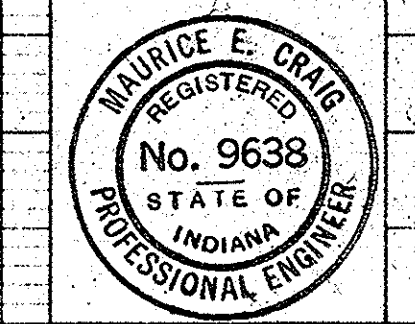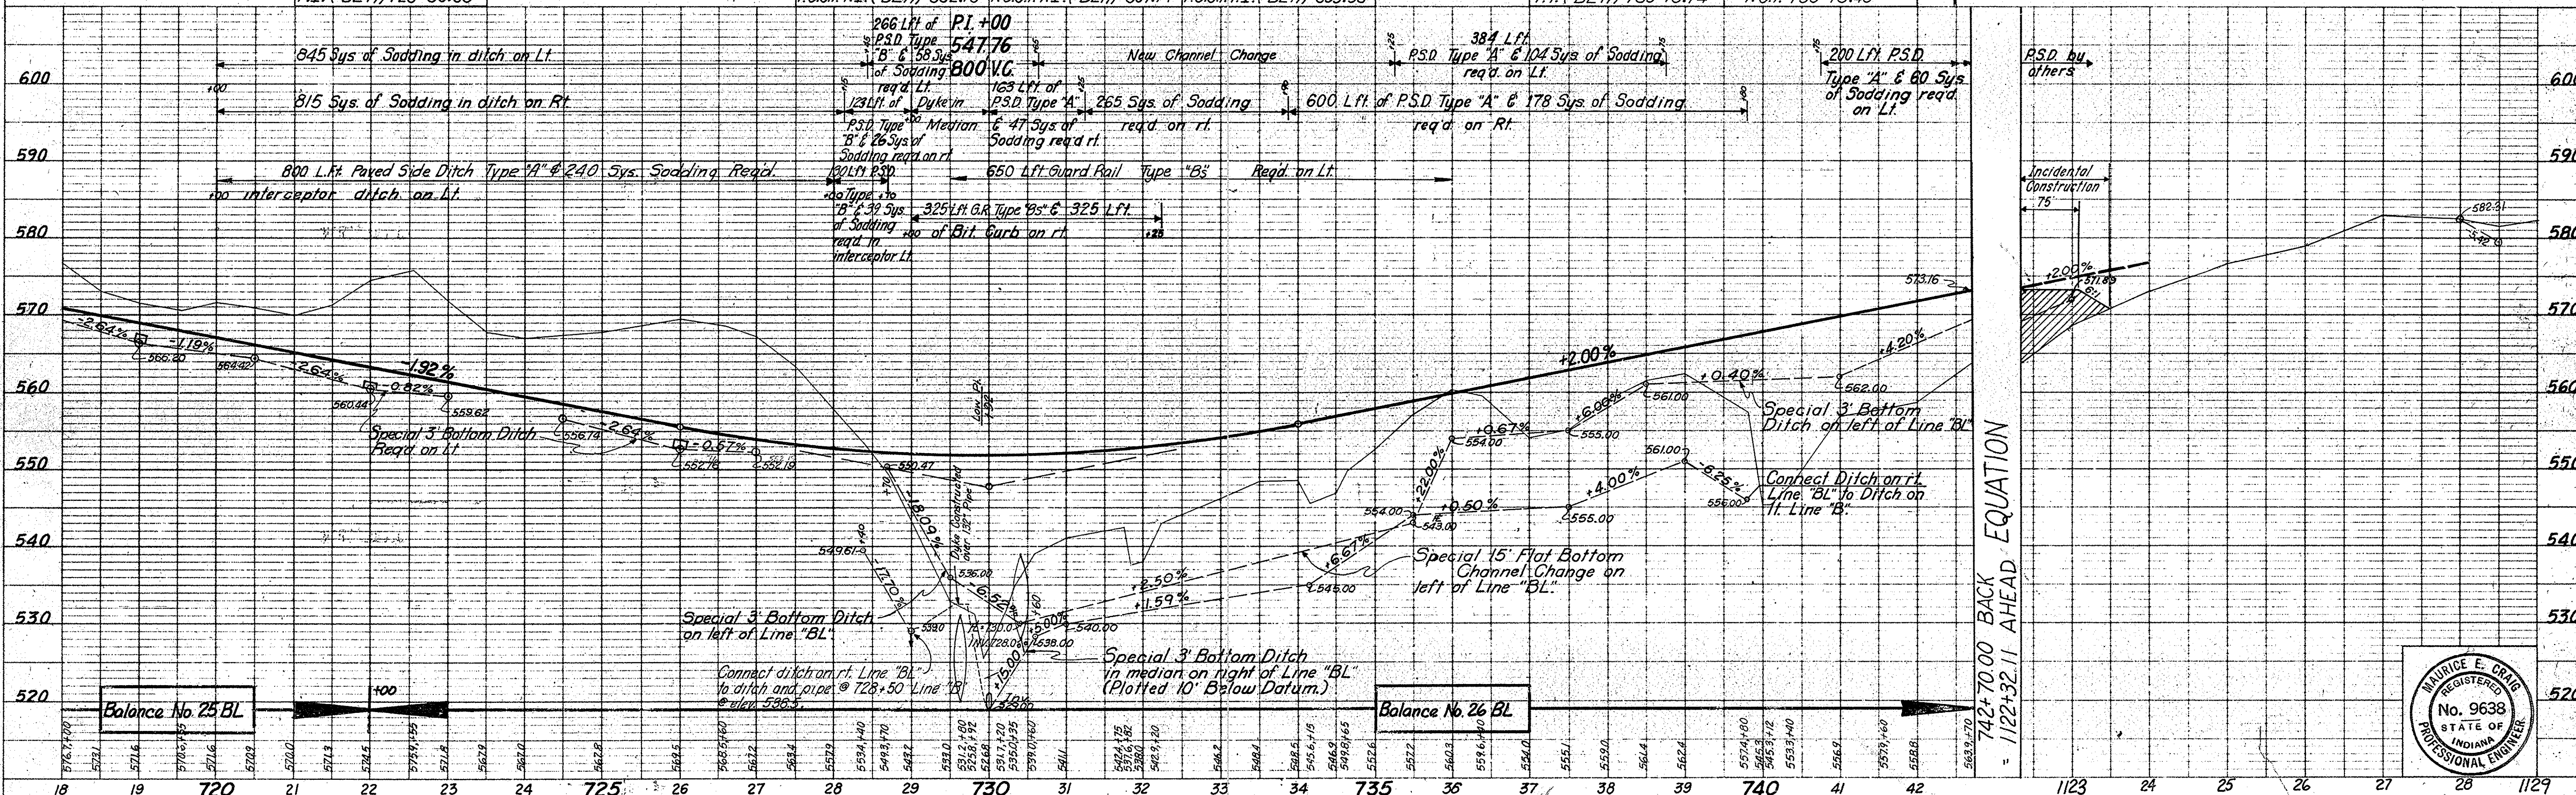

CURVE DATA

CURVE NO.	DELTA	PI	PC	PT	LC	LC	LC	LC	LC
1	30.00'	4+20.00'	0+18.00'	0+39.31'	0+20.00'	0+20.00'	0+20.00'	0+20.00'	0+20.00'
2	18.00'	4+20.00'	0+18.00'	0+39.31'	0+20.00'	0+20.00'	0+20.00'	0+20.00'	0+20.00'
3	18.00'	4+20.00'	0+18.00'	0+39.31'	0+20.00'	0+20.00'	0+20.00'	0+20.00'	0+20.00'
4	18.00'	4+20.00'	0+18.00'	0+39.31'	0+20.00'	0+20.00'	0+20.00'	0+20.00'	0+20.00'
5	18.00'	4+20.00'	0+18.00'	0+39.31'	0+20.00'	0+20.00'	0+20.00'	0+20.00'	0+20.00'

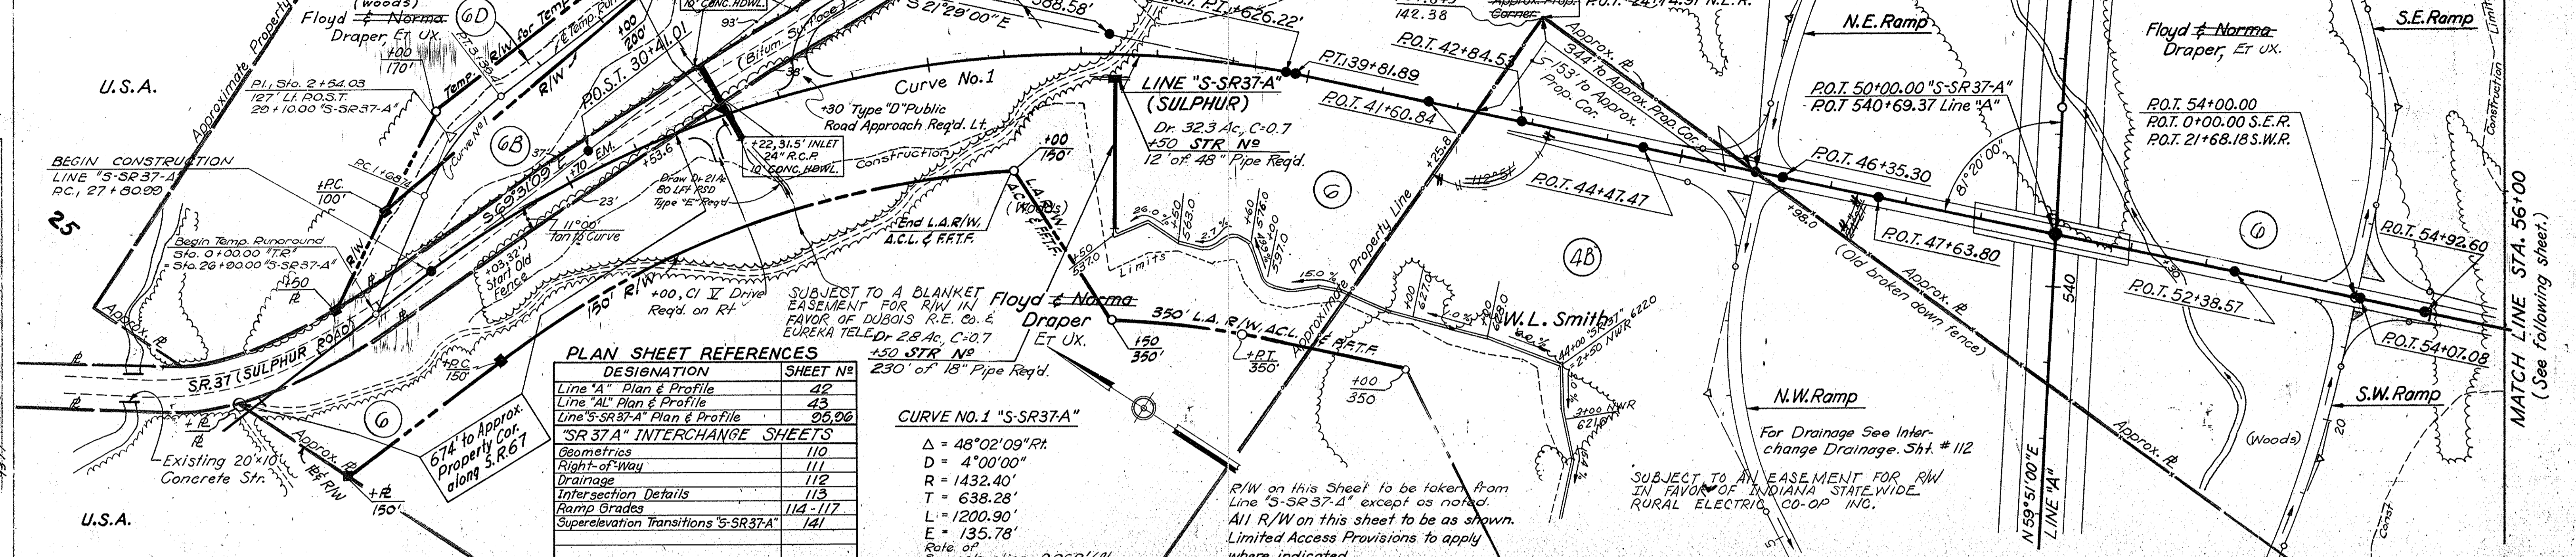

PLAN SHEET REFERENCES



DESIGNATION	SHEET NO.
Line "A" Plan & Profile	42
Line "AL" Plan & Profile	43
Line "S-SR37-A" Plan & Profile	95, 96

"S-SR37-A" INTERCHANGE SHEETS

Geometrics	110
Right-of-Way	111
Drainage	112
Intersection Details	113
Ramp Grades	114-117
Superelevation Transitions "S-SR37-A"	141

CURVE NO. 1 "S-SR37-A"

Δ = 48°02'09" RT
 D = 4°00'00"
 R = 1432.40'
 L = 638.28'
 T = 1200.90'
 E = 135.78'
 Rate of Superelevation = 0.002'/ft.

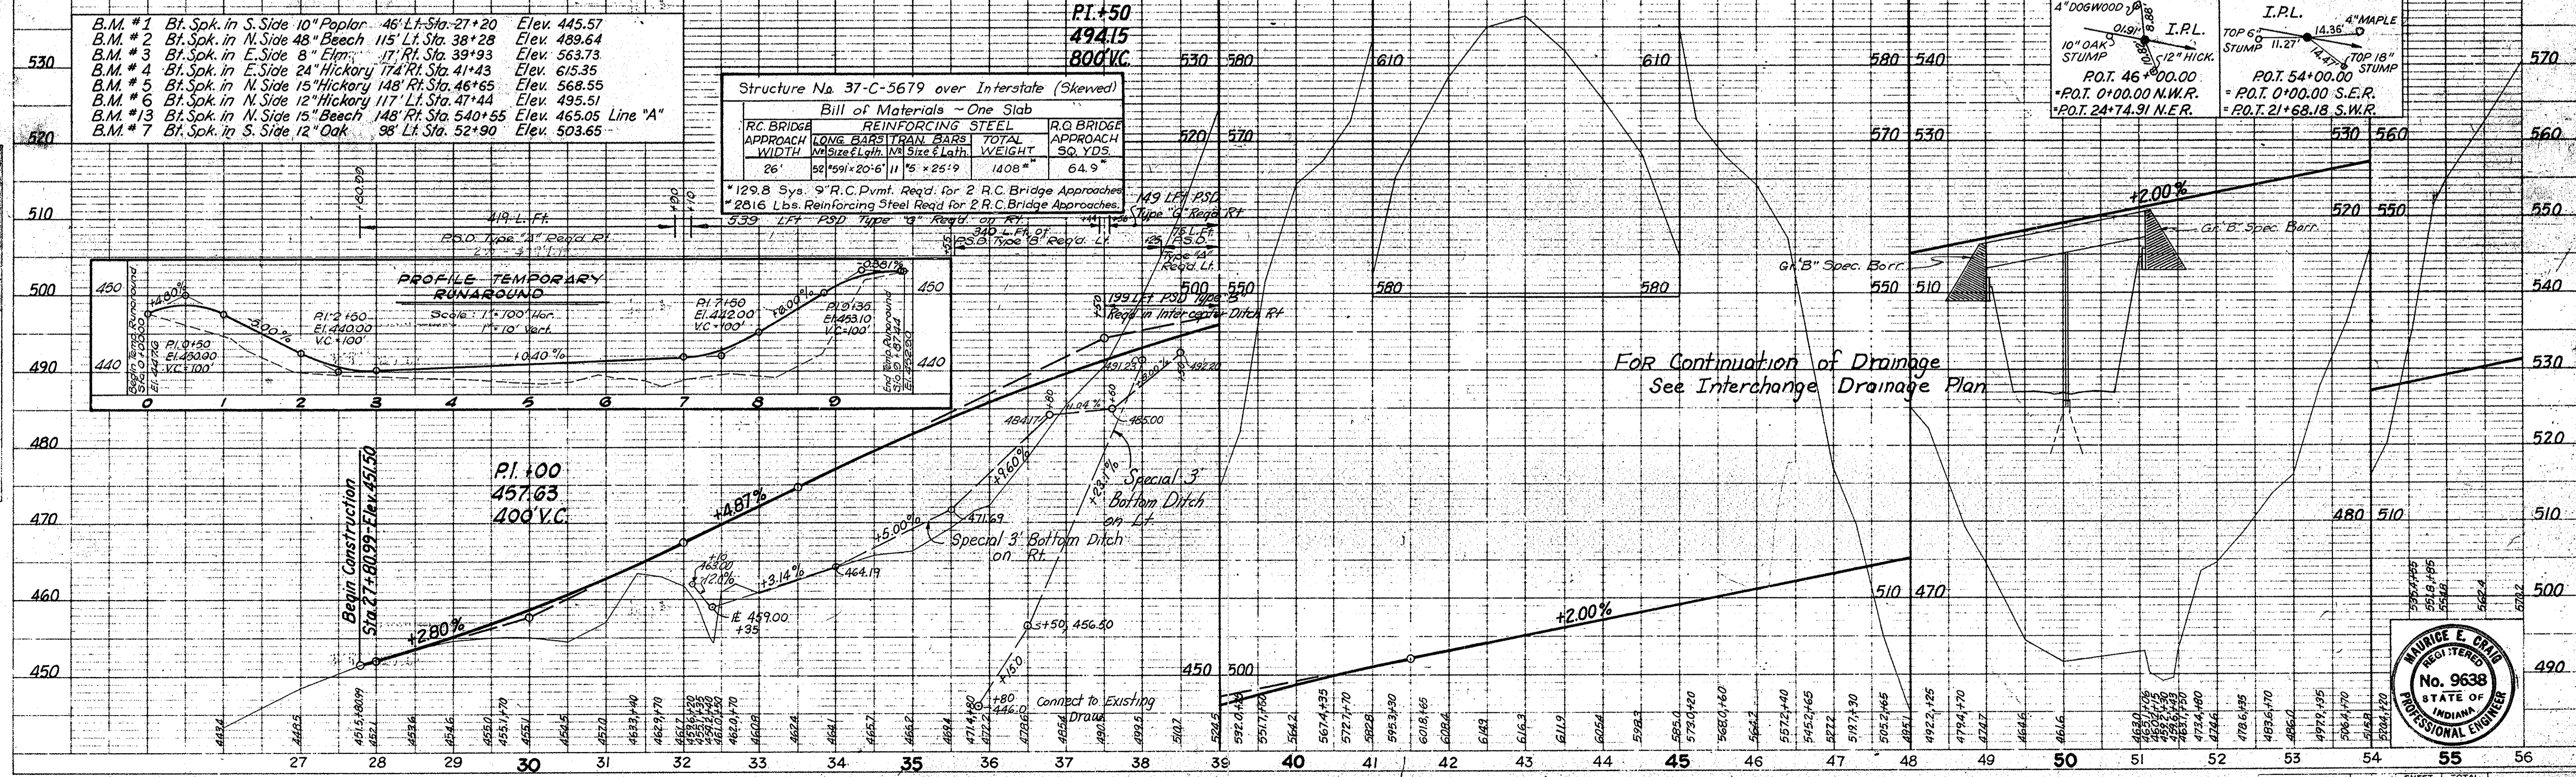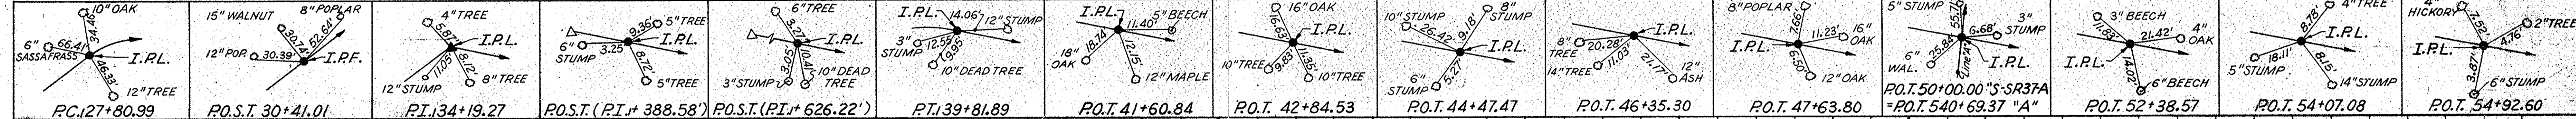

PROFILE SURVEYED: I.S.A.C. 1/66
 NOTE BOOK: 8, 9, 10, 11, 12
 NO. 9326-L, 13, 14, 15, 16, 17, 18, 19, 20, 21, 22, 23, 24, 25, 26, 27, 28, 29, 30, 31, 32, 33, 34, 35, 36, 37, 38, 39, 40, 41, 42, 43, 44, 45, 46, 47, 48, 49, 50, 51, 52, 53, 54, 55, 56




PLAN

DATE: 11-26-66
 BY: J.S.C.
 CHECKED: M.F.C.
 NO. OF WAY CHECKED: 2
 NO. OF STRUCTURE NOTATIONS CHECKED: 2

PROFILE

DATE: 11-26-66
 BY: J.S.C.
 CHECKED: M.F.C.
 NO. OF WAY CHECKED: 2
 NO. OF STRUCTURE NOTATIONS CHECKED: 2

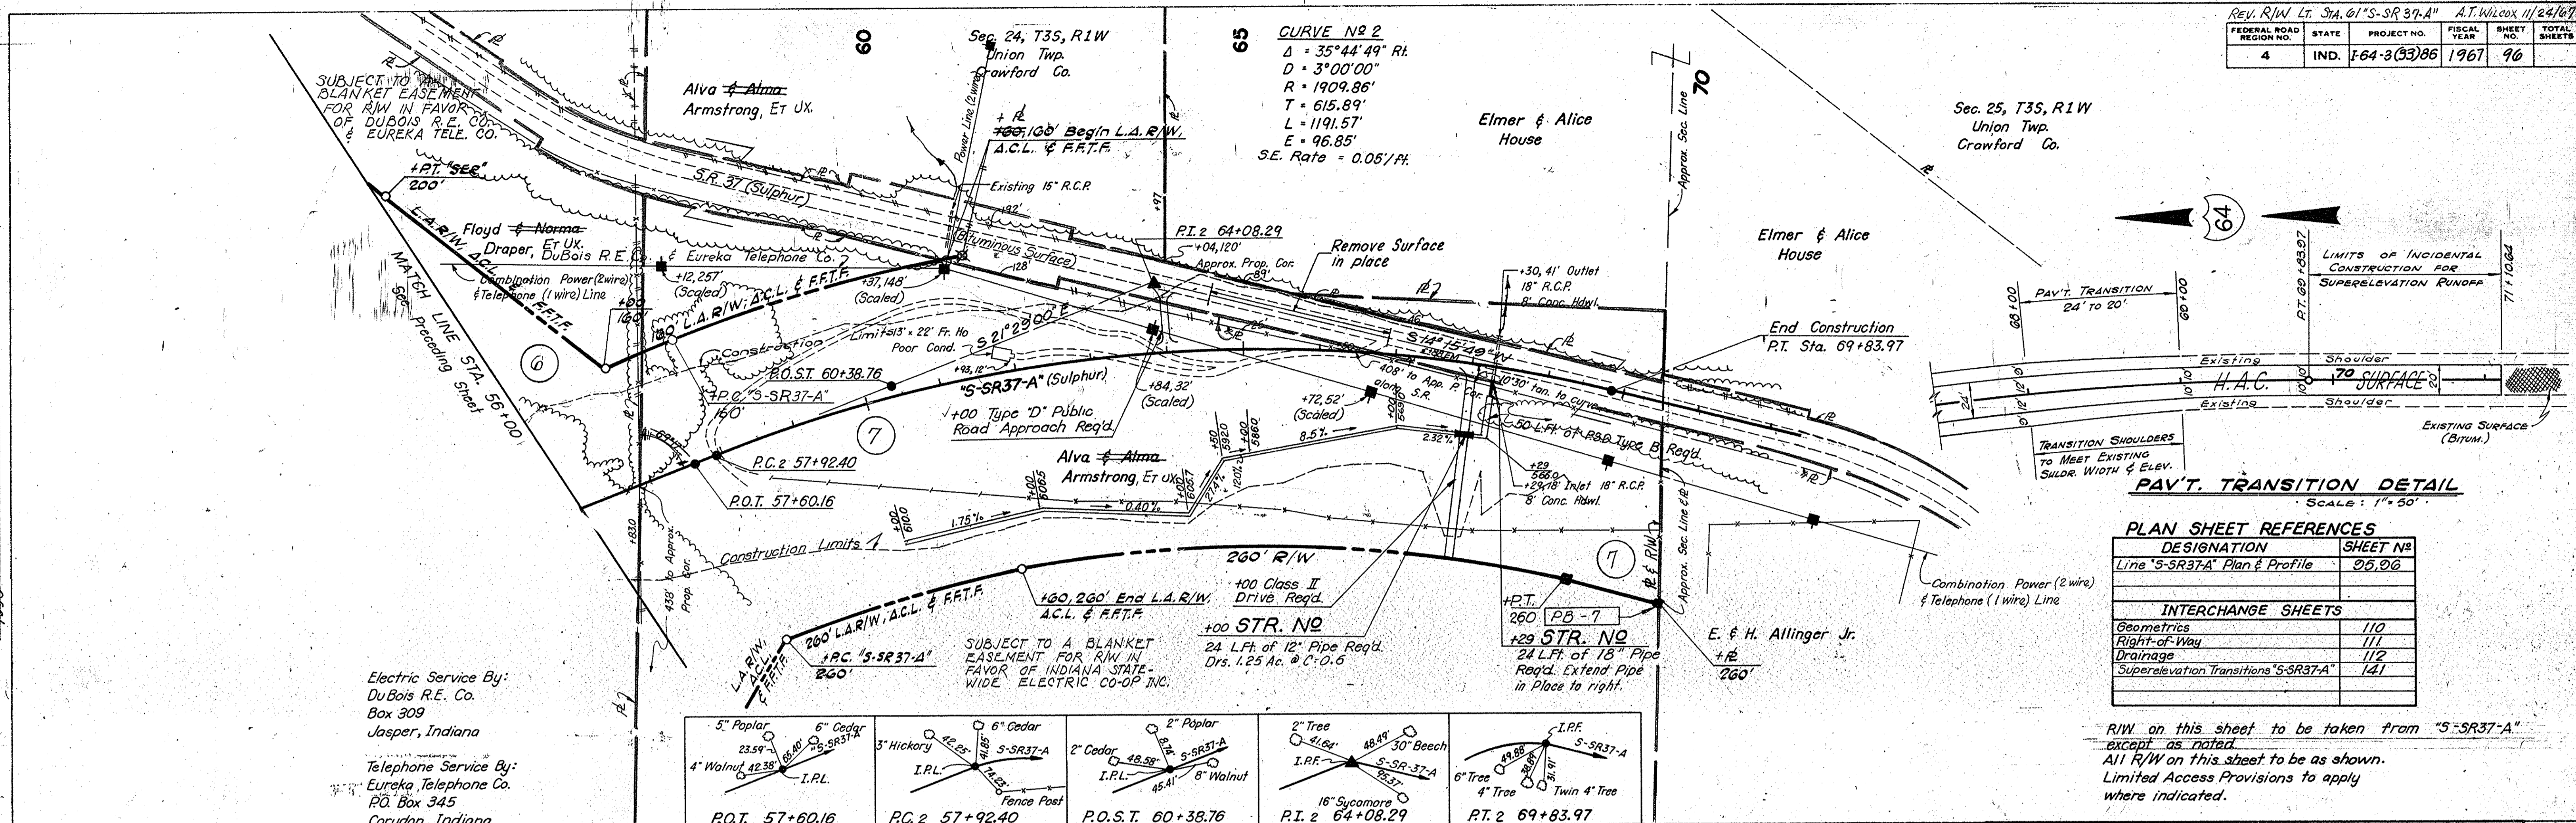



PAV'T. TRANSITION DETAIL
SCALE: 1" = 50'

PLAN SHEET REFERENCES


DESIGNATION	SHEET NO.
Line 'S-SR37-A' Plan & Profile	95, 96

INTERCHANGE SHEETS	
Geometrics	110
Right-of-Way	111
Drainage	112
Superelevation Transitions 'S-SR37-A'	141

R/W on this sheet to be taken from "S-SR37-A" except as noted.
 All R/W on this sheet to be as shown.
 Limited Access Provisions to apply where indicated.

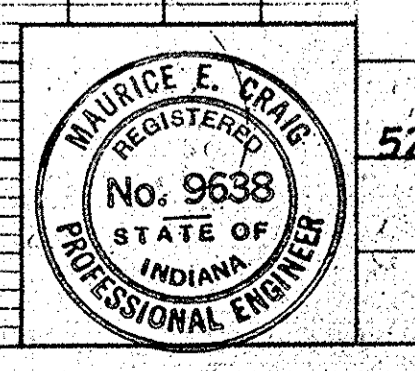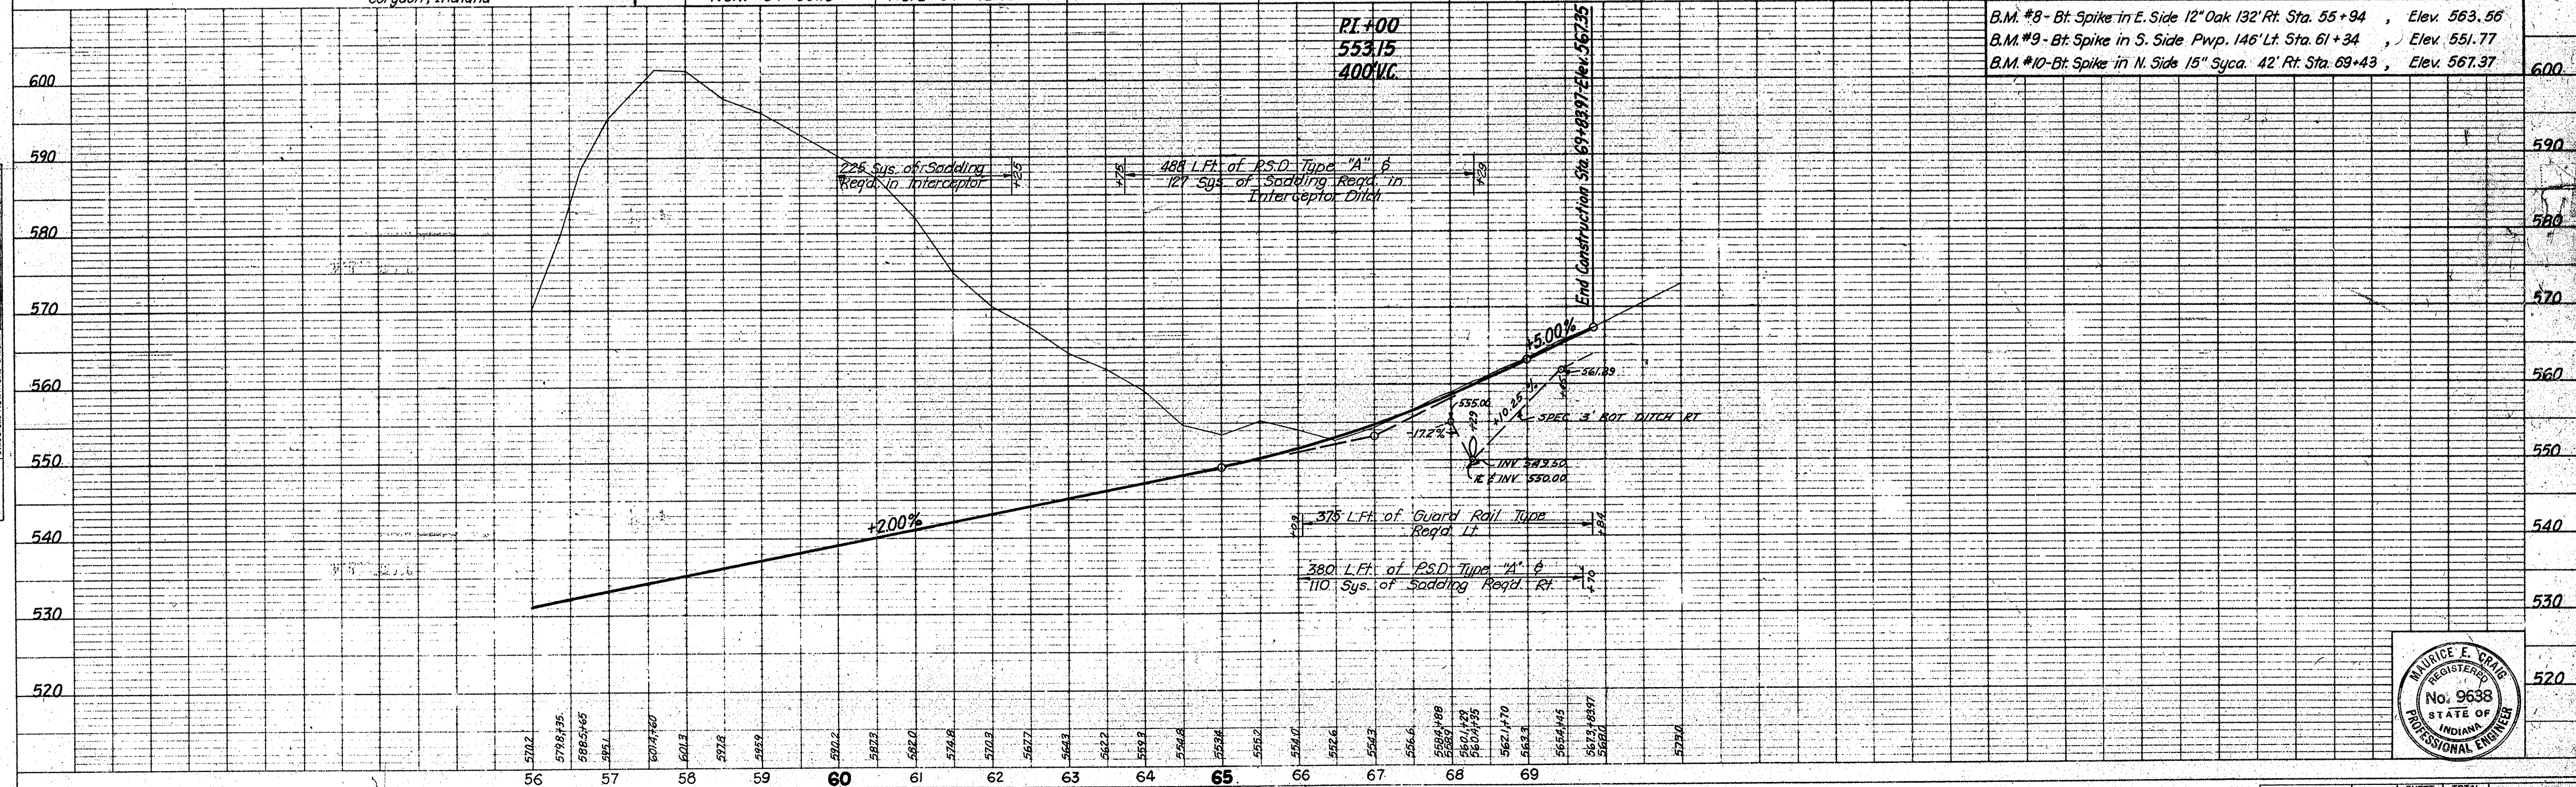

DATE: 1-66
 I.S.H.C.
 J.A.W.
 P.D.G.
 M.E.C.

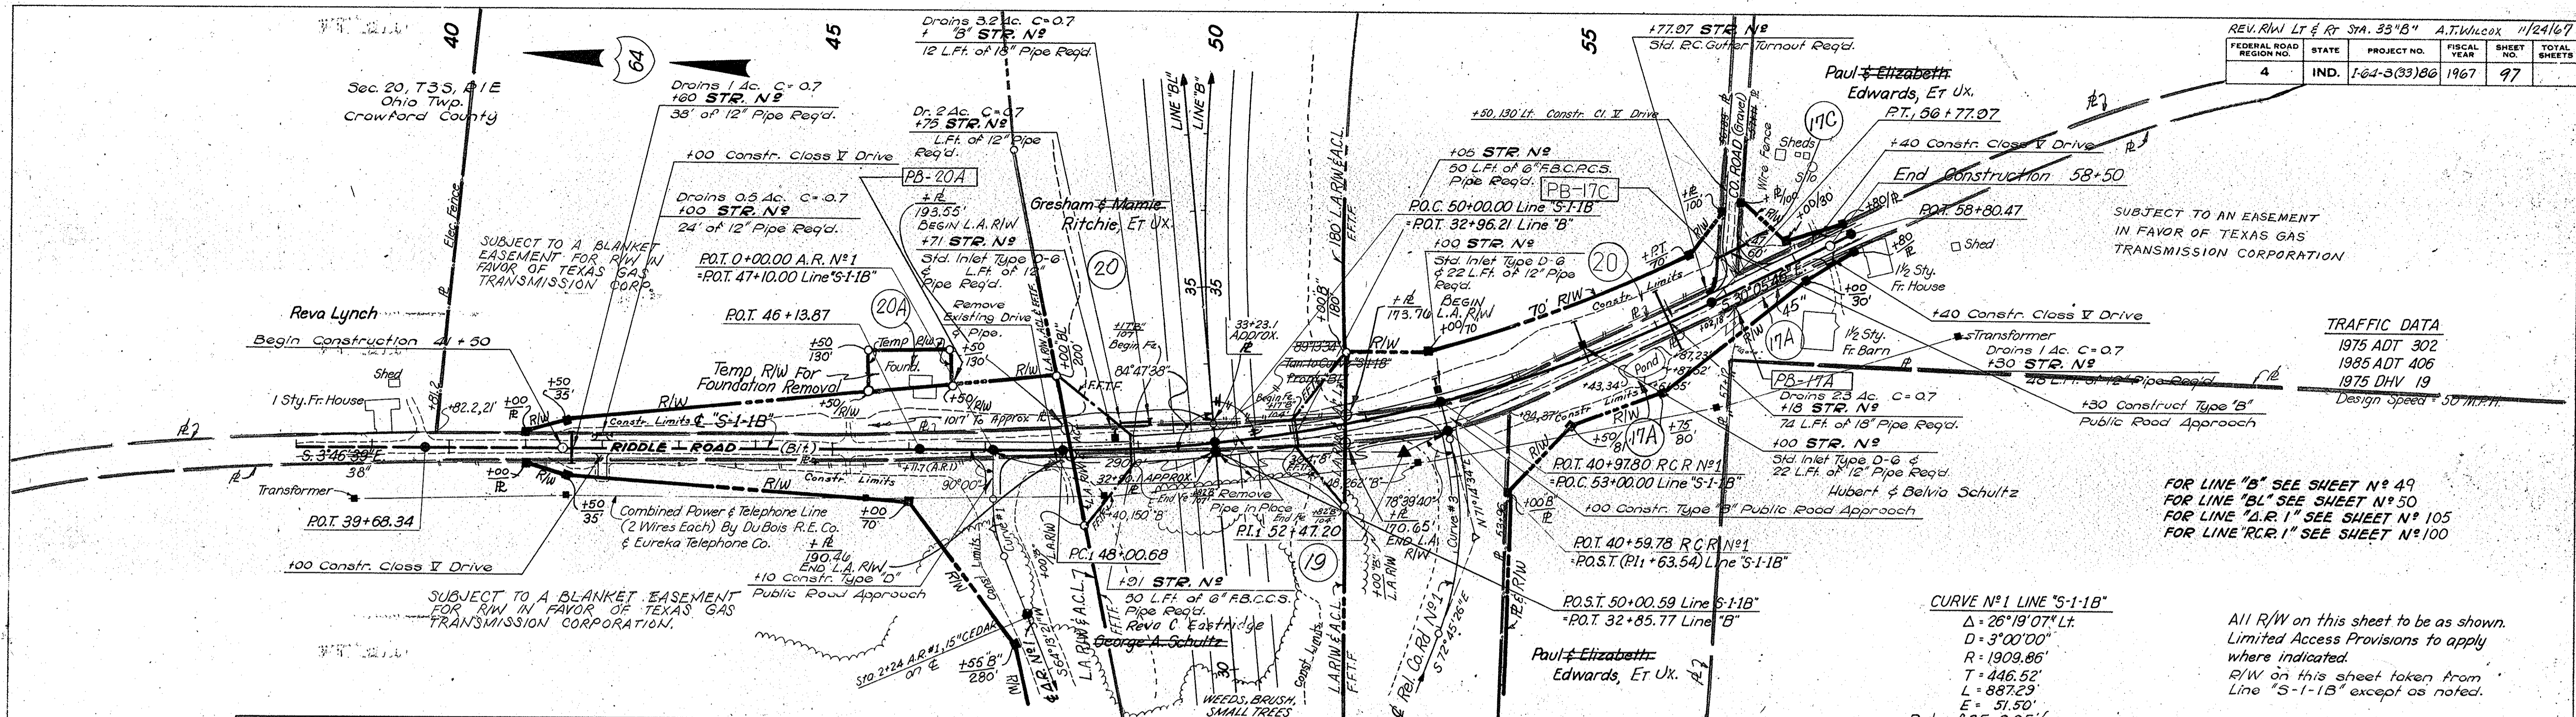

SUBJECT TO AN EASEMENT IN FAVOR OF TEXAS GAS TRANSMISSION CORPORATION

SUBJECT TO A BLANKET EASEMENT FOR RW IN FAVOR OF TEXAS GAS TRANSMISSION CORP.


SUBJECT TO A BLANKET EASEMENT FOR RW IN FAVOR OF TEXAS GAS TRANSMISSION CORPORATION.

TRAFFIC DATA
 1975 ADT 302
 1985 ADT 406
 1975 DHV 19
 Design Speed = 50 M.P.H.

FOR LINE "B" SEE SHEET N° 49
 FOR LINE "BL" SEE SHEET N° 50
 FOR LINE "A.R. 1" SEE SHEET N° 105
 FOR LINE "RCR. 1" SEE SHEET N° 100

CURVE N° 1 LINE "S-1-1B"
 $\Delta = 26^{\circ}19'07''$ Lt.
 $D = 3^{\circ}00'00''$
 $R = 1909.86'$
 $T = 446.52'$
 $L = 887.23'$
 $E = 51.50'$
 Rate of SE = 0.05/ft

All R/W on this sheet to be as shown. Limited Access Provisions to apply where indicated. R/W on this sheet taken from Line "S-1-1B" except as noted.

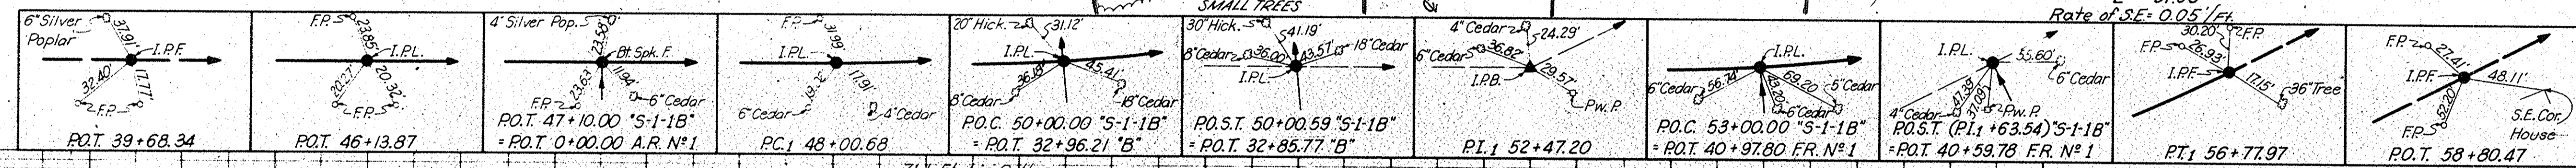


- B.M. #1 "S-1-1B" - Bt. Spike in Triple 12" Walnut, 19' Lt. Sta. 37+29 - Elev. 735.37
- B.M. #2 "S-1-1B" - Bt. Spike in 4" Silver Poplar, 24' Lt. Sta. 47+10 - Elev. 737.53
- B.M. #6 "B" - Bt. Spike in Twin 24" Oak, 170' Rt. Sta. 32+80 "B" - Elev. 720.64
- B.M. #3 "S-1-1B" - Bt. Spike in Twin 18" Silver Poplar, 54' Lt. Sta. 59+22 - Elev. 709.68

Structure N° I-64-80-5631 over Interstate (Square)

Bill of Materials - One Slab			
RC BRIDGE APPROACH WIDTH	REINFORCING STEEL LONG BARS	REINFORCING STEEL TRANS. BARS	RC BRIDGE APPROACH SQ. YDS.
22'	44,291 x 20# 11	#5 x 21'-0"	50.1 *

* 100.2 Sys. of 8" RC Pav't. Req'd. for 2 RC Br. Approaches.
 2374 Lbs. of Reinforcing Steel Req'd. for 2 RC Br. Approaches.

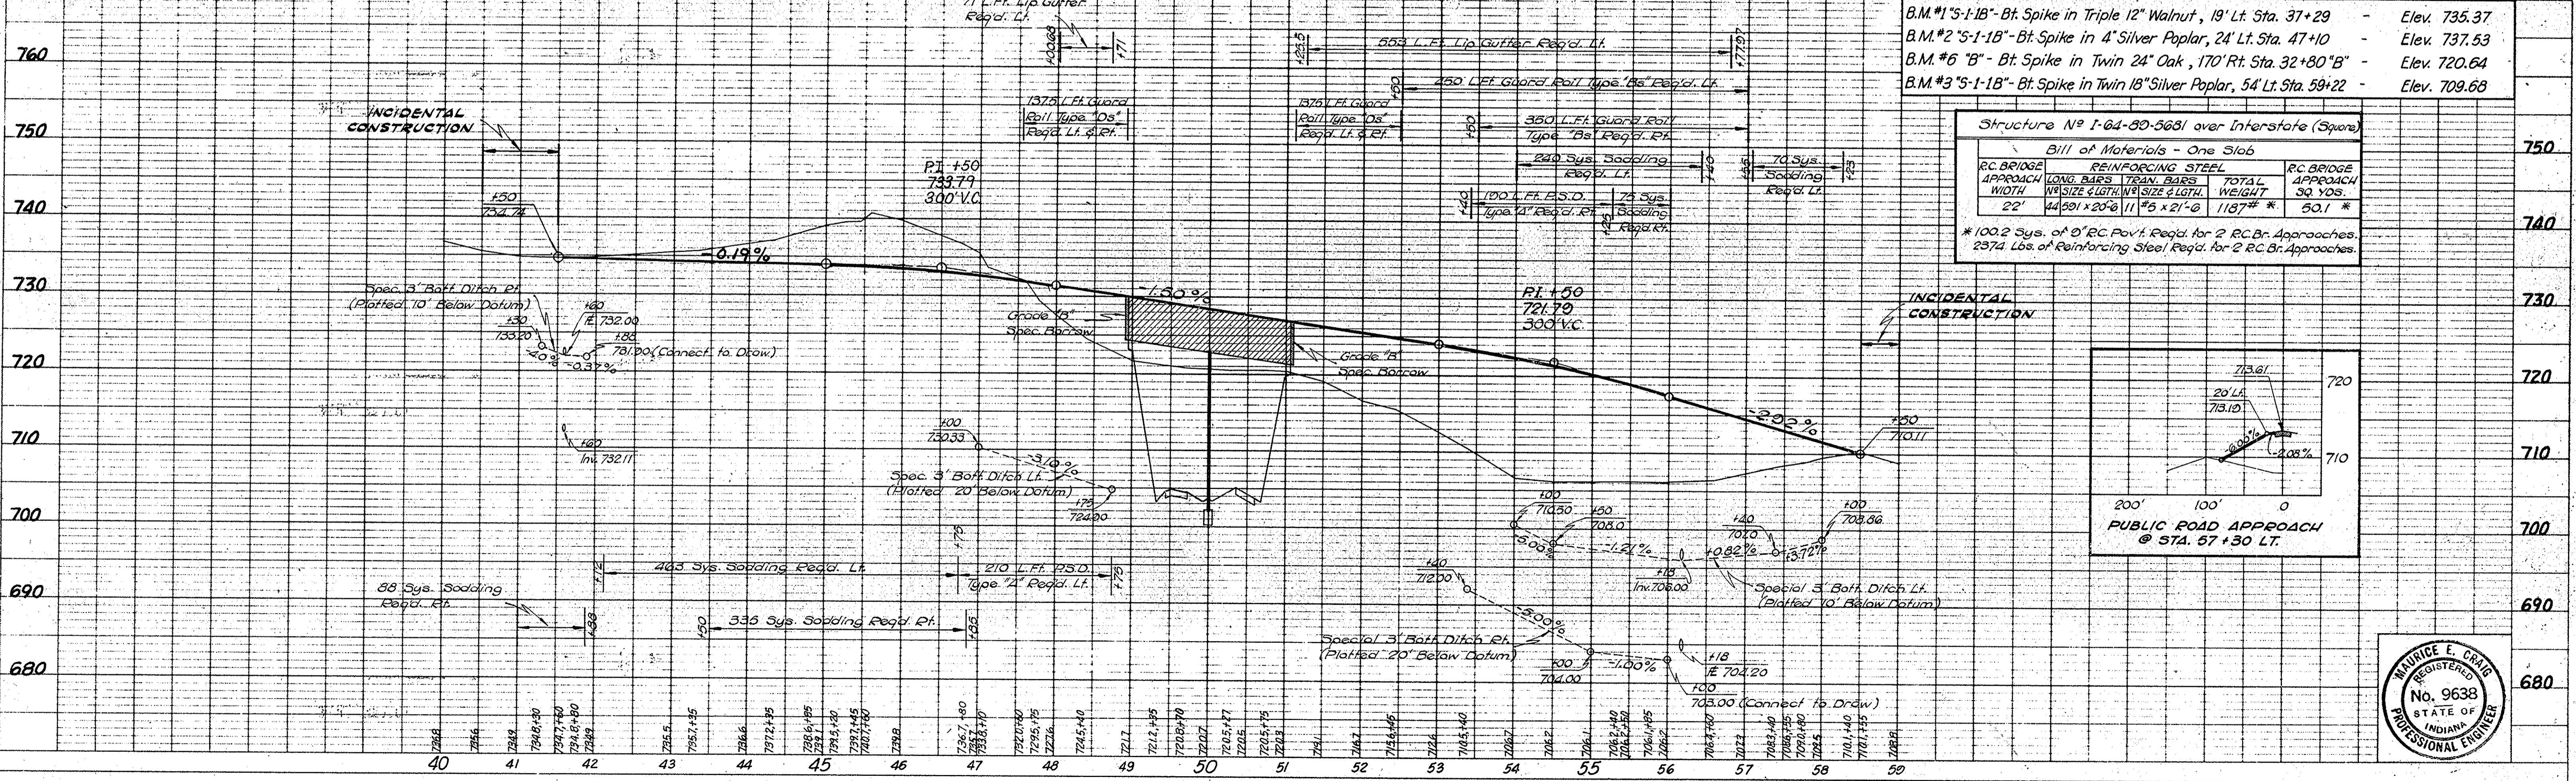


DATE: 1-66
 I.S.H.C.
 J.A.W.
 P.D.G.
 M.E.C.



LINE "S-SR66-B"

FEDERAL ROAD DISTRICT NO.	STATE	PROJECT NO.	FISCAL YEAR	SHEET NO.	TOTAL SHEETS
4	IND.	I-64-3 (33) 86	1967	98	



Sec. 24, T3S, R1E 65
Jeanings Twp.
Crawford County
Ray Beals

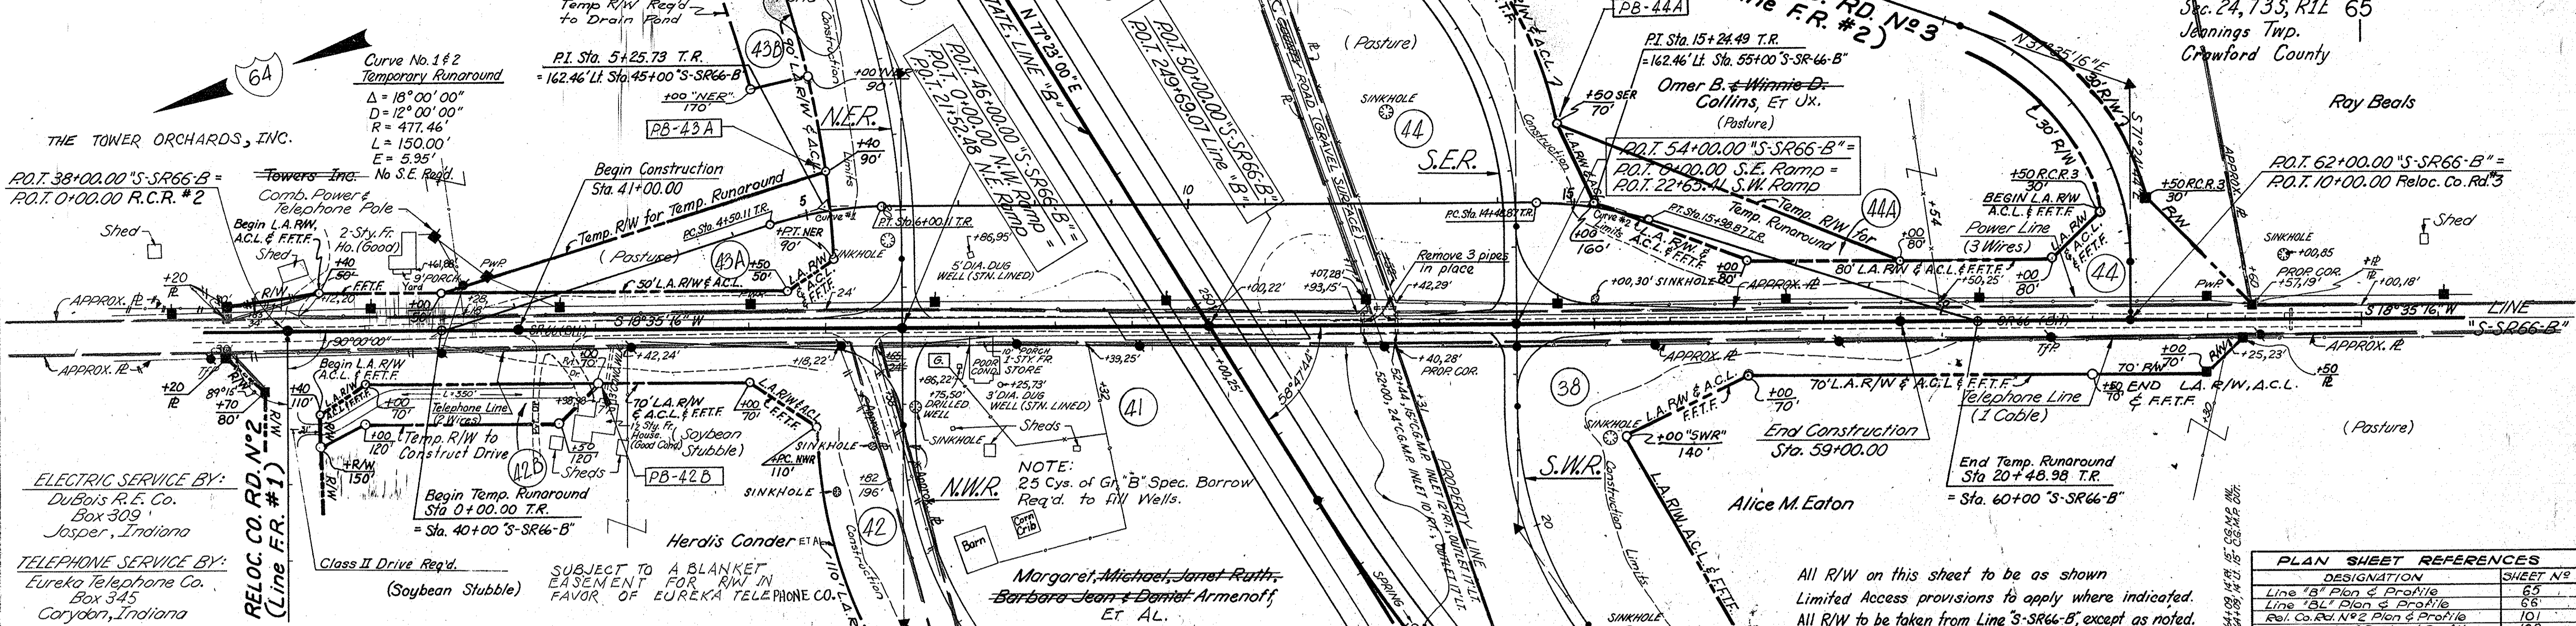

PLAN SHEET REFERENCES
 DESIGNATION SHEET NO.
 Line "B" Plan & Profile 65
 Line "AL" Plan & Profile 66
 Rel. Co. Rd. No. 2 Plan & Profile 101
 Rel. Co. Rd. No. 3 Plan & Profile 102

DESIGNATION	SHEET NO.
Line "B" Plan & Profile	65
Line "AL" Plan & Profile	66
Rel. Co. Rd. No. 2 Plan & Profile	101
Rel. Co. Rd. No. 3 Plan & Profile	102


All R/W on this sheet to be as shown
Limited Access provisions to apply where indicated.
All R/W to be taken from Line "S-SR66-B", except as noted.

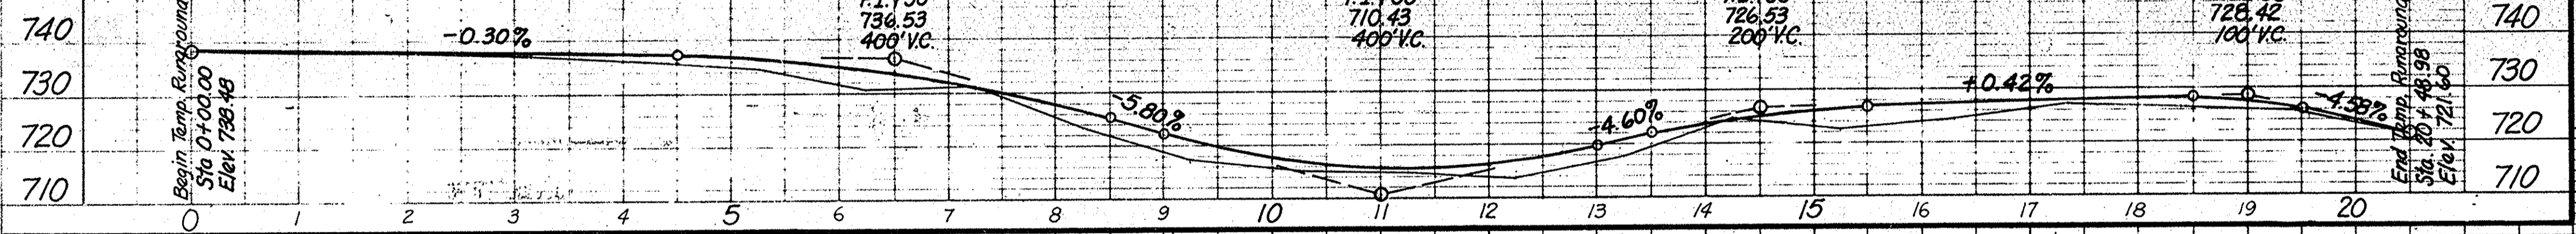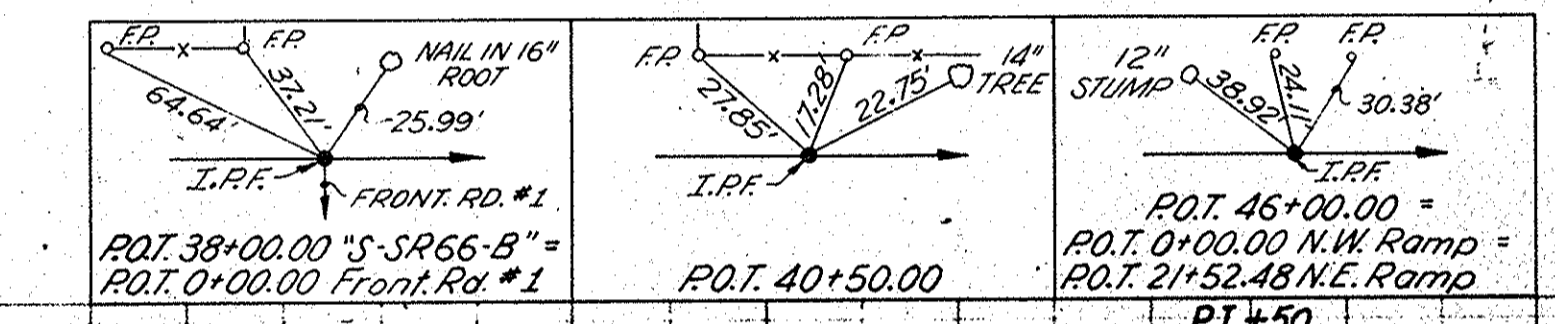

B.M. #1 Bt. Sok. in E. Side of TYP 33' Rt. of Station 36+94 Elev. 738.28
 U.S.G.S. Ref. Mark Tower 1946 Standard Disk in Conc. Post 24' Lt. Sta. 44+47, El. 735.86
 B.M. #3 Bt. Sok. in W. Side 15" Persimmon 170' Rt. Sta. 247+70 B Elev. 708.03
 B.M. #7 20' Top head of Bolt in Conc. Post 22' Lt. Sta. 57+00 Elev. 726.86
 B.M. #2 Bt. Sok. in W. Side of P.W.P. 27' Left of Station 62+91 Elev. 716.57

Structure No. 66-N-5684 over Interstate (Skewed)			
Bill of Materials - One Slab			
R.C. BRIDGE	REINFORCING STEEL	R.C. BRIDGE	
APPROACH	LONG BARS	TRANS BARS	TOTAL
WIDTH	NO. SIZE	NO. SIZE	WEIGHT
SCYDS.			
26'	52 5/8" x 20'-6"	11 5/8" x 25'-8"	1441 lbs
			82.0 "

*164.0 Sys. of R.C. Pymt. Req'd. for 2 R.C. Bridge Approaches
 *2882 lbs. of Reinforcing Steel Req'd. for 2 R.C. Bridge Approaches

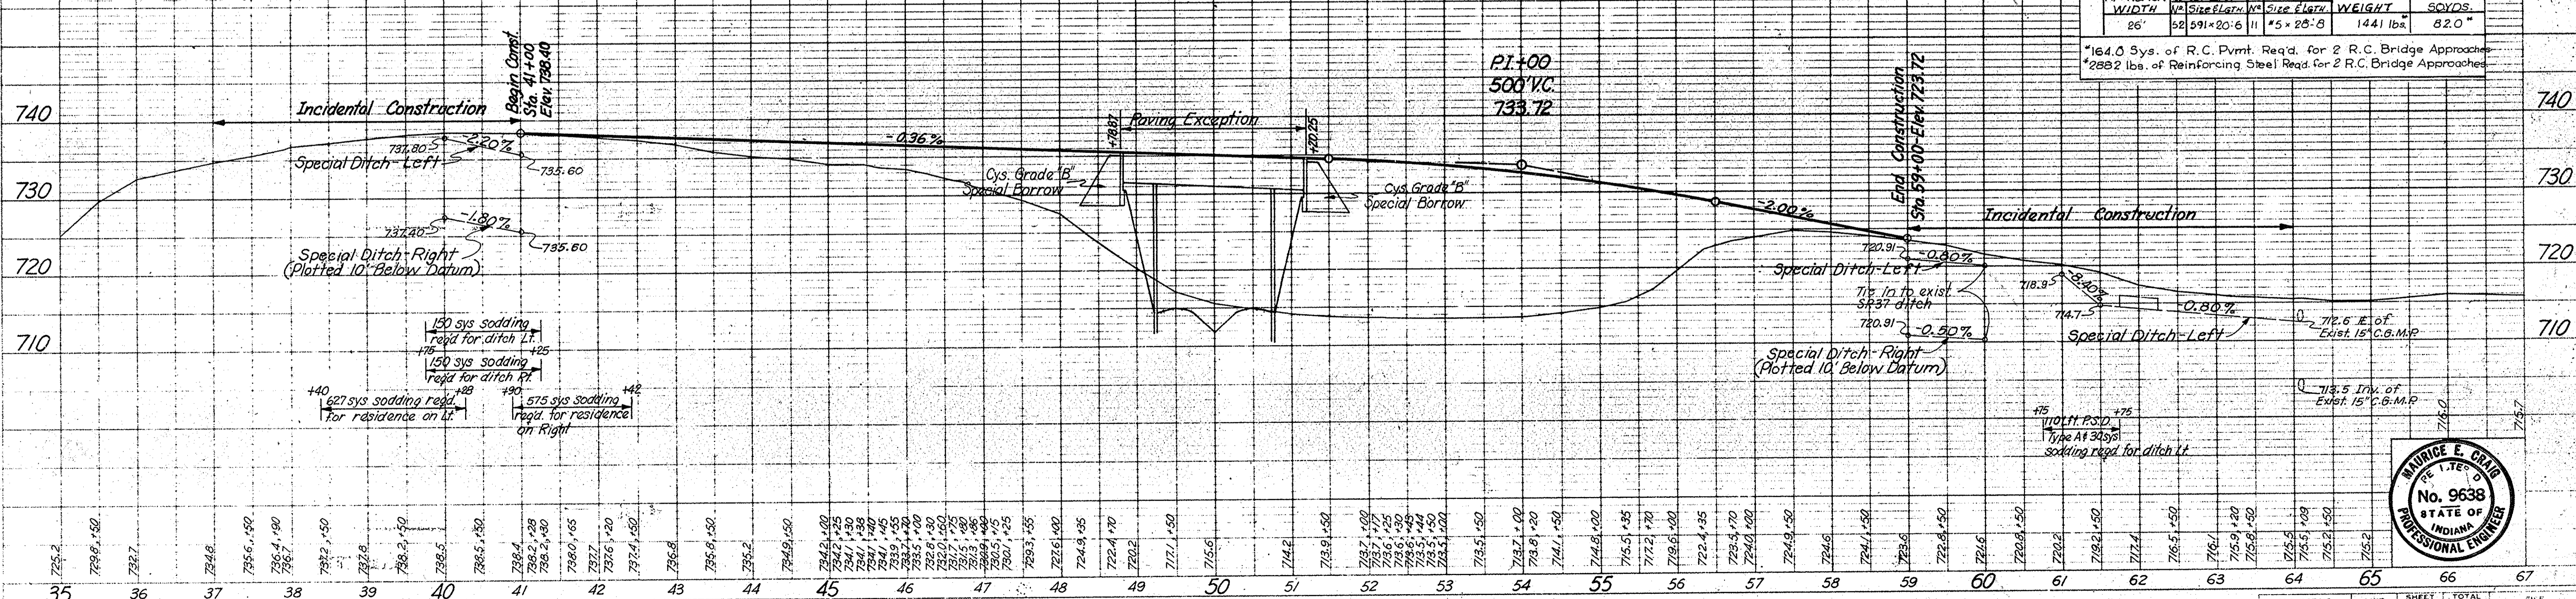

PROFILE SHEET REFERENCES
 DESIGNATION SHEET NO.
 Line "B" Plan & Profile 65
 Line "AL" Plan & Profile 66
 Rel. Co. Rd. No. 2 Plan & Profile 101
 Rel. Co. Rd. No. 3 Plan & Profile 102




FEDERAL ROAD REGION NO.	STATE	PROJECT NO.	FISCAL YEAR	SHEET NO.	TOTAL SHEETS
4	IND.	I-64-3(3)86	1967	99	

REV. 8/12/68 R/W Sta. 468+50 "B.U."


TRAFFIC DATA		
1975	A.D.T.	93
1985	A.D.T.	125
1975	D.H.V.	8

CURVE DATA	
PUBLIC ROAD APPROACH	
CURVE #1	CURVE #2
$\Delta = 120^{\circ}00'$	$\Delta = 40^{\circ}10'$
$D = 114^{\circ}35'28"$	$D = 76^{\circ}23'38"$
$R = 50.00'$	$R = 75.00'$
$T = 86.56'$	$T = 27.42'$
$L = 104.72'$	$L = 52.58'$
$E = 50.00'$	$E = 4.85'$
$PC = Sta. 0+35.0$	$PC = Sta. 1+87.78$
$PI = Sta. 1+21.56$	$PI = Sta. 2+15.20$
$PT = Sta. 1+39.72$	$PT = Sta. 2+40.36$


DATE: 11-66
BY: P.A.G.
CHECKED: M.E.C.
NO. 64-3(3)86-99

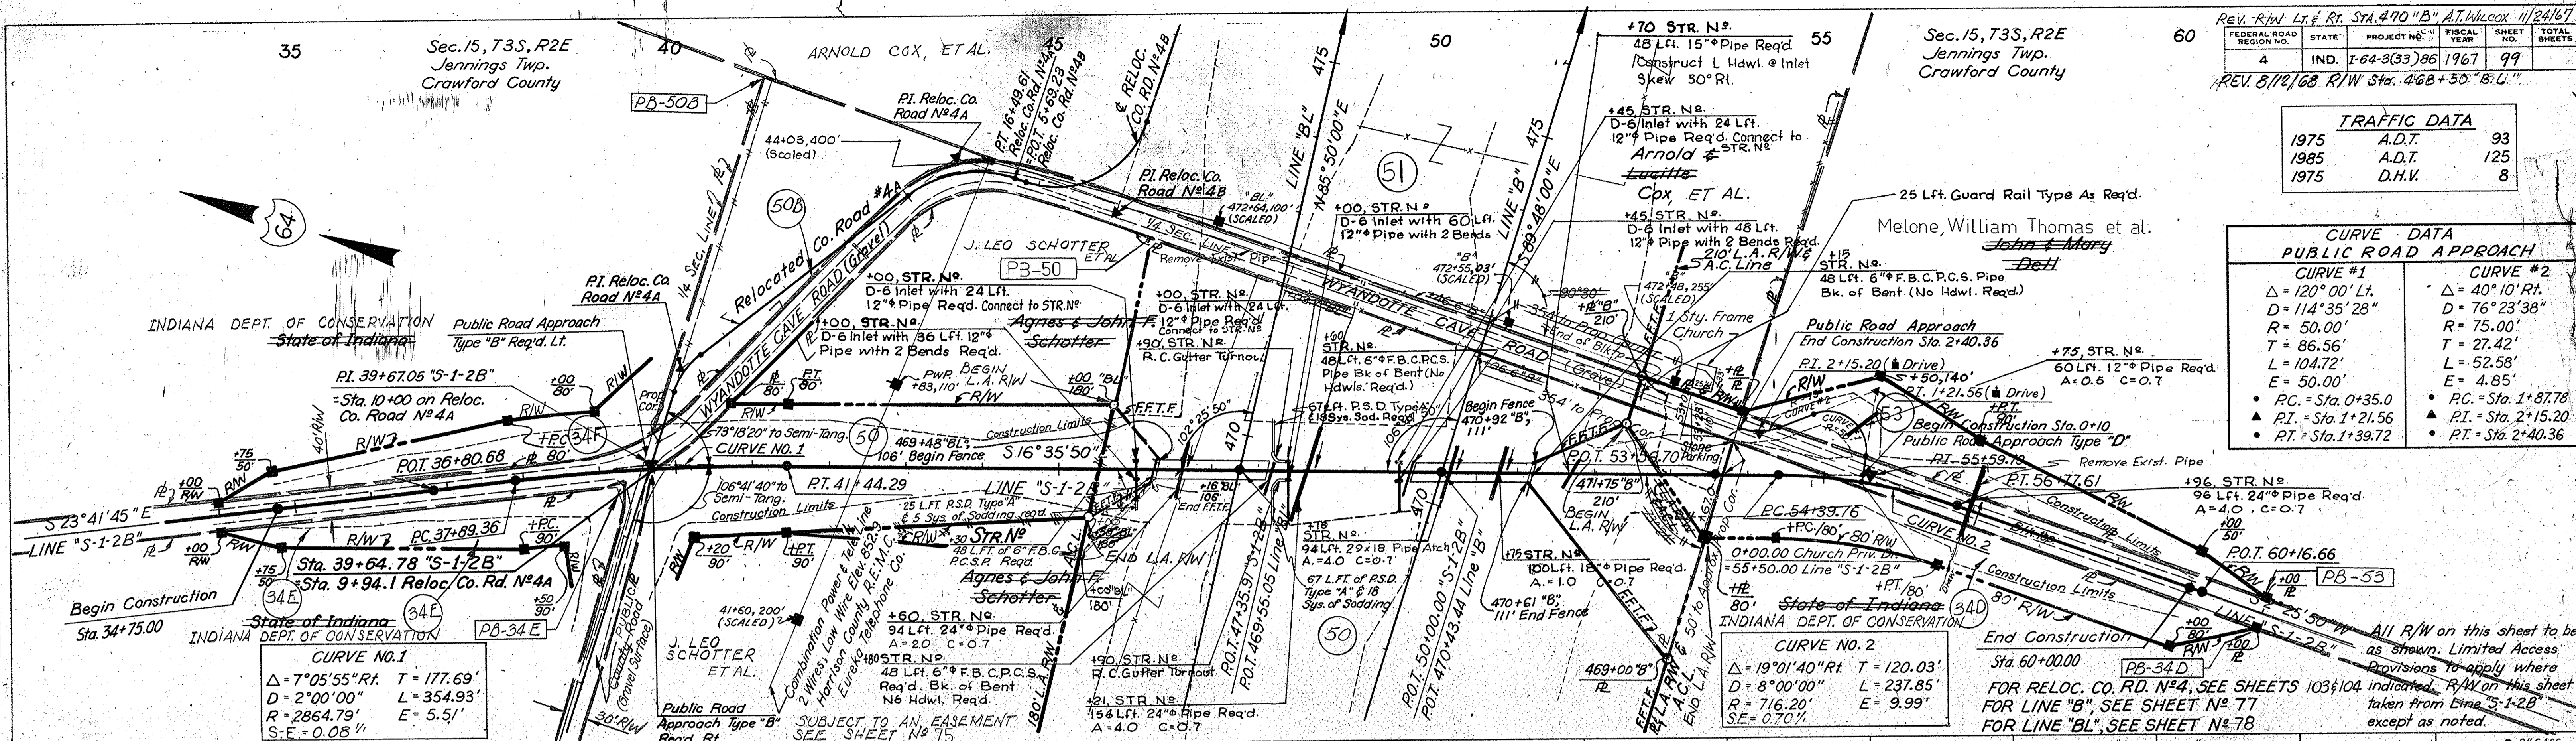


DATE: 11-66
BY: P.A.G.
CHECKED: M.E.C.
NO. 64-3(3)86-99

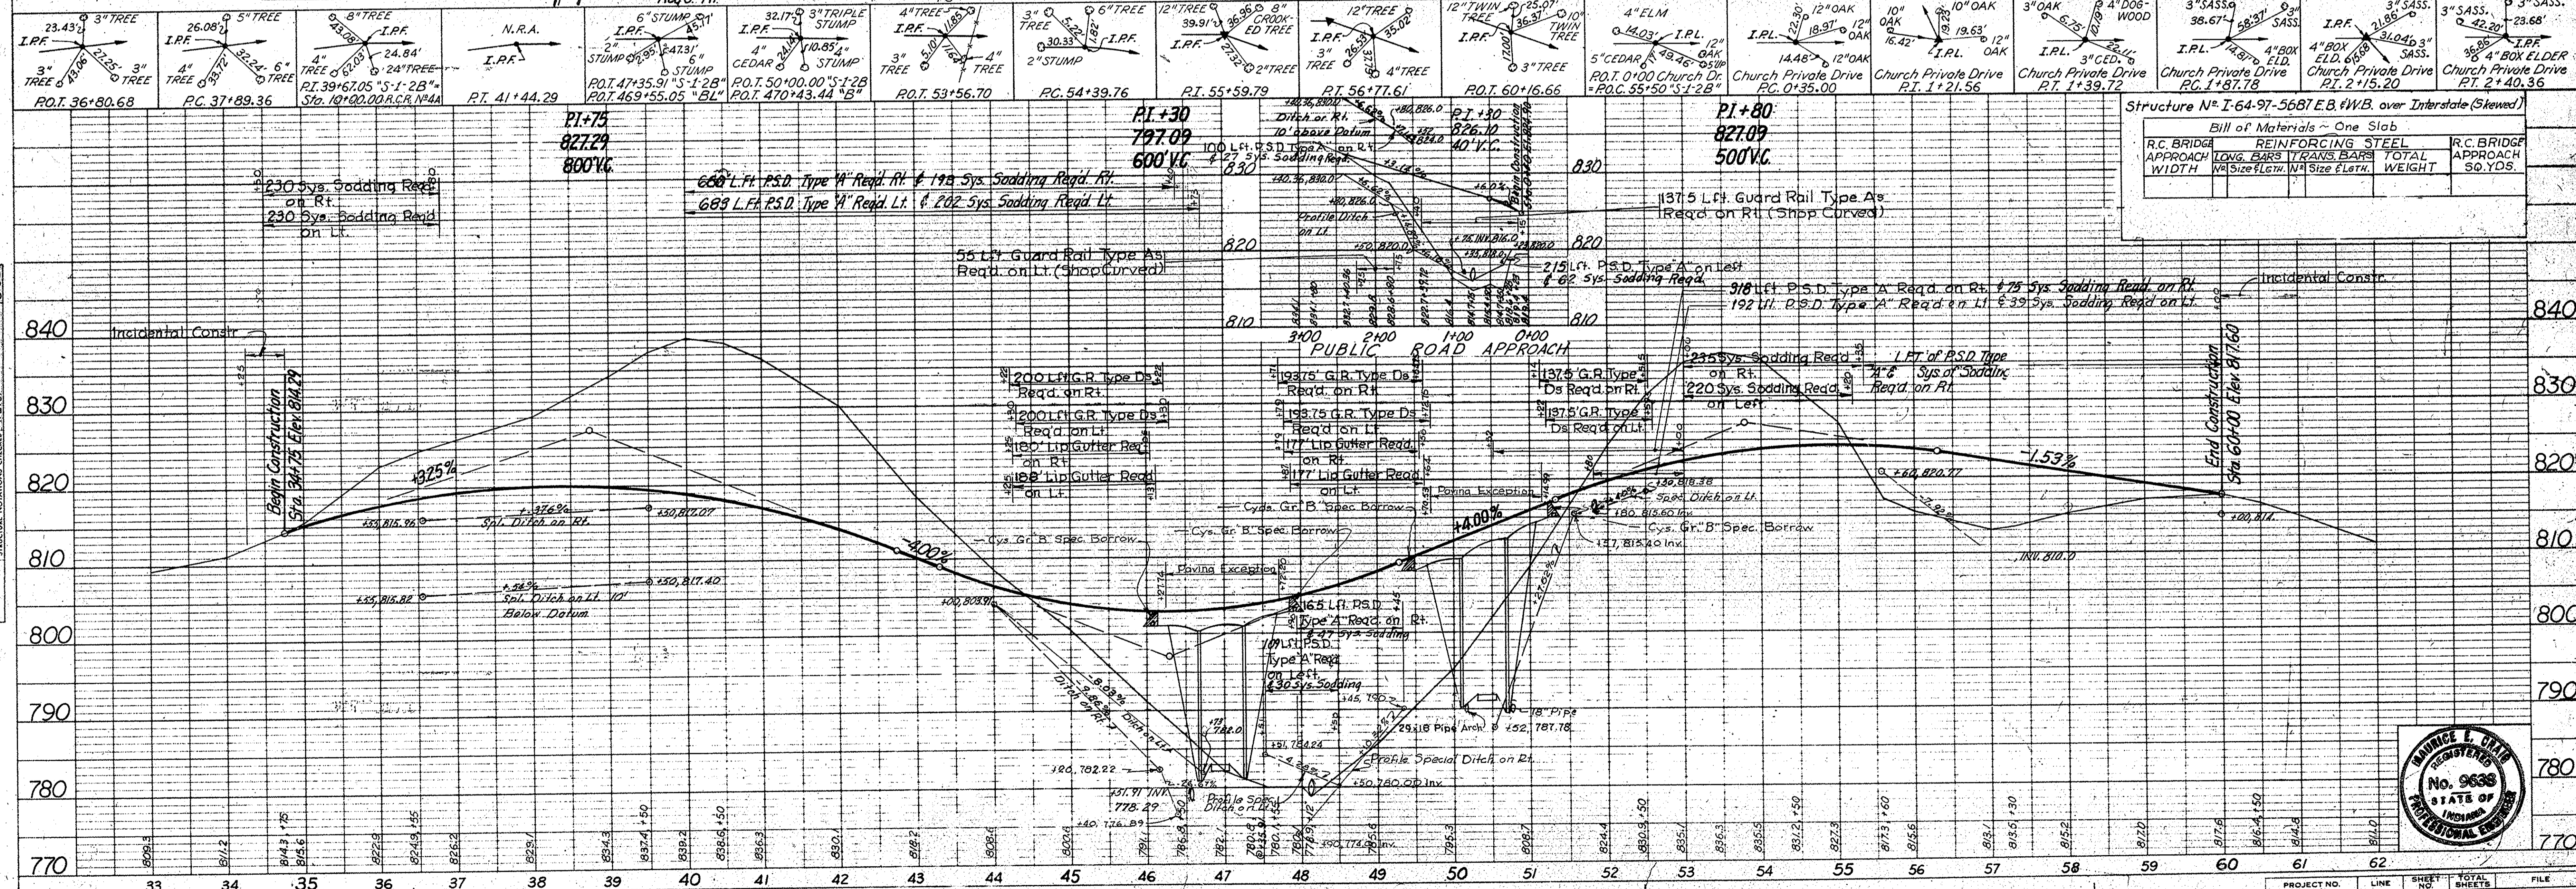



Structure No. I-64-97-5687 E.B. W.B. over Interstate (Skewed)			
Bill of Materials - One Slab			
R.C. BRIDGE APPROACH WIDTH	REINFORCING STEEL LONG BARS TRANS BARS	TOTAL WEIGHT	R.C. BRIDGE APPROACH SQ. YDS.

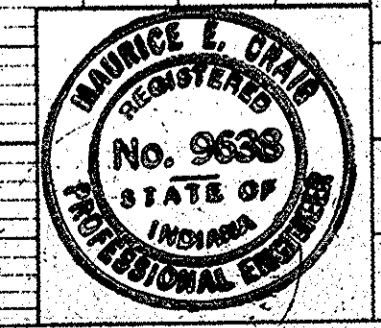

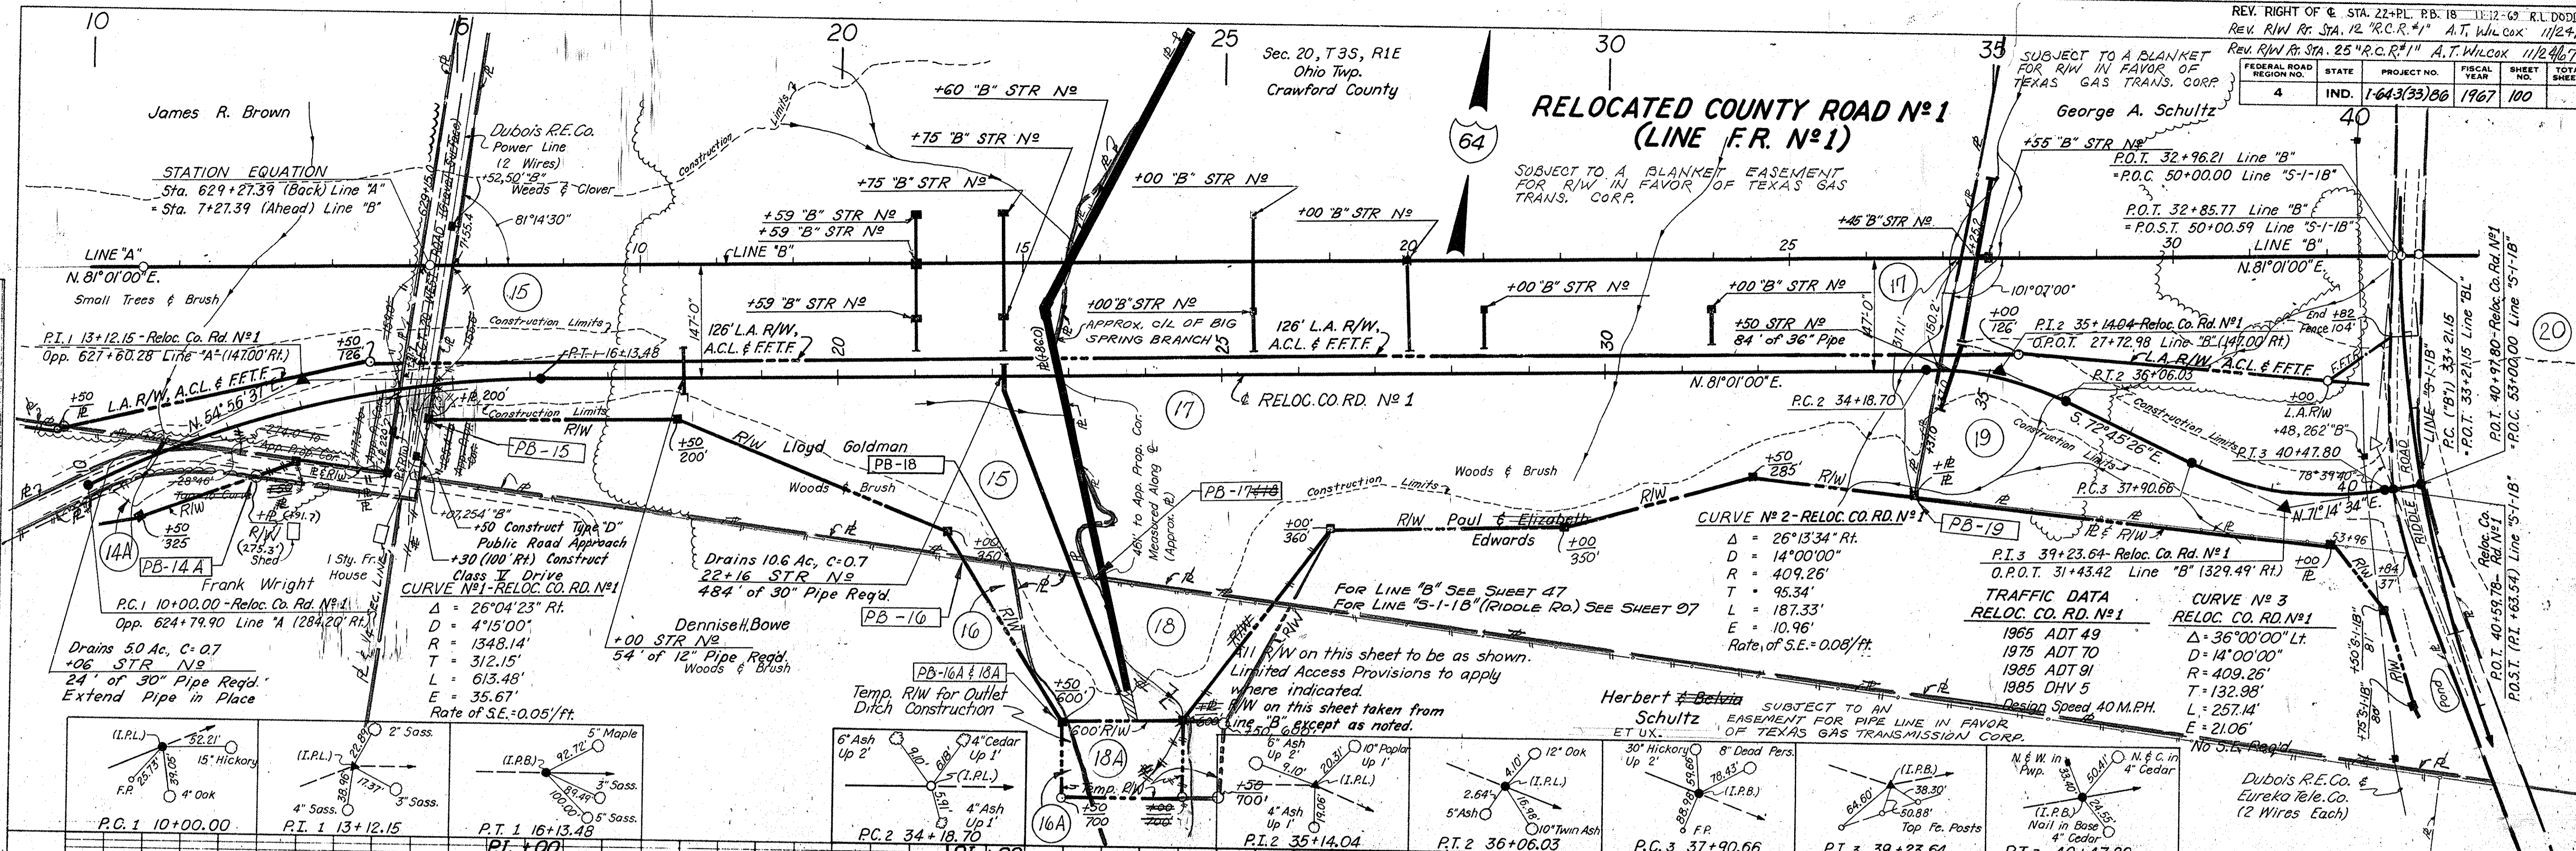

PLAN
 SURVEYED BY I.S.H.C. 1-5-66
 CHECKED BY R.M.A. 1-5-66
 NO. 93722

PROFILE
 SURVEYED BY I.S.H.C. 1-5-66
 CHECKED BY R.M.A. 1-5-66
 NO. 93722

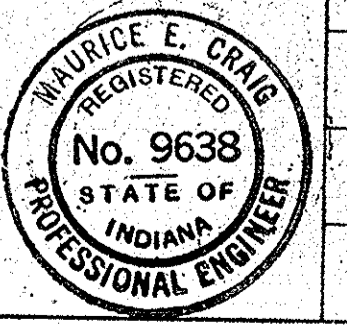
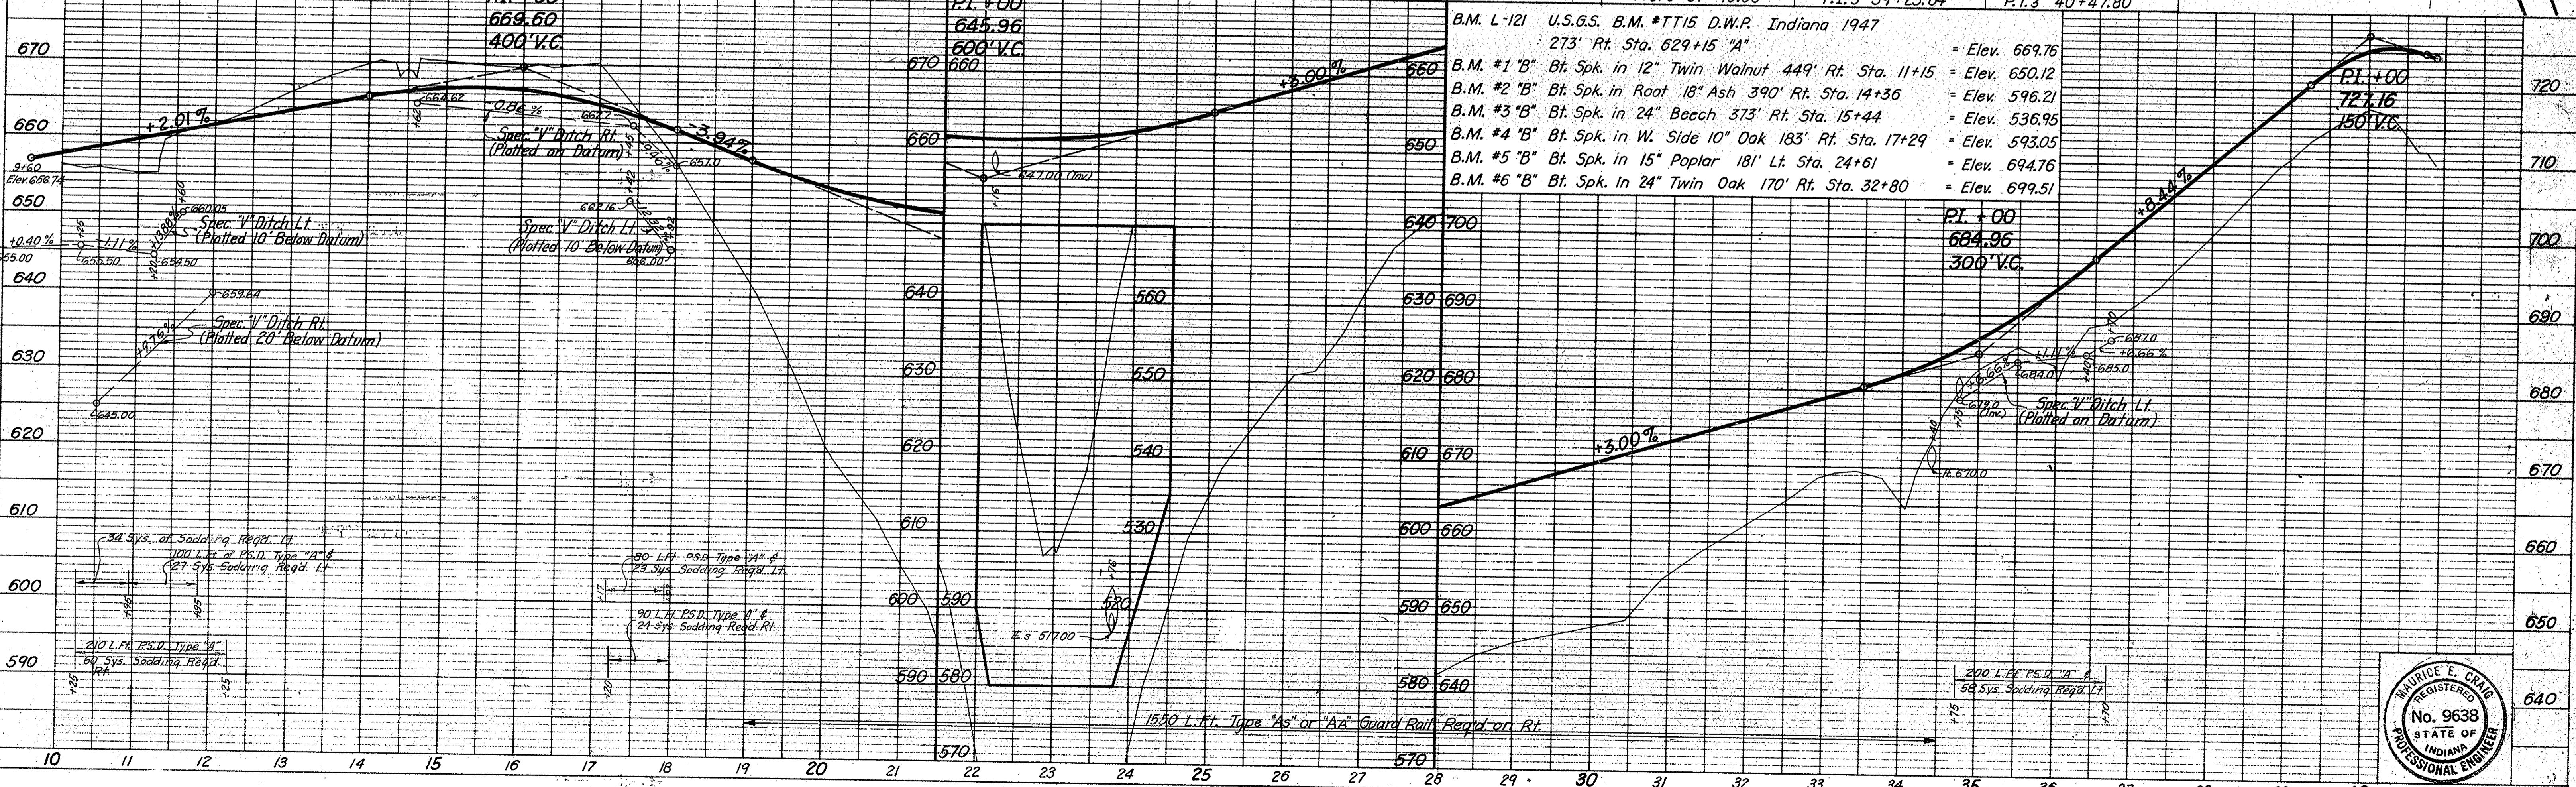


RELOCATED COUNTY ROAD NO 2 (LINE F.R. NO 1)

REV. RWI LT. STA. 14+RC.R. #2 "A. WILCOX 11/24/67					
FEDERAL ROAD REGION NO. 4	STATE IND.	PROJECT NO. I-64-3(33)86	FISCAL YEAR 1967	SHEET NO. 101	TOTAL SHEETS 101

PLAN
SURVEYED BY I.S.H.C.
P.L.G.
D.E.C.
G.P.C.
NOTE BOOK ALIGNMENT CHECKED No. 2423-9827 OF W.M. CHICAGO

PROFILE
SURVEYED BY I.S.H.C.
P.L.G.
D.E.C.
G.P.C.
NOTE BOOK GRADE CHECKED No. 7557-L STRUCTURE NOTATIONS CHECKED G.P.C.

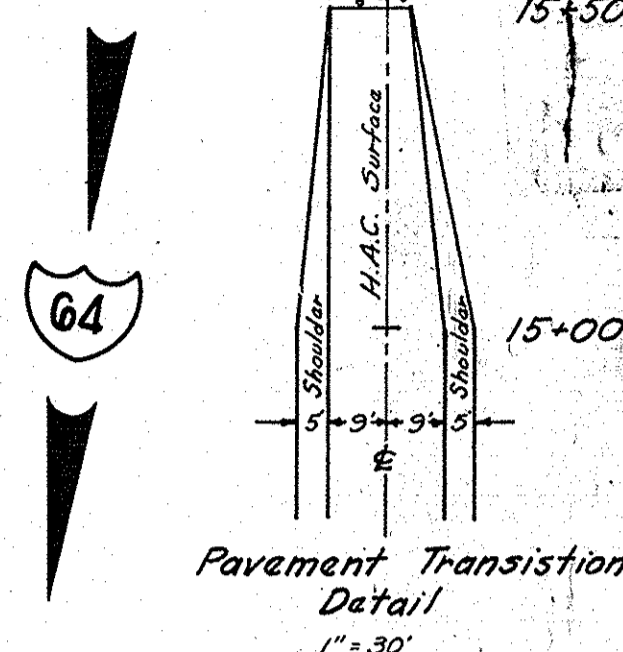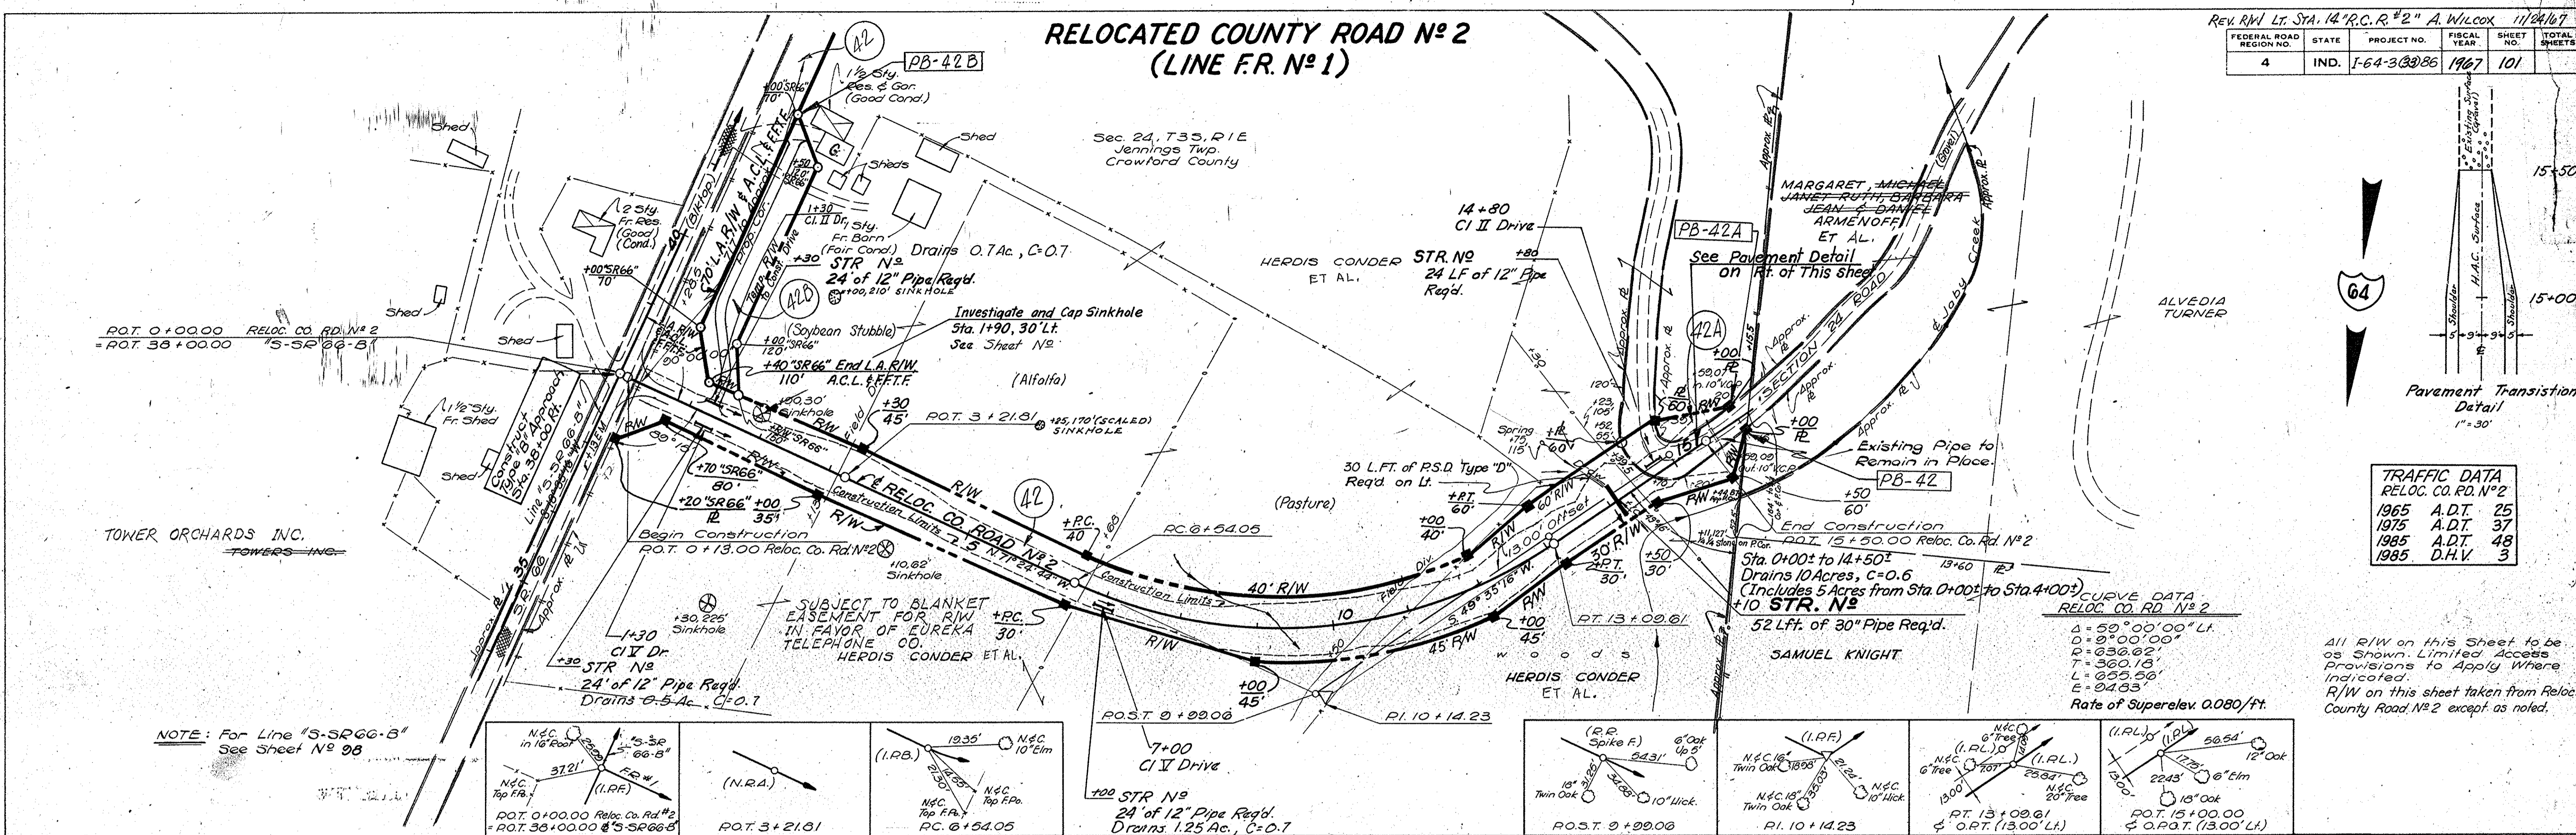


TRAFFIC DATA
RELOC. CO. RD. NO 2

1965	A.D.T.	25
1975	A.D.T.	37
1985	A.D.T.	48
1985	D.H.V.	3

CURVE DATA
RELOC. CO. RD. NO 2

$\Delta = 59^{\circ}00'00''$ LI
$D = 9^{\circ}00'00''$
$R = 336.02'$
$T = 360.13'$
$E = 055.56'$
$L = 04.03'$
Rate of Superlev. 0.080/ft.

All R/W on this Sheet to be as Shown. Limited Access Provisions to Apply Where Indicated.
R/W on this sheet taken from Reloc. County Road No 2 except as noted.

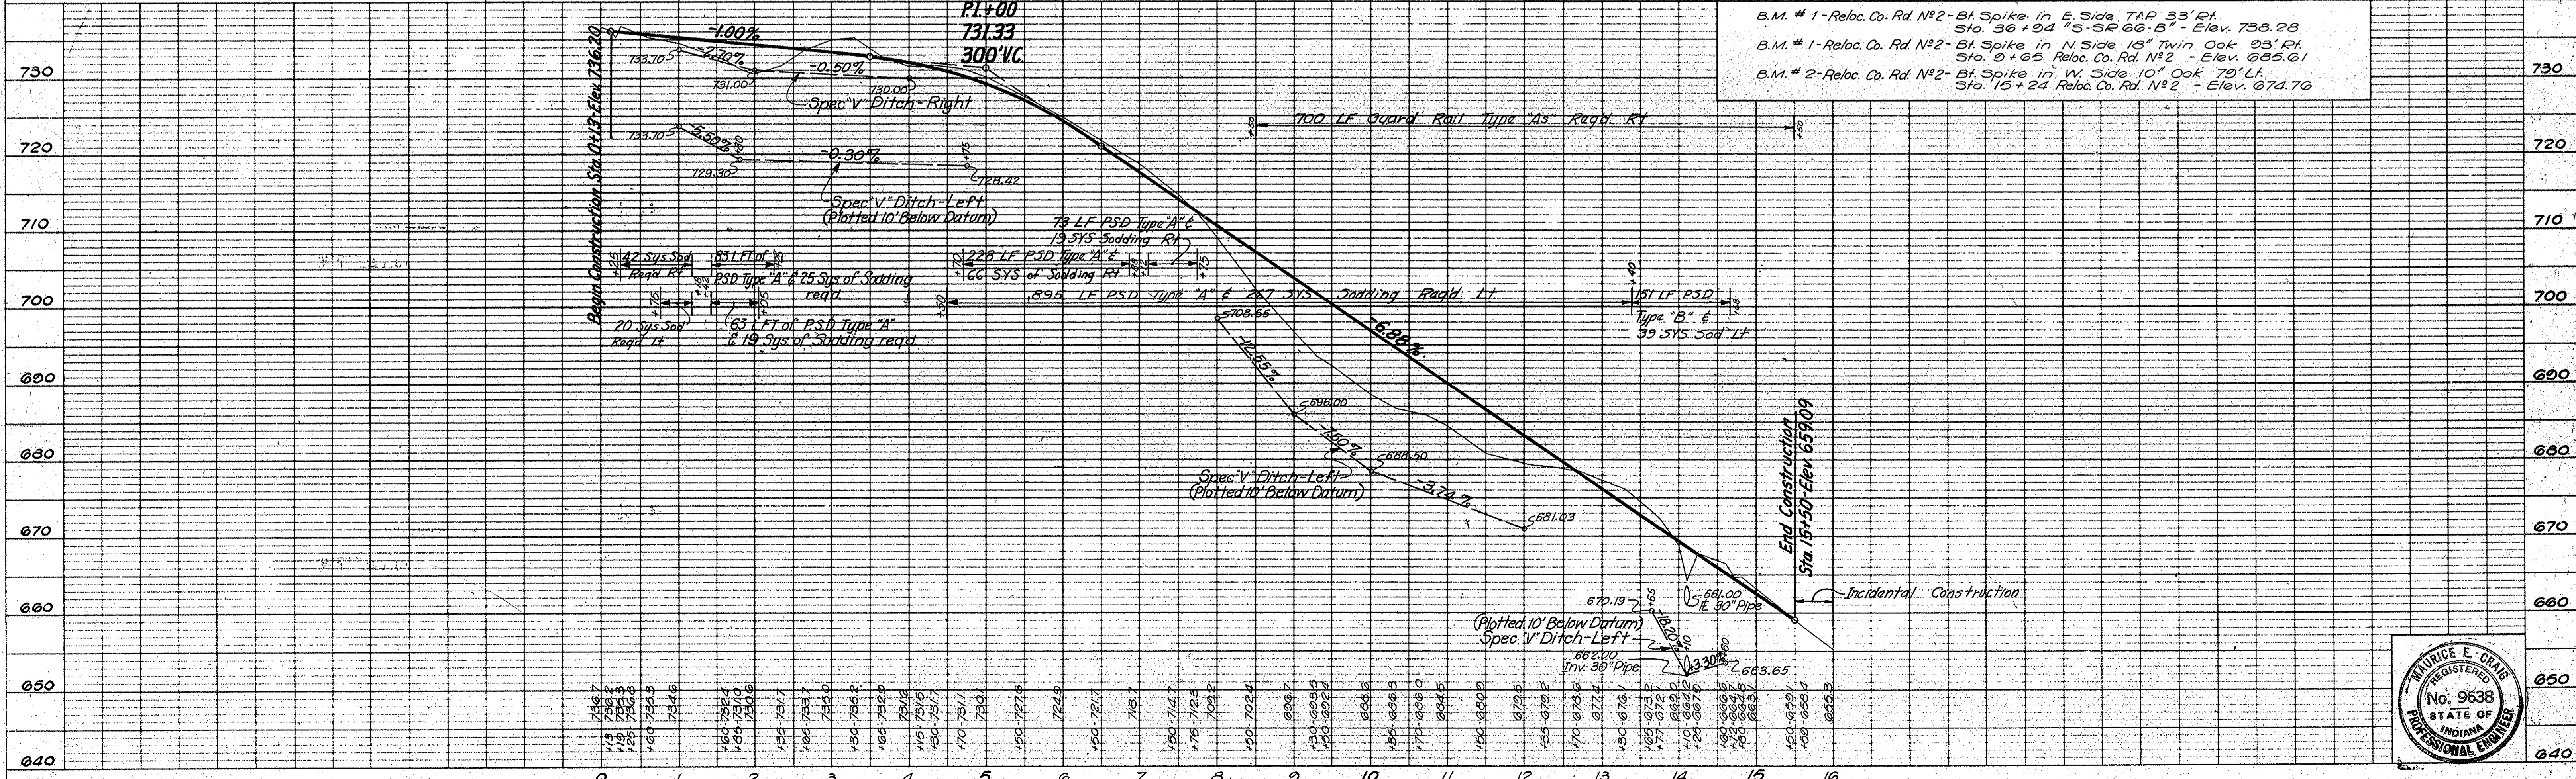

- B.M. # 1 - Reloc. Co. Rd. No 2 - Bt. Spike in E. Side TAP 33' RT. Sta. 36+94 "S-SR 66-B" - Elev. 733.28
- B.M. # 1 - Reloc. Co. Rd. No 2 - Bt. Spike in N. Side 18" Twin Oak 93' RT. Sta. 9+65 Reloc. Co. Rd. No 2 - Elev. 685.61
- B.M. # 2 - Reloc. Co. Rd. No 2 - Bt. Spike in W. Side 10" Oak 70' LT. Sta. 15+24 Reloc. Co. Rd. No 2 - Elev. 674.70

PROJECT NO. I-64-3(33)86	LINE RC.R. #2	SHEET NO. 101	TOTAL SHEETS 101	FILE
--------------------------	---------------	---------------	------------------	------



FEDERAL ROAD REGION NO.	STATE	PROJECT NO.	FISCAL YEAR	SHEET NO.	TOTAL SHEETS
4	IND.	1-64-3(2)86	1967	102	

RELOCATED COUNTY ROAD NO 3 (LINE F.R. NO 2)

CURVE DATA - Reloc. Co. Rd. No 3

CURVE NO 1	CURVE NO 2	CURVE NO 3
$\Delta = 71^{\circ}00'00''$ Lt.	$\Delta = 6^{\circ}41'50''$ Rt.	$\Delta = 45^{\circ}40'00''$ Rt.
$D = 17^{\circ}36'00''$	$D = 5^{\circ}00'00''$	$D = 10^{\circ}00'00''$
$R = 325.54'$	$R = 1145.92'$	$R = 301.96'$
$T = 232.21'$	$T = 87.03'$	$T = 126.97'$
$L = 403.41'$	$L = 133.94'$	$L = 240.35'$
$E = 74.33'$	$E = 1.06'$	$E = 25.64'$
$S.E. = 0.04'/ft.$	$S.E. = \text{Reverse Tilt}$	$S.E. = 0.08'/ft.$

TRAFFIC DATA
Reloc. Co. Rd. No 3


1965 A.D.T.	30
1975 A.D.T.	43
1985 A.D.T.	58
1985 D.H.V.	4

All R/W on this sheet to be as shown. Limited Access Provisions to Apply Where Indicated.
R/W on this sheet taken from Reloc. County Road No 3 except as noted.

EQUATION:
R.O.T. 10+00.00 Reloc. Co. Rd. No 3
= R.O.T. 62+00.00 "S-SR66-B"

PLAN
DATE: 1-6-66
BY: J.S.H.C.
CHECKED: P.D.G.
NO. 3-48-9-87 OF WY. CHECKED: R.M.L.

PROFILE
DATE: 1-6-66
BY: J.S.H.C.
CHECKED: P.D.G.
NO. 9-59-1-87 OF WY. CHECKED: R.M.L.

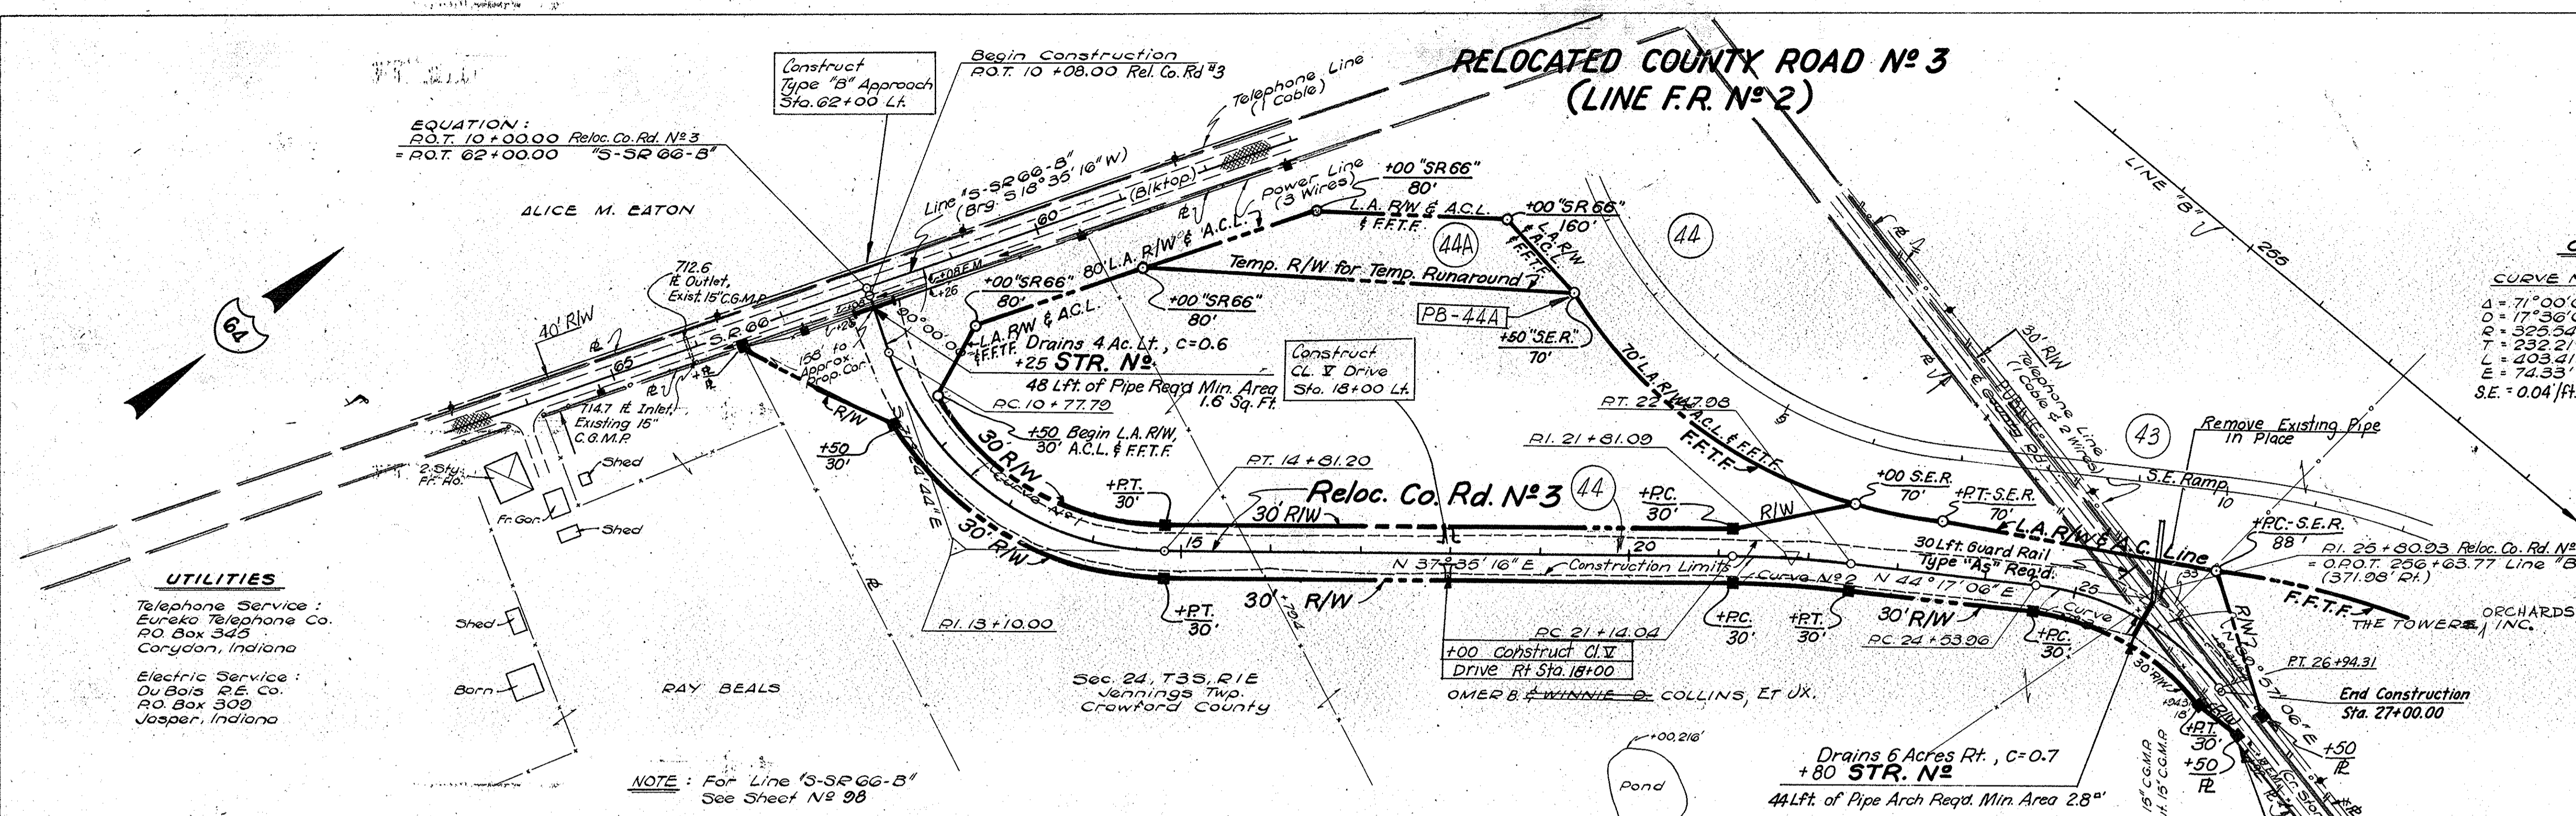


UTILITIES



Telephone Service:
Eureka Telephone Co.
P.O. Box 345
Corydon, Indiana

Electric Service:
Du Bois R.E. Co.
P.O. Box 309
Jasper, Indiana

NOTE: For Line "S-SR66-B"
See Sheet No 98

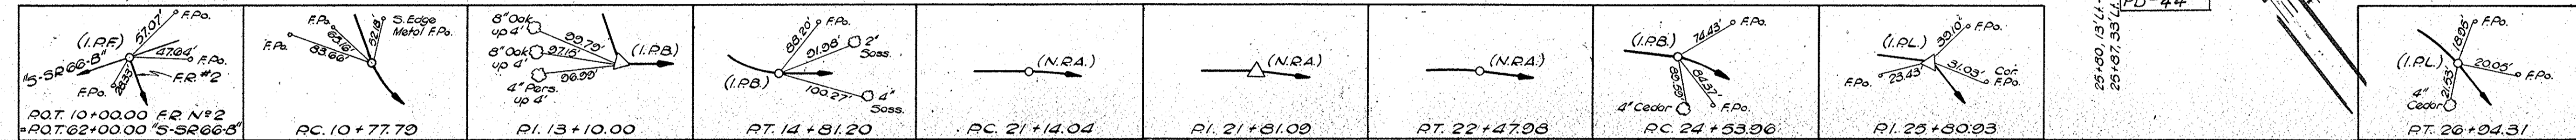


B.M. #2 "S-SR66-B": Boot Spike in W. Side Pw. R. 27' Lt. Sta. 62+01 "S-SR66-B" - Elev. 716.57
 B.M. # T-207: Top Head of Bolt in Conc. Post 22' Lt. Sta. 57+00 "S-SR66-B" - Elev. 720.86
 B.M. #44 "B": Boot Spike in W. Side 15" Walnut 172' Rt. Sta. 255+85 Line "B" - Elev. 718.70

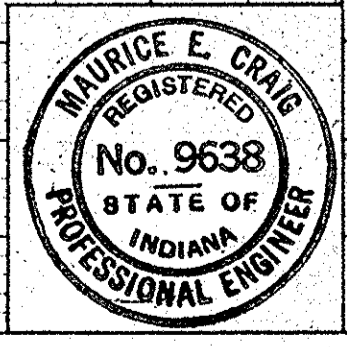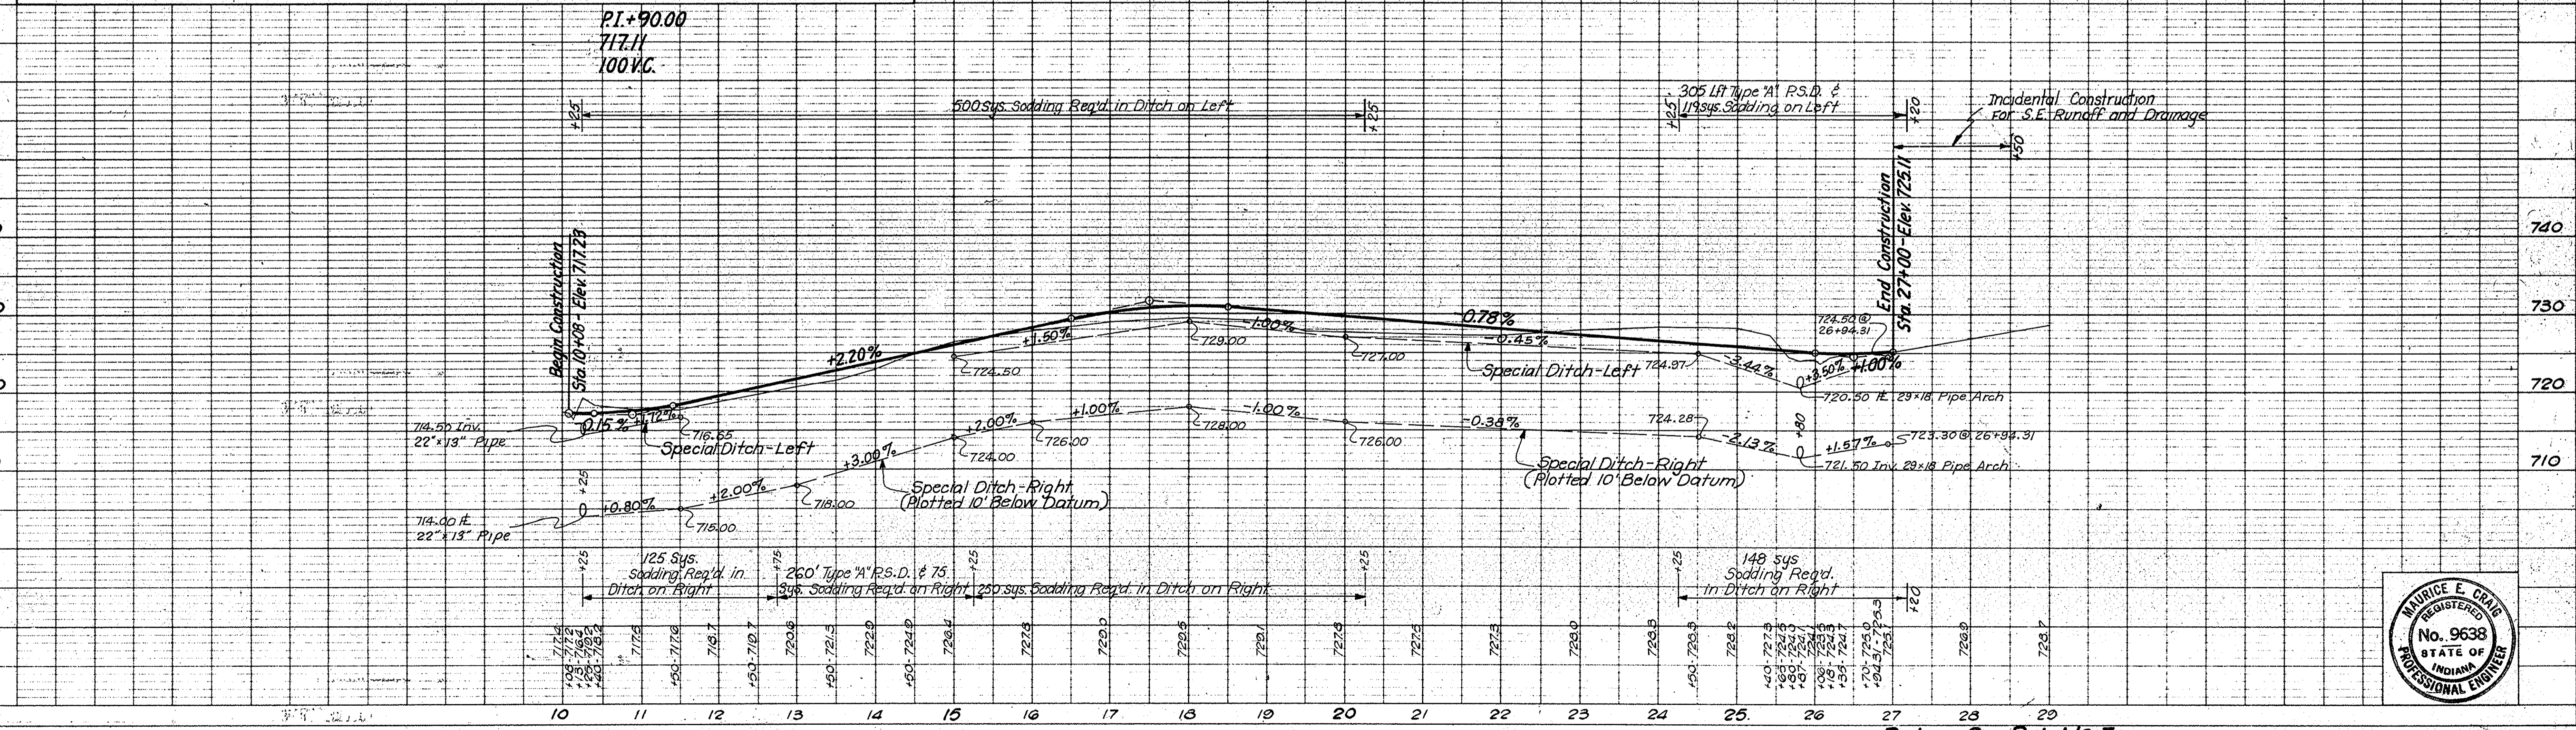

PROJECT NO.	LINE	SHEET NO.	TOTAL SHEETS	FILE
1-64-3(2)86	RCR#3	102		

REV. R/W Lt. STA. 33+5" A.T. Wic Cox 1/24/67	
FEDERAL ROAD REGION NO.	STATE
4	IND.
PROJECT NO.	FISCAL YEAR
1-64-3(33)86	1967
SHEET NO.	TOTAL SHEETS
105	105

ACCESS ROAD No 1 (LINE A.R. No 1)

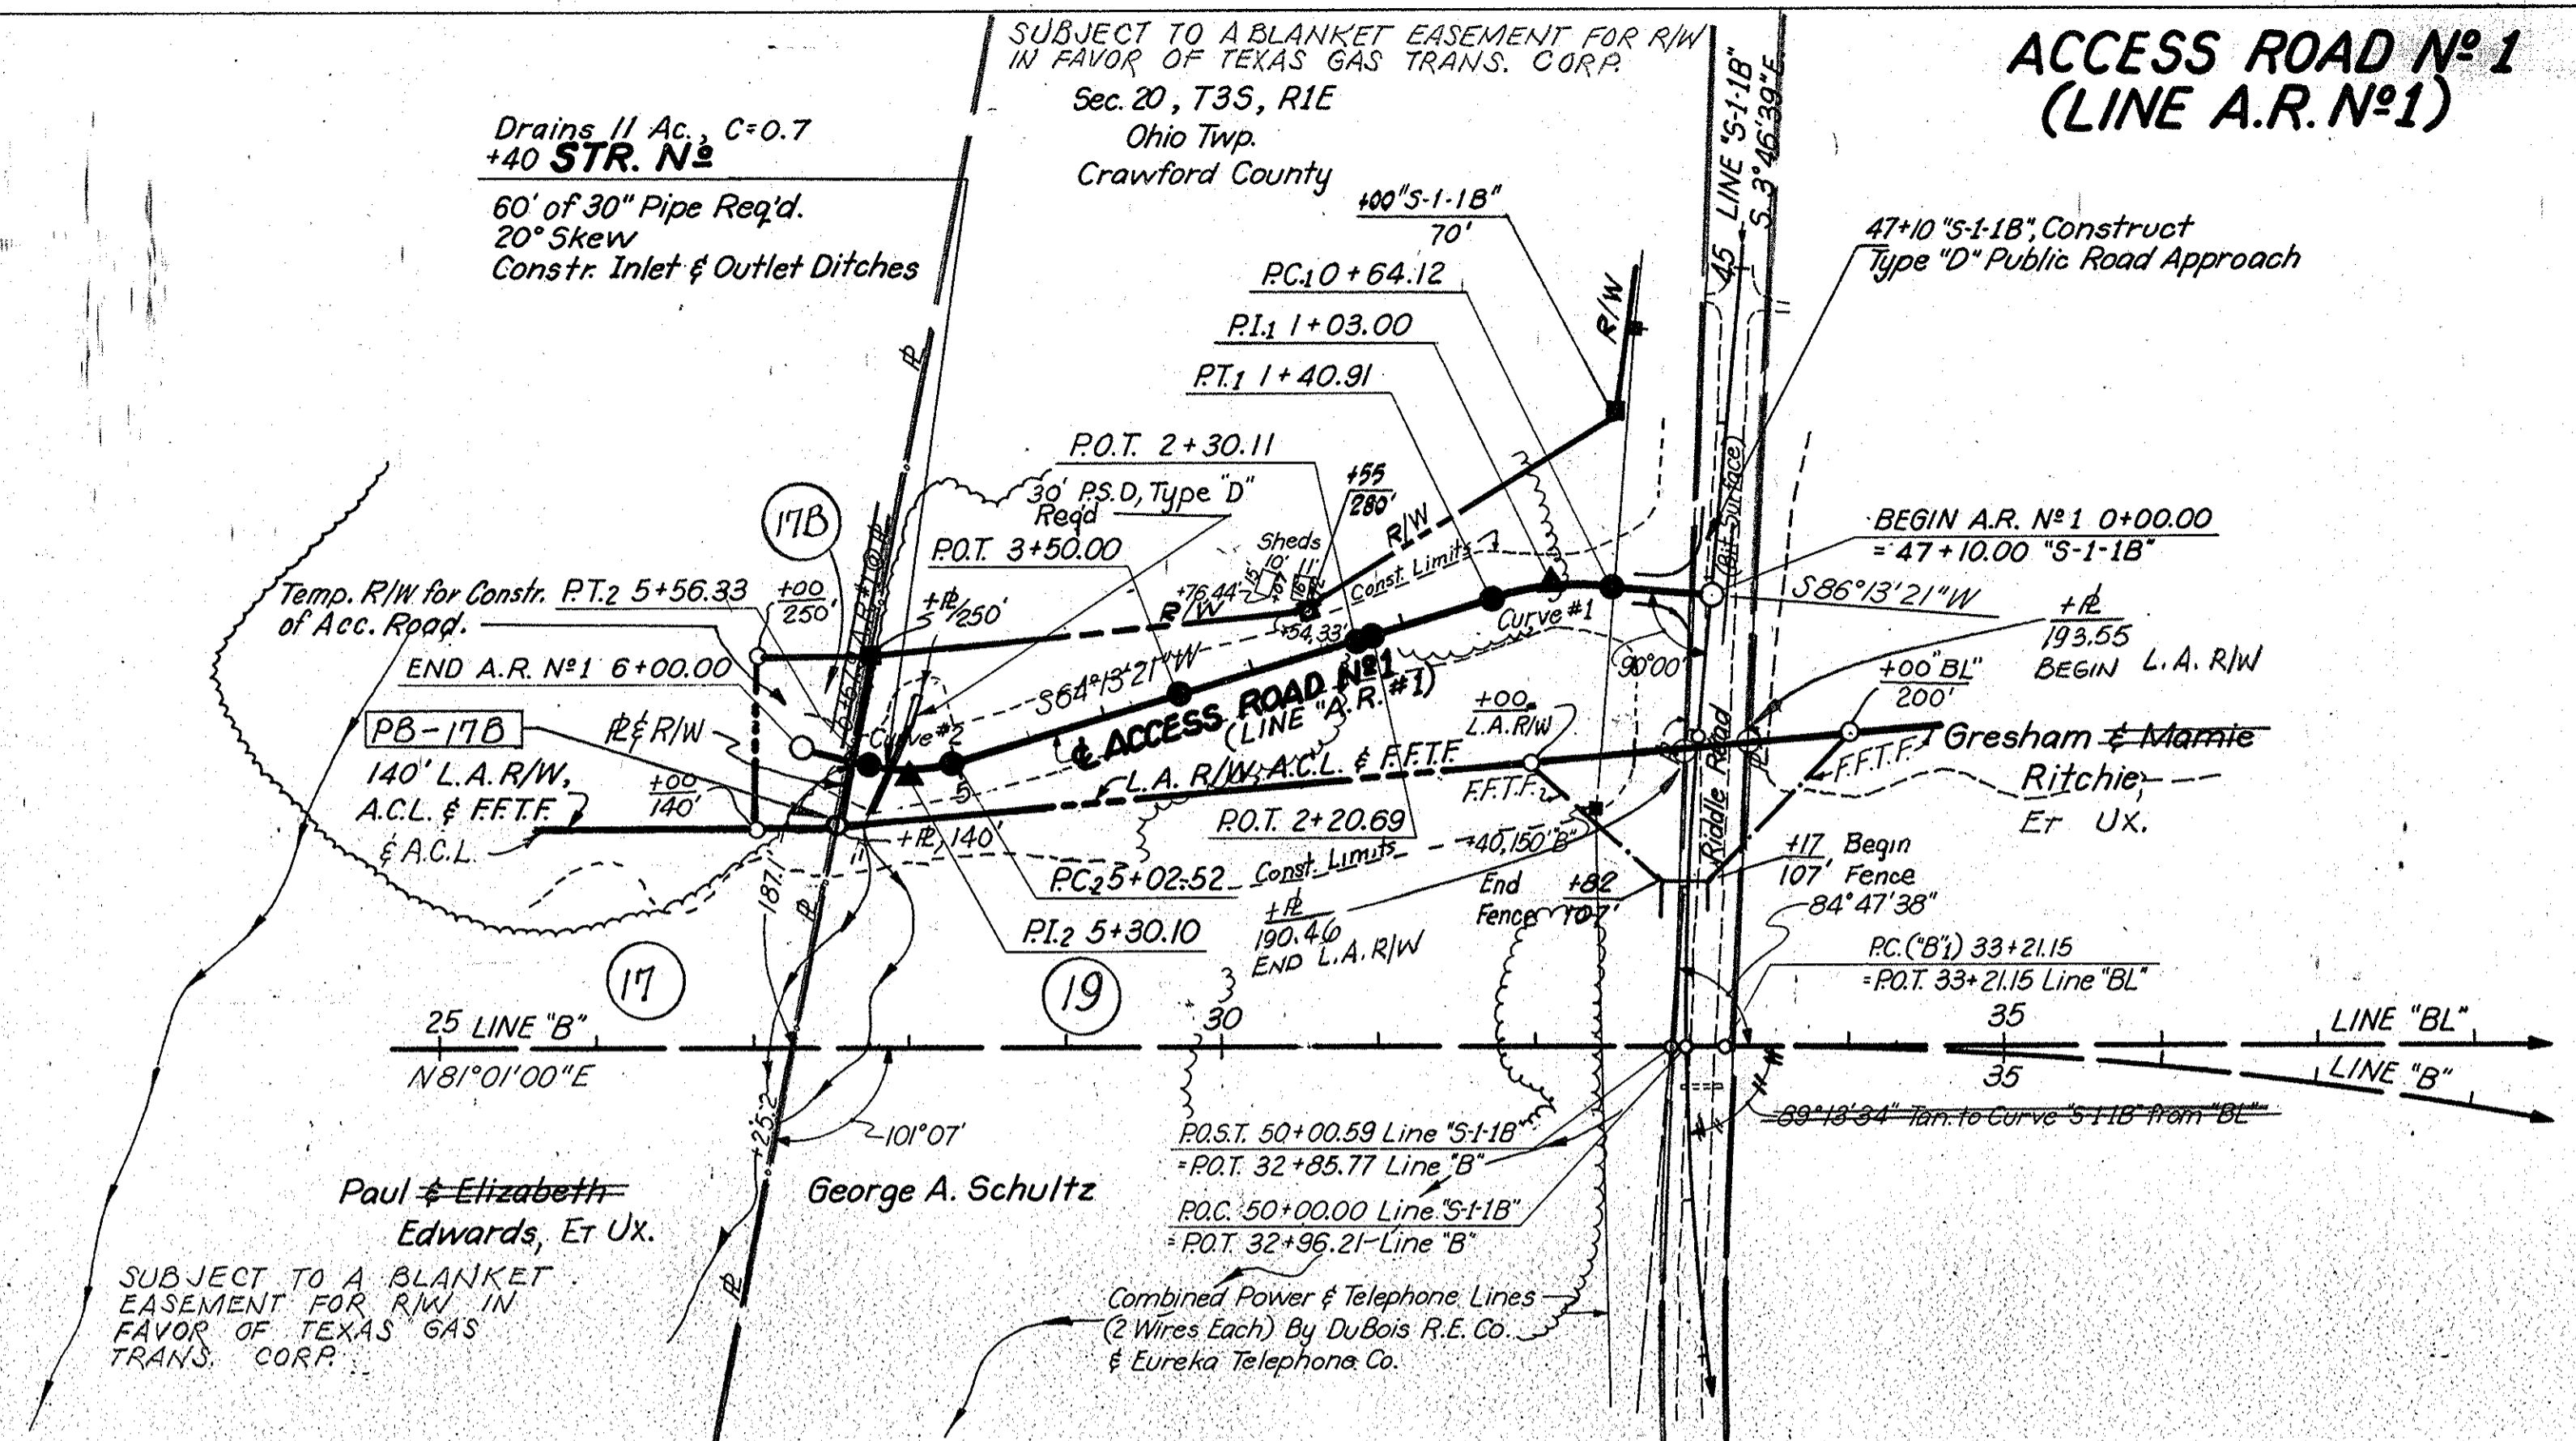


CURVE No 1-A.R. No 1	CURVE No 2-A.R. No 1
Δ=22°00'00" Lt	Δ=30°50'00" Rt
D=28°38'52.44"	D=57°17'44.58"
R=200.00'	R=100.00'
T=38.88'	T=27.58'
L=76.79'	L=53.81'
E=3.73'	E=3.73'
No S.E. Req'd.	No S.E. Req'd.

FOR LINE "B", SEE SHEET # 49
FOR LINE "BL", SEE SHEET # 50
FOR LINE "S-1-18", SEE SHEET # 97

DATE 1/66
BY I.S.H.C.
L.A.W.
J.A.W.
M.E.C.
SURVEYED BY I.S.H.C.
PLANNED BY I.S.H.C.
NOTED BY I.S.H.C.
NO. 93722



DATE 1/66
BY I.S.H.C.
L.A.W.
J.A.W.
P.C.
SURVEYED BY I.S.H.C.
PLANNED BY I.S.H.C.
NOTED BY I.S.H.C.
NO. 93722

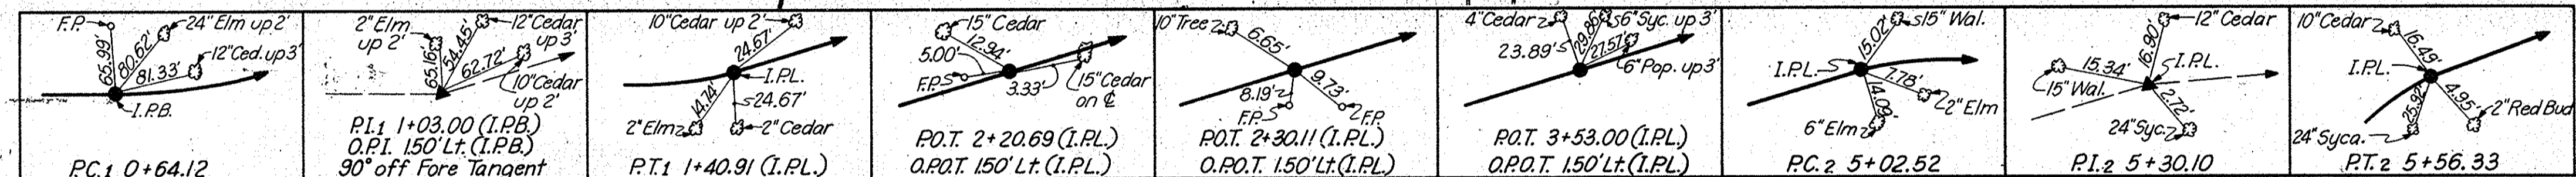

All R/W on this sheet to be as shown.
Limited Access Provisions to apply where indicated.
R/W on this sheet taken Line "B" except as noted.

NOTE: Stationed Backwards

B.M. #2 "S-1-18" - Bt. Spike in 4" Silver Poplar, 24' Lt. Sta. 47+10	Elev. 737.53
B.M. #5 "B" - Bt. Spike in 15' Poplar, 181' Lt. Sta. 24+61	Elev. 694.76

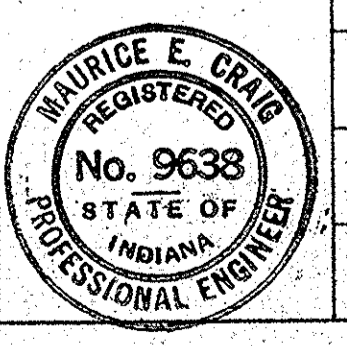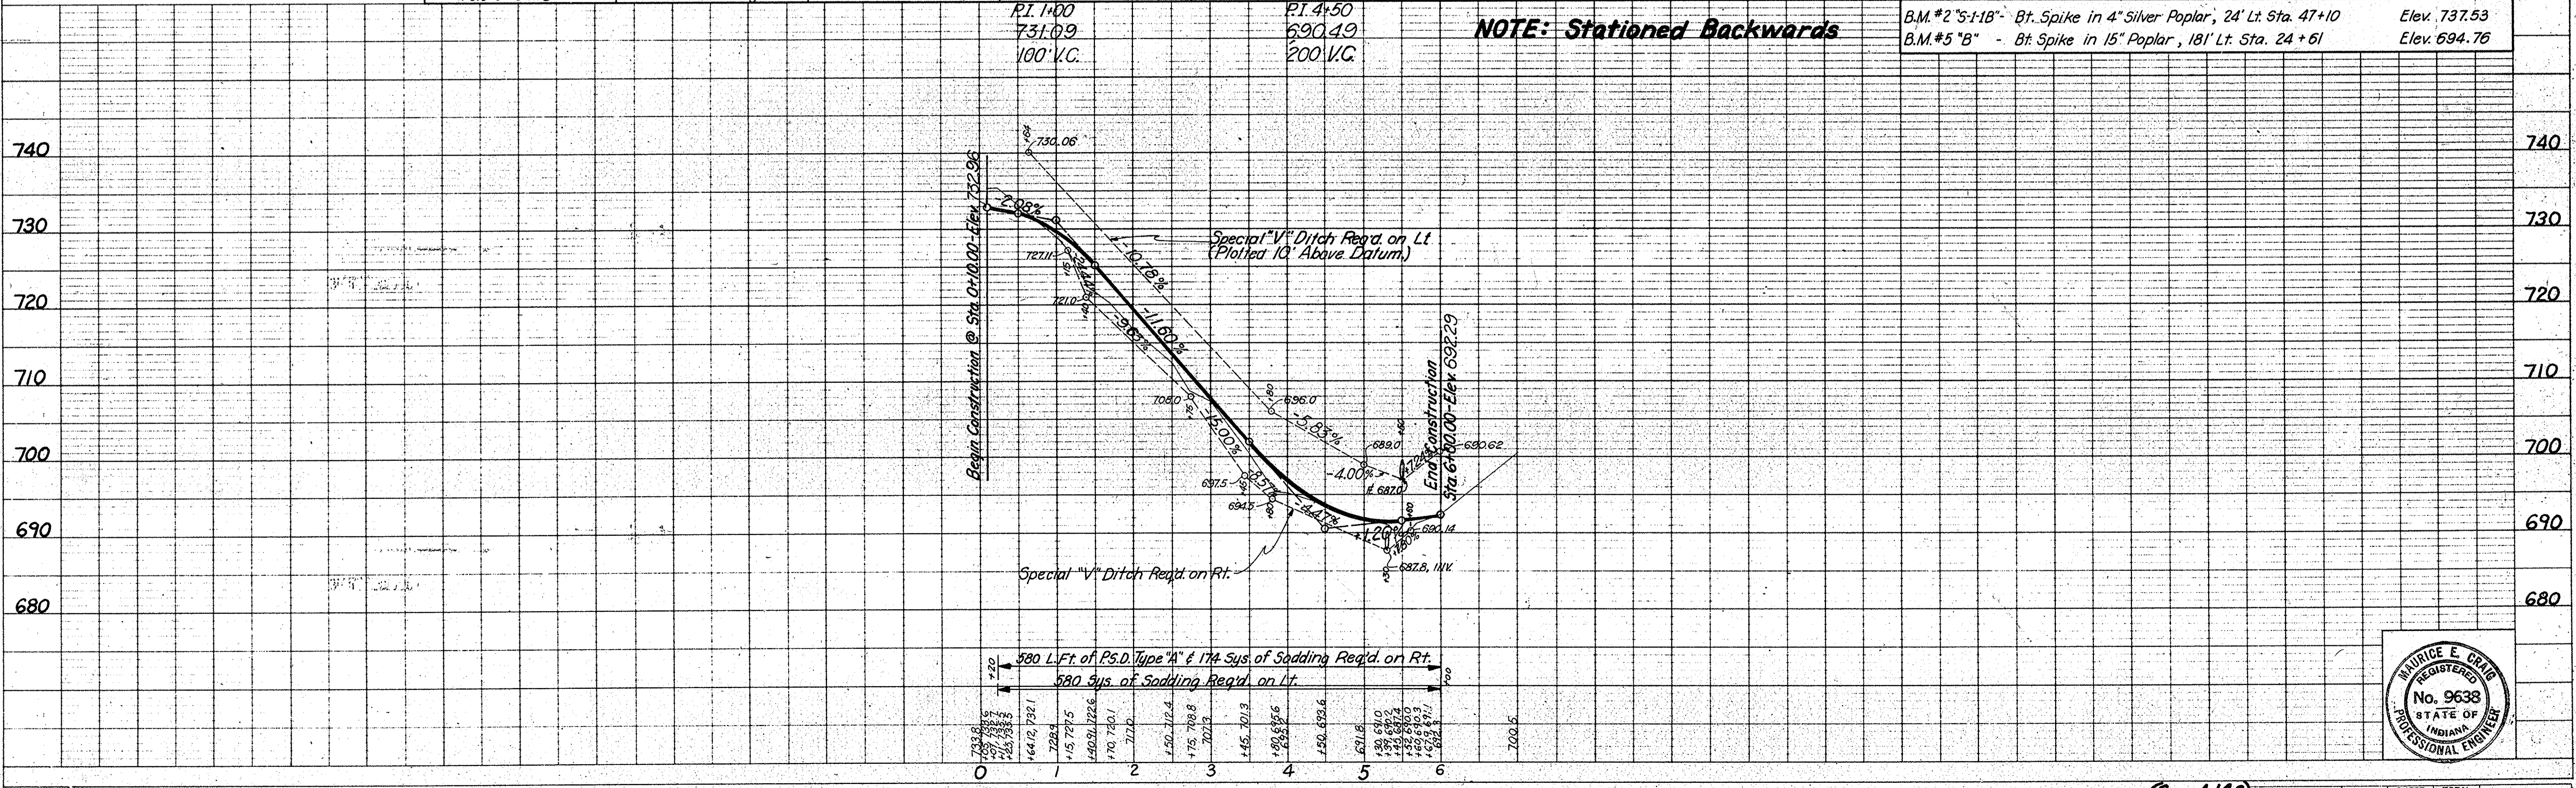

DATE: 3-66
 BY: S.H.C.
 CHECKED: M.E.C.
 DATE: 5-66
 BY: F.D.L.

PLAN: REVISIONS
 1. NOTE BOOK ALIGNMENT CHECKED
 2. NOTE BOOK GRADES CHECKED
 3. STRUCTURE NOTATIONS CHECKED, T.E.C.

DATE: 3-66
 BY: S.H.C.
 CHECKED: M.E.C.
 DATE: 5-66
 BY: F.D.L.

PROFILE: REVISIONS
 1. NOTE BOOK GRADES CHECKED
 2. NOTE BOOK GRADES CHECKED
 3. STRUCTURE NOTATIONS CHECKED, T.E.C.


Kort & Esther
 Pease, Et UX.

SUBJECT TO A BLANKET EASEMENT FOR R/W IN FAVOR OF INDIANA STATEWIDE RURAL ELECTRIC COOP, INC.

SUBJECT TO A BLANKET EASEMENT FOR R/W IN FAVOR OF INDIANA STATEWIDE RURAL ELECTRIC COOP, INC.

TRAFFIC DATA		
1975 ADT	33	
1985 ADT	45	
1975 DHV	3	

Bee & Rhode
 Cox, Et UX.

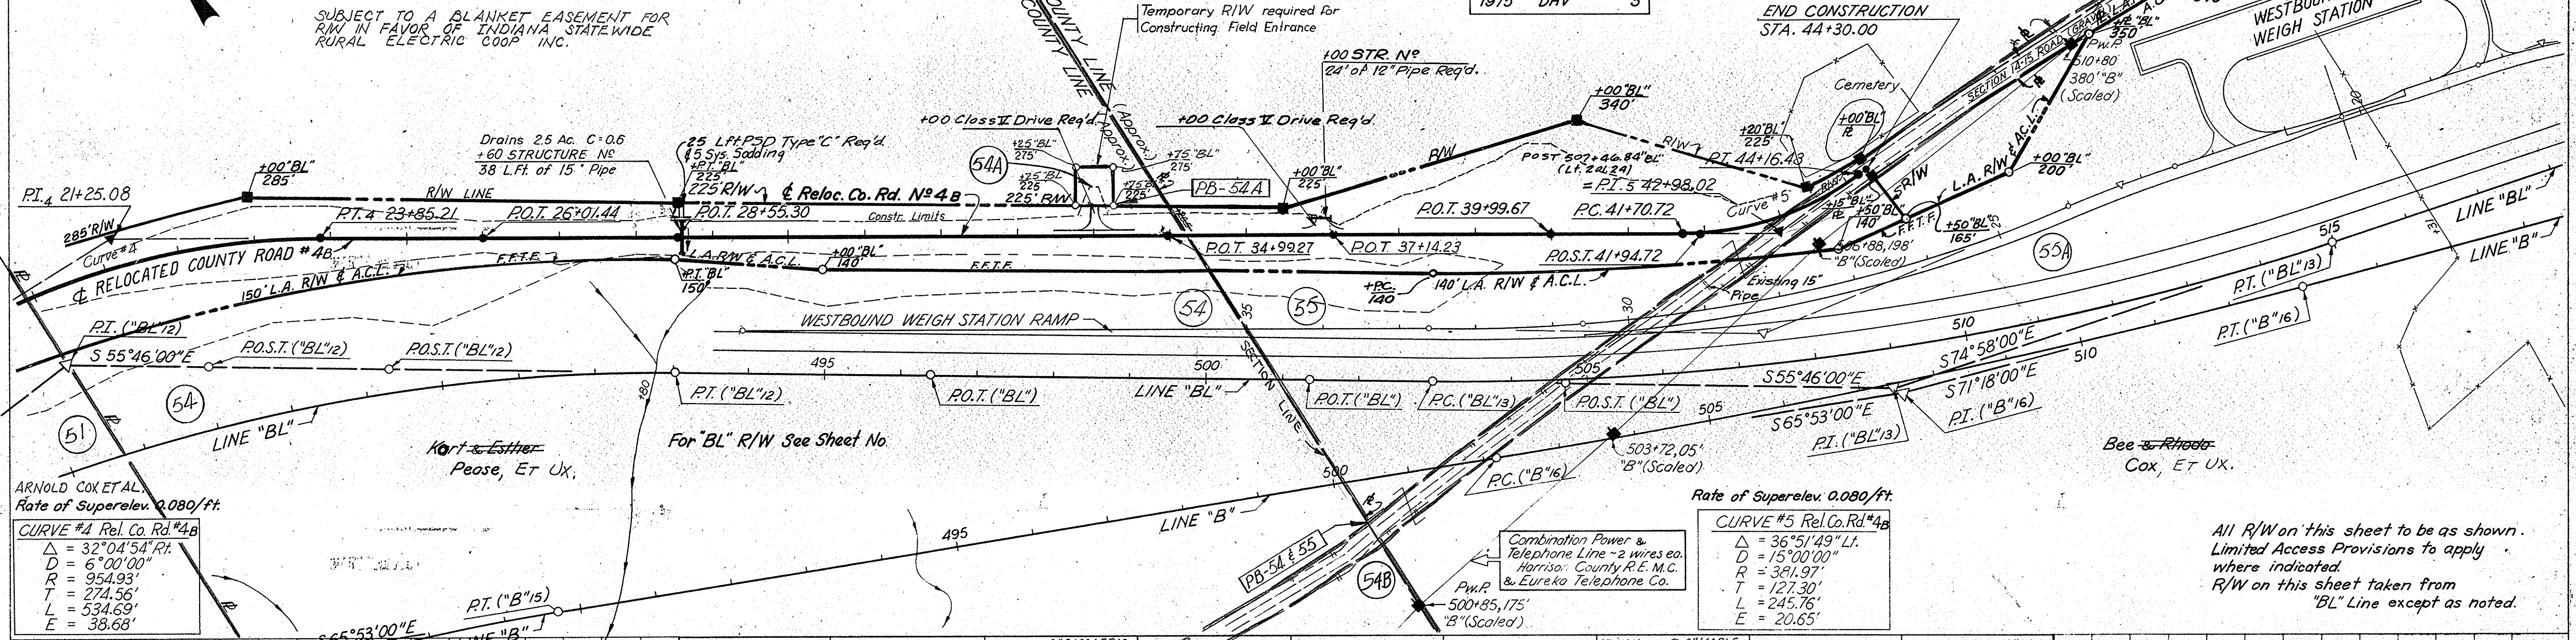



ARNOLD COX ET AL.
 Rate of Superelev. 0.080/ft.

CURVE #4 Rel. Co. Rd. #4B
 $\Delta = 32^{\circ}04'54''$ Rt.
 $D = 6^{\circ}00'00''$
 $R = 954.93'$
 $T = 274.56'$
 $L = 534.69'$
 $E = 38.68'$

Rate of Superelev. 0.080/ft.



CURVE #5 Rel. Co. Rd. #4B
 $\Delta = 36^{\circ}51'49''$ Lt.
 $D = 15^{\circ}00'00''$
 $R = 321.97'$
 $T = 127.30'$
 $L = 245.76'$
 $E = 20.65'$

All R/W on this sheet to be as shown. Limited Access Provisions to apply where indicated. R/W on this sheet taken from "BL" Line except as noted.

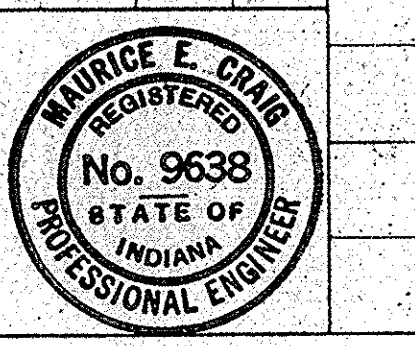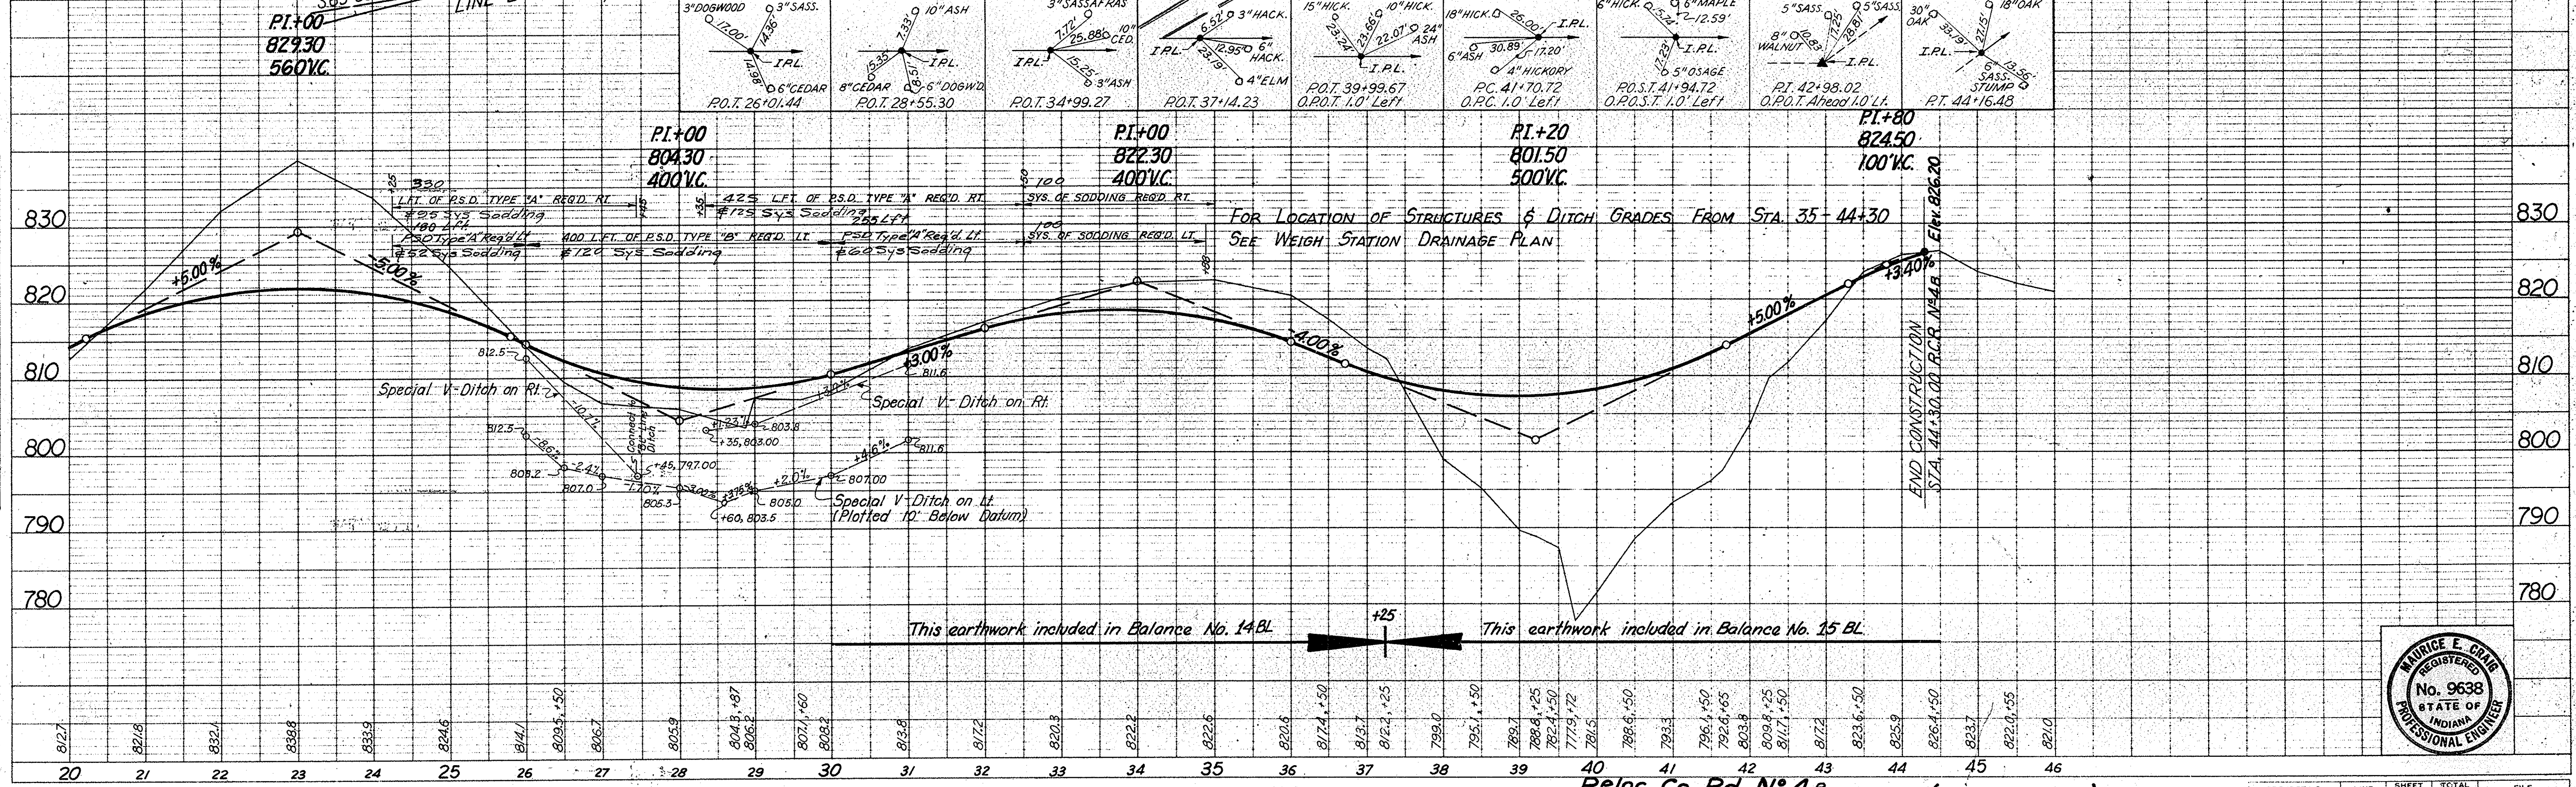

ACCESS ROAD No 2 (LINE A.R. No 1)


FEDERAL ROAD REGION NO.	STATE	PROJECT NO.	FISCAL YEAR	SHEET NO.	TOTAL SHEETS
4	IND.	1-64-3 (83) 86	1967	106	

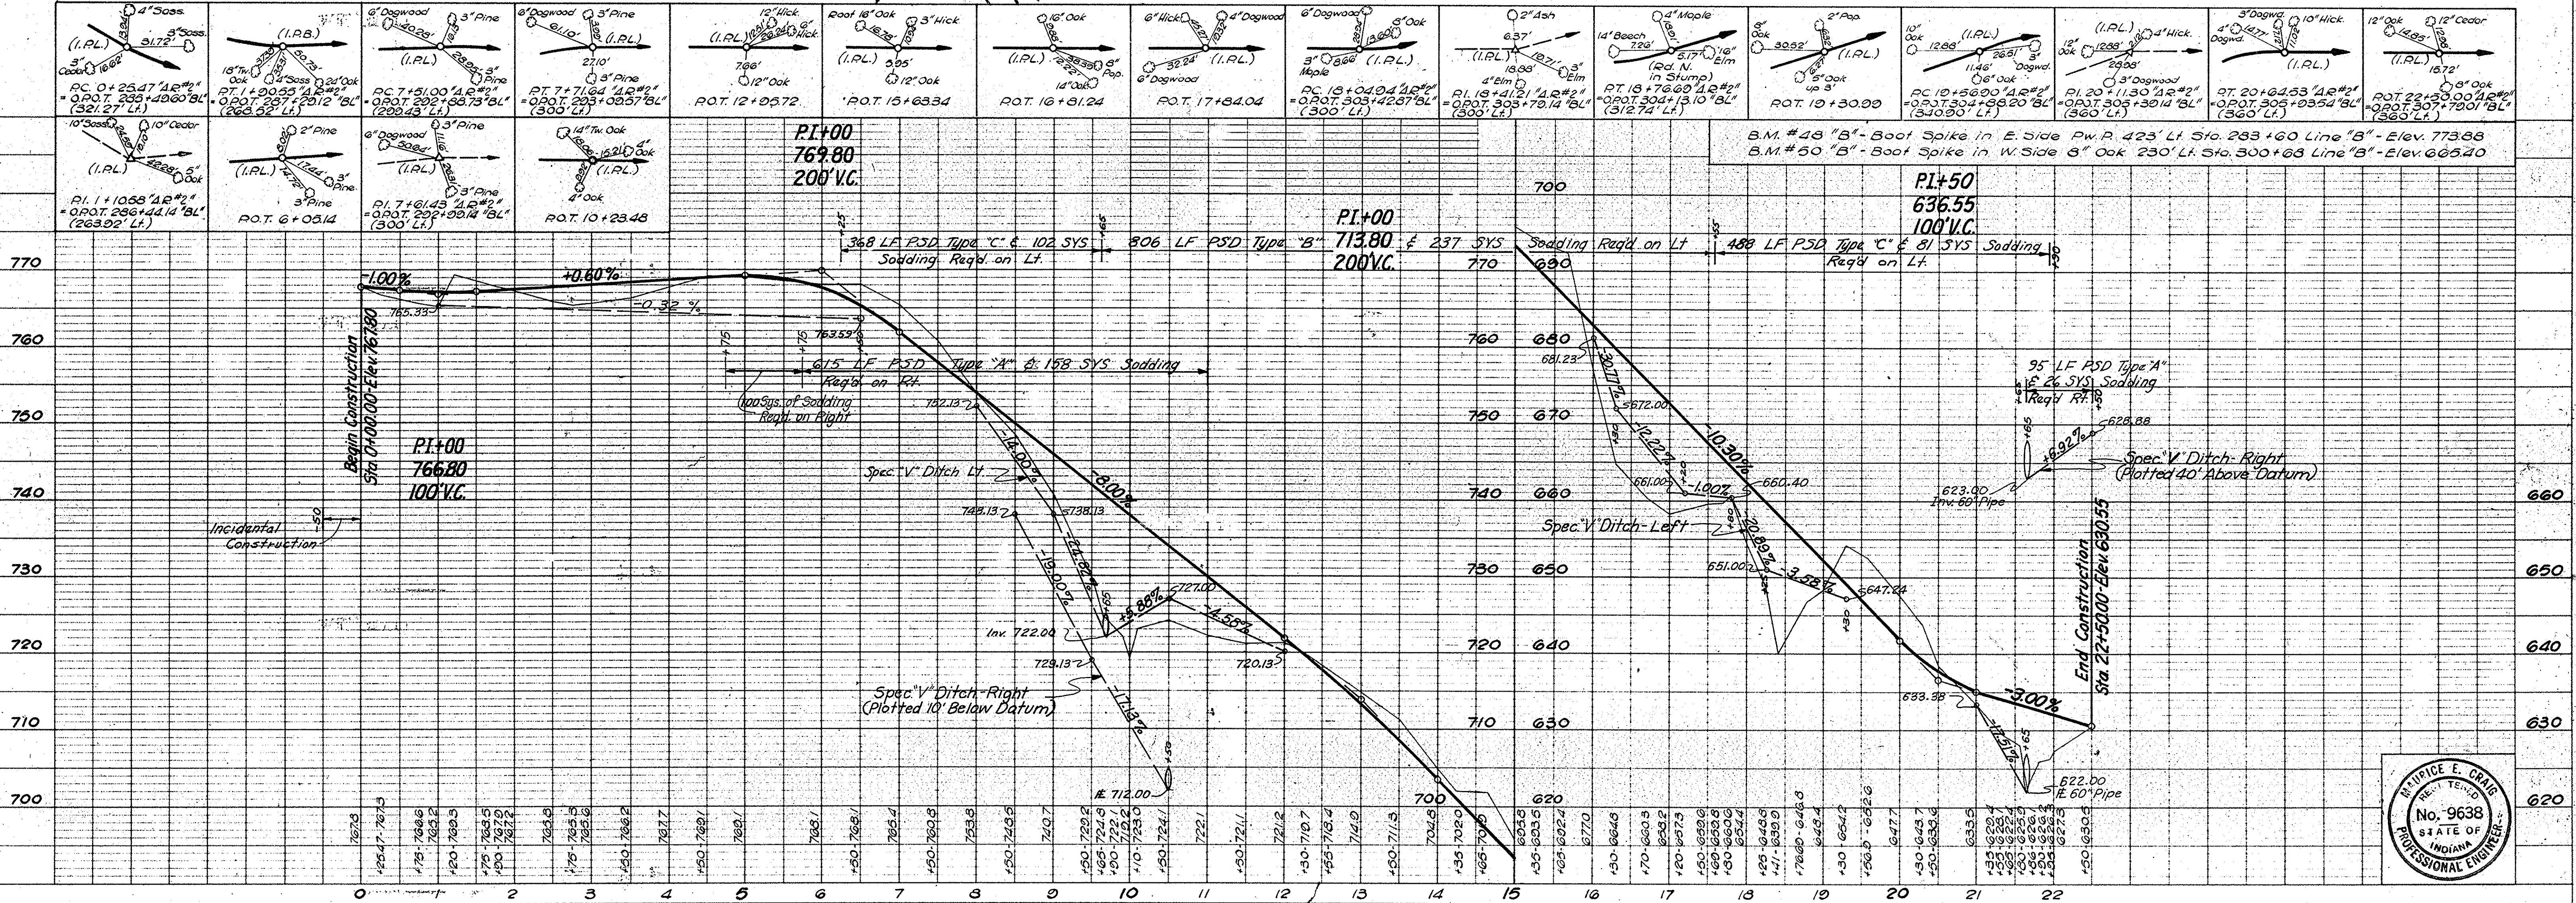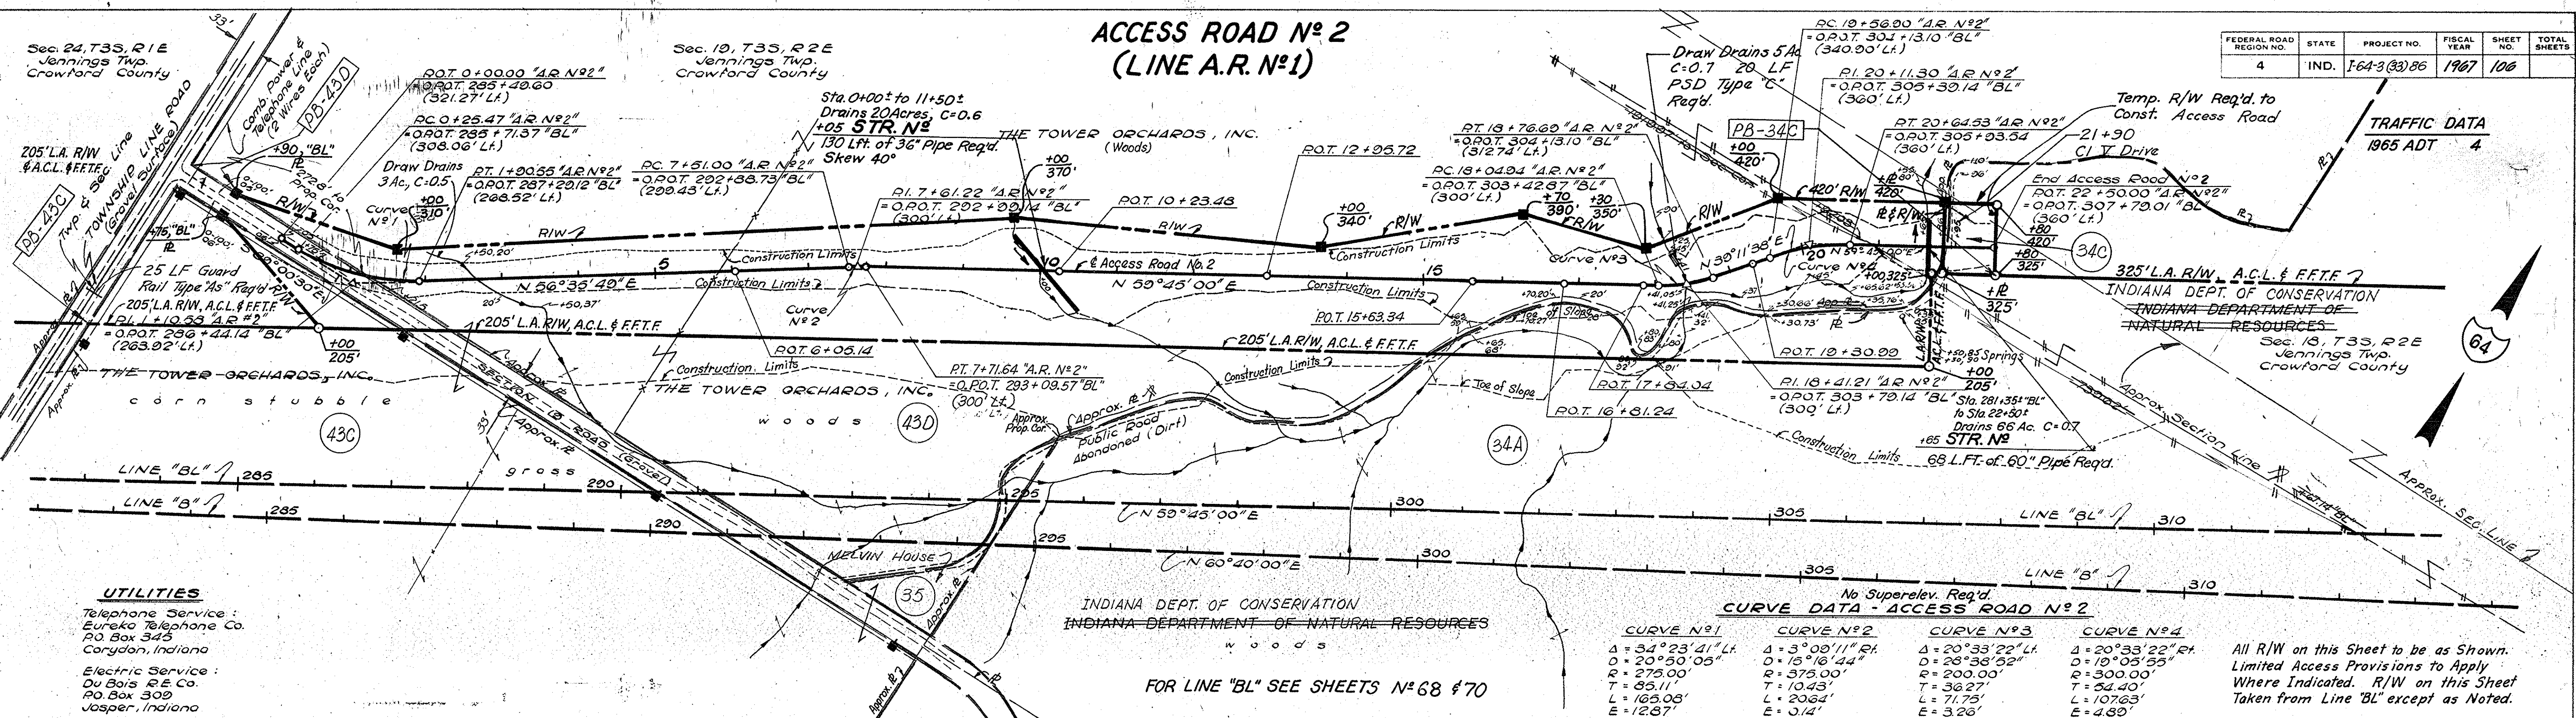

DATE: 4-66
 BY: T.S. M.C.
 CHECKED: M.E.C.
 NO. 154-9-1
 STRUCTURE INDICATOR CHECKED: F.E.C.

DATE: 4-66
 BY: T.S. M.C.
 CHECKED: M.E.C.
 NO. 154-9-1
 STRUCTURE INDICATOR CHECKED: F.E.C.

PROJECT NO.	LINE NO.	SHEET NO.	TOTAL SHEETS	FILE
1-64-3 (83) 86	A.R. #2	106		

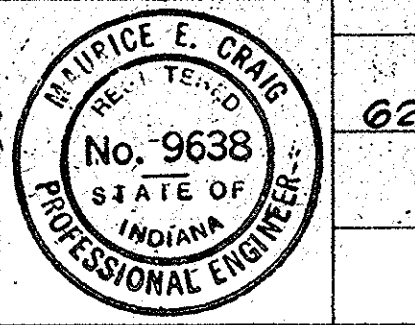


FEDERAL ROAD REGION NO.	STATE	PROJECT NO.	FISCAL YEAR	SHEET NO.	TOTAL SHEETS
4	IND.	1-64-3(33)85	1967	107	

TRAFFIC DATA
 Access Road No 3

Year	A.D.T.
1965	17
1975	24
1985	33
1985	D.H.V. 2

**ACCESS ROAD No 3
 (LINE A.R. No 2)**


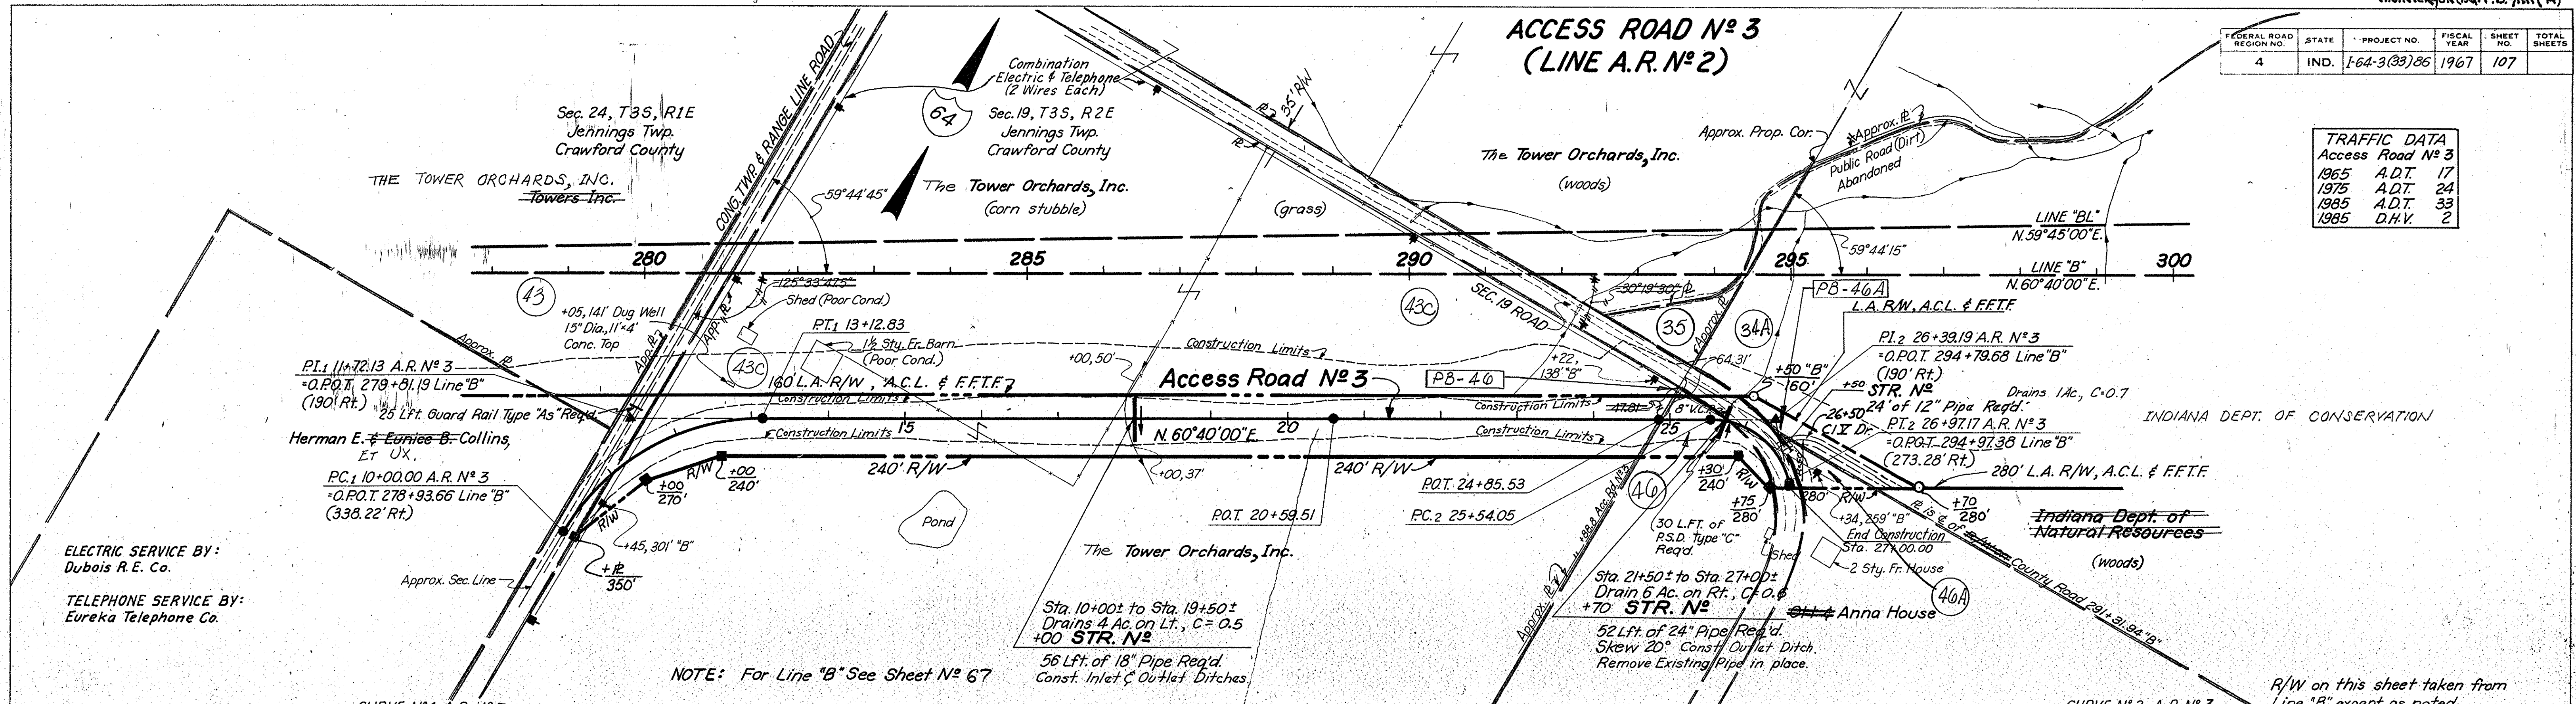


PLAN
 DATE: 3-66
 BY: T.S.H.C.
 CHECKED: D.D.C.
 APPROVED: G.E.C.
 NO. 938-PL
 NOTE: BOOK, ADJUSTMENT CHECKED. NO. 938-PL, 1-66


PROFILE
 DATE: 3-66
 BY: T.S.H.C.
 CHECKED: D.D.C.
 APPROVED: G.E.C.
 NO. 938-PL
 NOTE: BOOK, GRADES CHECKED. E.A. NOTED. NO. 938-PL, 1-66

CURVE No 1 A.R. No 3
 $\Delta = 59^{\circ}26'12.5''$ Rt.
 $D = 19^{\circ}00'00''$
 $R = 301.56'$
 $T = 172.13'$
 $L = 312.83'$
 $E = 45.67'$
 No Superelevation Req'd.

CURVE No 2 A.R. No 3
 $\Delta = 78^{\circ}00'00''$ Rt.
 $D = 54^{\circ}30'00''$
 $R = 105.13'$ No Superelev. Required
 $L = 143.12'$
 $E = 30.15'$

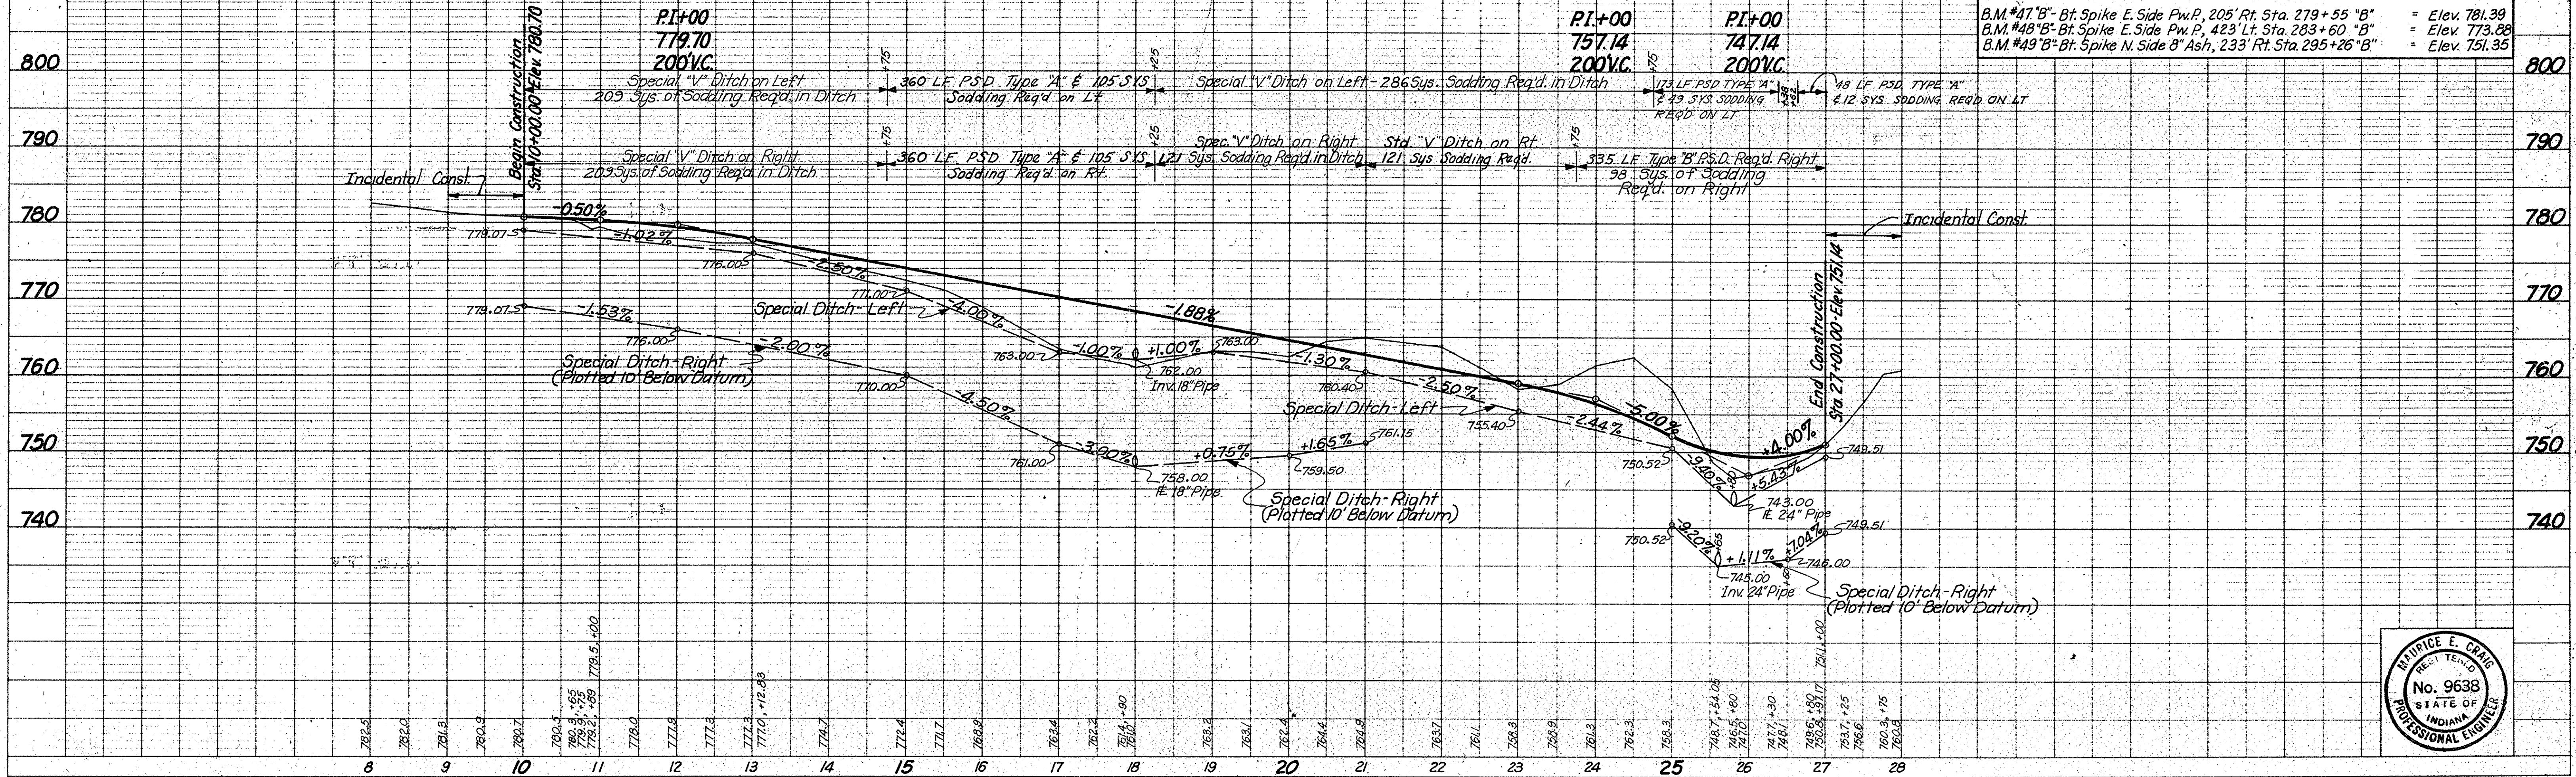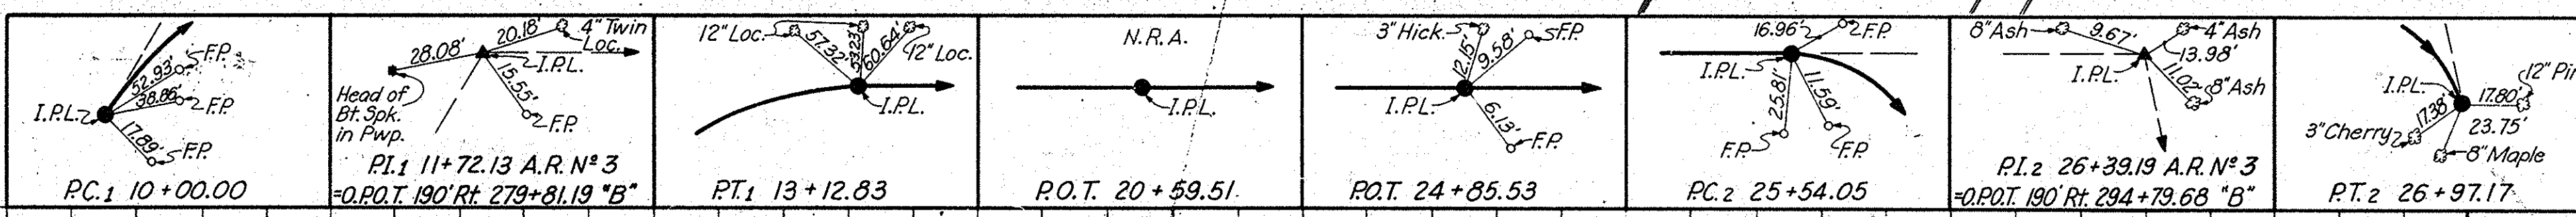

B.M. #47 B - Bt. Spike E. Side Pw.P., 205' Rt. Sta. 279+55 "B" = Elev. 781.39
 B.M. #48 B - Bt. Spike E. Side Pw.P., 423' Lt. Sta. 283+60 "B" = Elev. 773.88
 B.M. #49 B - Bt. Spike N. Side B' Ash, 233' Rt. Sta. 295+26 "B" = Elev. 751.35

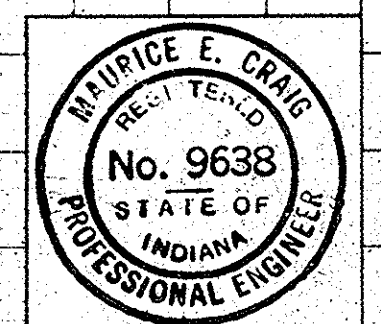


PROJECT NO.	LINE	SHEET NO.	TOTAL SHEETS	FILE
1-64-3(33)85	A.R. #3	107		

Access Road No 4
(Line A.R.-1-B)



REV. R/W LT. STA. 9 "A.R.#4" A.T. Wilcox 11/24/67				
FEDERAL ROAD REGION NO.	STATE	PROJECT NO.	FISCAL YEAR	TOTAL SHEETS
4	IND.	I-64-3(33)86	1967	108

TRAFFIC DATA
1975 ADT 2


PLAN
I.S.U.C.
M.E.C.
P.D.G.
S.E.C.
NOTE BOOK ALIGNMENT CHECKED
No. 8914-1-11/1/66

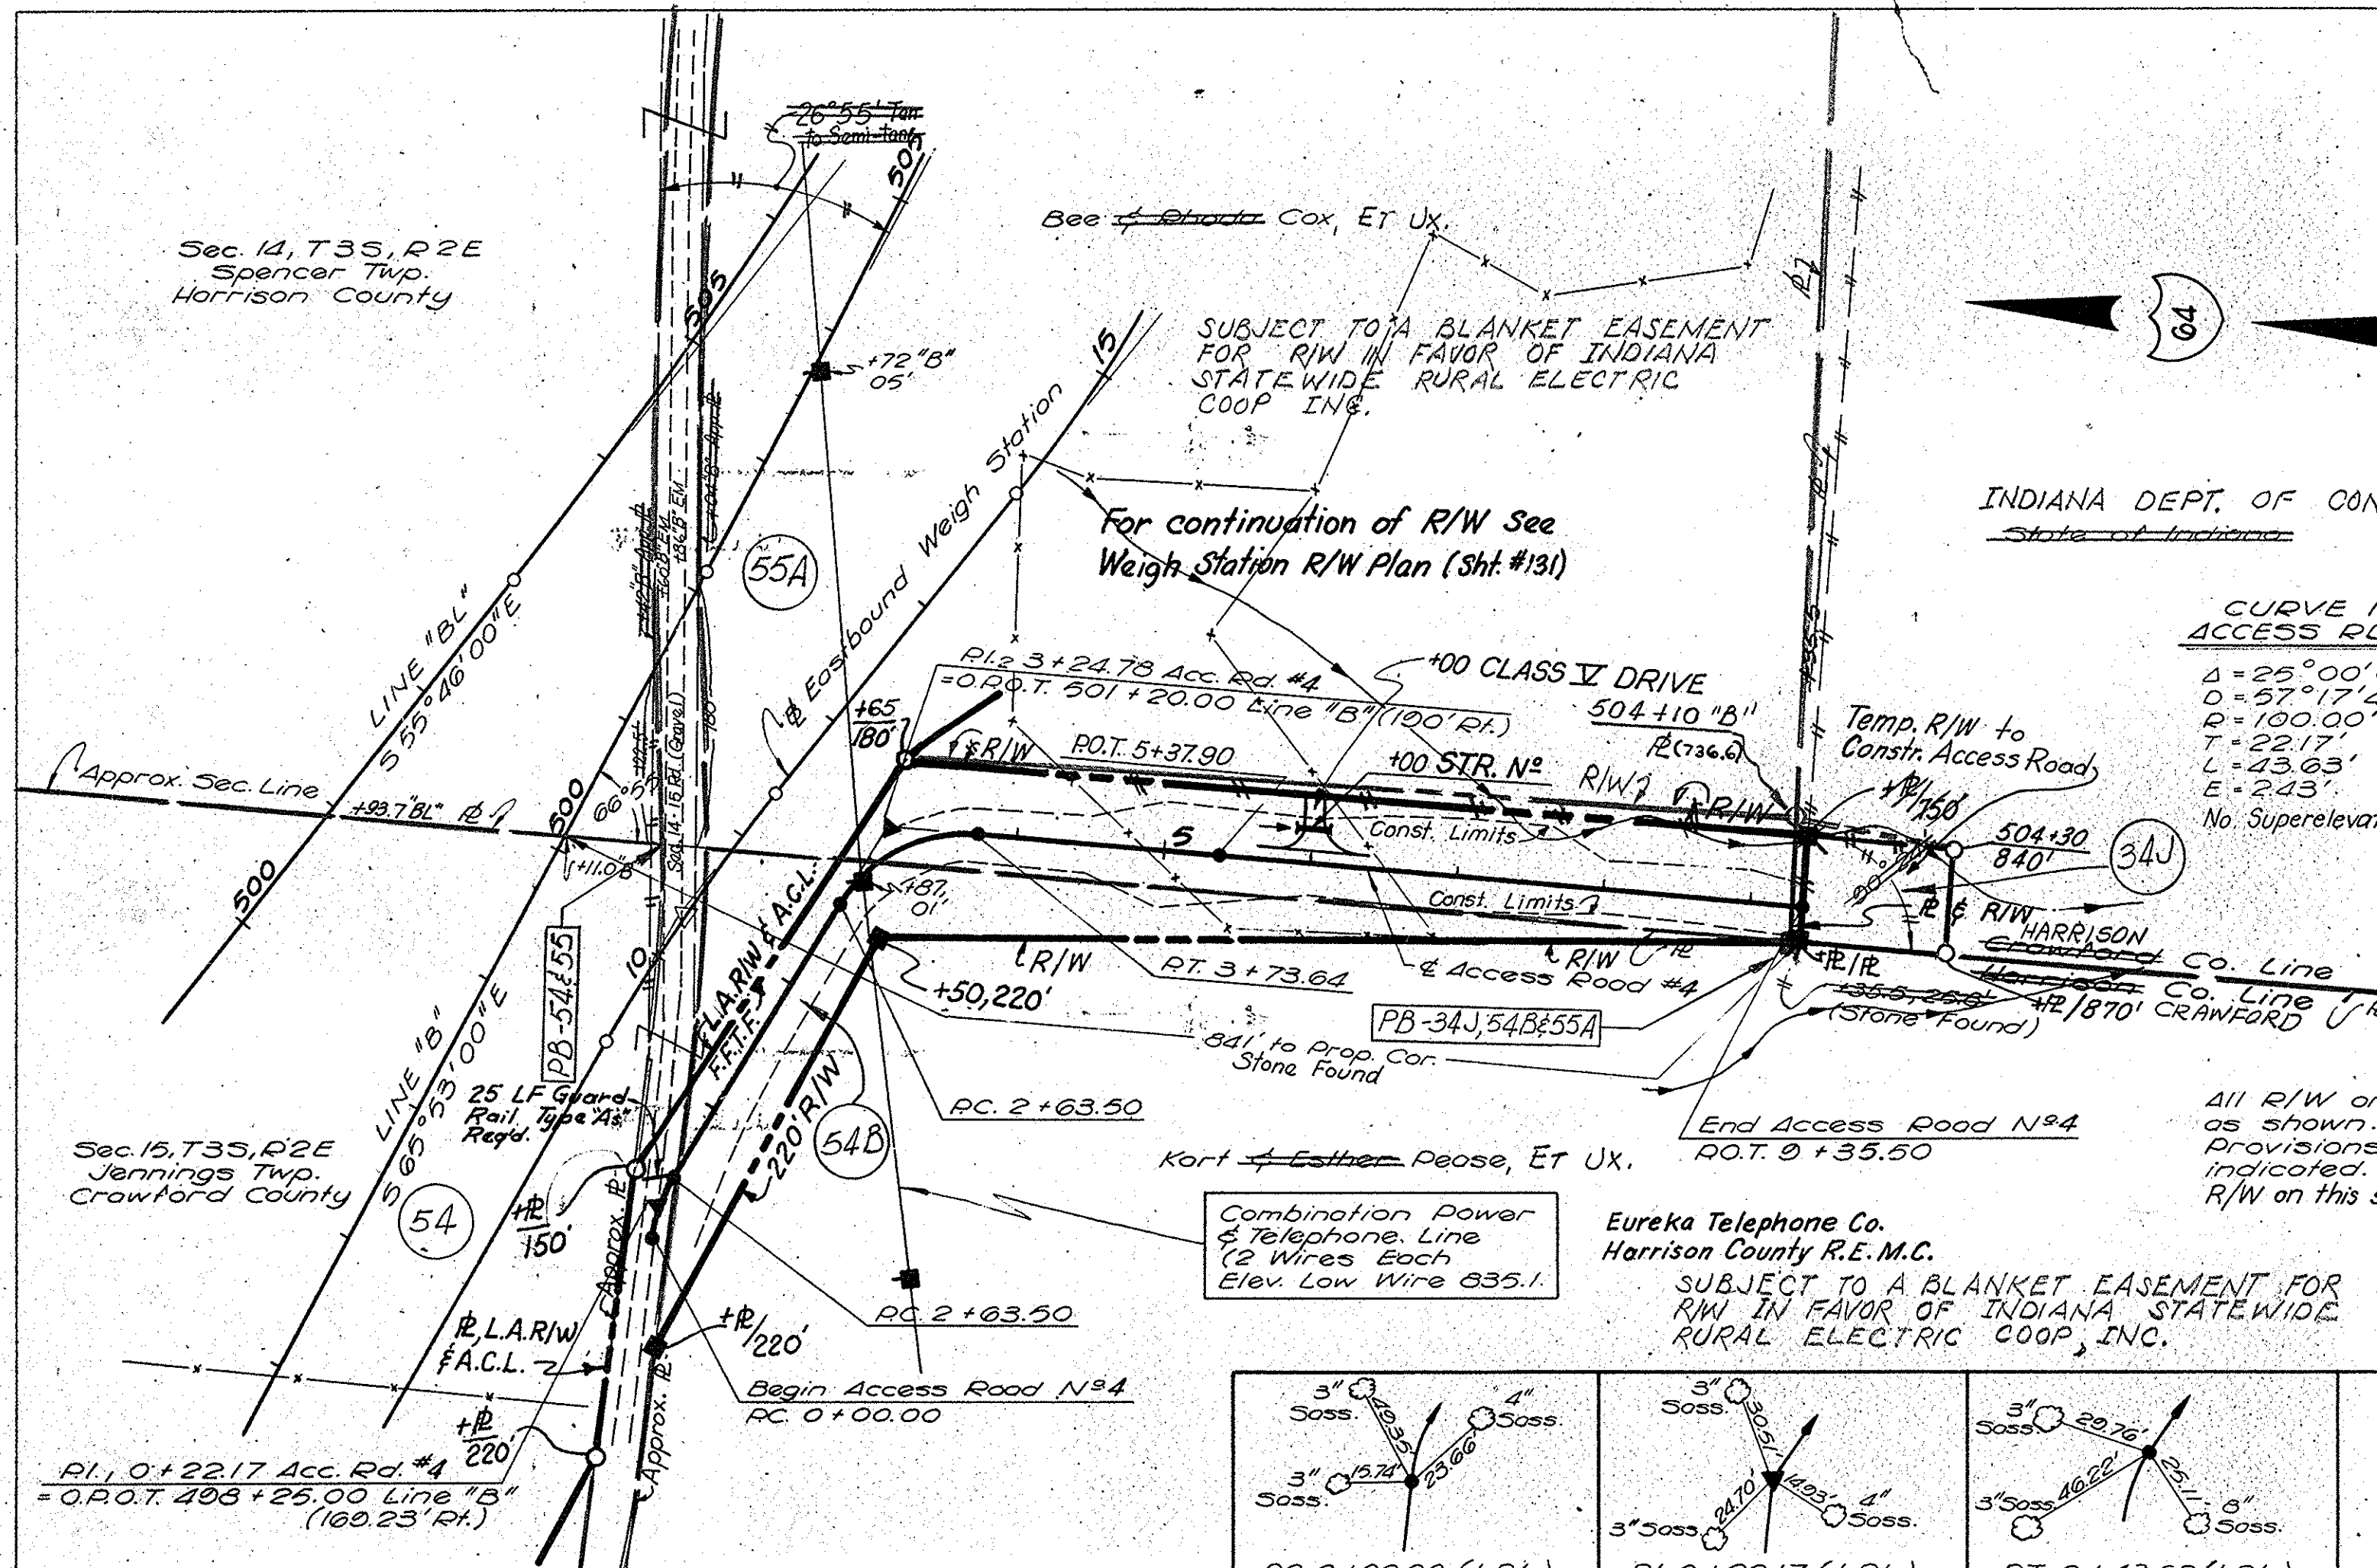

PROFILE
I.S.U.C.
M.E.C.
P.D.G.
S.E.C.
NOTE BOOK GRADE CHECKED
No. 8914-1-11/1/66

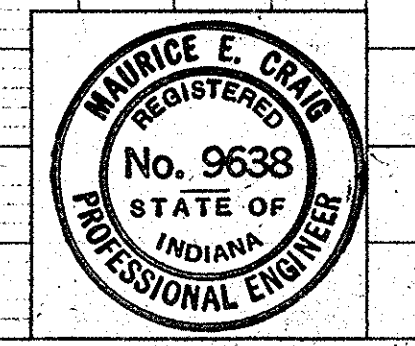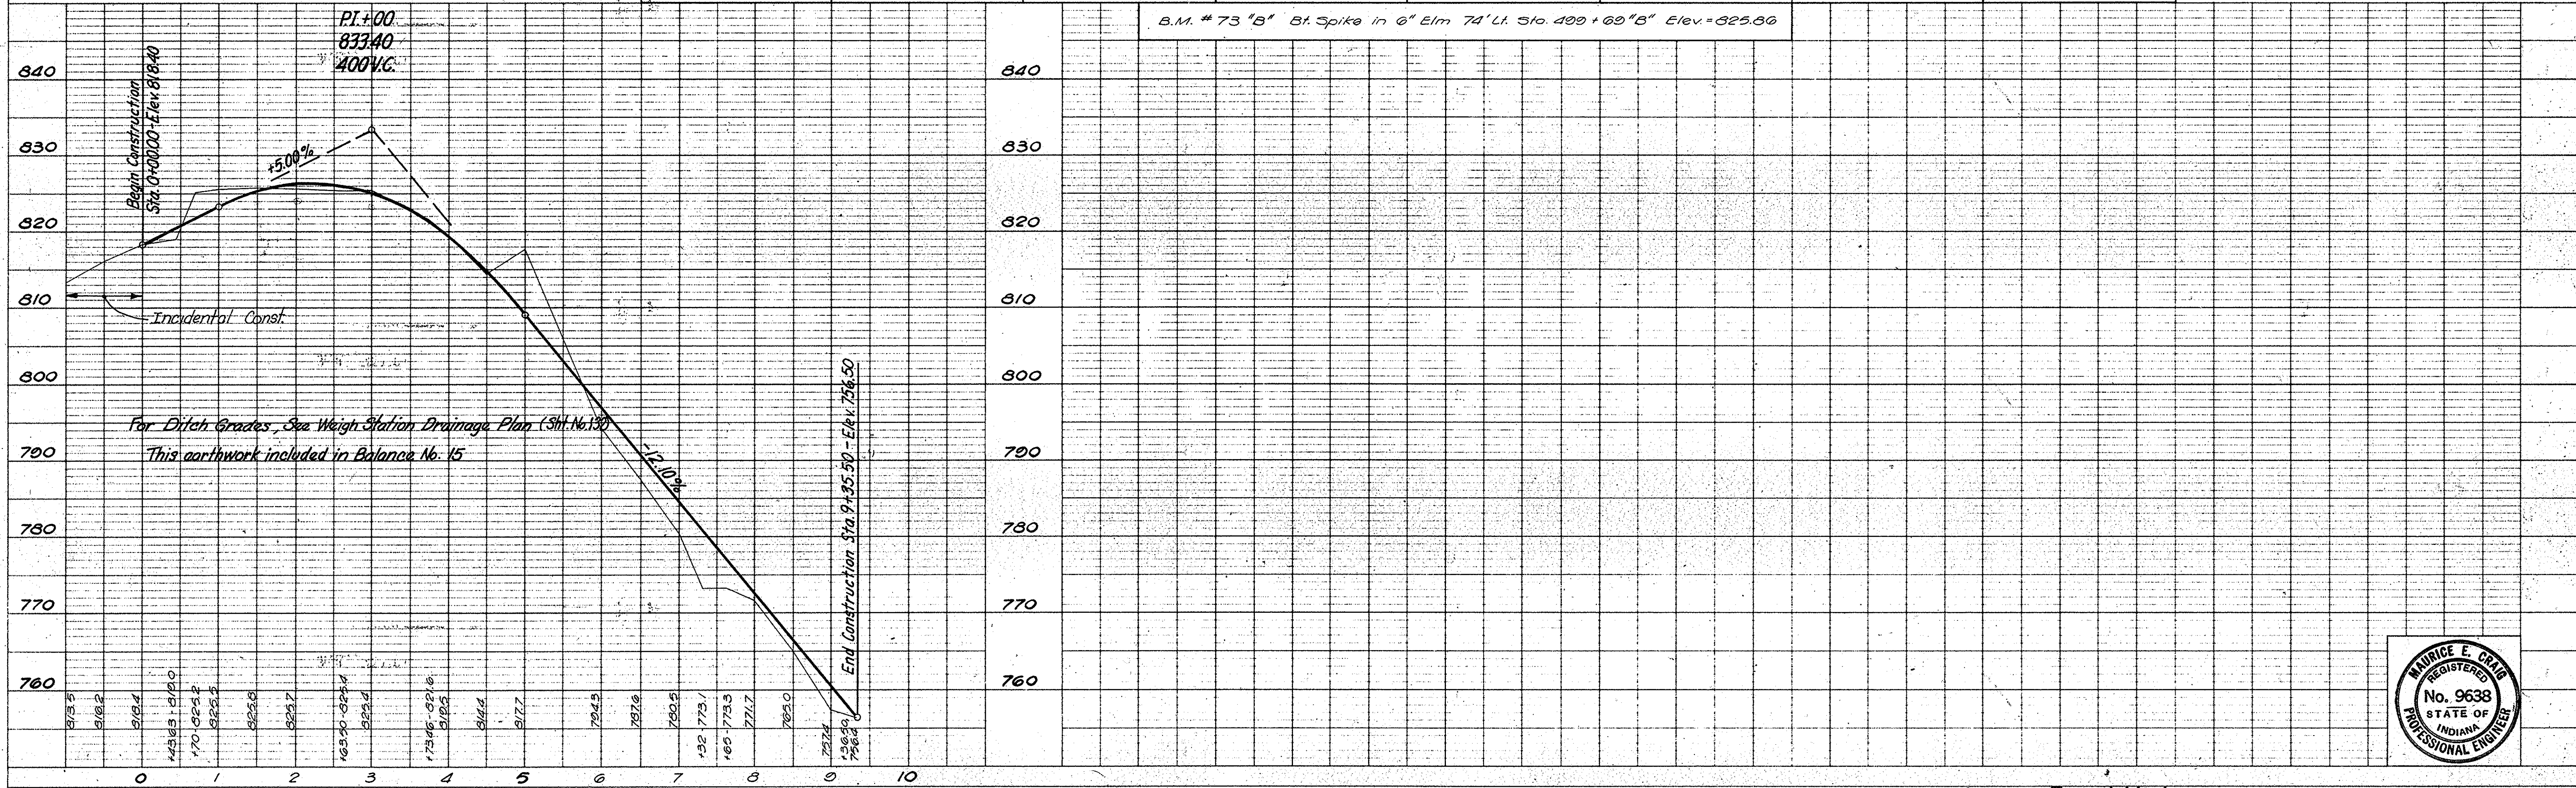


PROJECT NO.	LINE NO.	SHEET NO.	TOTAL SHEETS	FILE
I-64-3(33)86	A.R.#4	108		

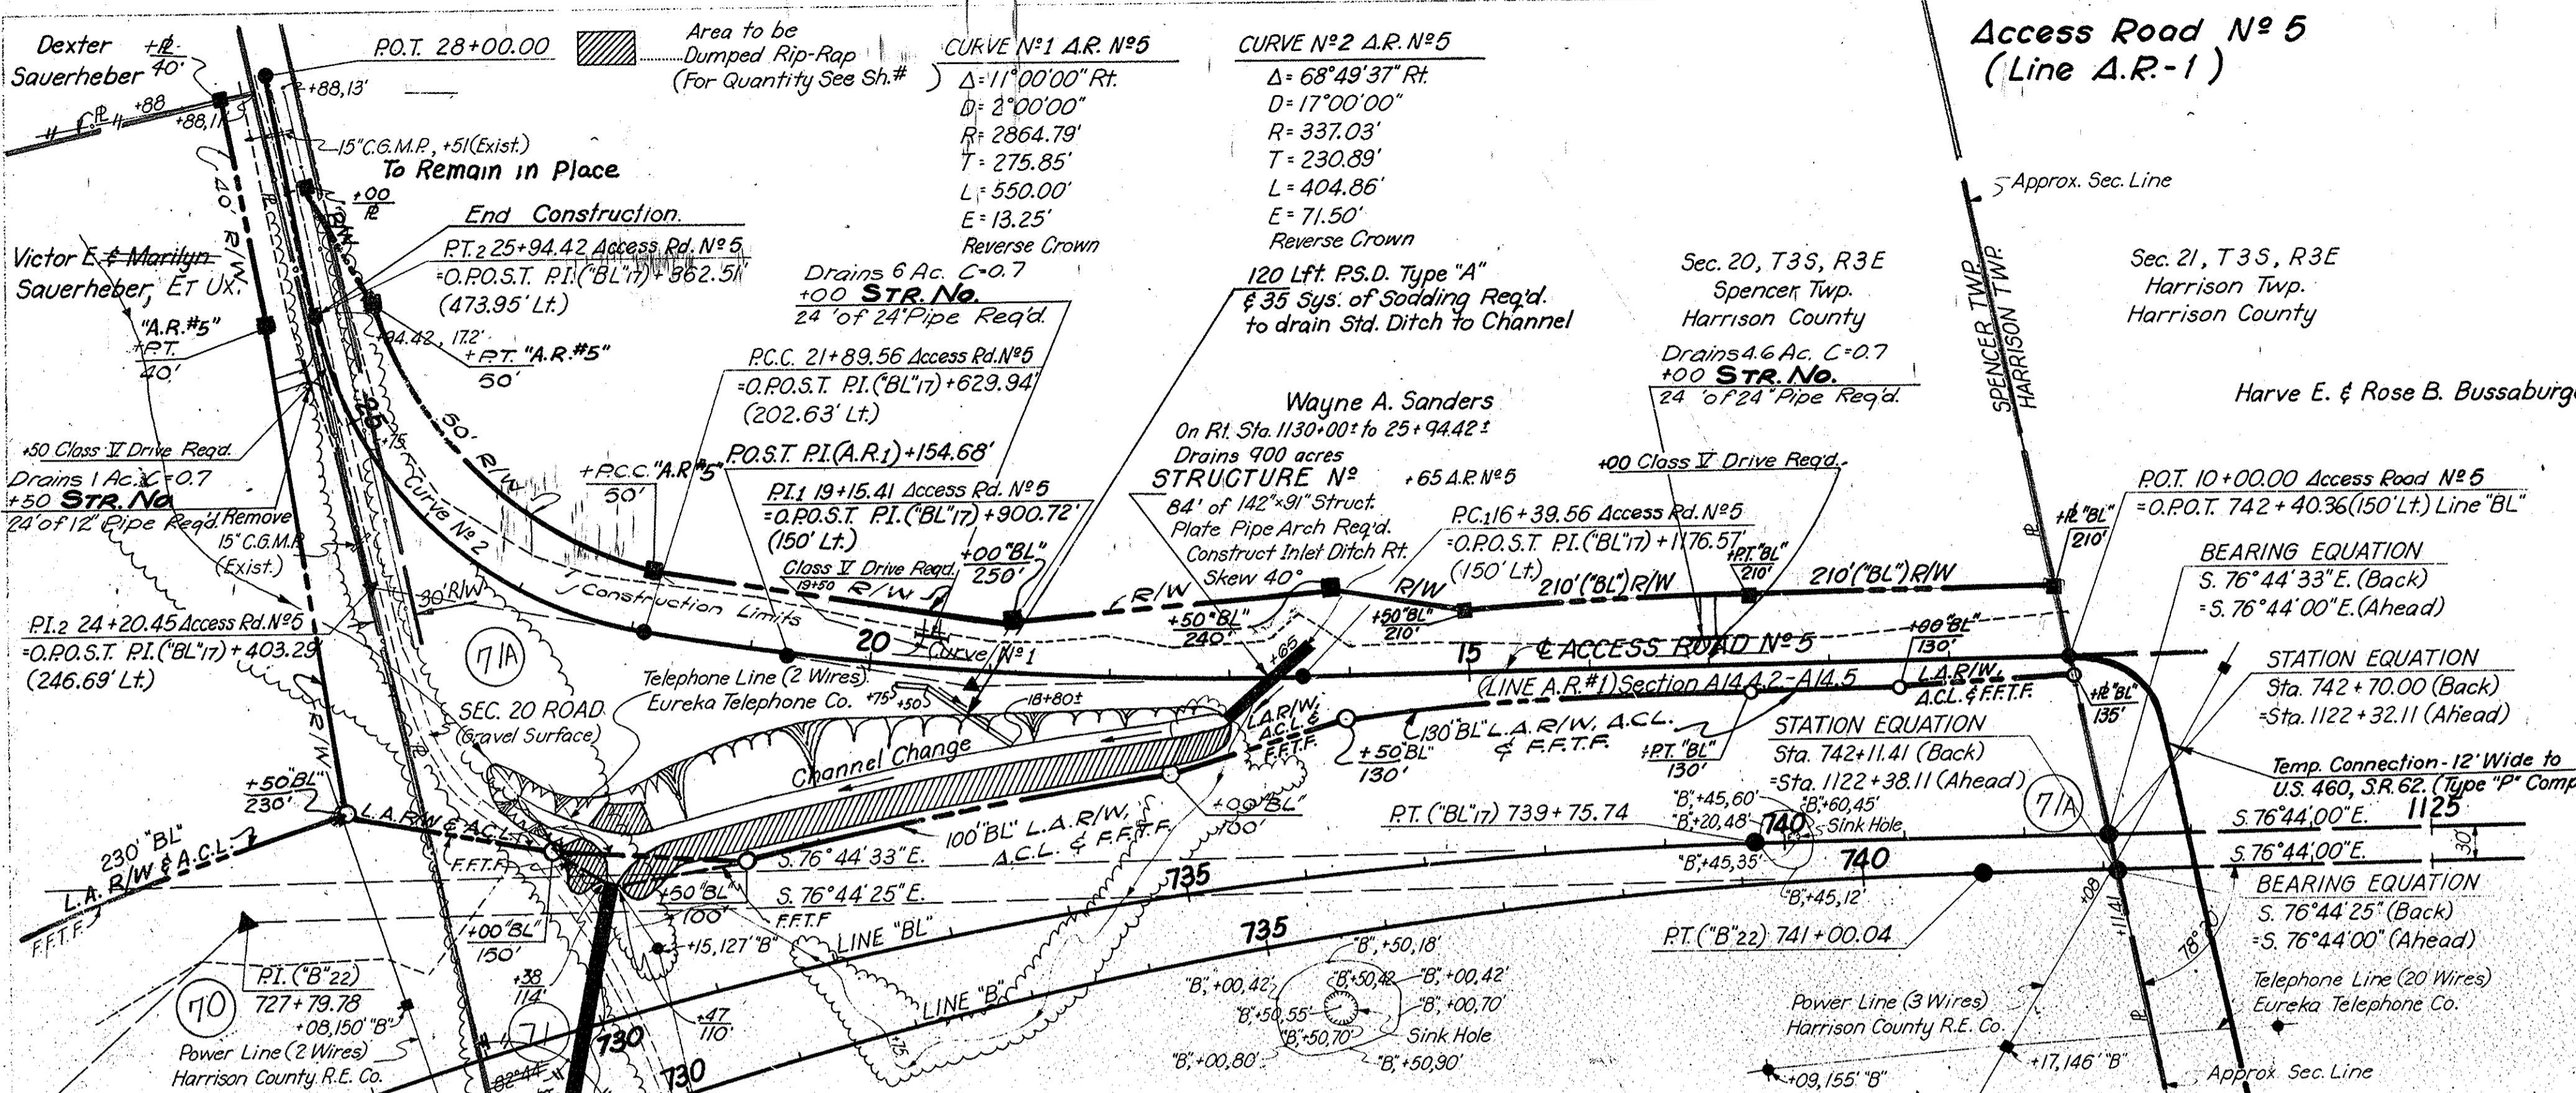



TRAFFIC DATA

1975 A.D.T.	33
1985 A.D.T.	45
1975 D.H.V.	3

PARCEL 71 ON PROJECT I-64-3(32) AND PARCEL 2 ON PROJECT I-64-3(32) COVER THE SAME LAND, WITH ACQUISITION THEREOF ENTIRELY UNDER SAID PROJECT I-64-3(32)

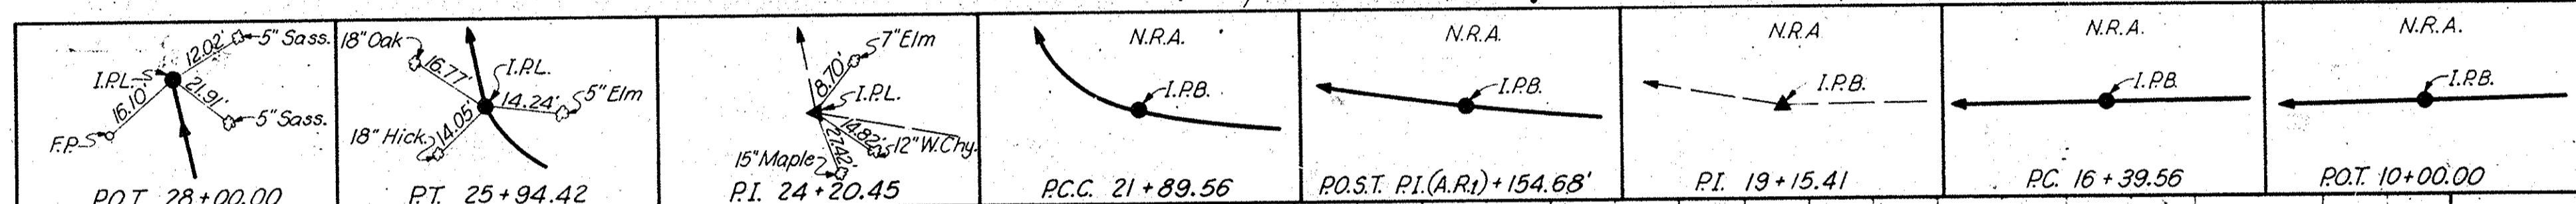

R/W on this sheet taken from Access Road No. 5 Line except as noted. All R/W on this sheet to be as shown. Limited Access Provisions to apply where indicated.

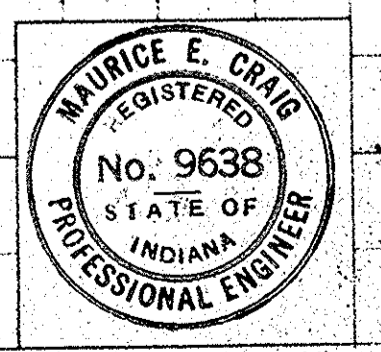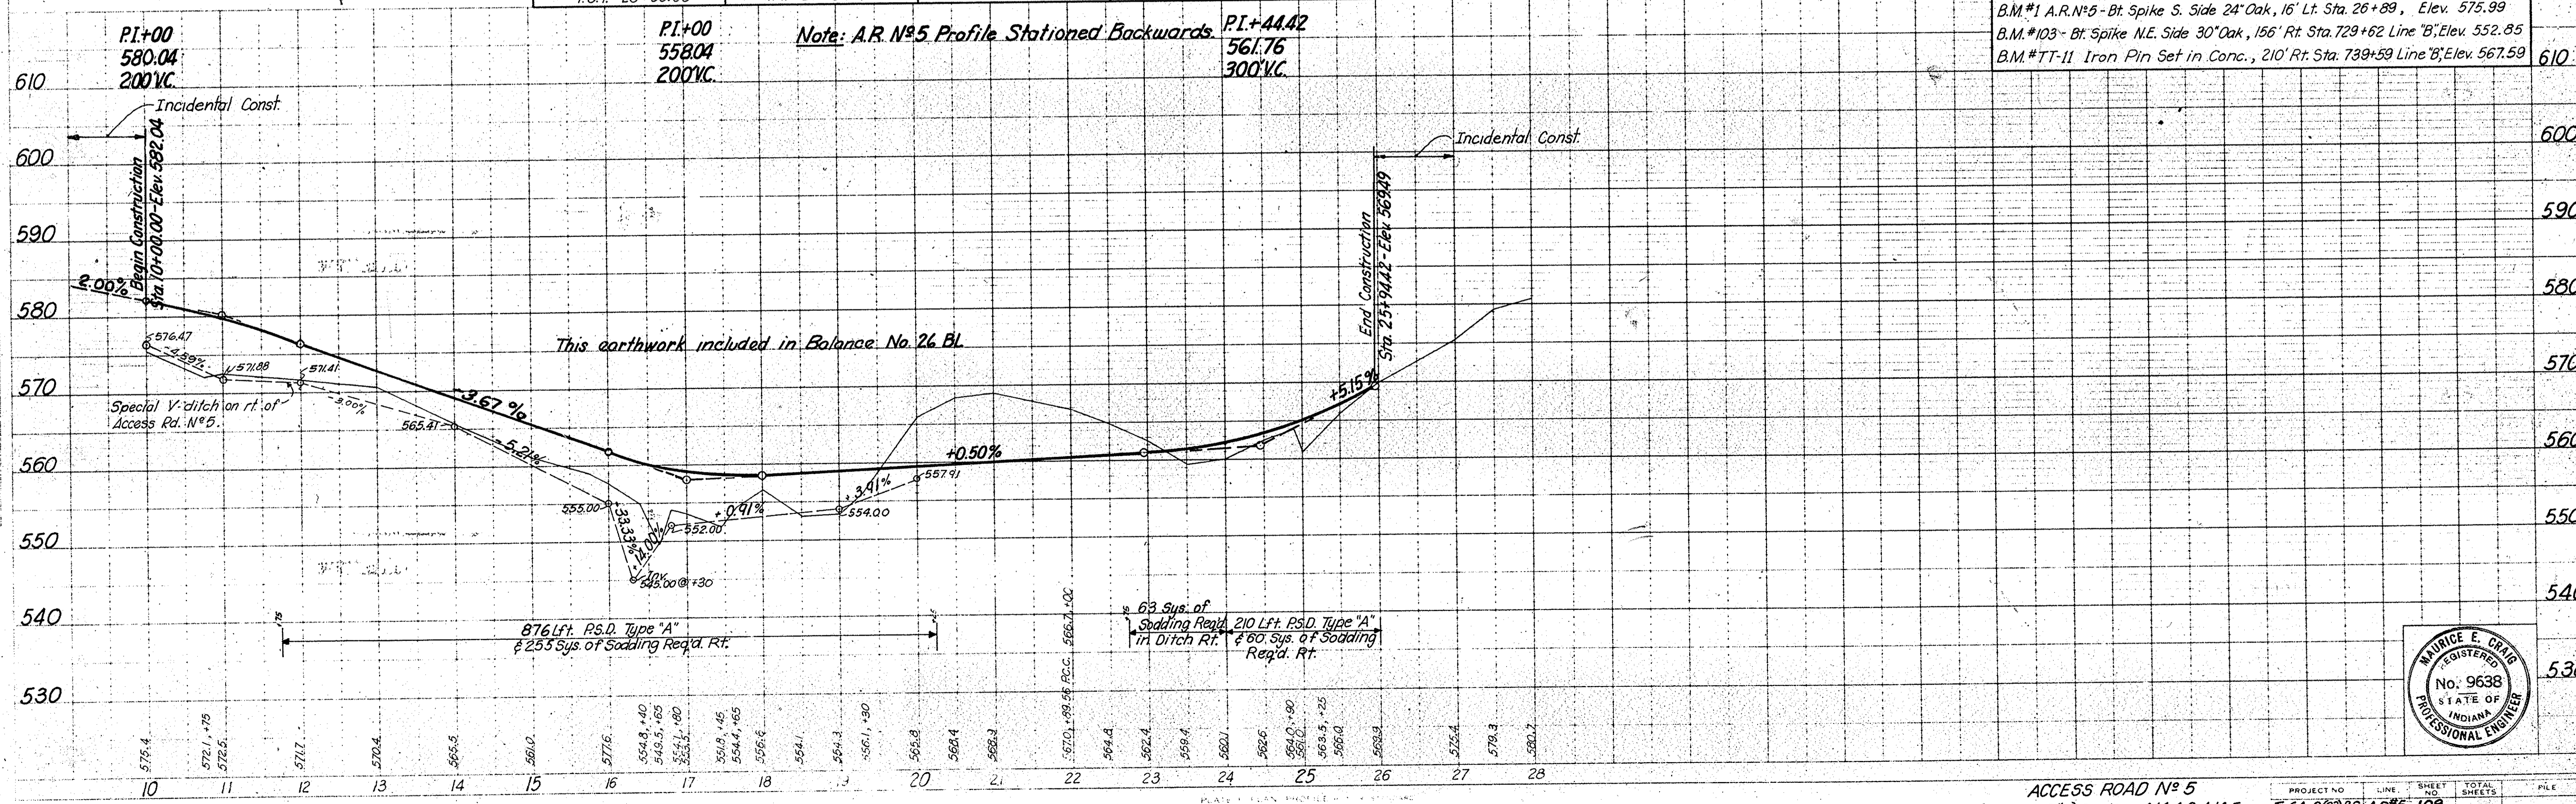

November 6, 1961


FEDERAL ROAD DISTRICT NO.	STATE	PROJECT NO.	FISCAL YEAR	SHEET NO.	TOTAL SHEETS
4	IND.	I-64-3(33)86	1967	110	

N. W. RAMP

See Sheet # Line "S-SR37-A" (I.R.L.) P.O.T. 0+00.00 P.O.T. 24+74.91 N.E.R. P.O.T. 46+00.00 S-SR37-A P.C.C. 13+29.41	Top 12" Stump 12" Maple (I.R.P.) P.C. 1+28.00	4" Oak (I.R.L.) P.T. 4+81.12	18" Hickory (I.R.L.) P.C. 6+95.28	4" Oak (I.R.L.) P.I. 10+20.69	20" Oak (I.R.L.) P.O.S.T. (P.I. +185.15)
4" Hickory Up 4" P.C.C. 13+29.41	12" Hickory (I.R.L.) P.T. 14+04.03	15" Oak (I.R.L.) P.C.C. 14+79.41	6" Oak (I.R.L.) P.O.S.T. 18+10.39	4" Oak (I.R.L.) P.I. 19+30.00	12" Twin Oak (I.R.L.) P.O.S.T. (P.I. +189.22)

APPROACH

	A	B	C	D
1965 ADT	8115	813	2098	7972
1975 ADT	12497	1139	2839	12293
1985 ADT	16769	1465	3780	16504
1975 D.V.H.	1692	165	411	1666
% COMM. D.V.H.	10	8	10	10
% COMM. ADT	20	18	21	20

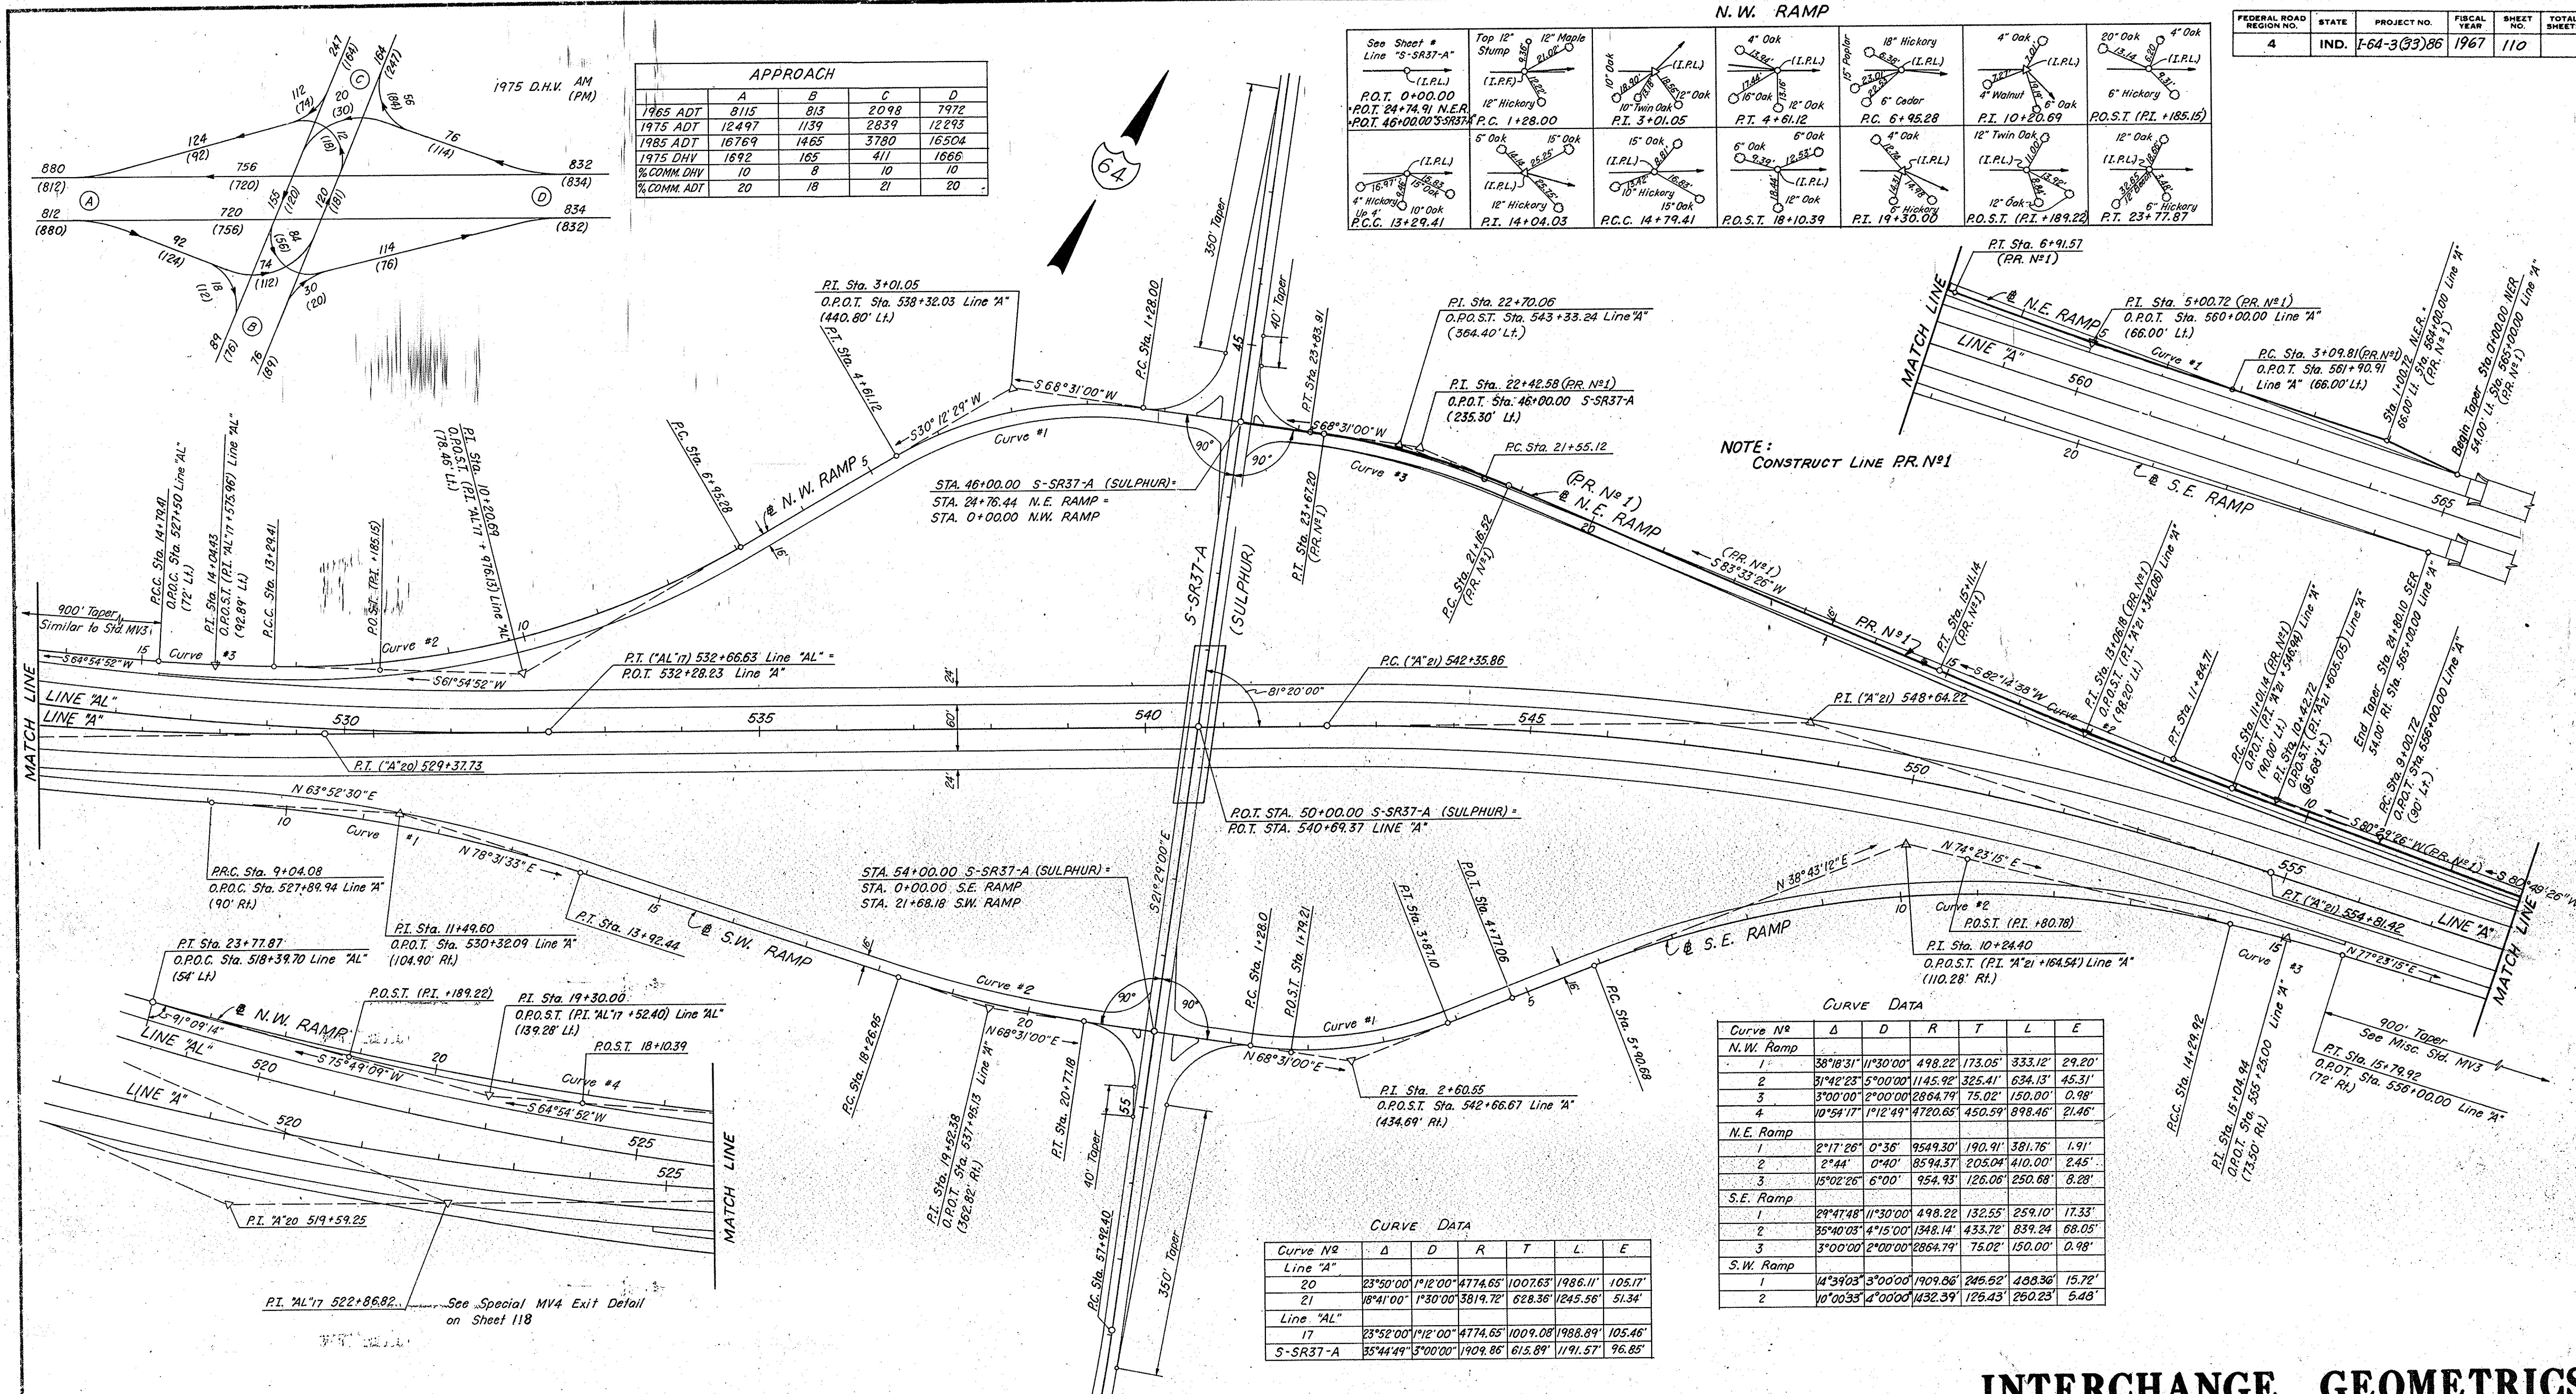

NOTE:
CONSTRUCT LINE RR. N°1

CURVE DATA

Curve No	Δ	D	R	T	L	E
N.W. Ramp						
1	38°18'31"	11°30'00"	498.22	173.05	333.12	29.20'
2	31°42'23"	5°00'00"	1145.92	325.41	634.13	45.31'
3	3°00'00"	2°00'00"	2864.79	75.02	150.00	0.98'
4	10°54'17"	1°12'49"	4720.65	450.59	898.46	21.46'
N.E. Ramp						
1	2°17'26"	0°36'	9549.30	190.91	381.76	1.91'
2	2°44'	0°40'	8594.37	205.04	410.00	2.45'
3	15°02'26"	6°00'	954.93	126.06	250.68	8.28'
S.E. Ramp						
1	29°47'48"	11°30'00"	498.22	132.55	259.10	17.33'
2	35°40'03"	4°15'00"	1348.14	433.72	839.24	68.05'
3	3°00'00"	2°00'00"	2864.79	75.02	150.00	0.98'
S.W. Ramp						
1	14°39'03"	3°00'00"	1909.86	245.52	488.36	15.72'
2	10°00'35"	4°00'00"	1432.39	126.43	250.23	5.48'

CURVE DATA

Curve No	Δ	D	R	T	L	E
Line "A"						
20	23°50'00"	1°12'00"	4774.65	1007.63	1986.11	105.17'
21	18°41'00"	1°30'00"	3819.72	628.38	1245.56	51.34'
Line "AL"						
17	23°52'00"	1°12'00"	4774.65	1009.08	1988.89	105.46'
5-SR37-A	35°44'49"	3°00'00"	1909.86	615.89	1191.57	96.85'

5 Elm 12" Sycamore (I.R.L.) P.T. 13+92.44	6 Thorn 8 Walnut (I.R.L.) P.C. 18+26.95	3 Maple Stump (I.R.L.) P.I. 19+52.38	4 Beech Stump (I.R.L.) P.T. 20+77.18	15" Gum Top 10" Stump (I.R.L.) P.R.C. 9+04.08	10" Maple 6" Hickory (I.R.L.) P.O.T. 21+68.18 P.O.T. 54+00.00 S-SR37-A P.C. 5+90.68	See Sheet # Line "S-SR37-A" (I.R.L.) P.O.T. 0+00.00 P.O.T. 21+68.18 S.E.R. P.O.T. 54+00.00 S-SR37-A P.C. 1+28.00	4" Maple Up 5" (I.R.L.) P.C. 1+28.00	Top 24" Stump 3" Ash Up 5" (I.R.L.) P.O.S.T. (P.I. +80.78)	6" Elm Up 5" (I.R.L.) P.I. 2+60.55	15" Oak Up 5" (I.R.L.) P.T. 3+87.10	6" Sassafras Up 4" (I.R.L.) P.O.T. 4+77.06
--	--	---	---	--	--	--	---	--	---	--	---

PLAN SHEET REFERENCES


DESIGNATION	SHEET NO
Line "A" Plan & Profile	42 & 44
Line "AL" Plan & Profile	43
Line "S-SR37-A" Plan & Profile	95 & 96
INTERCHANGE S-SR37-A SHEETS	
DESIGNATION	SHEET NO
R/W	111
Drainage	112
Intersection Details	113
Ramp Grades	114 - 117
Special S.W. Ramp Exit	118
Superelev. Transitions S.R.37	121

INTERCHANGE GEOMETRICS

"I-64" at "S-SR37-A"

DETAILS

Scale: 1" = 100'

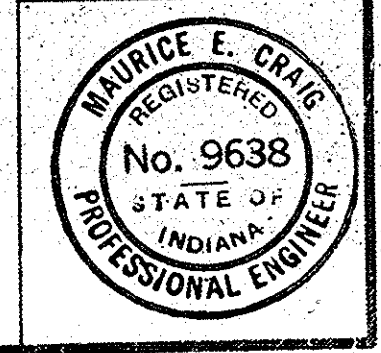

PROJECT NO.	LINE	SHEET NO.	TOTAL SHEETS	FILE
I-64-3(33)86	S-SR37-A	110		

November 6, 1961


FEDERAL ROAD REGION NO.	STATE	PROJECT NO.	FISCAL YEAR	SHEET NO.	TOTAL SHEETS
4	IND.	I-64-3 (33) 86	1967	111	

REV. 10-1-69 PARCEL 4 EXCESS LAND ELIMINATED. S.M. CLINE

PUBLIC UTILITY OWNERS

- ELECTRIC SERVICE BY: Dubois R.E.M.C., Inc.
- TELEPHONE SERVICE BY: Eureka Telephone Co.

All R/W on this sheet to be as shown. Limited Access Provisions to apply where indicated. R/W on this sheet taken from lines as indicated.

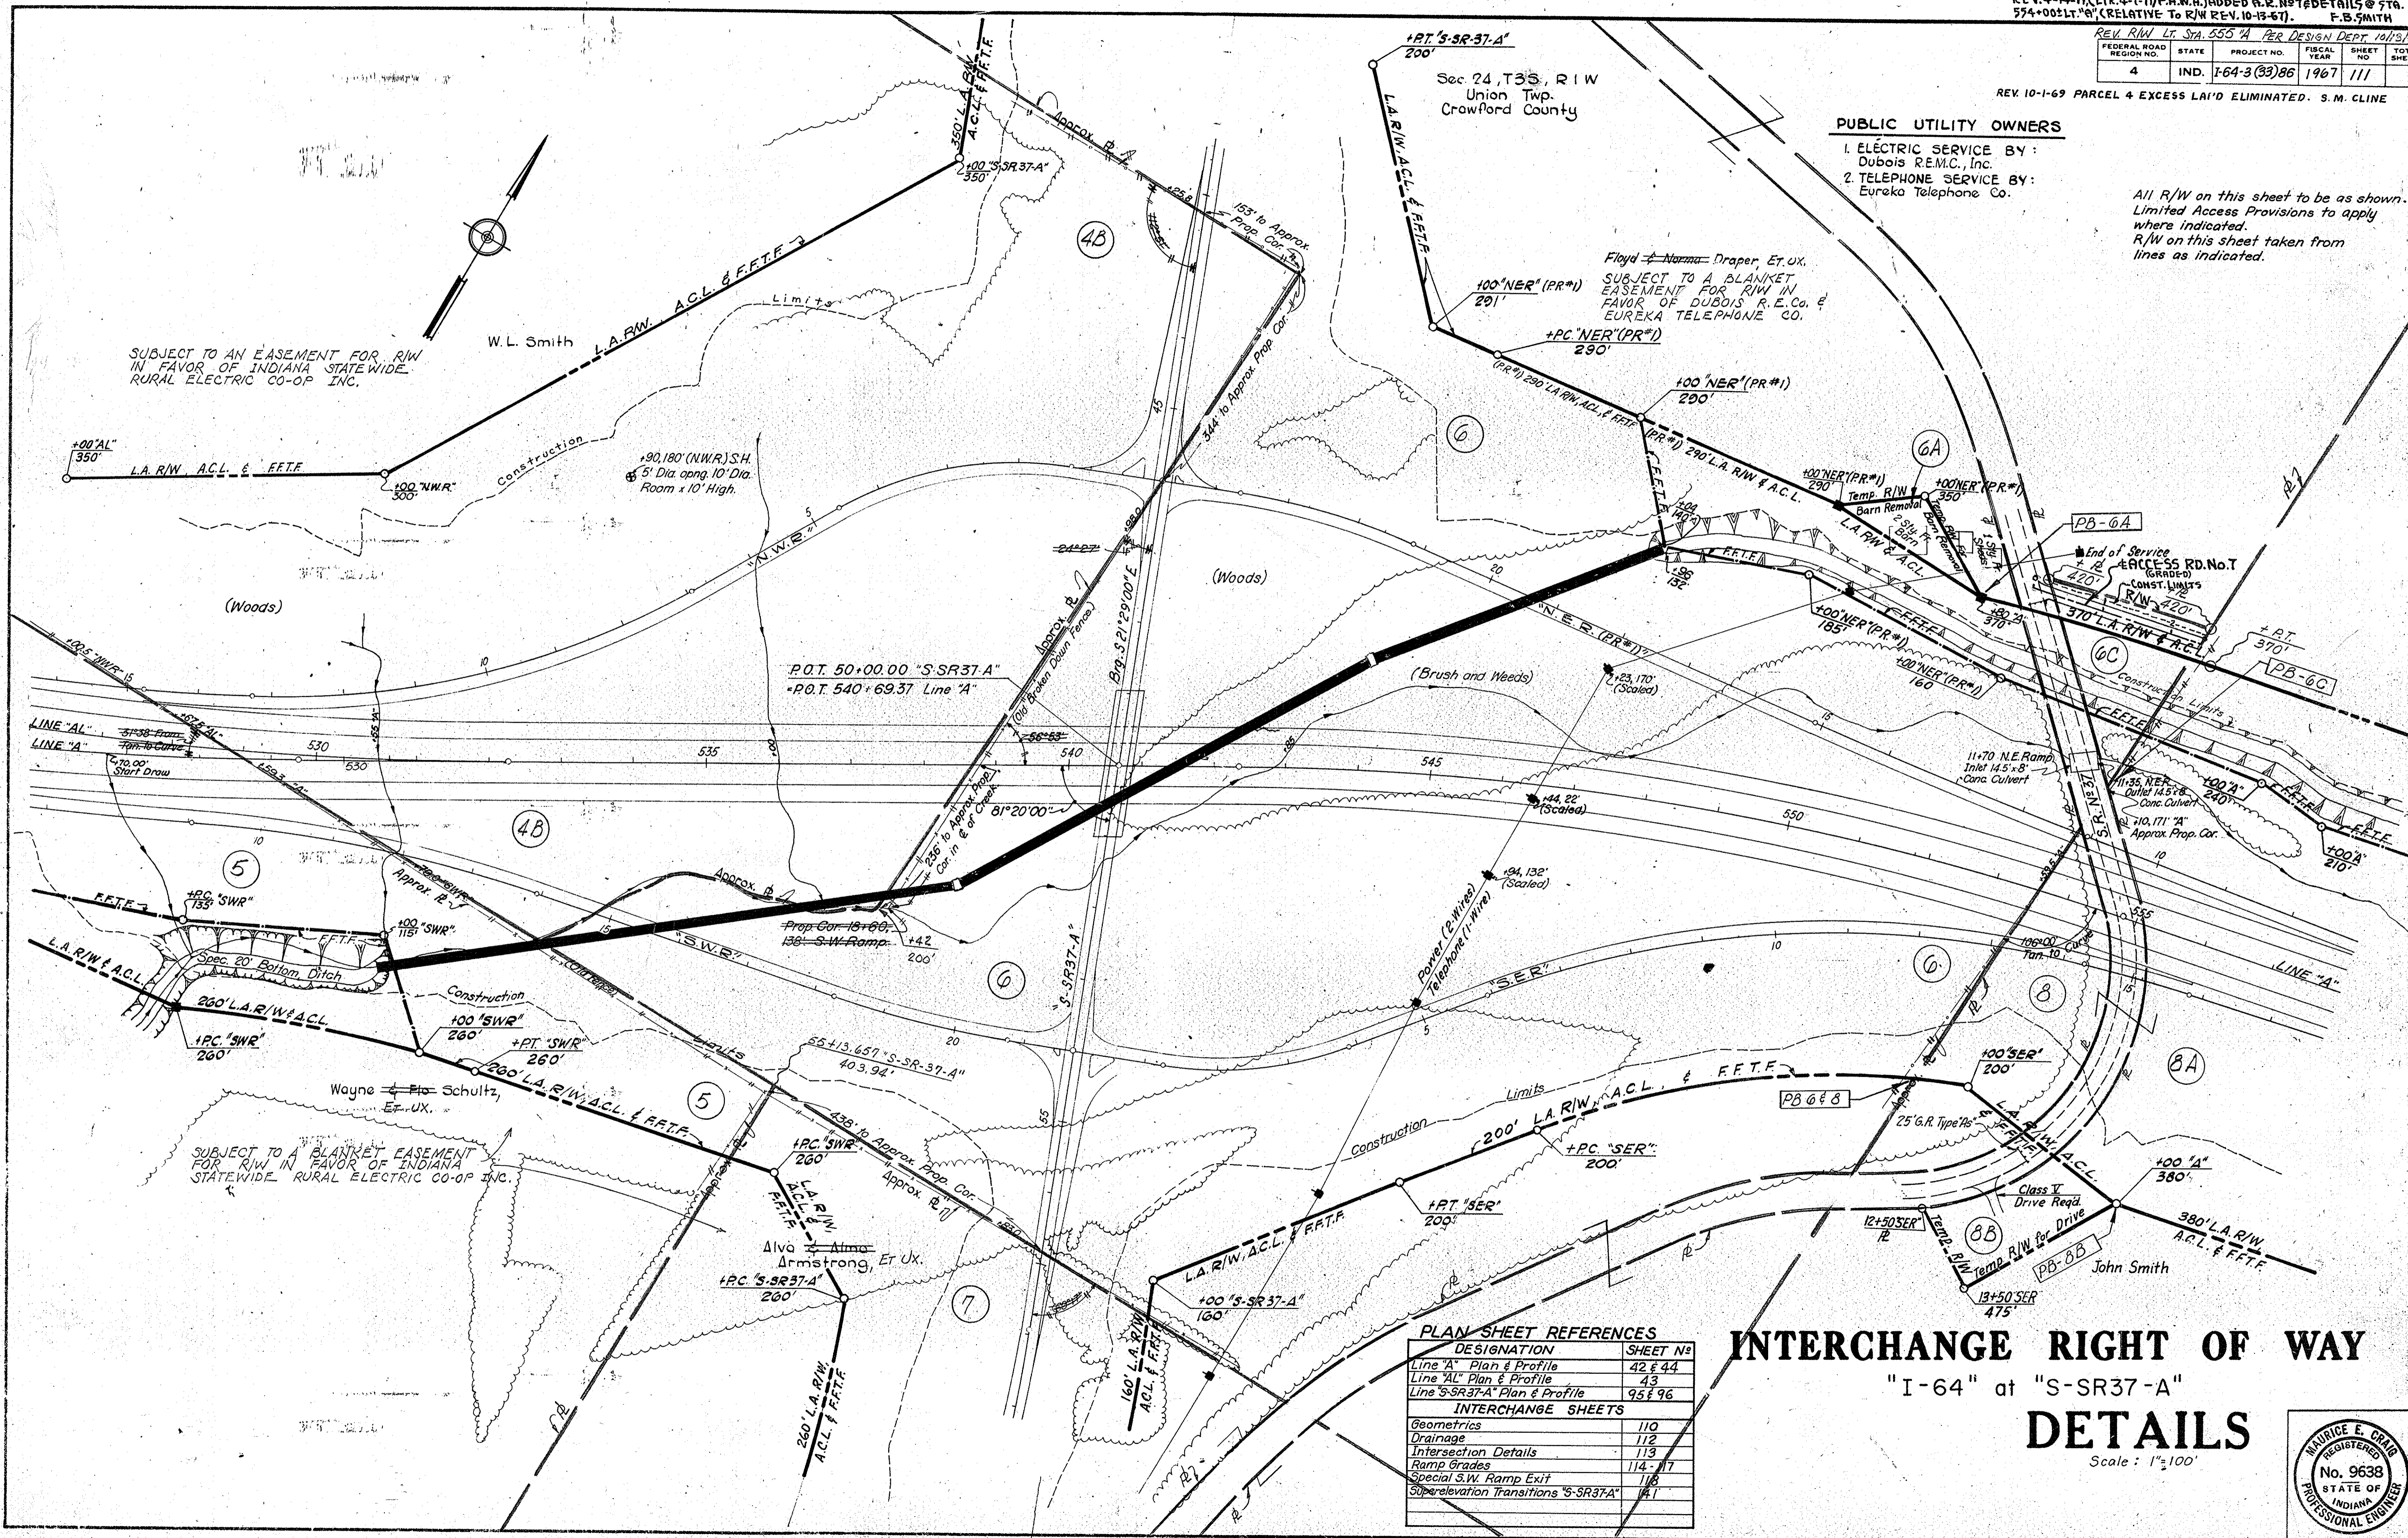

SUBJECT TO AN EASEMENT FOR R/W IN FAVOR OF INDIANA STATEWIDE RURAL ELECTRIC CO-OP INC.

SUBJECT TO A BLANKET EASEMENT FOR R/W IN FAVOR OF INDIANA STATEWIDE RURAL ELECTRIC CO-OP INC.


PLAN SHEET REFERENCES

DESIGNATION	SHEET No.
Line "A" Plan & Profile	42 & 44
Line "AL" Plan & Profile	43
Line "S-SR37-A" Plan & Profile	95 & 96

INTERCHANGE SHEETS	
Geometrics	110
Drainage	112
Intersection Details	113
Ramp Grades	114, 117
Special S.W. Ramp Exit	118
Superelevation Transitions "S-SR37-A"	111


**INTERCHANGE RIGHT OF WAY
"I-64" at "S-SR37-A"
DETAILS**

Scale: 1"=100'

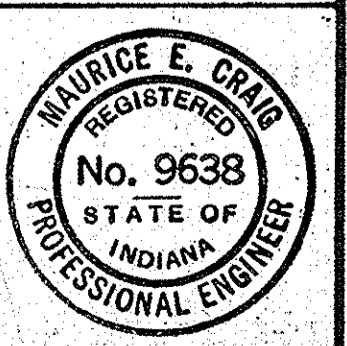

November 6, 1961

PROJECT NO.	LINE NO.	SHEET NO.	TOTAL SHEETS	FILE
I-64-3 (33) 86	S-SR37-A	111		

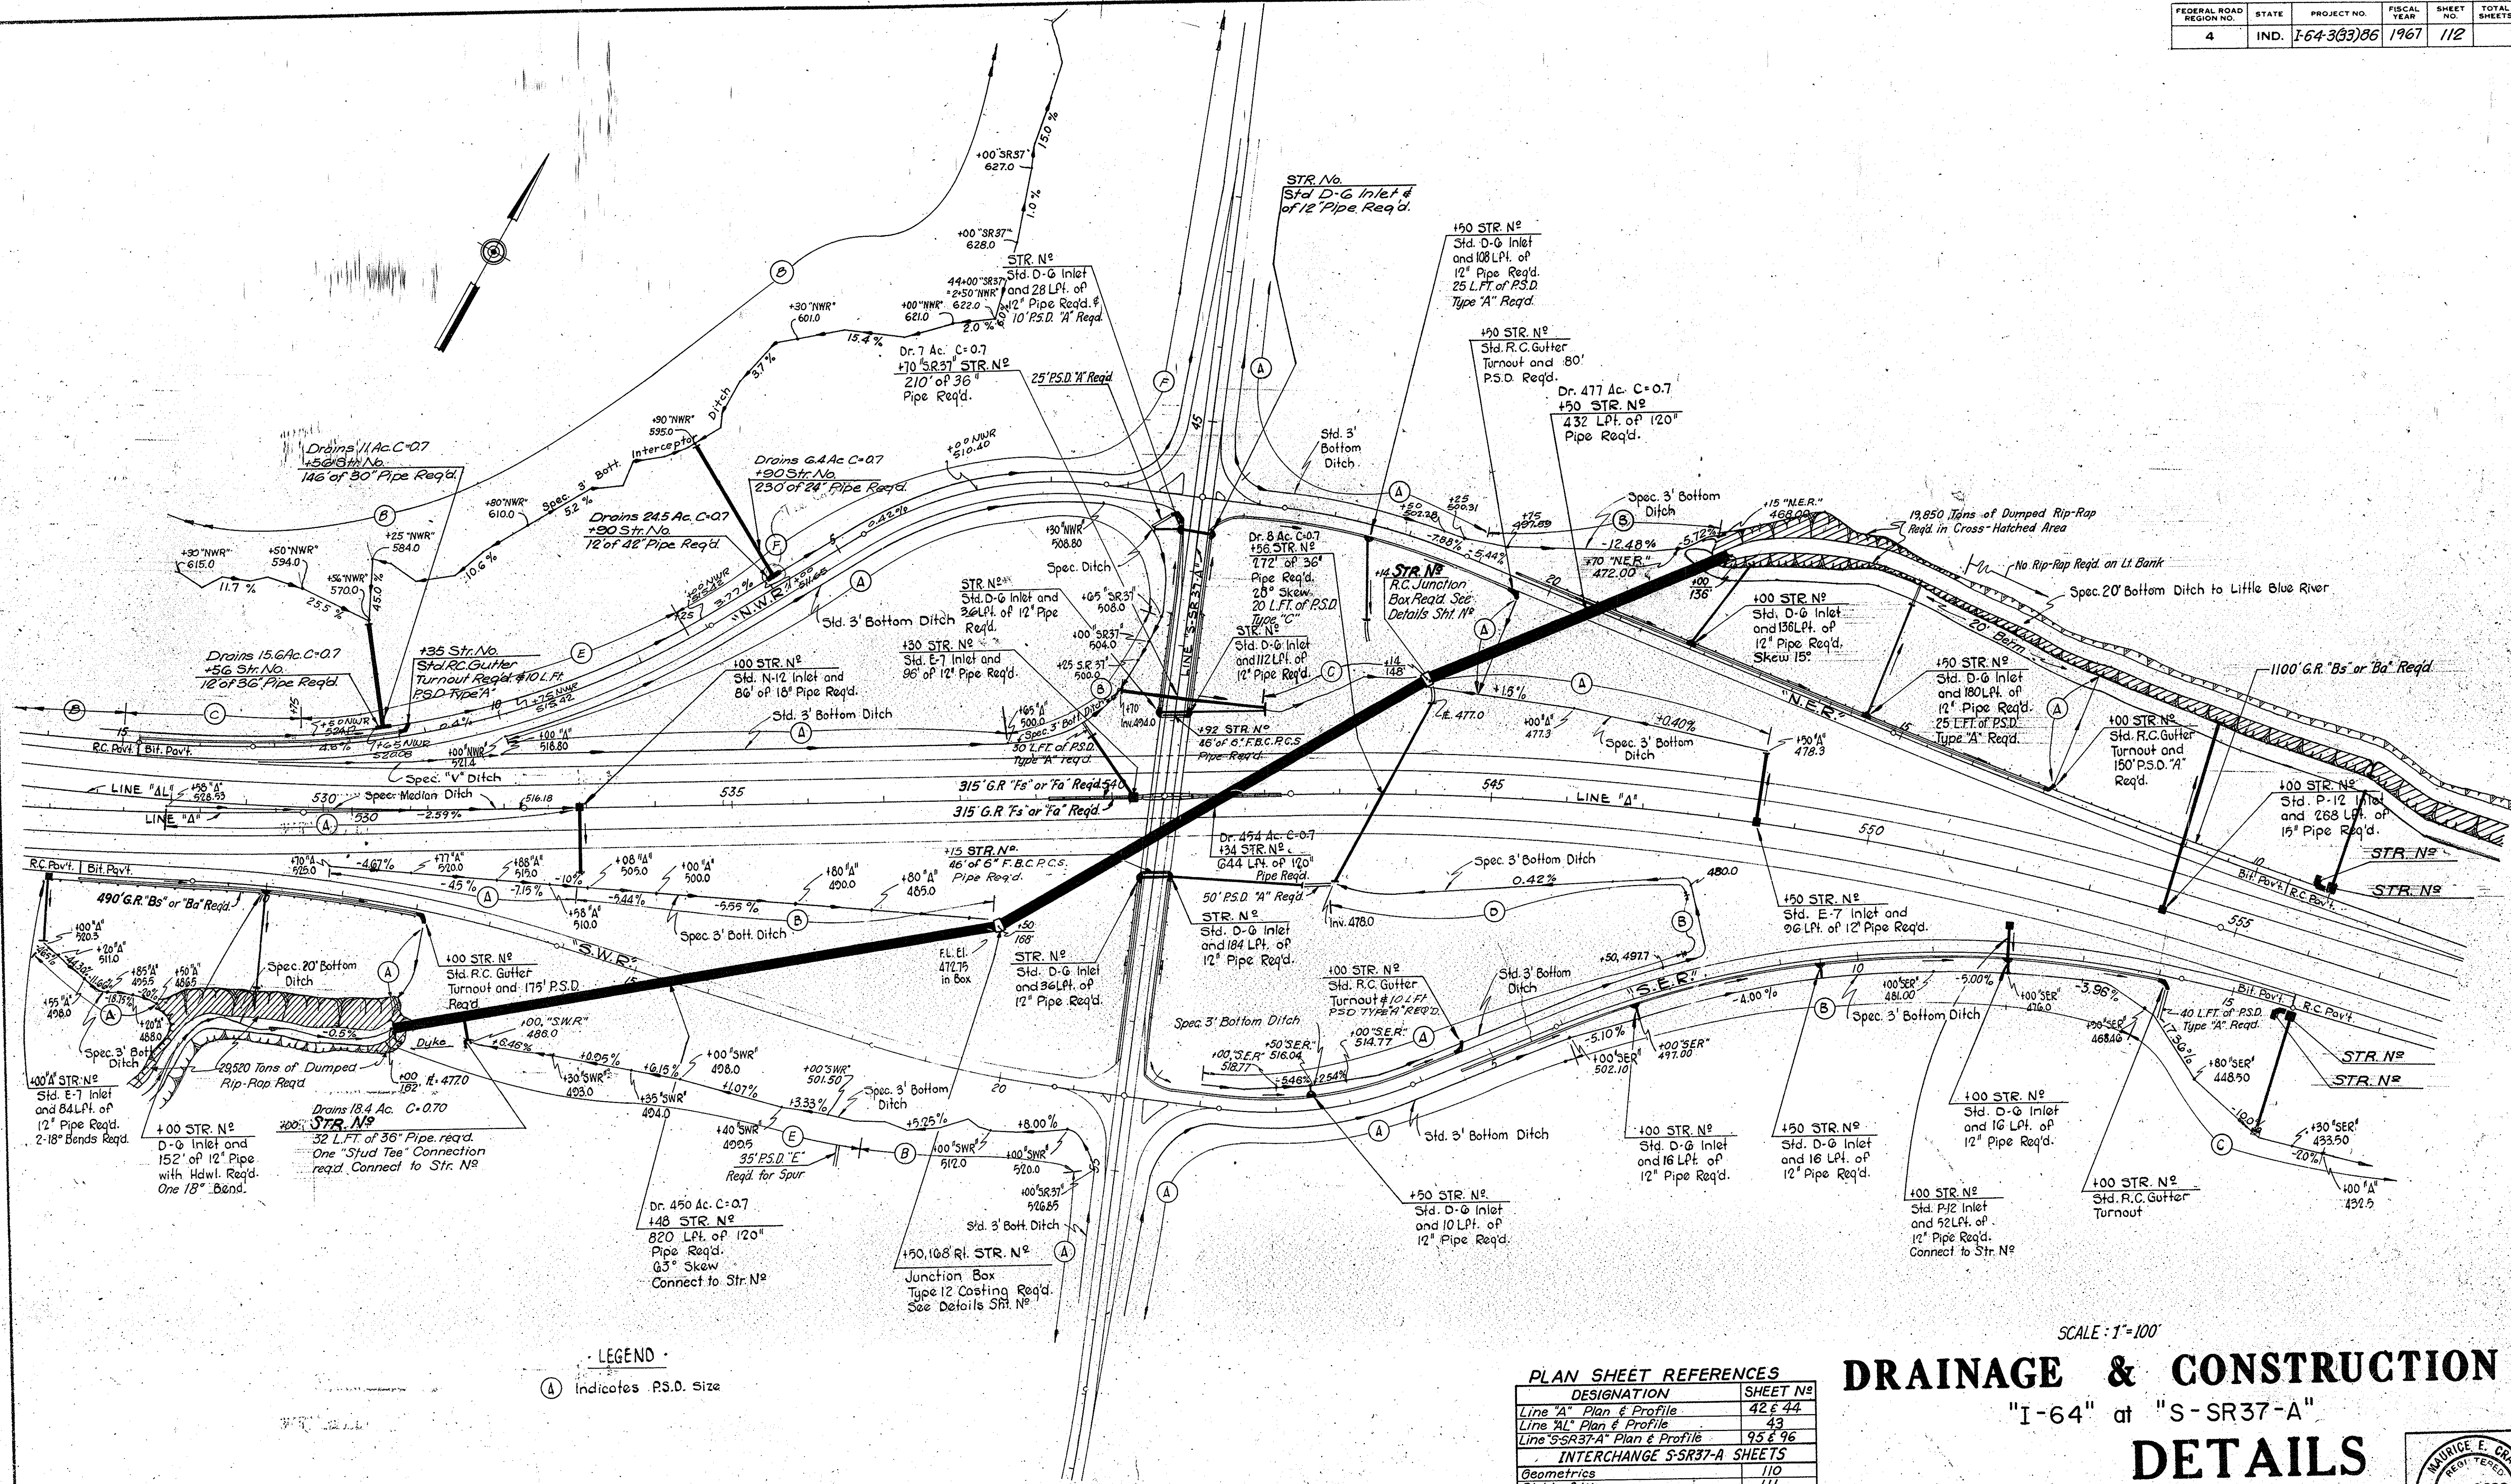

LEGEND
 (A) Indicates P.S.D. Size

PLAN SHEET REFERENCES

DESIGNATION	SHEET NO.
Line "A" Plan & Profile	42 & 44
Line "AL" Plan & Profile	43
Line "S-SR37-A" Plan & Profile	95 & 96

INTERCHANGE S-SR37-A SHEETS


Geometrics	110
Right-of-Way	111
Intersection Details	113
Ramp Grades	114 - 117
Special S.W. Ramp Exit	118
Superelevation Transitions S-SR37-A	141

SCALE: 1"=100'




DRAINAGE & CONSTRUCTION

"I-64" at "S-SR37-A"

DETAILS

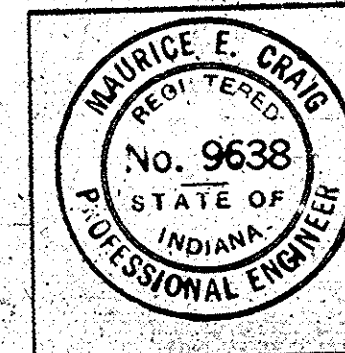

FEDERAL ROAD REGION NO.	STATE	PROJECT NO.	FISCAL YEAR	SHEET NO.	TOTAL SHEETS
4	IND.	1-64-3(33) 86	1967	113	

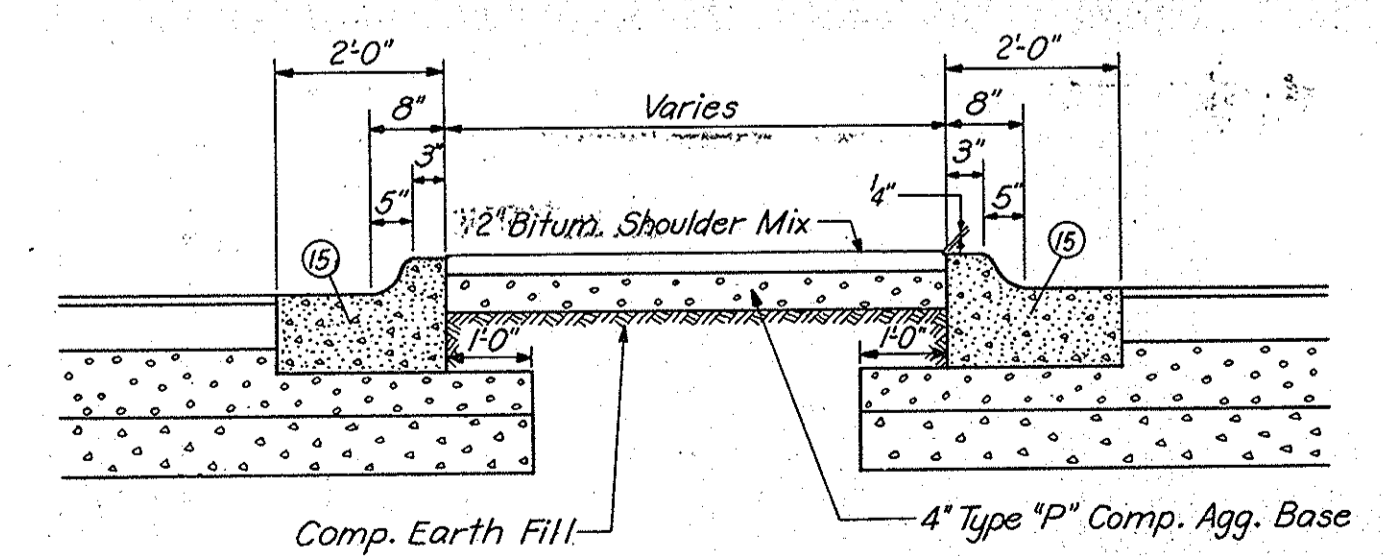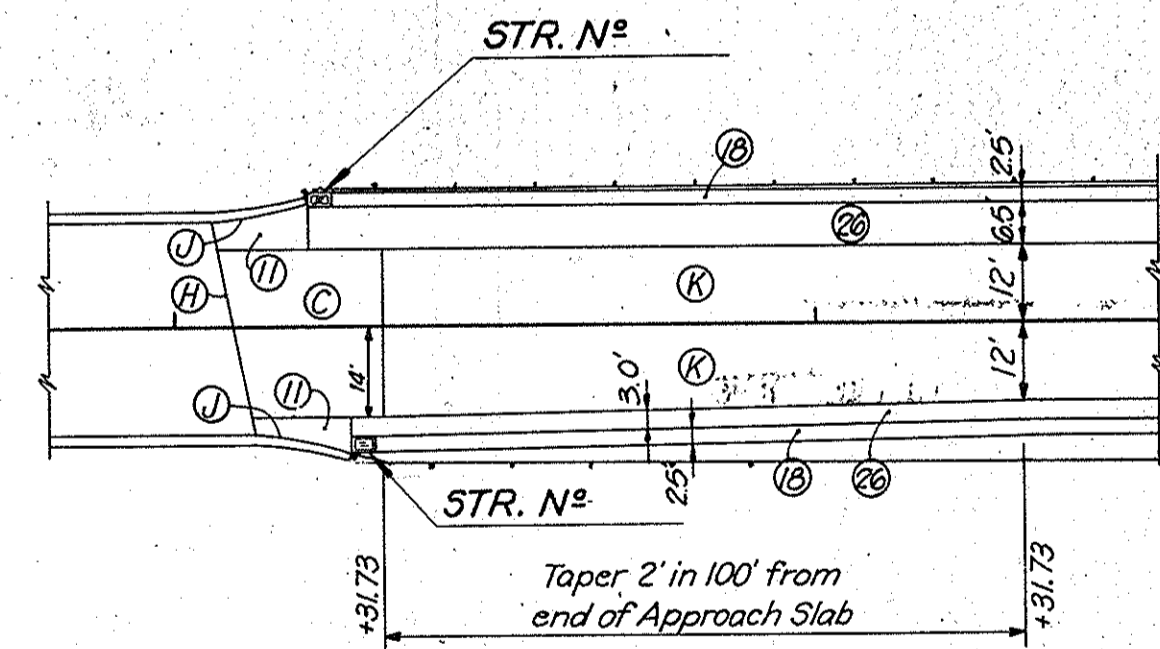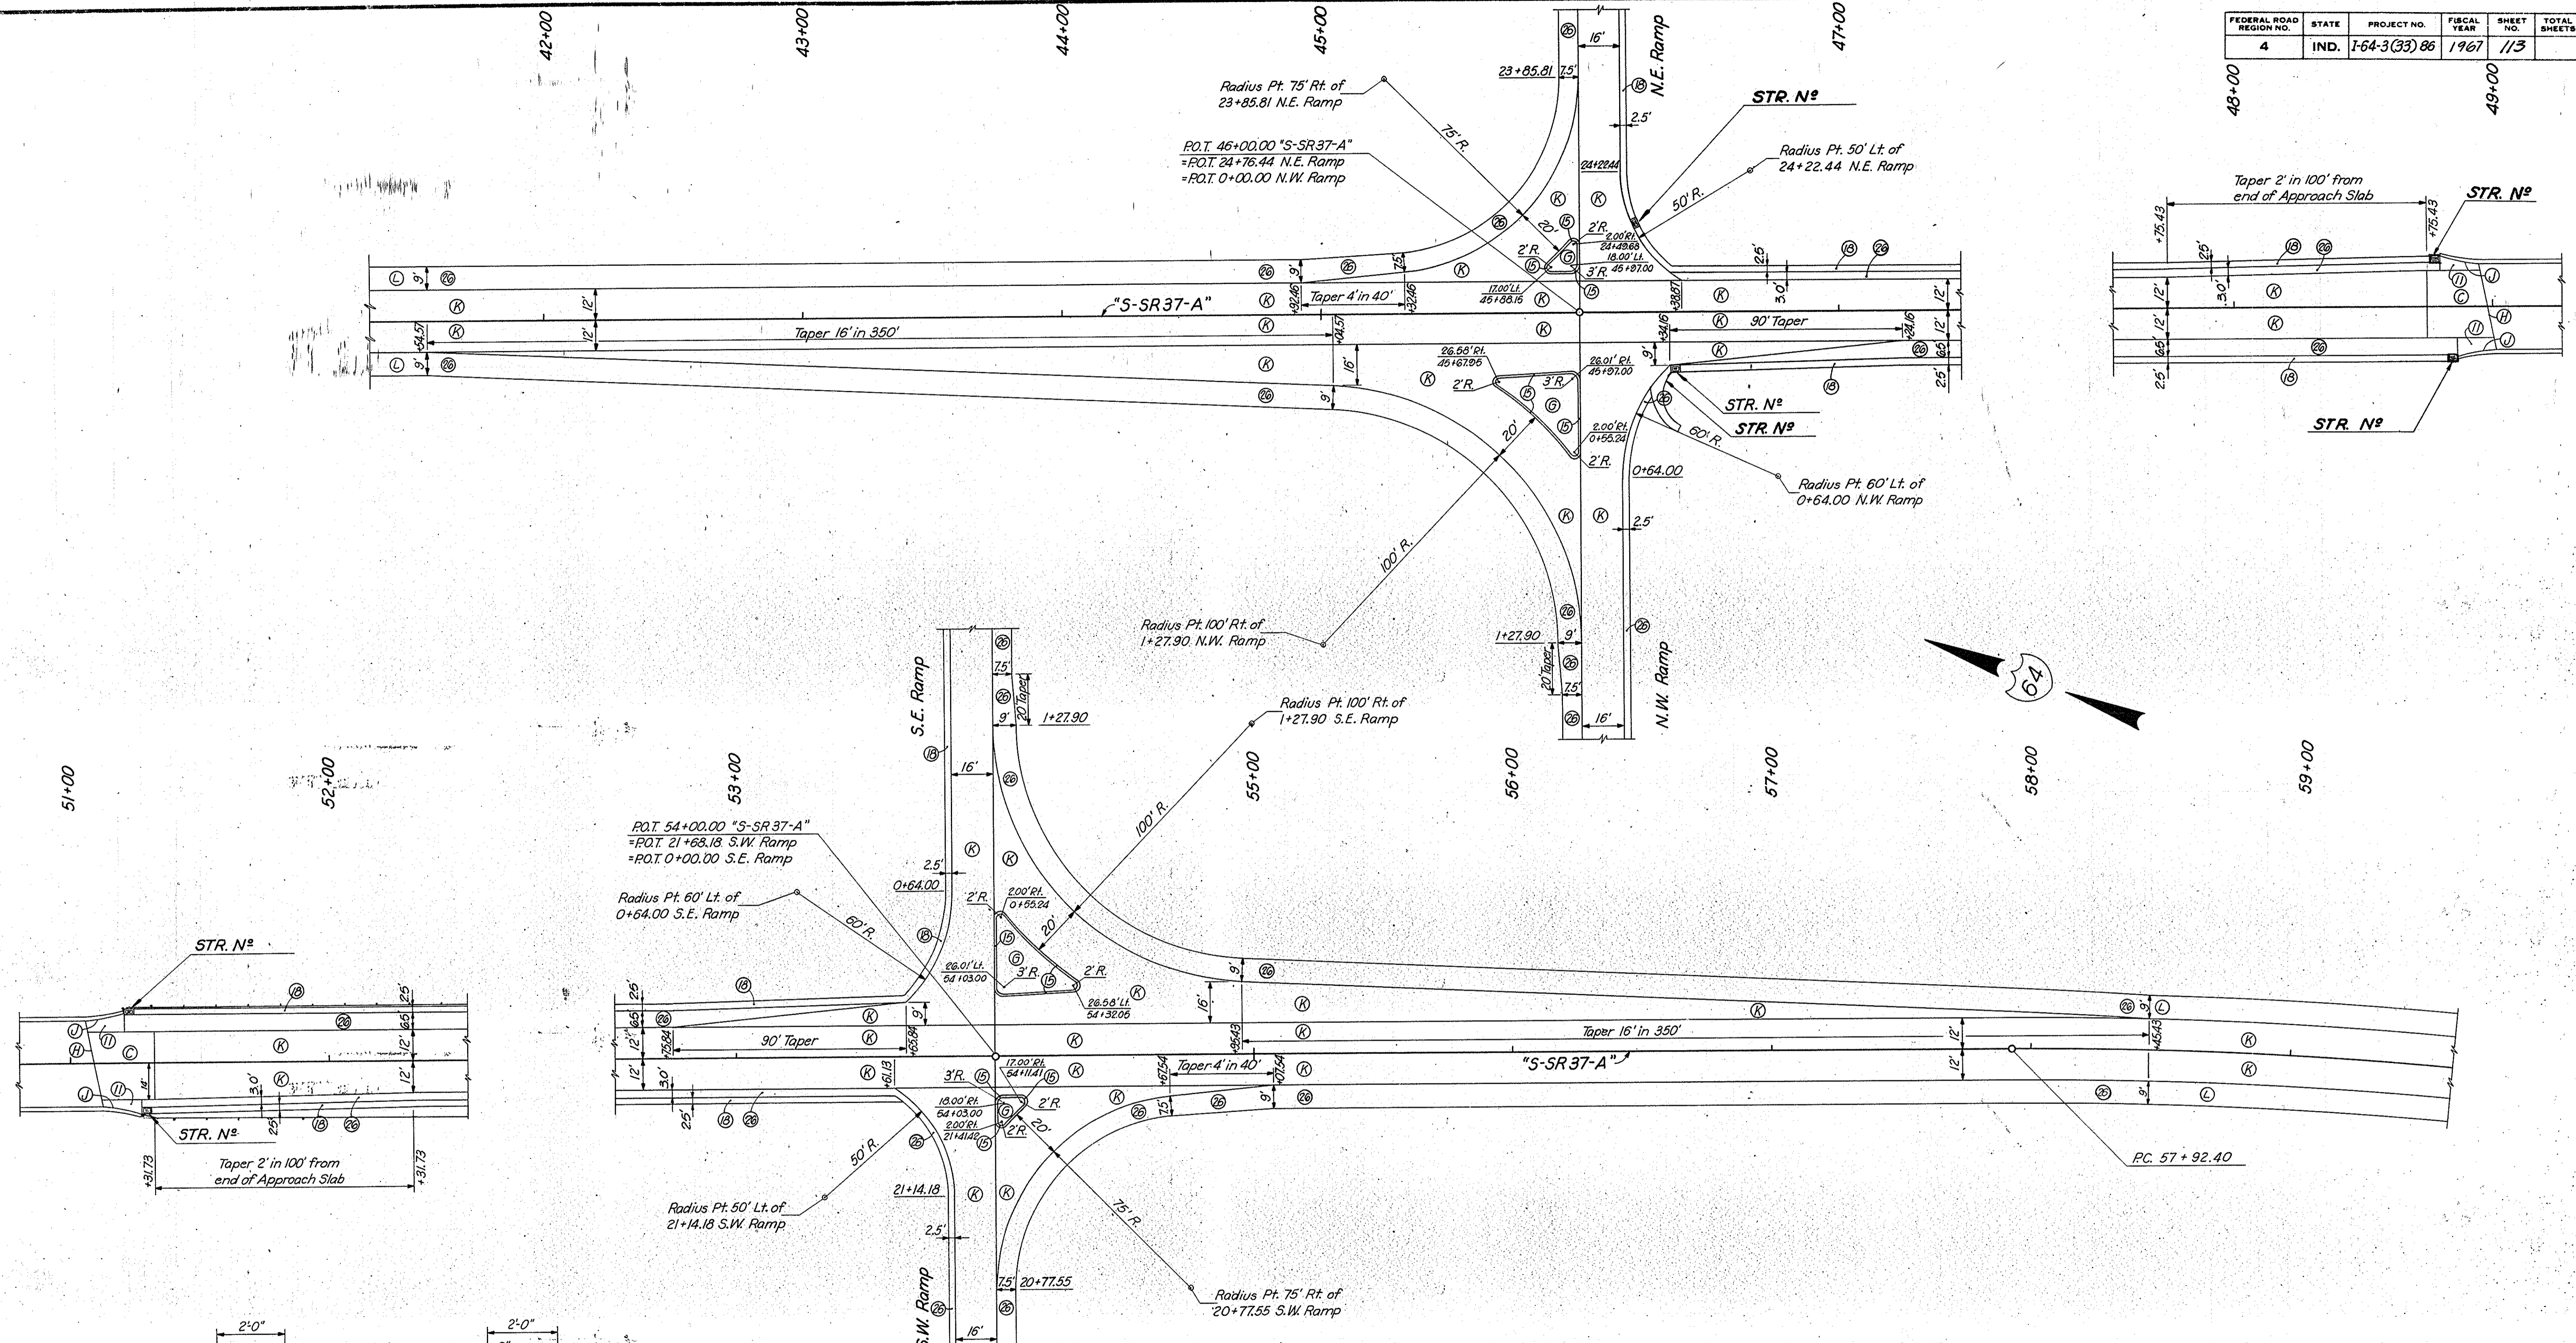


PLAN SHEET REFERENCES	
DESIGNATION	SHEET N°
Line "A" Plan & Profile	42 & 44
Line "AL" Plan & Profile	43
Line "S-SR37-A" Plan & Profile	95 & 96

INTERCHANGE SHEETS	
DESIGNATION	SHEET N°
Geometrics	110
R/W	111
Drainage	112
Ramp Grades	114-117
Special S.W. Ramp Exit	118
Superelev. Transitions S.R.37	141

- LEGEND**
- ① Integral Curb-Walk (See Special Details)
 - ② Combined Curb & Gutter, Type "B"
 - ③ Standard Lip Curb
 - ④ Bituminous Curb
 - ⑤ 1 3/4" Expansion Joint, Type IIA (See Bridge Std. J)
 - ⑥ 1 1/2" Expansion Joint, Type IIA (See Bridge Std. J)
 - ⑦ Ramp Pavement & "S-SR37-A" Pavement (See Typical Sections)
 - ⑧ Seal Coat, Type II
 - ⑨ Reinforced Concrete Pavement (9") (Approach Slab)
 - ⑩ Paved Island - 2" Bituminous Shoulder Mix & 4" Type "P" Compacted Aggregate Base
 - ⑪ 3/4" Type "P" Compacted Aggregate Base
 - ⑫ 1 3/4" Expansion Joint, Type IIA (See Bridge Std. J)
 - ⑬ 1 1/2" Expansion Joint, Type IIA (See Bridge Std. J)
 - ⑭ Ramp Pavement & "S-SR37-A" Pavement (See Typical Sections)
 - ⑮ Seal Coat, Type II

RAMP INTERSECTIONS DETAILS


SCALE: 1" = 30'-0"

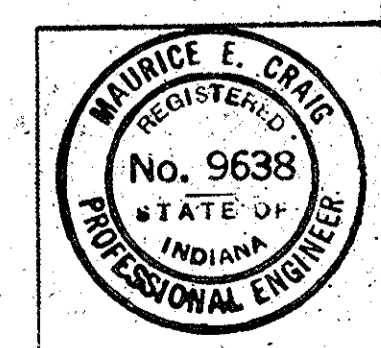

November 6, 1967

PROJECT NO.	LINE	SHEET NO.	TOTAL SHEETS	FILE
1-64-3(33) 86	55R37-4	113		

CUT CROSS SECTIONS FILL
Scale 1 inch = 10 feet

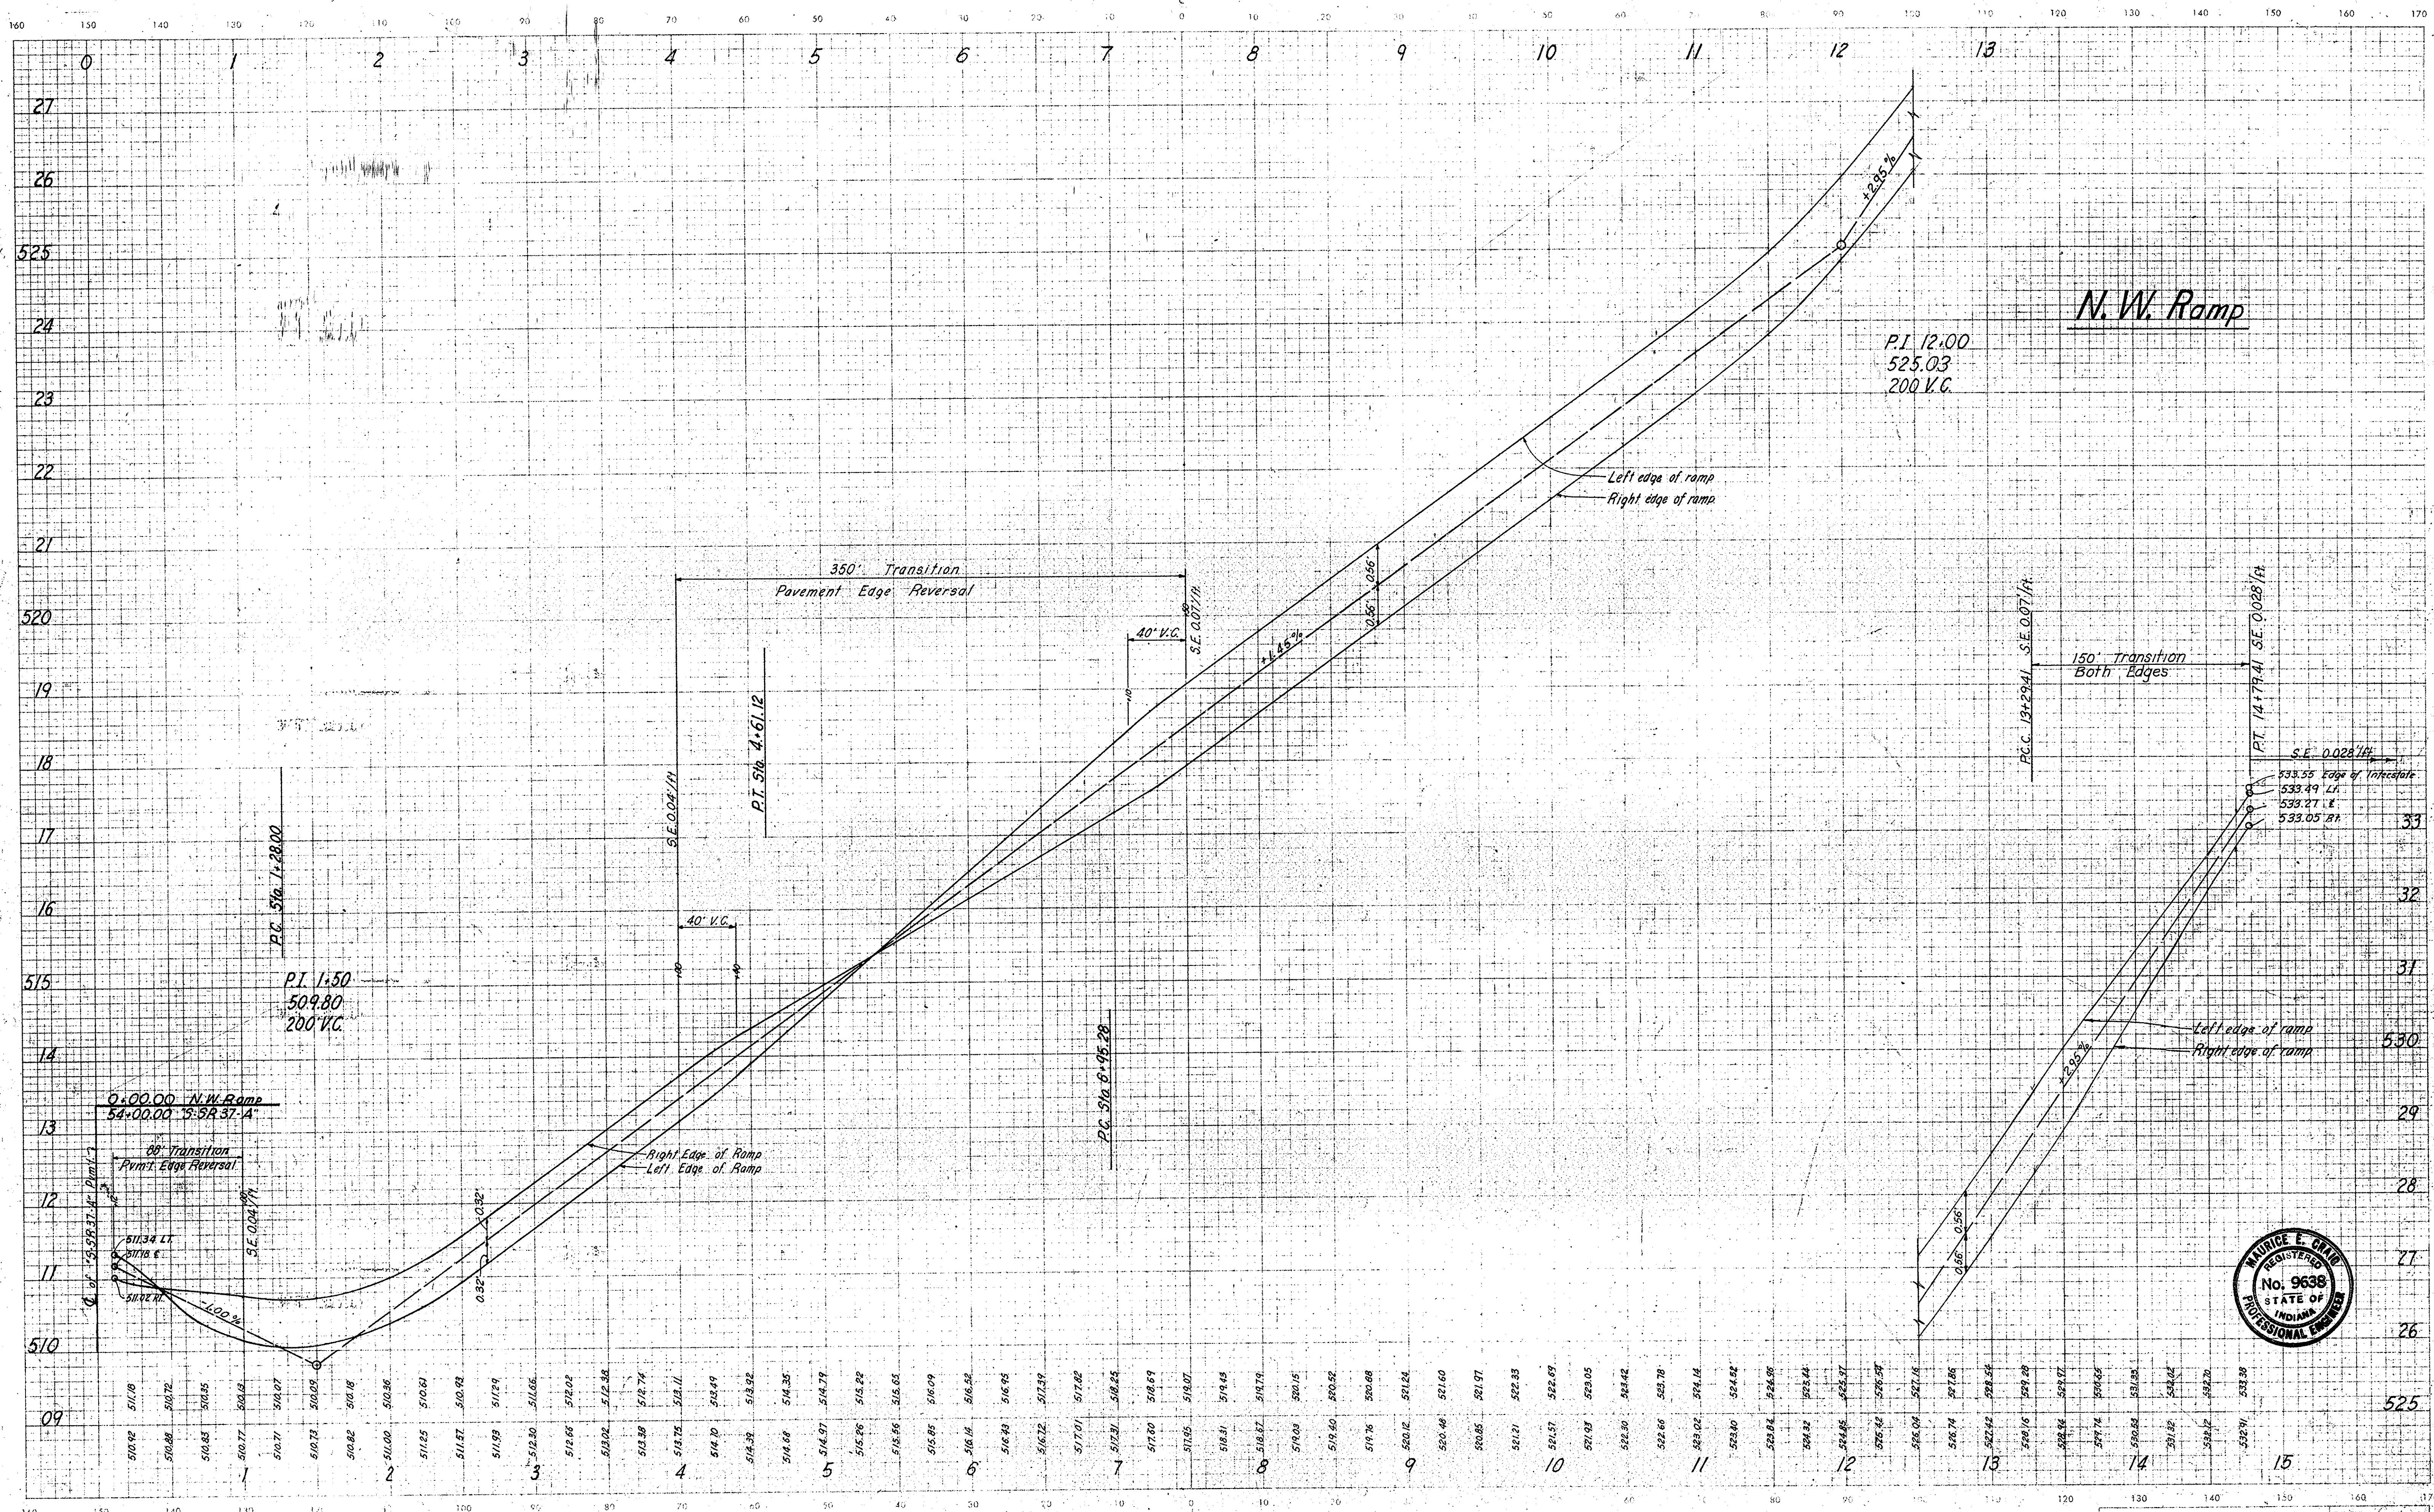


November 6, 1967

LEVEL BOOK NO.	FILE
FEDERAL ROAD REGION NO.	SHEET NO.
4	114
STATE	TOTAL SHEETS
IND.	
PROJECT NO.	
I-64-3(33)86	
FISCAL YEAR	
1967	

S.R. 37 INTERCHANGE LINE N.W.R.

CUT CROSS SECTIONS FILL
Scale: 1 inch = 10 feet

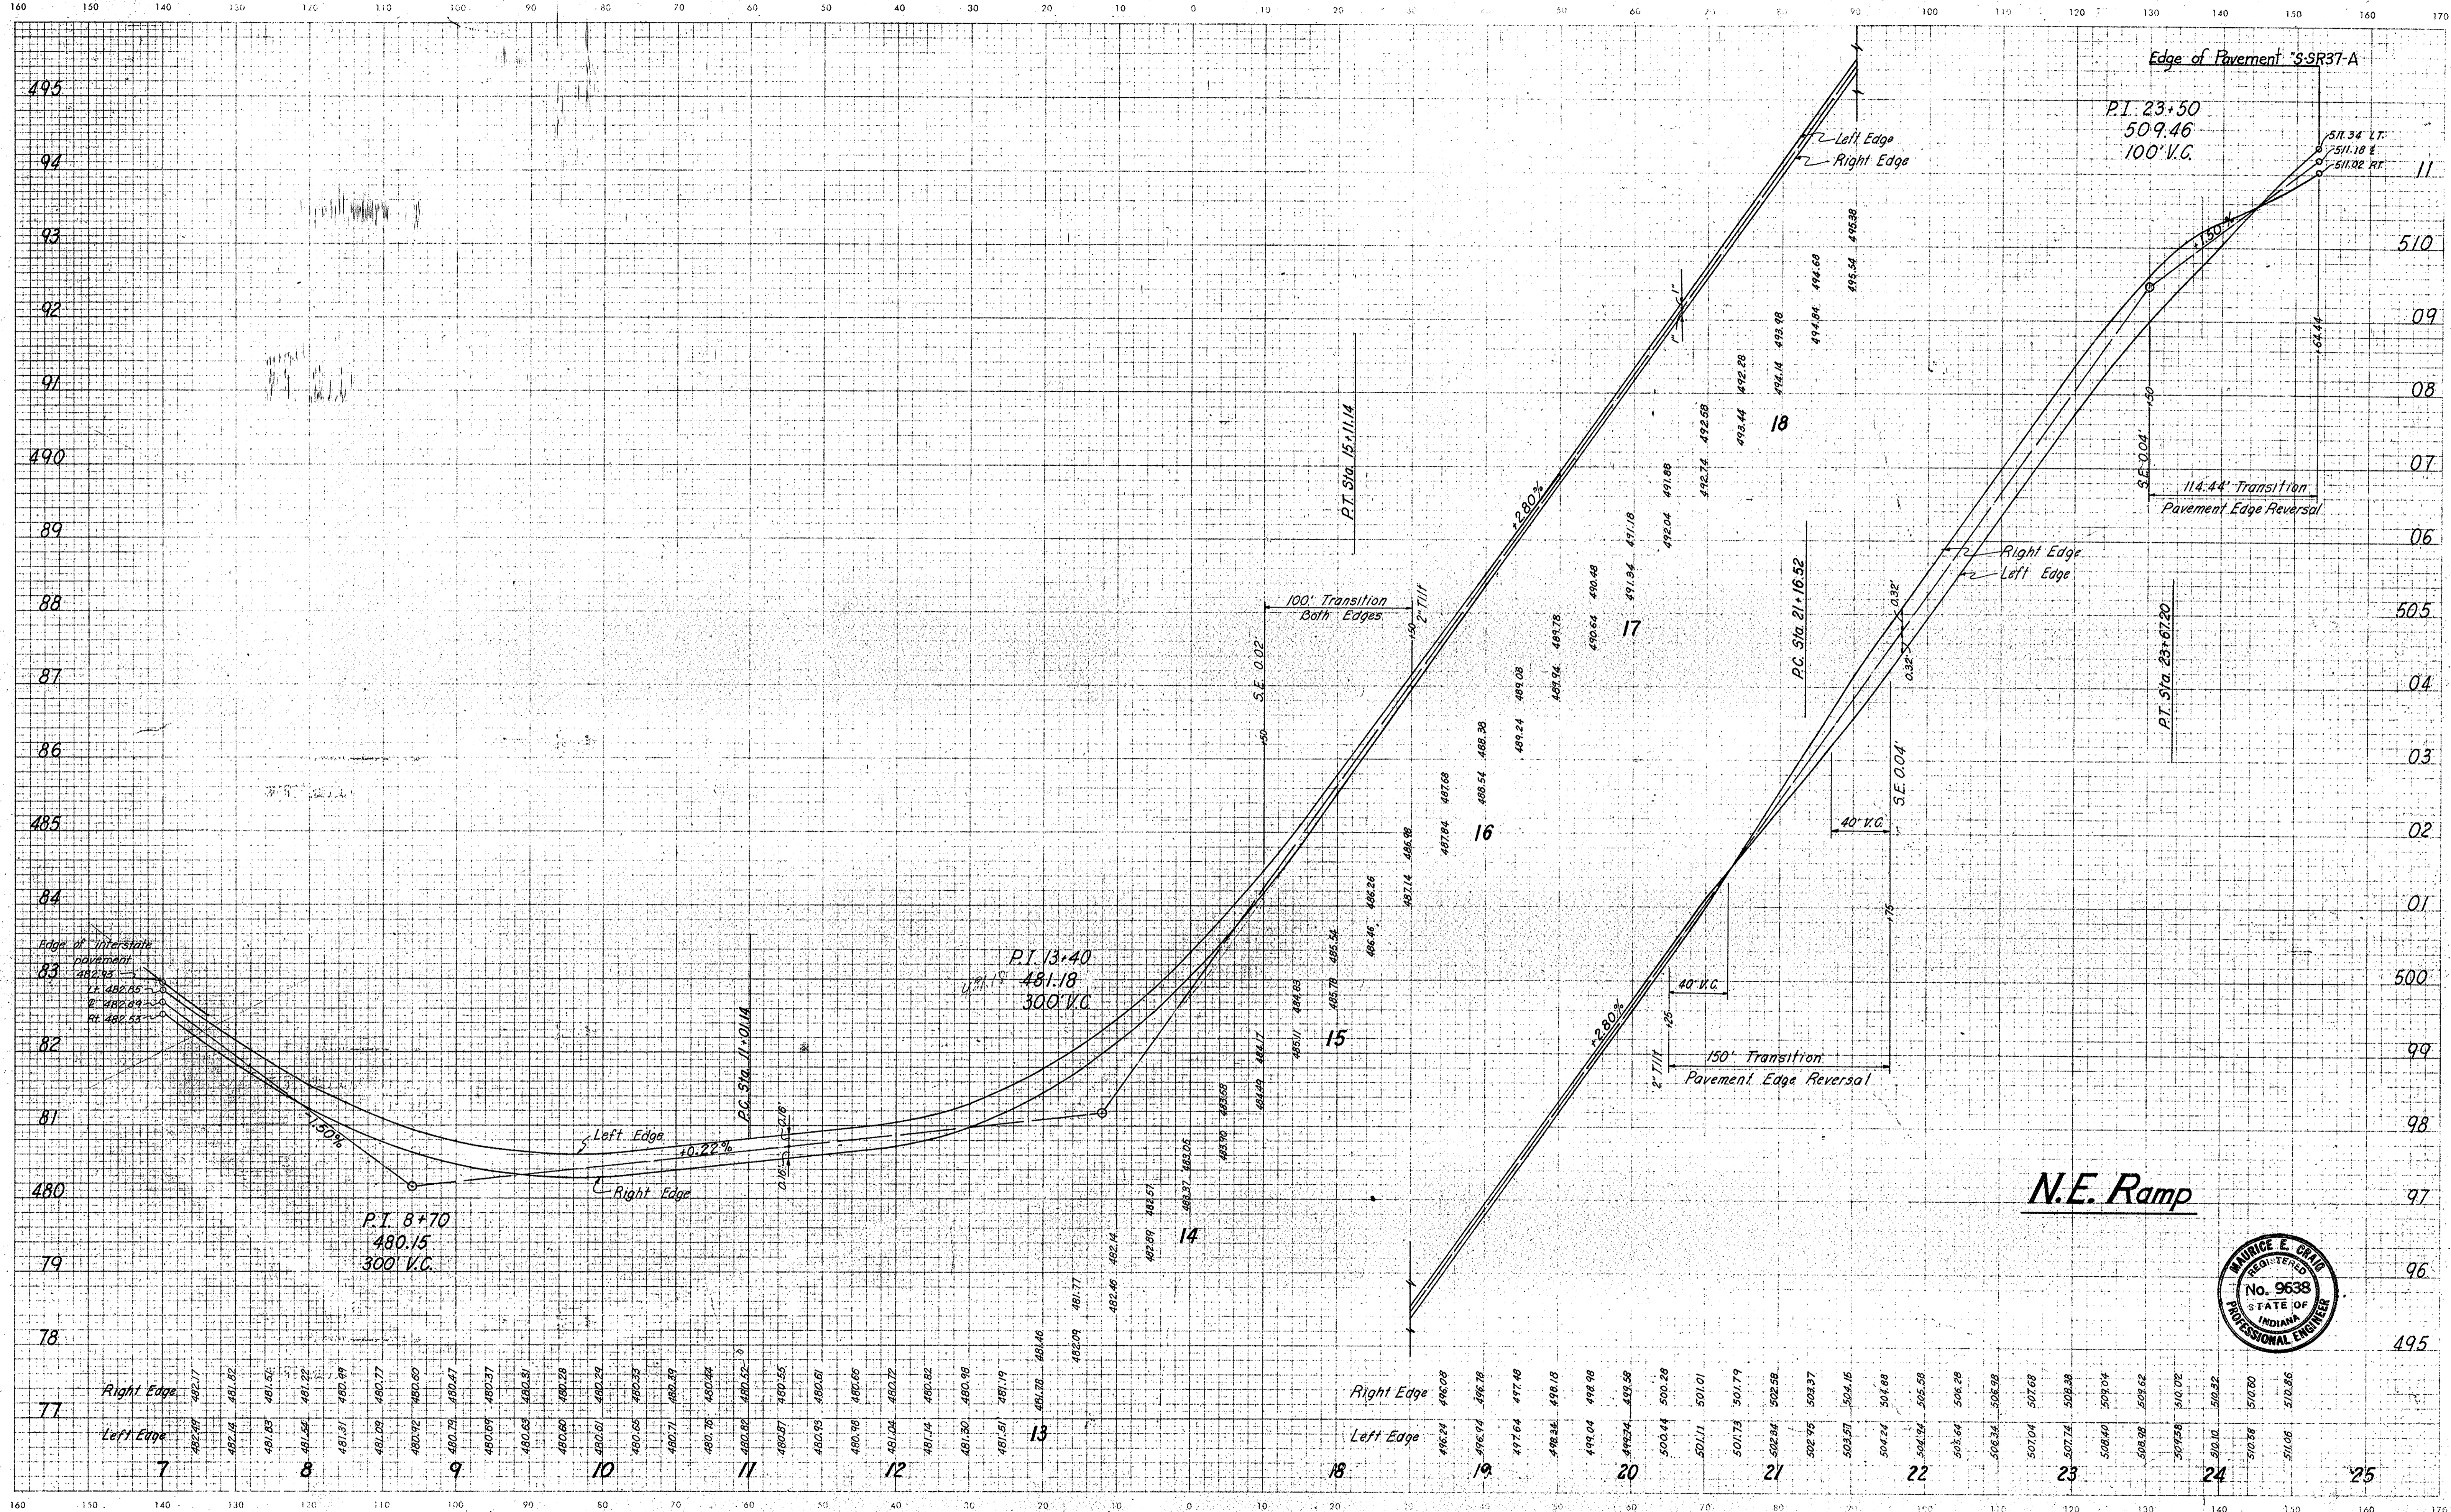



N.E. Ramp



November 6, 1961

LEVEL BOOK NO.	FILE
FEDERAL ROAD REGION NO.	STATE
PROJECT NO.	FISCAL YEAR
SHEET NO.	TOTAL SHEETS
4	IND. I-64-3(3)86
115	1967
S.R. 37 INTERCHANGE, LINE N.E.R.	


CROSS SECTIONS
Scale 1 inch = 10 feet

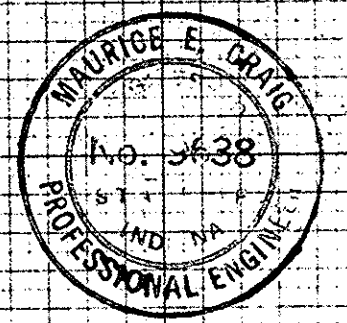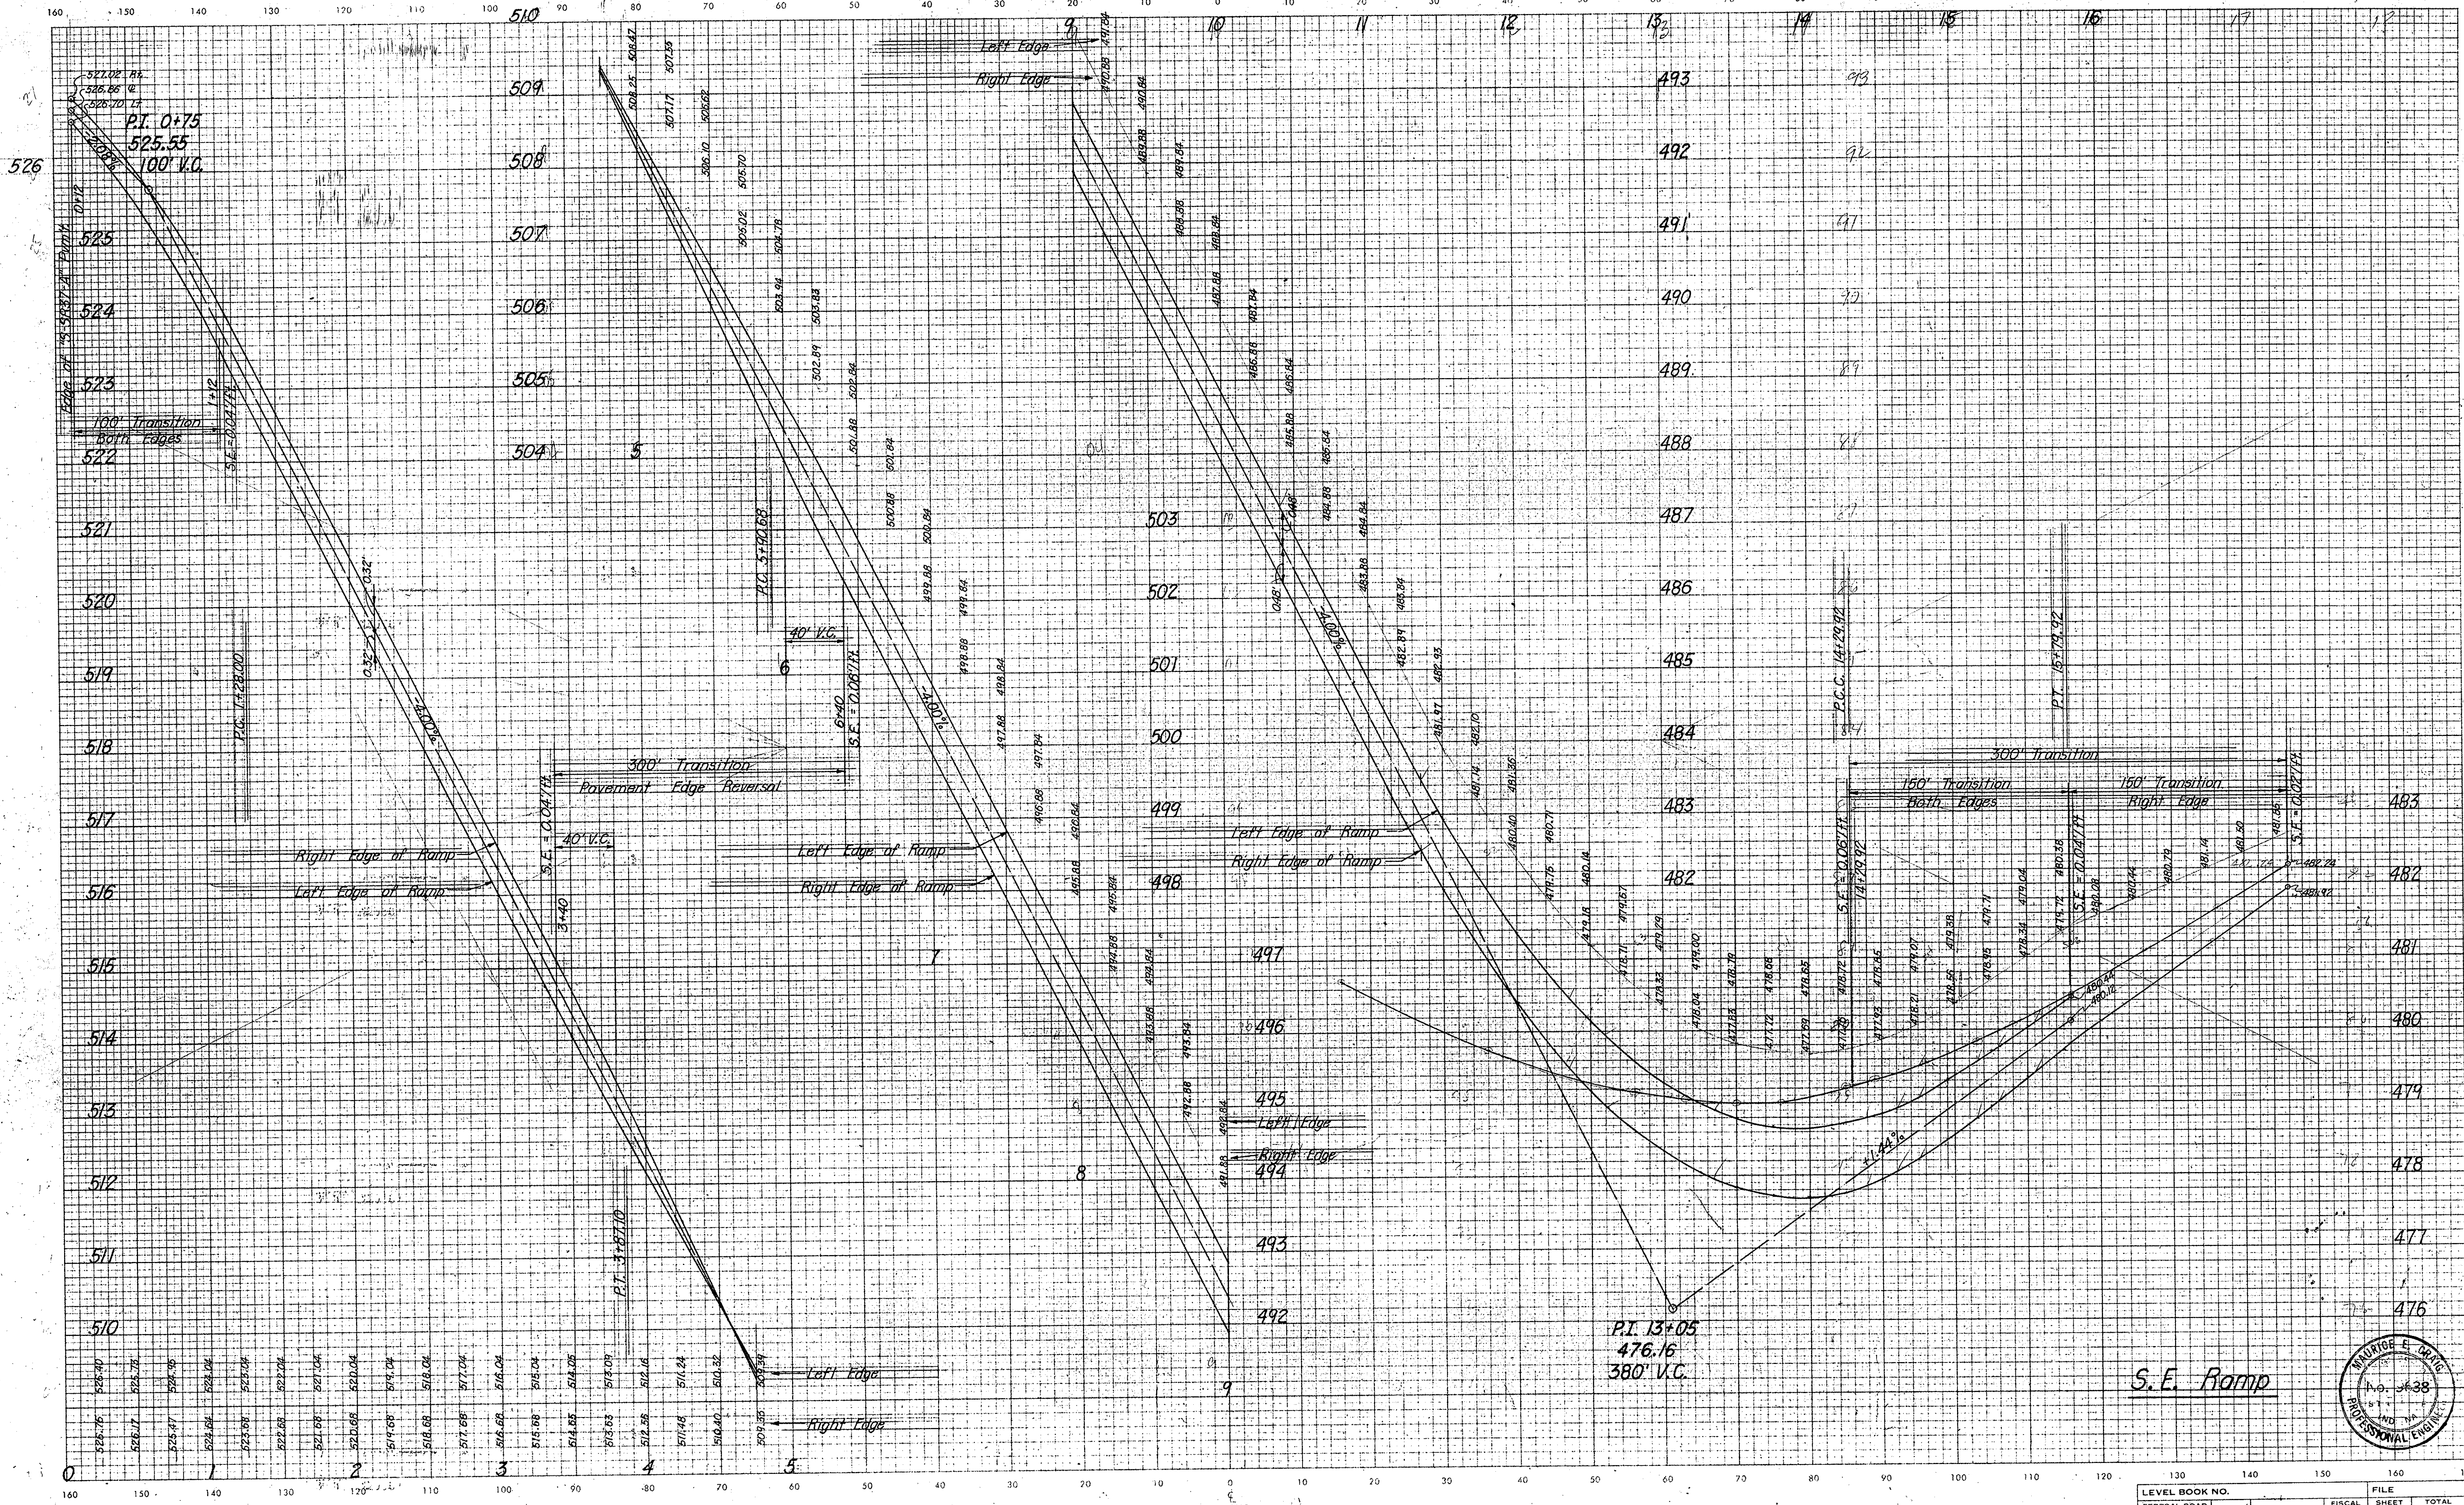

November 6, 1961

LEVEL BOOK NO.		FILE	
FEDERAL ROAD REGION NO.	STATE	PROJECT NO.	FISCAL YEAR
4	IND.	I-64-3(33)86	1967
S.R. 37 INTERCHANGE LINE S.E.R.		SHEET NO.	TOTAL SHEETS
		116	

FEDERAL ROAD REGION NO.	STATE	PROJECT NO.	FISCAL YEAR	SHEET NO.	TOTAL SHEETS
4	IND.	I-64-3(33)86	1967	118	

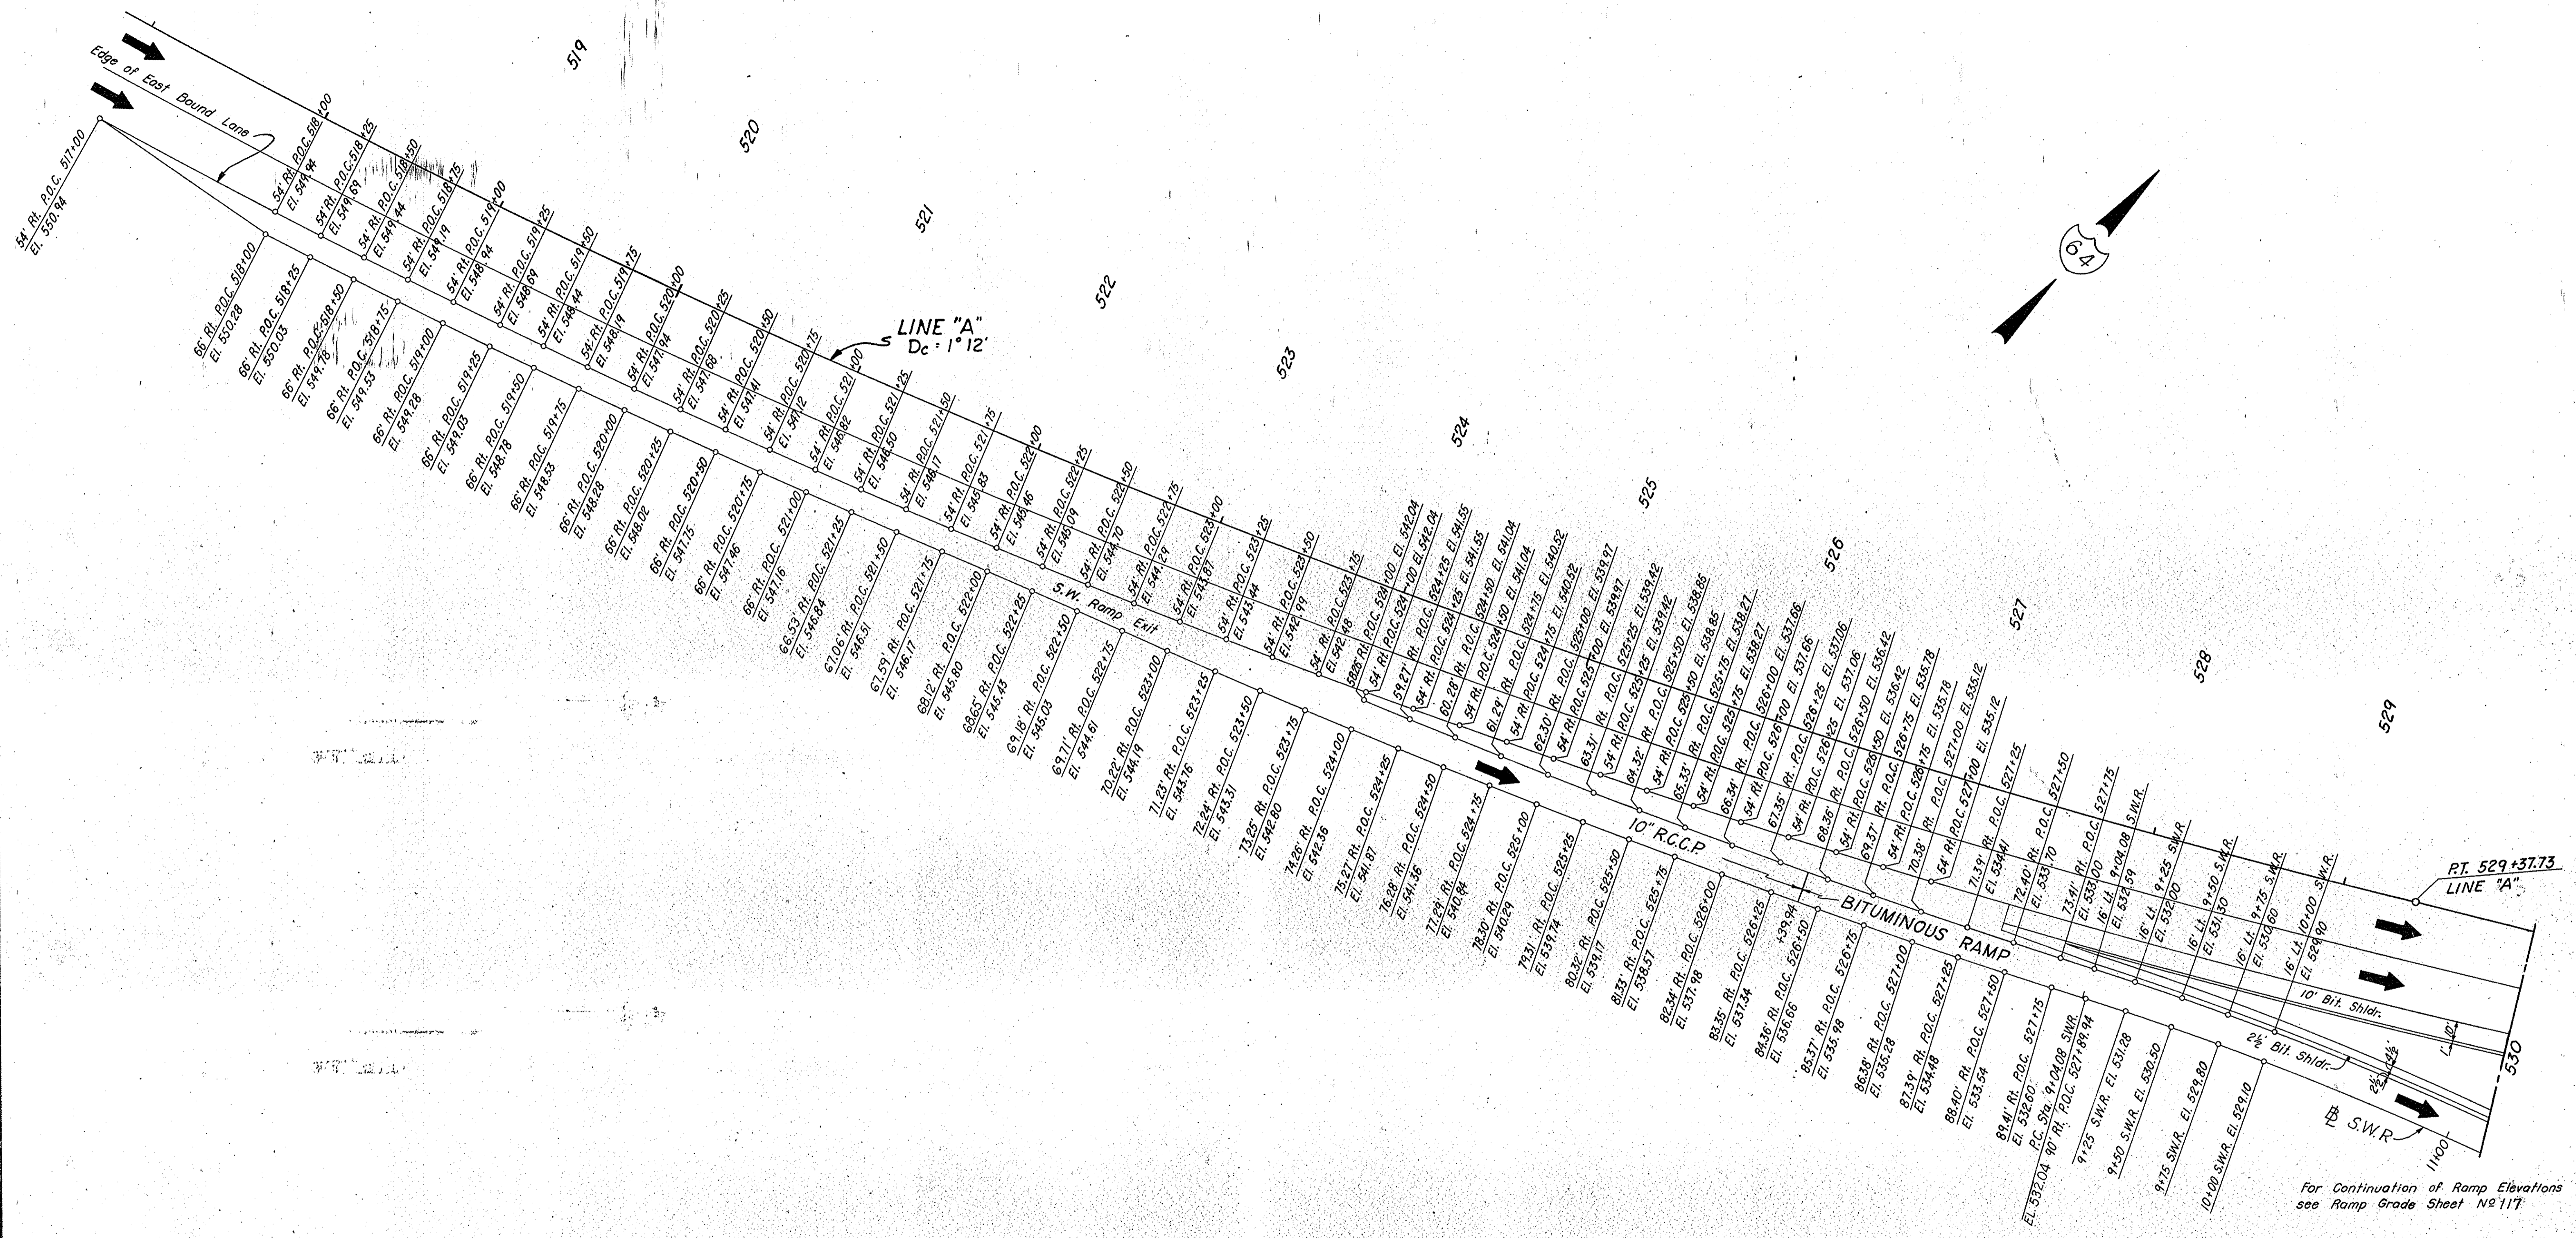


For Continuation of Ramp Elevations see Ramp Grade Sheet No. 117

OFFSETS & ELEVATIONS FOR SPECIAL S.W.R. EXIT DETAILS

S.R. 37 INTERCHANGE

SCALE: 1" = 40'


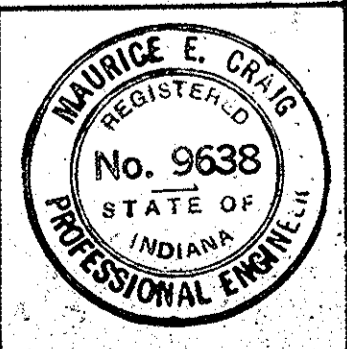


PROJECT NO.	LINE	SHEET NO.	TOTAL SHEETS	FILE
I-64-3(33)86	S.W.R.	118		

FEDERAL ROAD REGION NO.	STATE	PROJECT NO.	FISCAL YEAR	SHEET NO.	TOTAL SHEETS
4	IND.	I-64-3(33)86	1967	120	

SUBJECT TO A BLANKET EASEMENT FOR R/W IN FAVOR OF EUREKA TELEPHONE CO.

Sec. 24, T35, R1E
Jennings Twp.
Crawford County

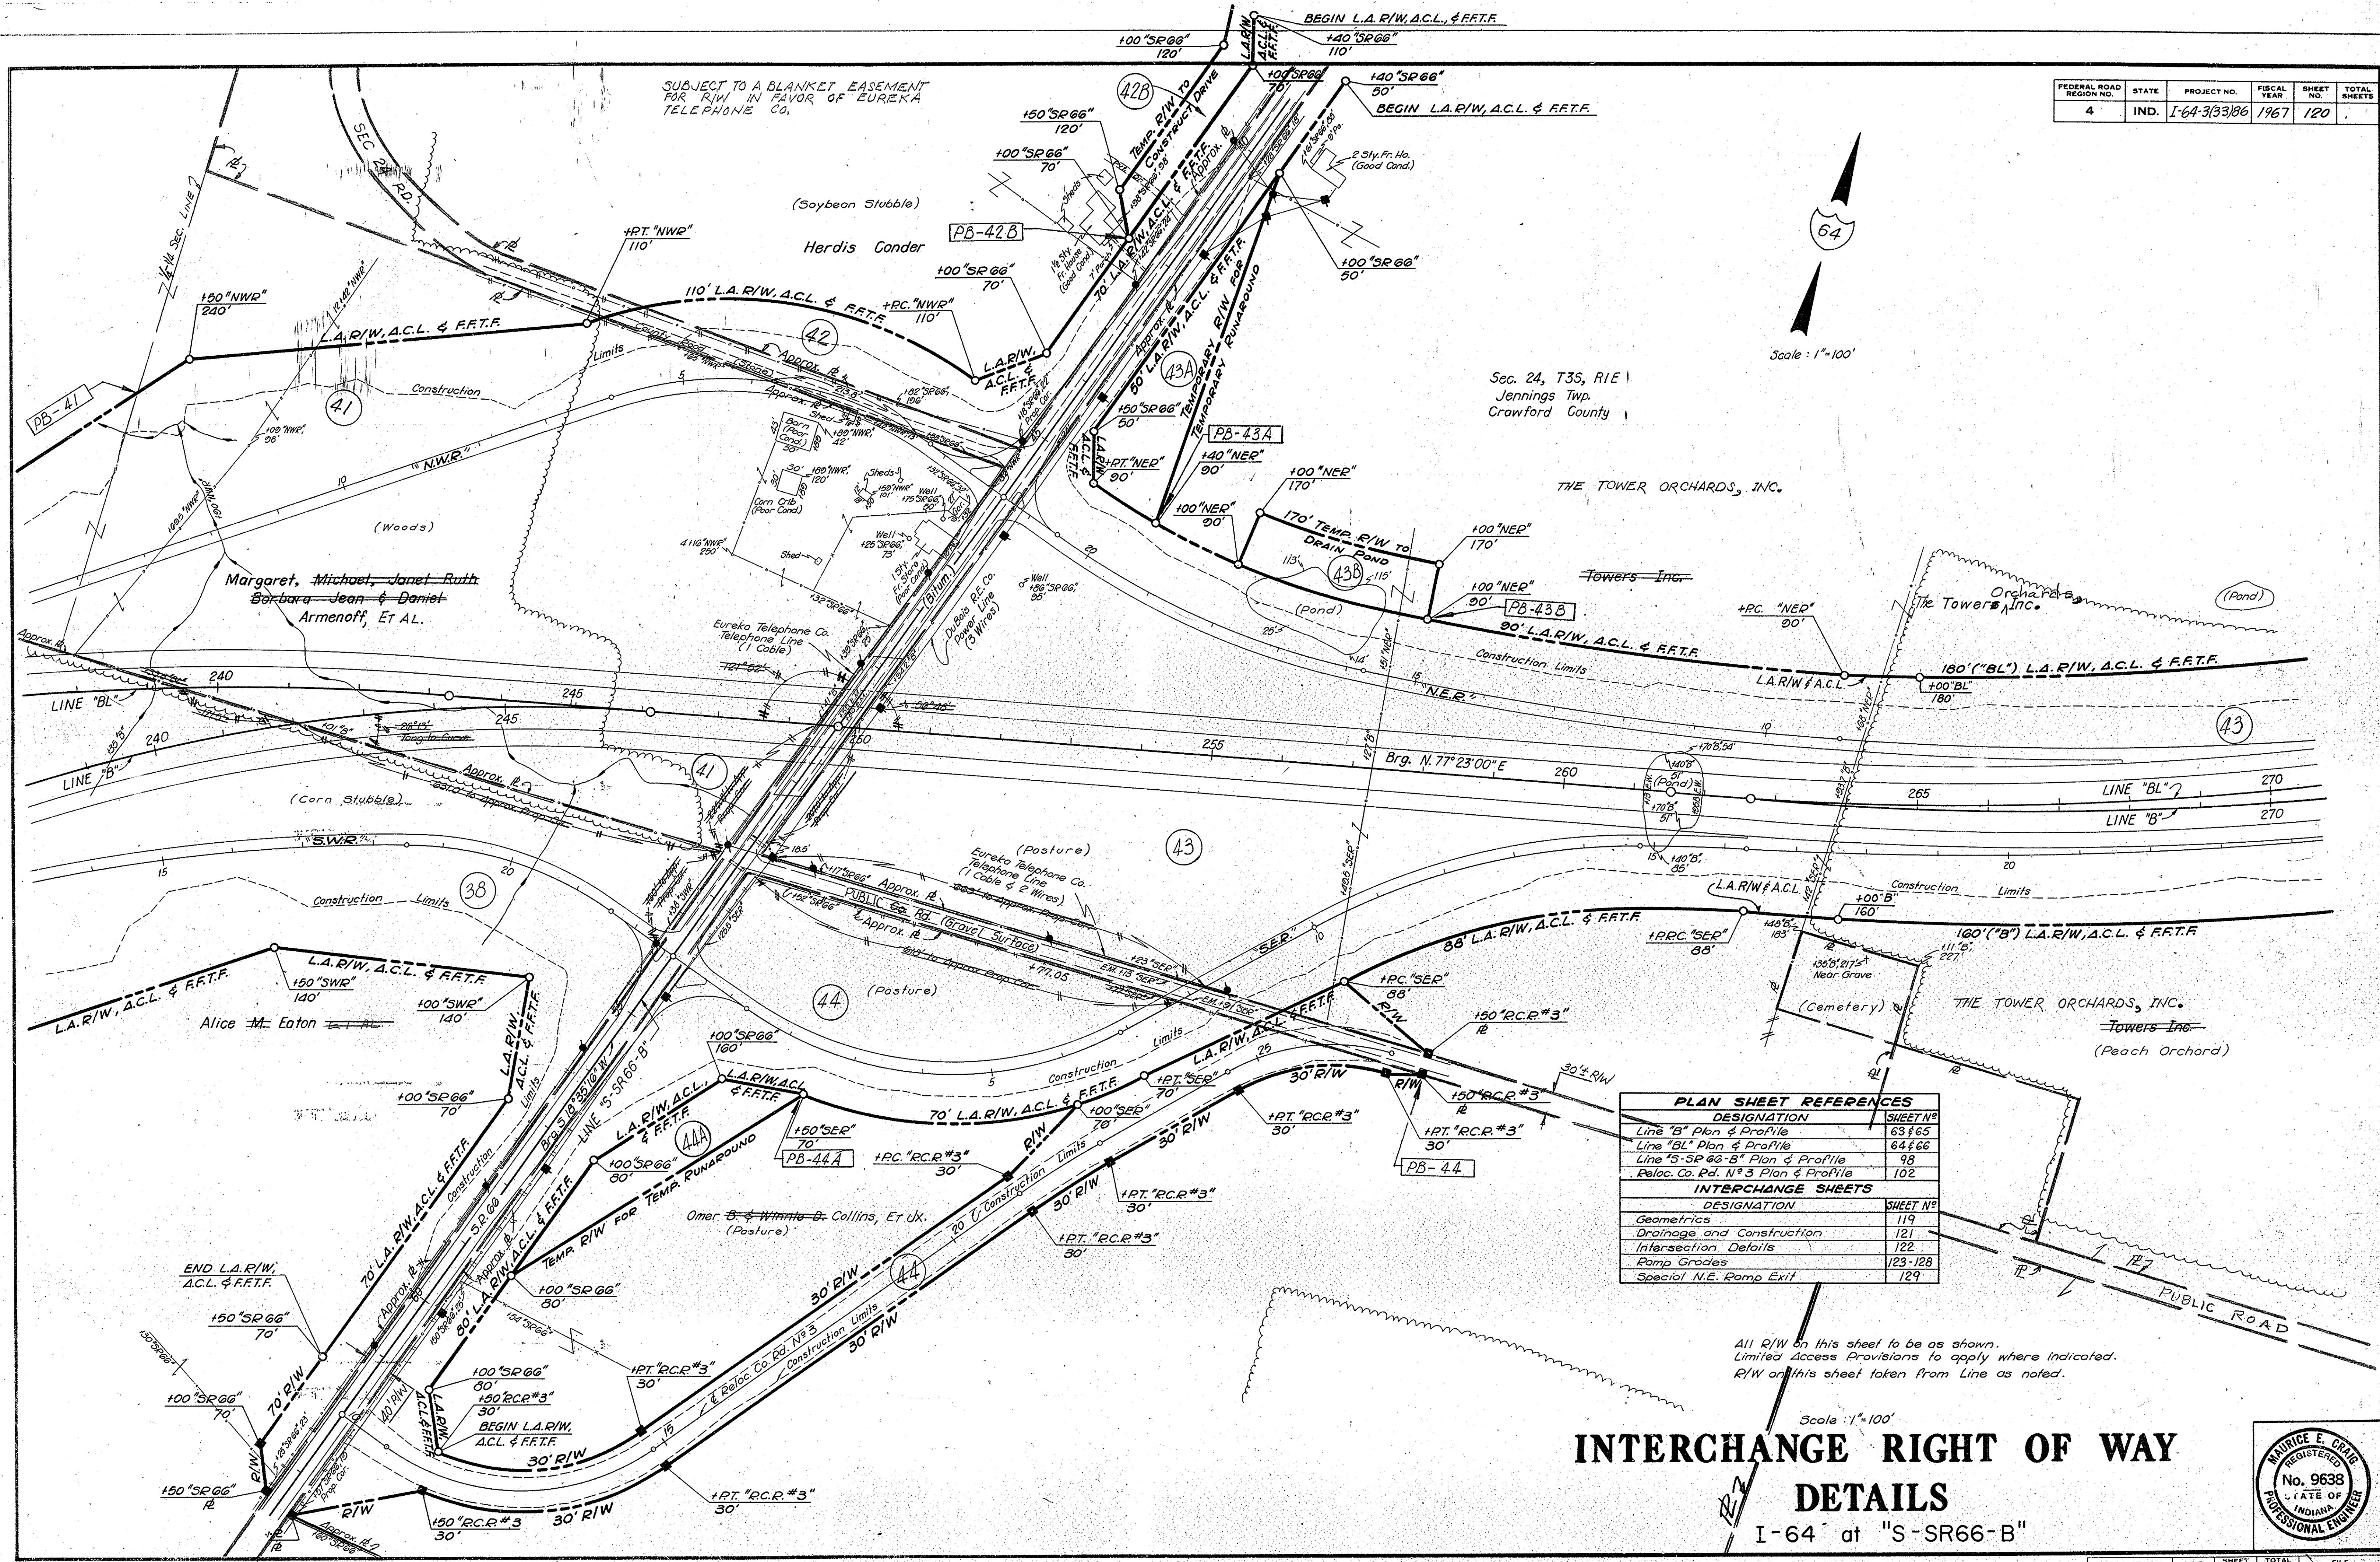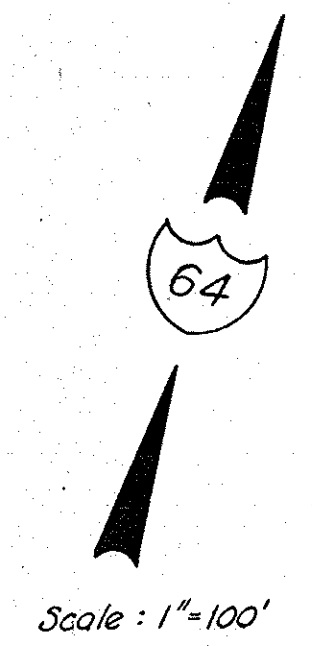


PLAN SHEET REFERENCES	
DESIGNATION	SHEET NO.
Line "B" Plan & Profile	63 & 65
Line "BL" Plan & Profile	64 & 66
Line "S-SR66-B" Plan & Profile	98
Reloc. Co. Rd. N° 3 Plan & Profile	102
INTERCHANGE SHEETS	
DESIGNATION	SHEET NO.
Geometrics	119
Drainage and Construction	121
Intersection Details	122
Ramp Grades	123-128
Special N.E. Ramp Exit	129

All R/W on this sheet to be as shown.
Limited Access Provisions to apply where indicated.
R/W on this sheet taken from Line as noted.

INTERCHANGE RIGHT OF WAY DETAILS

I-64 at "S-SR66-B"

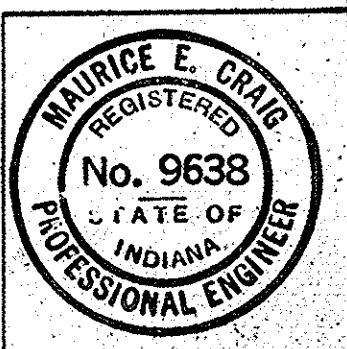

PROJECT NO.	LINE	SHEET NO.	TOTAL SHEETS	FILE
I-64-3(33)86	S-SR66-B	120		

⑥ COMBINED CURB & GUTTER - TYPE "B"
 Traffic Island @ NWR = 115.0 L.Ft.
 " " " @ SER = 115.0 L.Ft.
 " " " @ NER = 46.0 L.Ft.
 " " " @ SWR = 46.0 L.Ft.
 322.0 L.Ft.

⑧ STANDARD LIP GUTTER
 46+34.2 to 48+74 S.R.66 Rt. = 238.8 L.Ft.
 46+38.9 to 48+50 " Lt. = 211.1 " "
 51+26 to 53+58 " Lt. = 232.0 " "
 51+45 to 53+58 Rt. = 213.0 " "
 0+21 to 6+85 N.W.R. Lt. = 669.3 " "
 6+85 to 19+37.45 " Rt. = 1252.5 " "
 7+50 to 21+74.8 S.W.R. Rt. = 1424.8 " "
 4240.5 L.Ft.

⑦⑧ GUARD RAIL - TYPE "Ds"
 "S-SR66-B"
 North End of Bridge = 100 L.Ft.
 50 L.Ft. Rt. & Lt.
 South End of Bridge = 100 L.Ft.
 50 L.Ft. Rt. & Lt.
 200 L.Ft.

REINFORCING STEEL
 NWR Entrance 22 - #5 x 20'-9"
 SWR Exit 4 - #5 x 20'-9"
 SER Entrance 22 - #5 x 20'-9"
 NER Exit 4 - #5 x 20'-9"
 52 - #5 x 20'-9" x 1.043
 = 1126#

PAVED SIDE DITCH
 TYPE "A"

232+00 to 239+00 "B" Lt.
 241+70 "B" Lt. to 241+00 "BL" Rt.
 233+00 to 241+00 "BL" Rt.
 238+55 to 239+47 "BL" Lt.
 248+30 "B" Lt. to 47+00 S.R.66 Rt.
 43+75 S.R.66 to 1+80 N.W.R. Rt.
 44+75 S.R.66 to 20+10 N.E.R. Rt.
 47+00 S.R.66 to 1+80 N.W.R. Lt.
 55+00 to 56+25 S.R.66 Lt.
 55+25 to 56+25 S.R.66 Rt.
 1+00 to 2+75 S.E.R. Rt.
 8+25 to 9+25 S.E.R. Lt.
 10+95 to 16+00 S.E.R. Lt.
 8+25 to 11+25 S.E.R. Lt.
 9+00 to 14+75 N.E.R. Rt.
 16+25 N.E.R. Lt. to 256+00 "B" Lt.
 4+90 to 7+05 N.W.R. Rt.
 2+50 to 10+82 N.W.R. Lt.
 9+30 to 15+25 S.W.R. Rt.
 51+75 "SR66" Lt. to 250+00 "B" Rt.
 53+60 "SR66" Rt. to 246+90 "B" Rt.
 51+45 "SR66" Rt.
 10+75 to 13+25 "SWR" Rt. Interceptor


232+00 to 234+00 "B" Rt.
 241+00 to 246+25 "BL" Median
 7+05 to 10+75 N.W.R. Rt.
 TYPE "C"
 243+88 to 245+40 "BL" Lt.
 9+60 to 10+95 S.E.R. Rt.
 14+75 to 16+25 N.E.R. Rt.
 10+75 to 11+75 N.W.R. Rt.
 TYPE "D"
 20+75 S.W.R. to 55+25 "SR66" Rt.
 TYPE "E"
 246+15 to 247+40 "B" Rt.
 TYPE "H"
 241+37 to 243+88 "BL" Lt.

⑦⑨ GUARD RAIL - TYPE "Bs"
 "NWR" 11+00 to 16+00 Rt. = 500 L.Ft.
 Sta. 239+00 to 243+00 "BL" Lt. = 400 L.Ft.
 900 L.Ft.

②⑤ BITUMINOUS CURB
 Sta. 239+00 to 243+00 "BL" Lt. = 400 L.Ft.

⑦⑩ GUARD RAIL - TYPE "Es"
 Sta. 247+71.68 to 249+46.68 = 176.0 L.Ft.
 Sta. 249+91.46 to 251+66.46 = 176.0 L.Ft.
 352.0 L.Ft.

⑦⑪ GUARD RAIL - TYPE "Fs"
 Sta. 248+62.82 to 251+75.32 = 312.5 L.Ft.

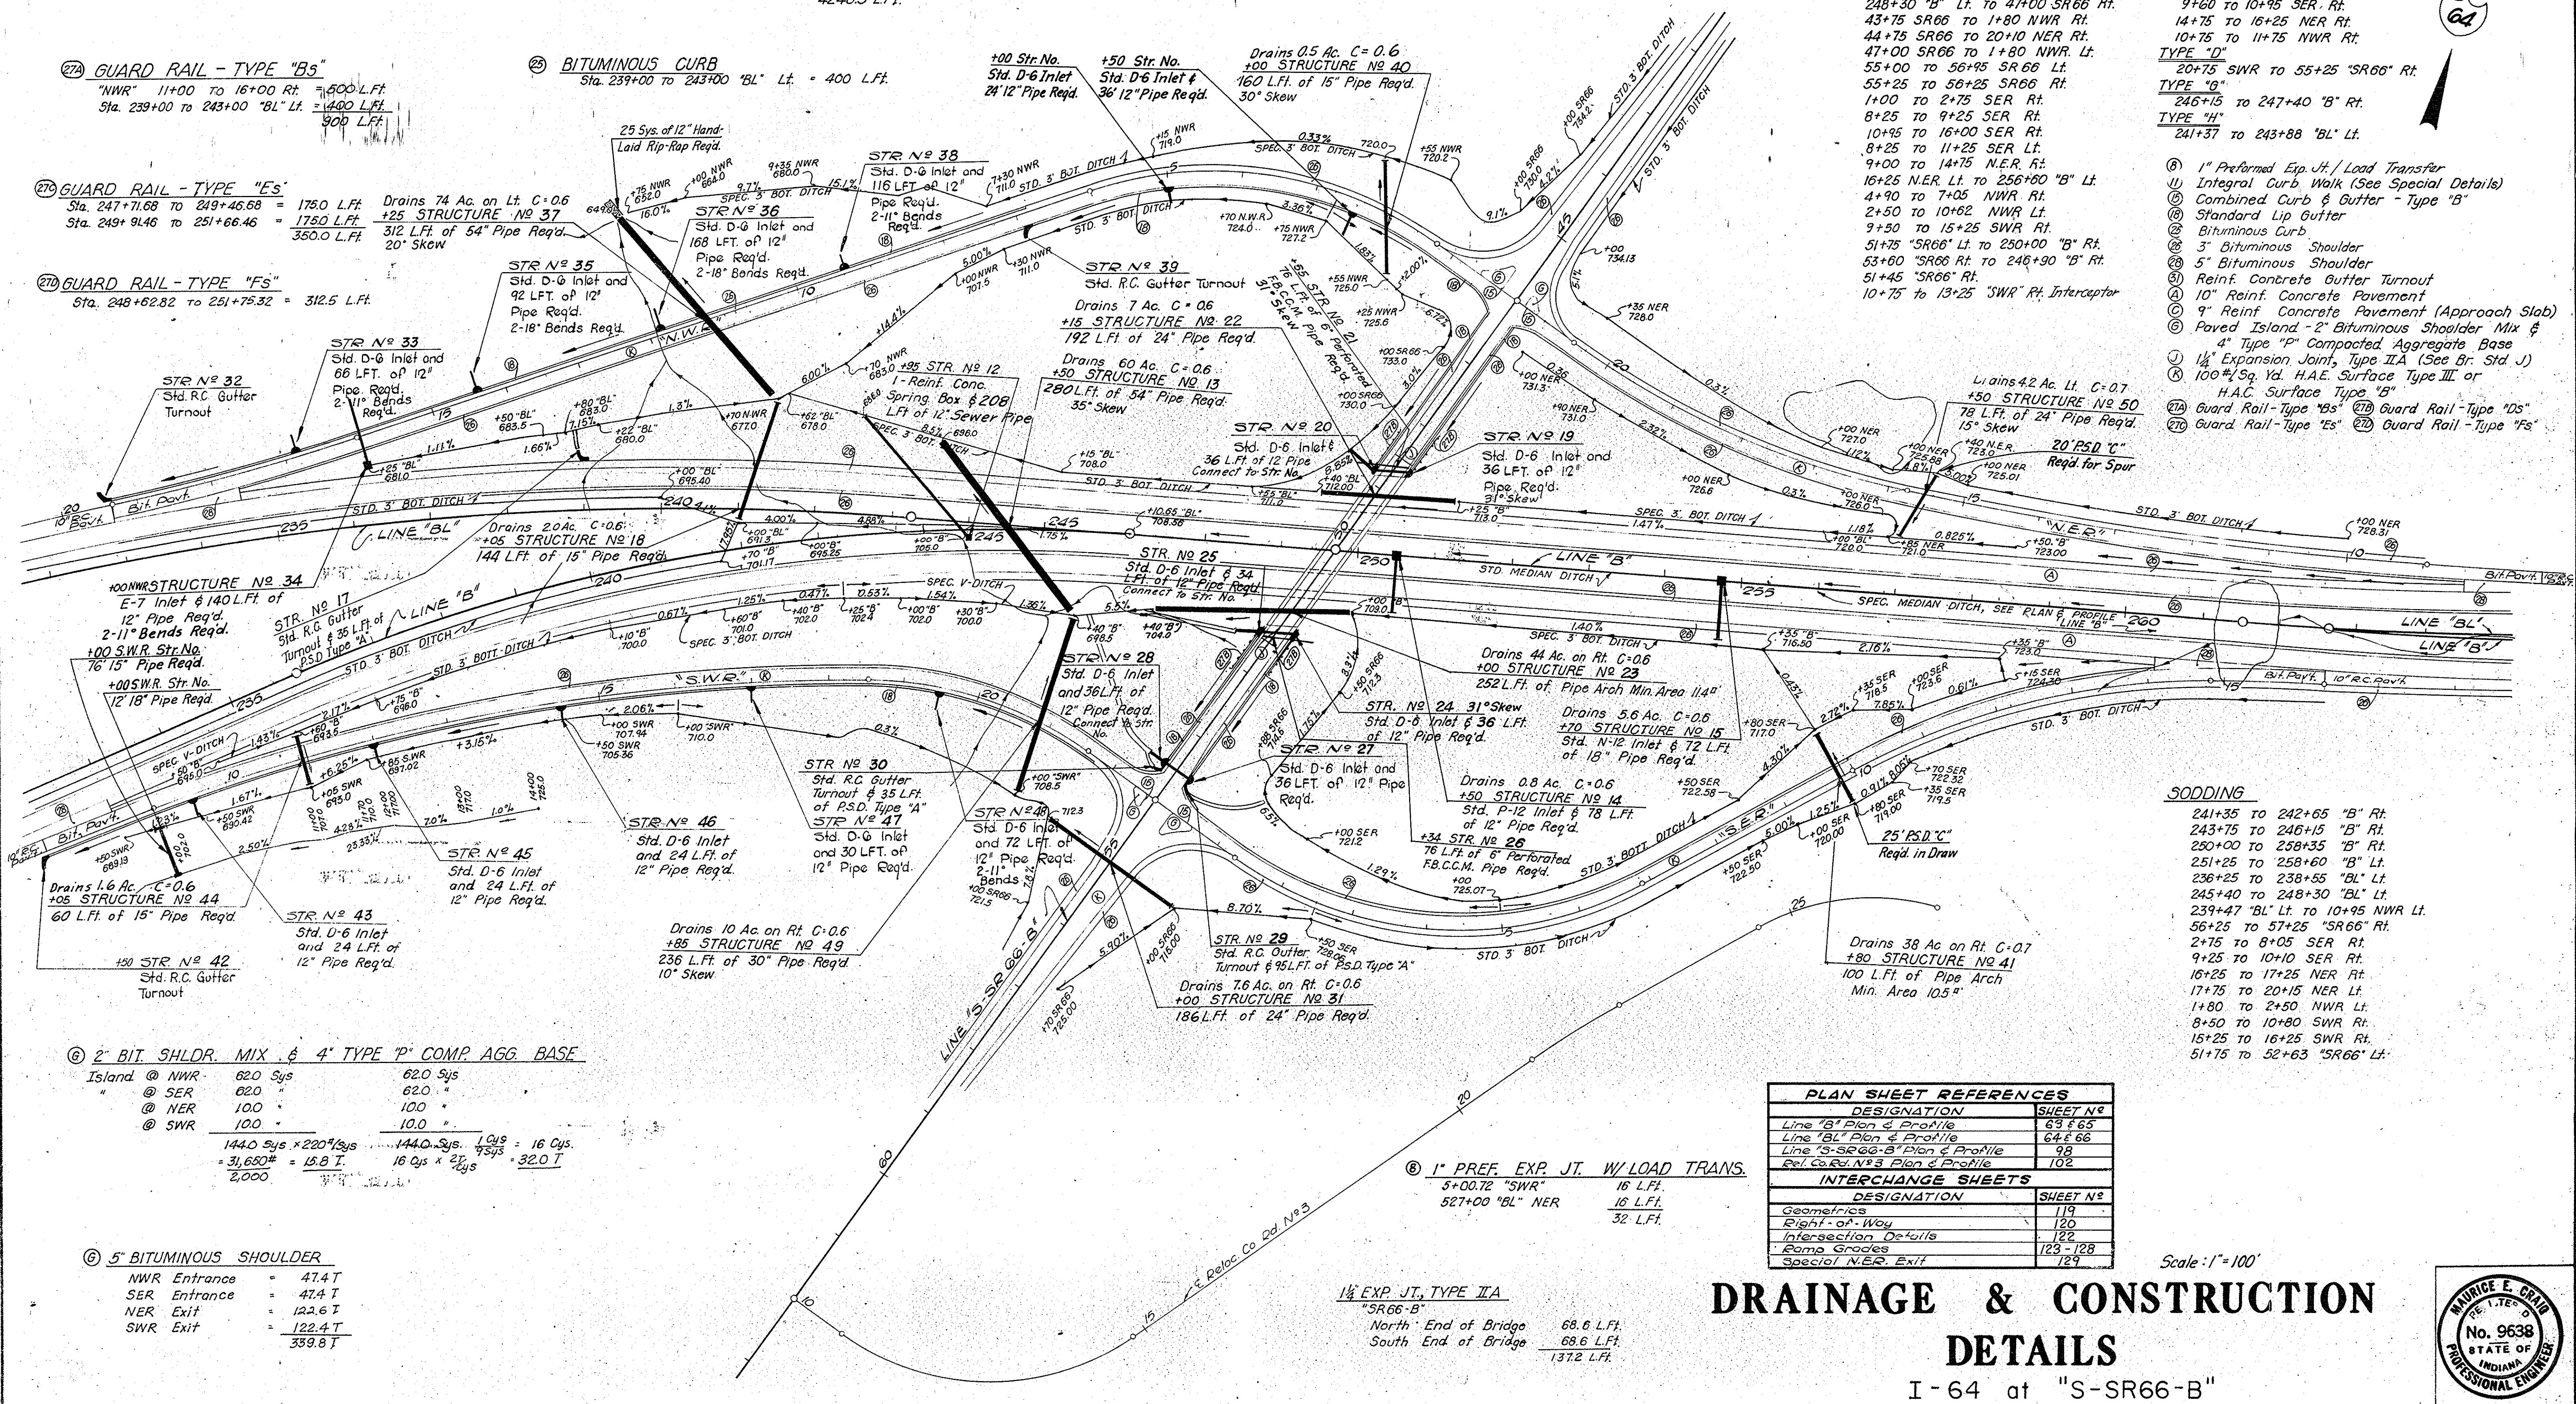

SODDING
 241+35 to 242+65 "B" Rt.
 243+75 to 246+15 "B" Rt.
 250+00 to 258+35 "B" Rt.
 251+25 to 258+60 "B" Lt.
 236+25 to 238+55 "BL" Lt.
 245+40 to 248+30 "BL" Lt.
 239+47 "BL" Lt. to 10+95 N.W.R. Lt.
 56+25 to 57+25 "SR66" Rt.
 2+75 to 8+05 S.E.R. Rt.
 9+25 to 10+10 S.E.R. Rt.
 16+25 to 17+25 N.E.R. Rt.
 17+75 to 20+15 N.E.R. Lt.
 1+80 to 2+50 N.W.R. Lt.
 8+50 to 10+80 S.W.R. Rt.
 15+25 to 16+25 S.W.R. Rt.
 51+75 to 52+63 "SR66" Lt.

⑥ 2" BIT. SHLDR. MIX. & 4" TYPE "P" COMP. AGG. BASE
 Island @ NWR 62.0 Sys 62.0 Sys
 " " " @ SER 62.0 " 62.0 " "
 " " " @ NER 100 " 100 " "
 " " " @ SWR 100 " 100 " "
 144.0 Sys x 220' Sys = 144.0 Sys. 1 Cys = 16 Cys.
 = 31,680# = 15.8 T. 16 Cys x 25' Cys = 32.0 T.
 2,000

⑤ 5" BITUMINOUS SHOULDER
 NWR Entrance = 47.4 T
 SER Entrance = 47.4 T
 NER Exit = 122.6 T
 SWR Exit = 122.4 T
 359.8 T

⑥ 1" PREF. EXP. JT. W/ LOAD TRANS.
 5+00.72 "SWR" 16 L.Ft.
 527+00 "BL" NER 16 L.Ft.
 32 L.Ft.


1/2 EXP. JT. TYPE I/A
 "SR66-B"
 North End of Bridge 68.6 L.Ft.
 South End of Bridge 68.6 L.Ft.
 137.2 L.Ft.

PLAN SHEET REFERENCES	
DESIGNATION	SHEET NO.
Line "B" Plan & Profile	63 & 65
Line "BL" Plan & Profile	64 & 66
Line "S-SR66-B" Plan & Profile	98
Ref. Co. Rd. No. 3 Plan & Profile	102
INTERCHANGE SHEETS	
DESIGNATION	SHEET NO.
Geometrics	119
Right-of-Way	120
Intersection Details	122
Ramp Grades	123-128
Special N.E.R. Exit	129



DRAINAGE & CONSTRUCTION DETAILS

I-64 at "S-SR66-B"

Scale: 1" = 100'

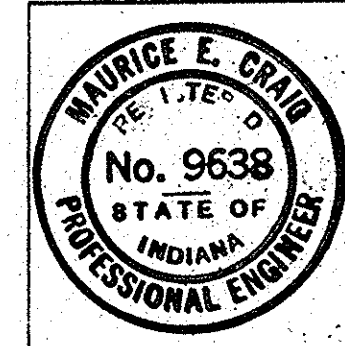

FEDERAL ROAD REGION NO.	STATE	PROJECT NO.	FISCAL YEAR	SHEET NO.	TOTAL SHEETS
4	IND.	I-64-3(33)86	1967	122	

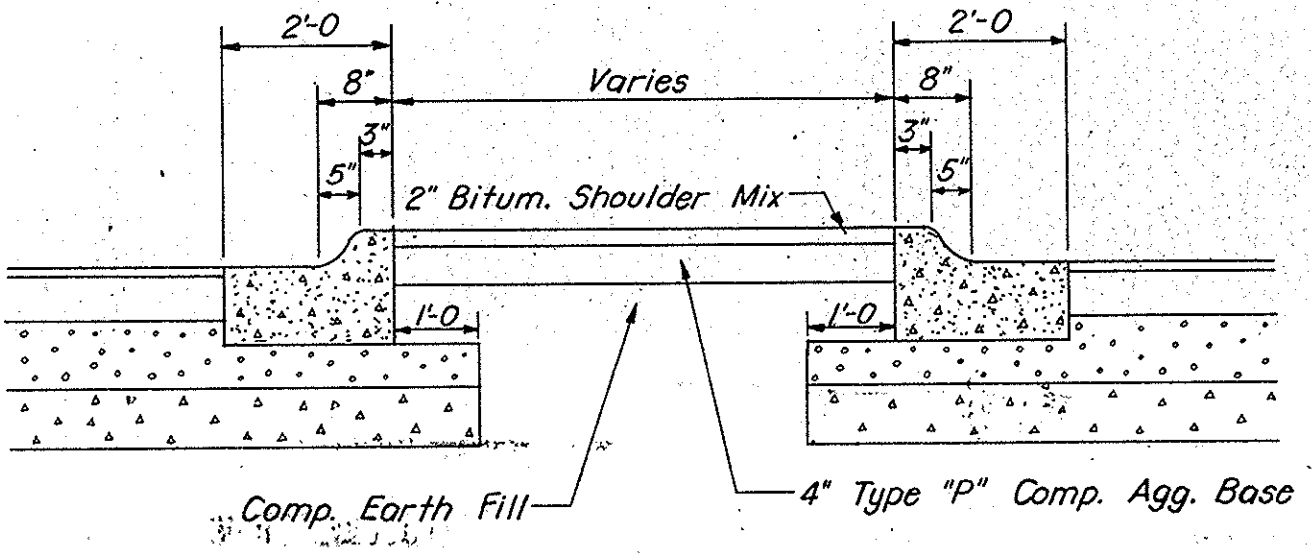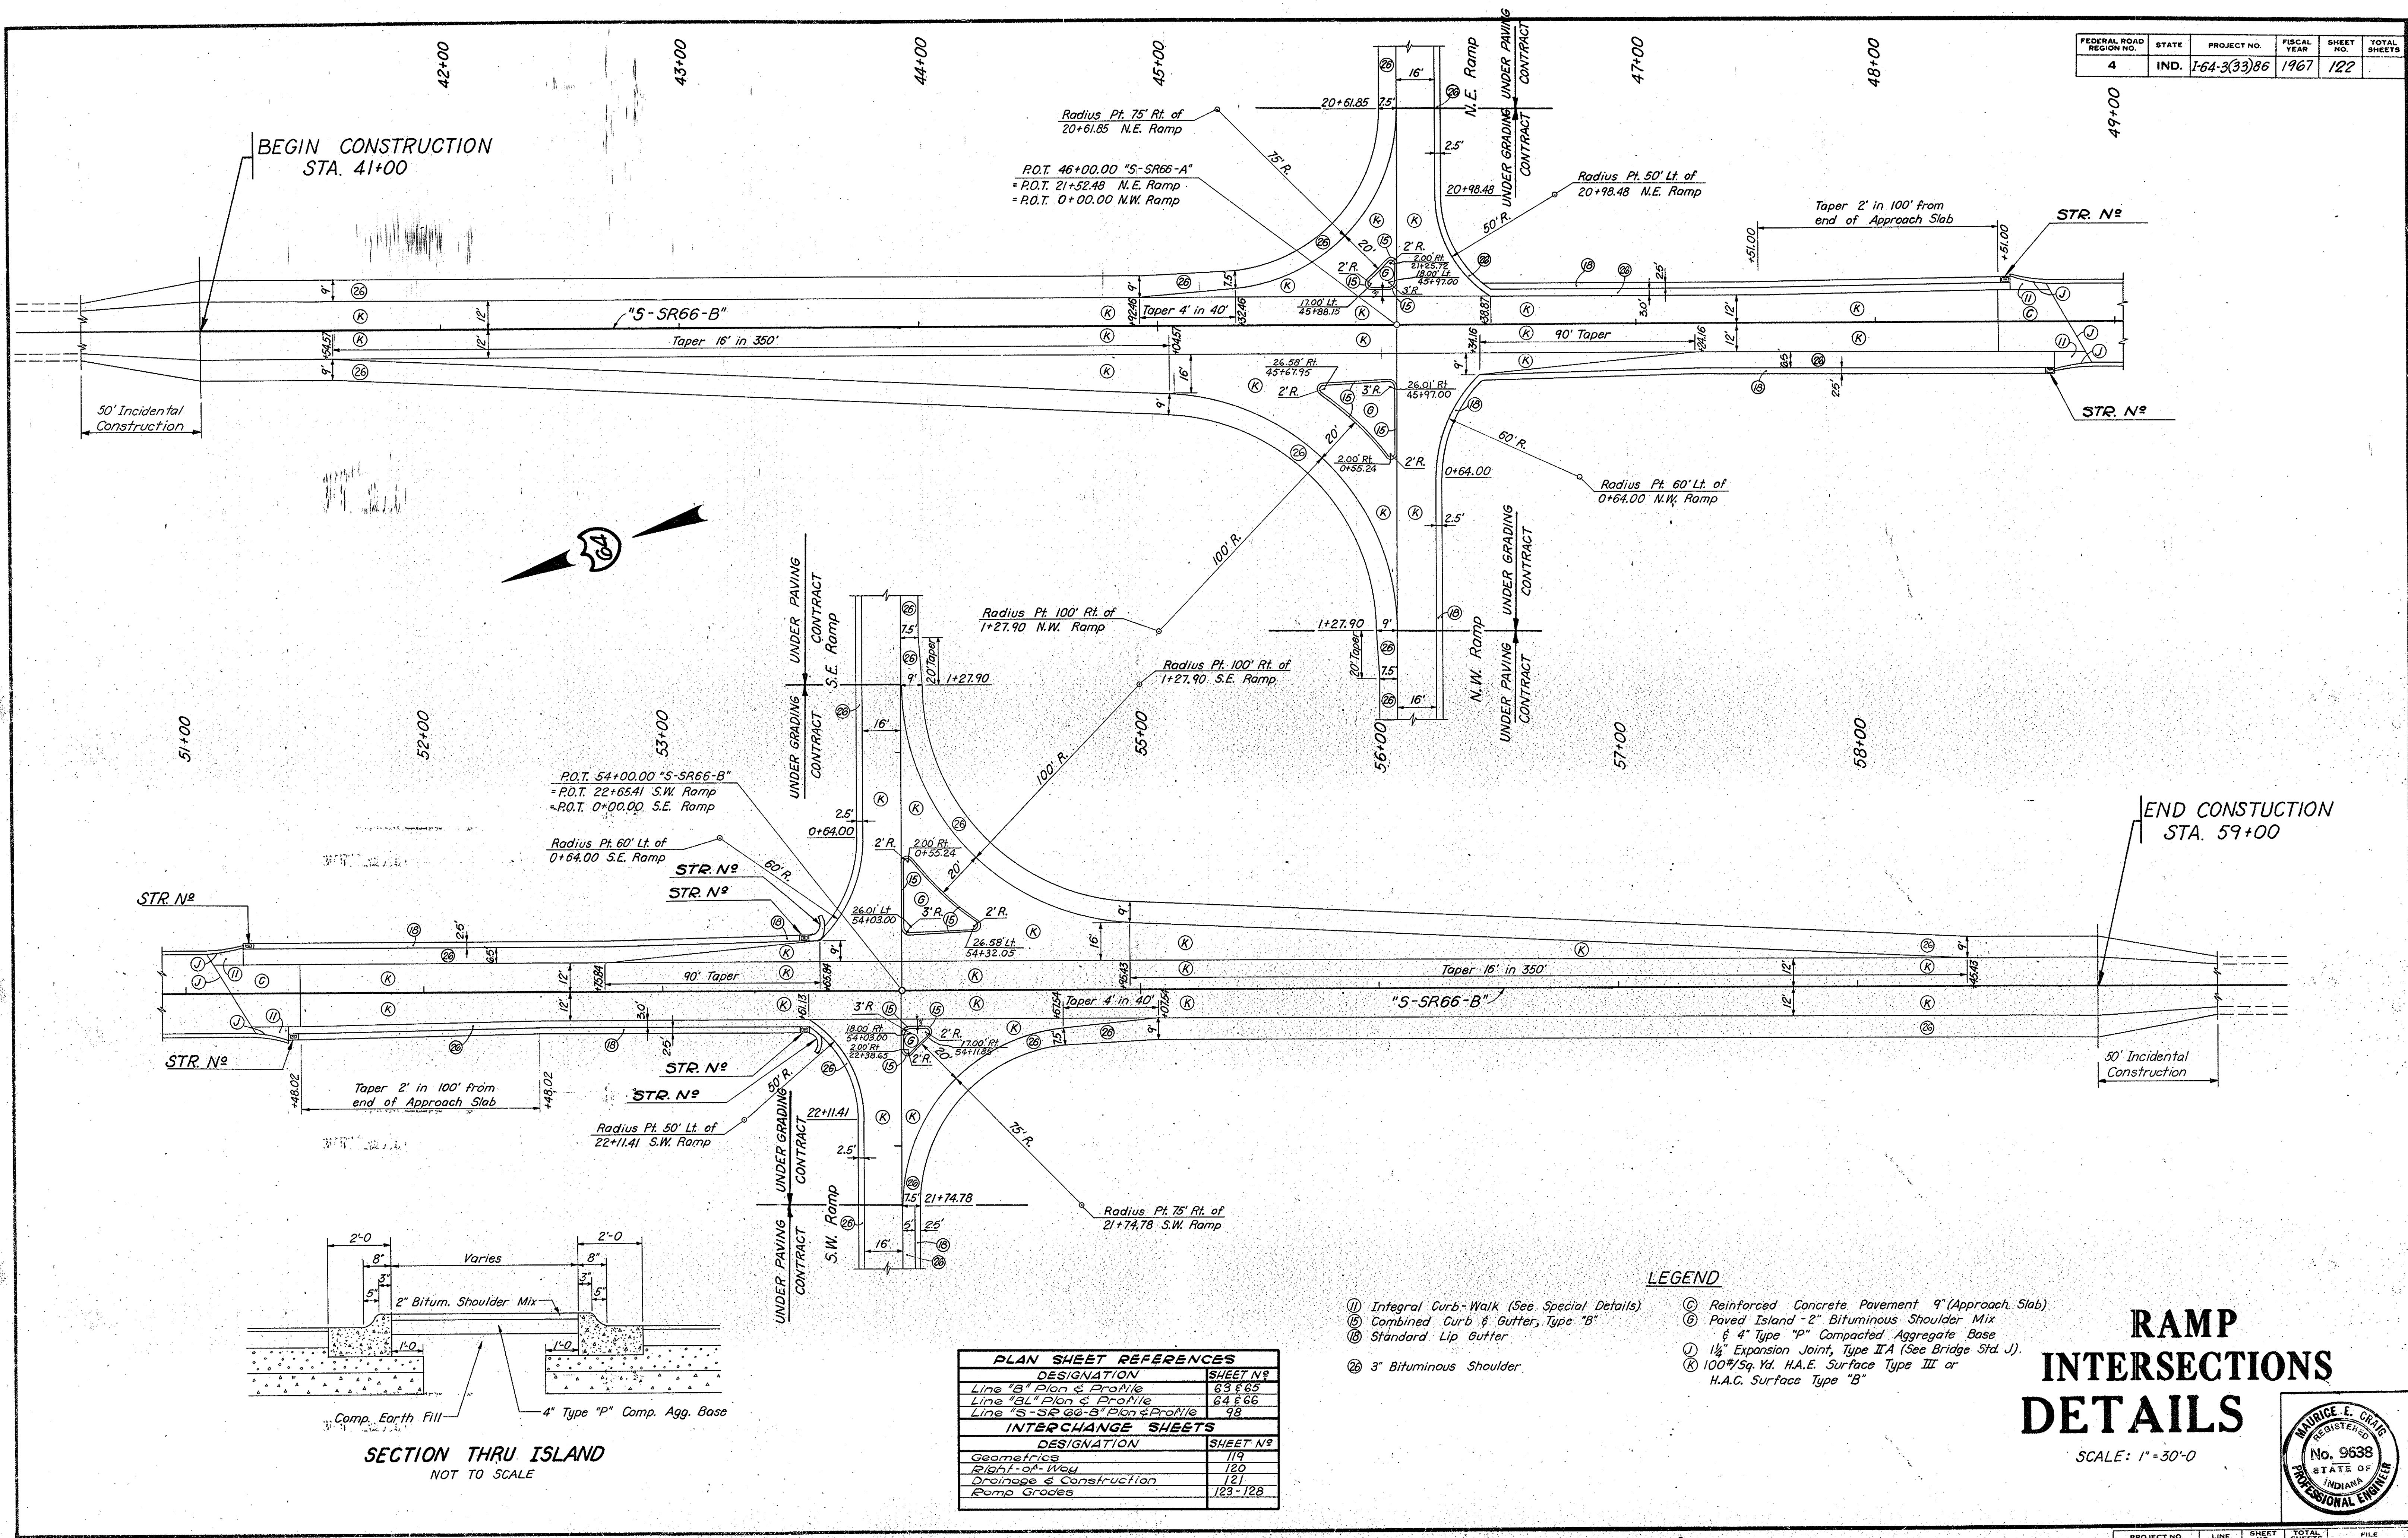


SECTION THRU ISLAND
NOT TO SCALE

PLAN SHEET REFERENCES	
DESIGNATION	SHEET NO.
Line "B" Plan & Profile	63 & 65
Line "BL" Plan & Profile	64 & 66
Line "S-SR66-B" Plan & Profile	98
INTERCHANGE SHEETS	
DESIGNATION	SHEET NO.
Geometrics	119
Right-of-Way	120
Drainage & Construction	121
Ramp Grades	123-128

- LEGEND**
- (1) Integral Curb-Walk (See Special Details)
 - (2) Combined Curb & Gutter, Type "B"
 - (3) Standard Lip Gutter
 - (4) 3" Bituminous Shoulder
 - (5) Reinforced Concrete Pavement 9" (Approach Slab)
 - (6) Paved Island - 2" Bituminous Shoulder Mix & 4" Type "P" Compacted Aggregate Base
 - (7) 1 1/2" Expansion Joint, Type II A (See Bridge Std. J)
 - (8) 100#/Sq Yd. H.A.E. Surface Type III or H.A.C. Surface Type "B"

RAMP INTERSECTIONS DETAILS


SCALE: 1" = 30'-0"

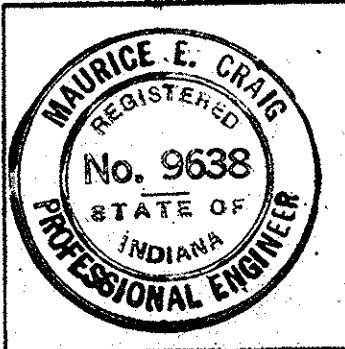


November 6, 1961

PROJECT NO.	LINE	SHEET NO.	TOTAL SHEETS	FILE
I-64-3(33)86	S-SR66-B	122		

CUT CROSS SECTIONS FILL
Scale: 1 inch = 10 feet

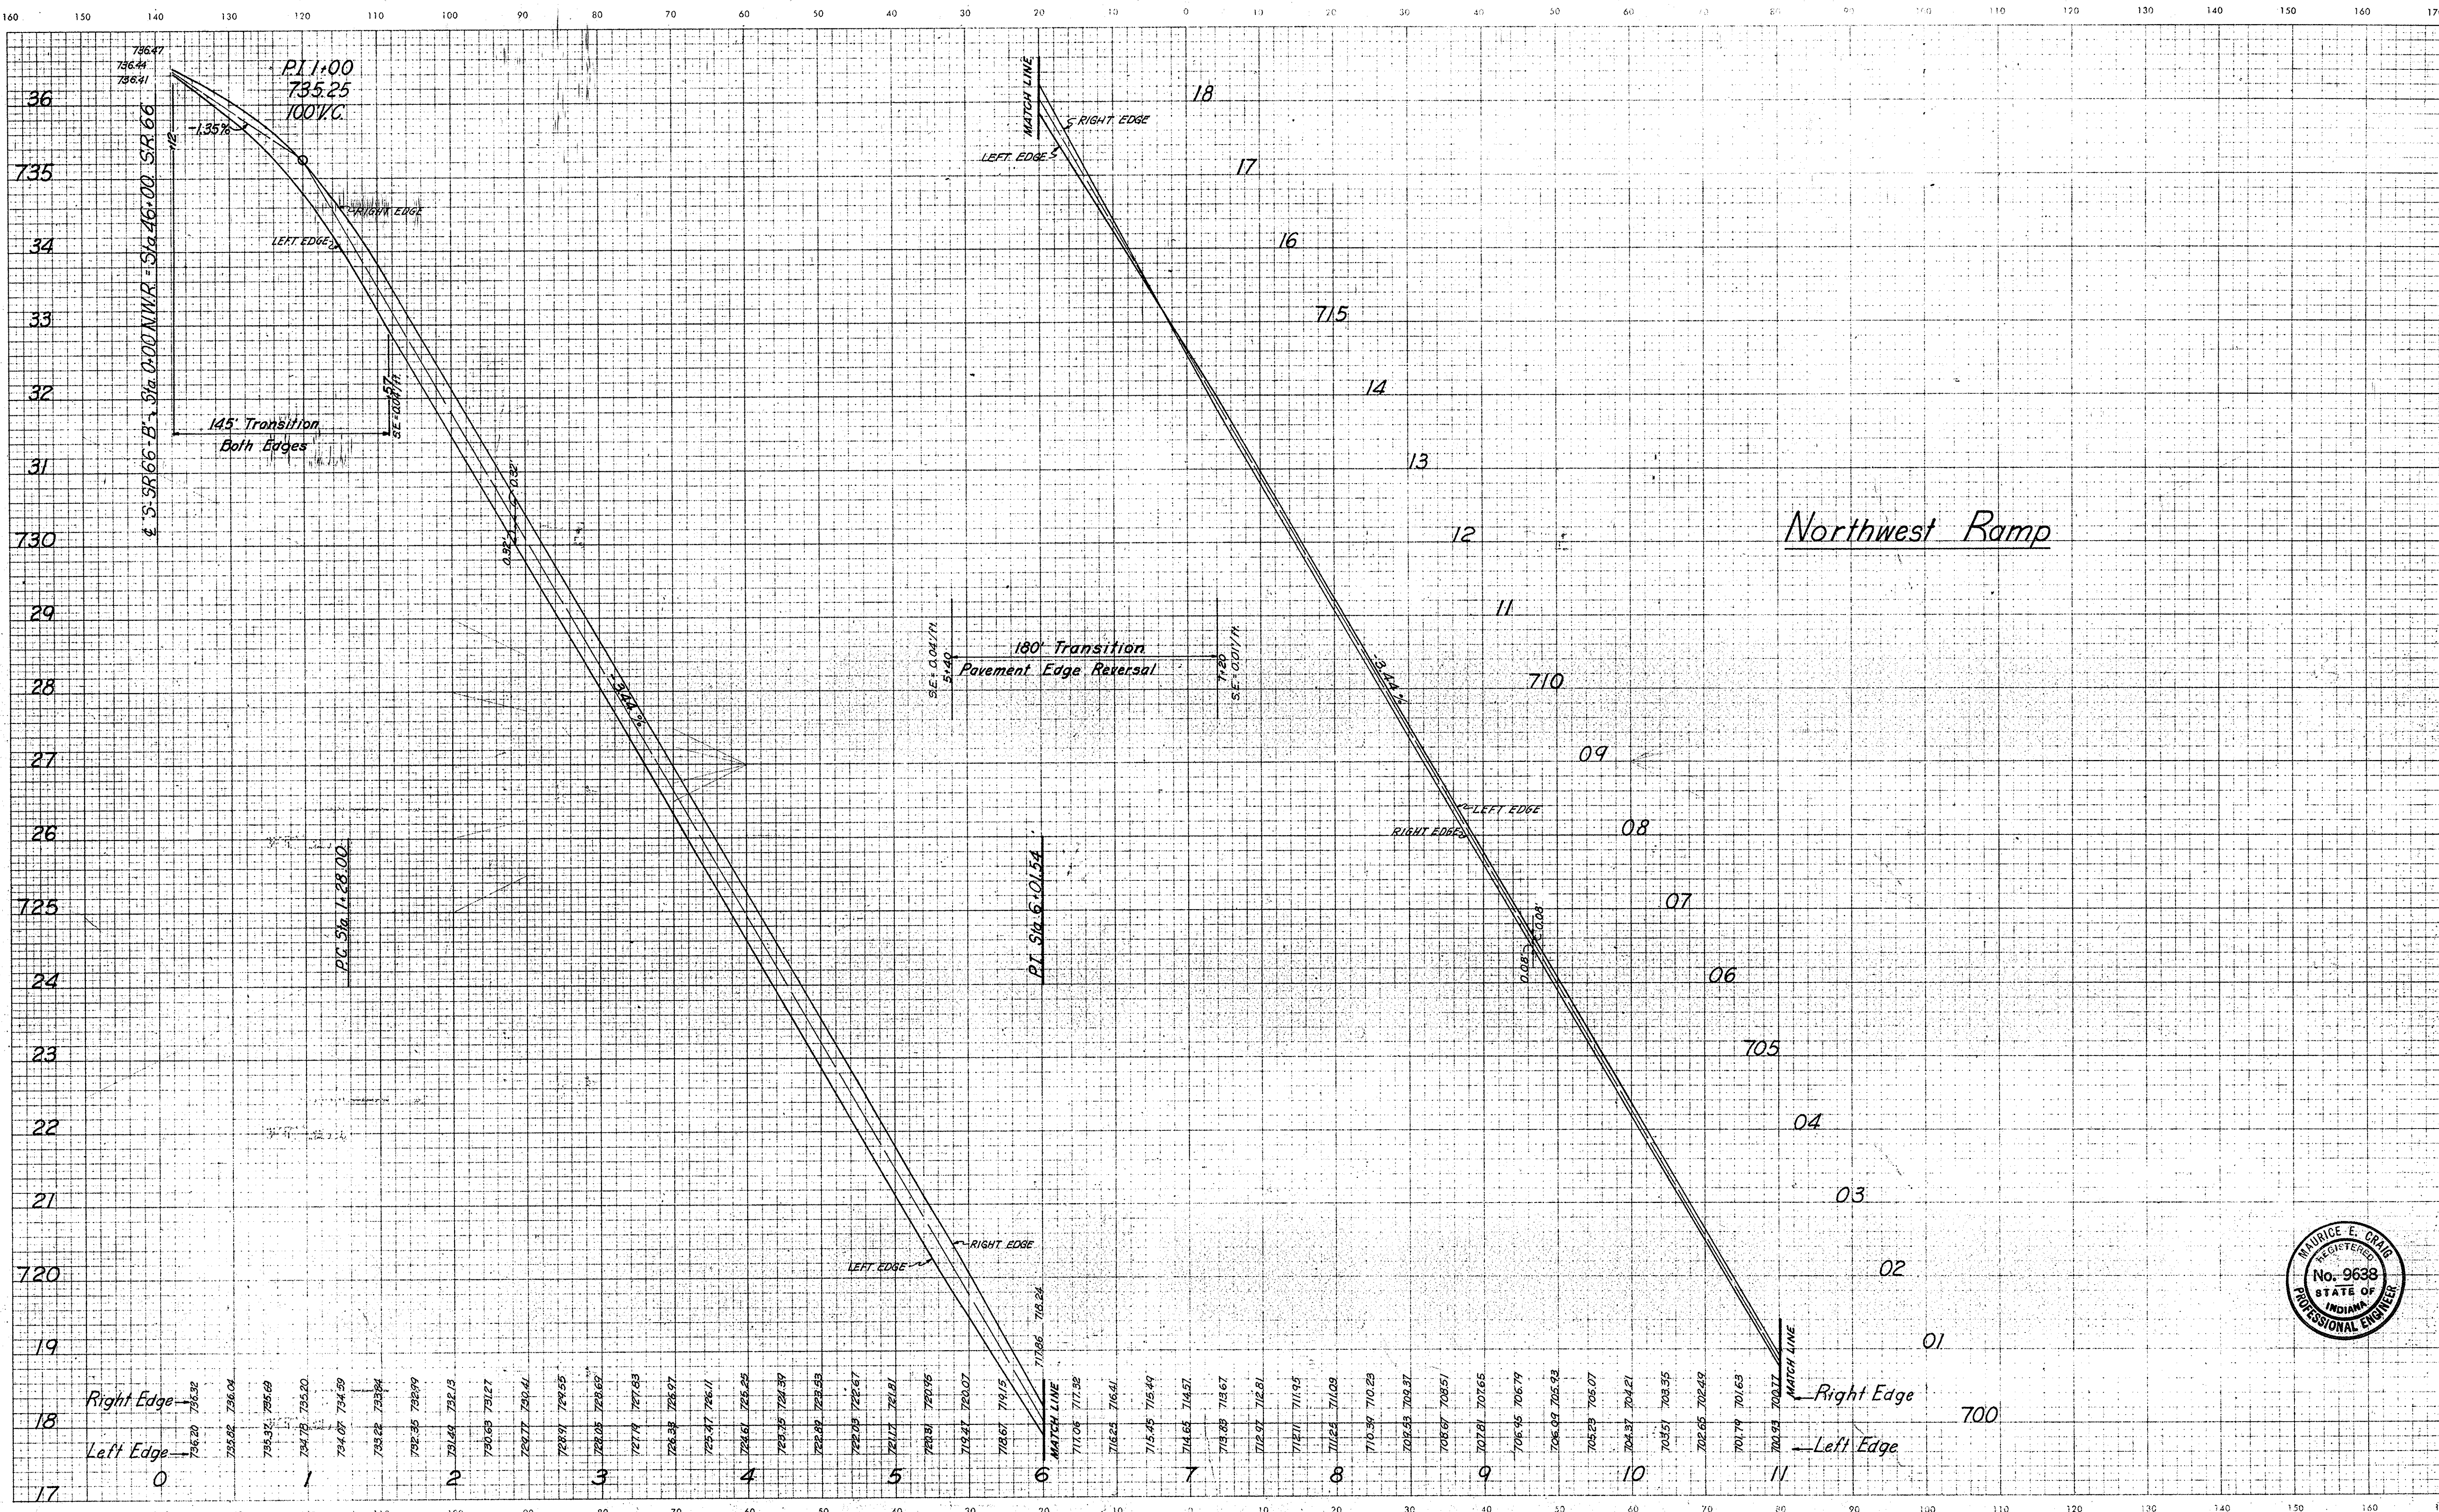


Northwest Ramp

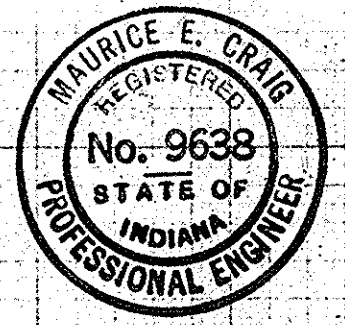

November 6, 1961


LEVEL BOOK NO.		FILE	
FEDERAL ROAD DISTRICT NO.	STATE	PROJECT NO.	FISCAL YEAR
4	IND.	I-64-3(33)86	1967
SHEET NO.		TOTAL SHEETS	
126		126	
S.R. 66 Interchange LINE N.W. Ramp			

CUT CROSS SECTIONS FILL
Scale 1 inch = 10 feet

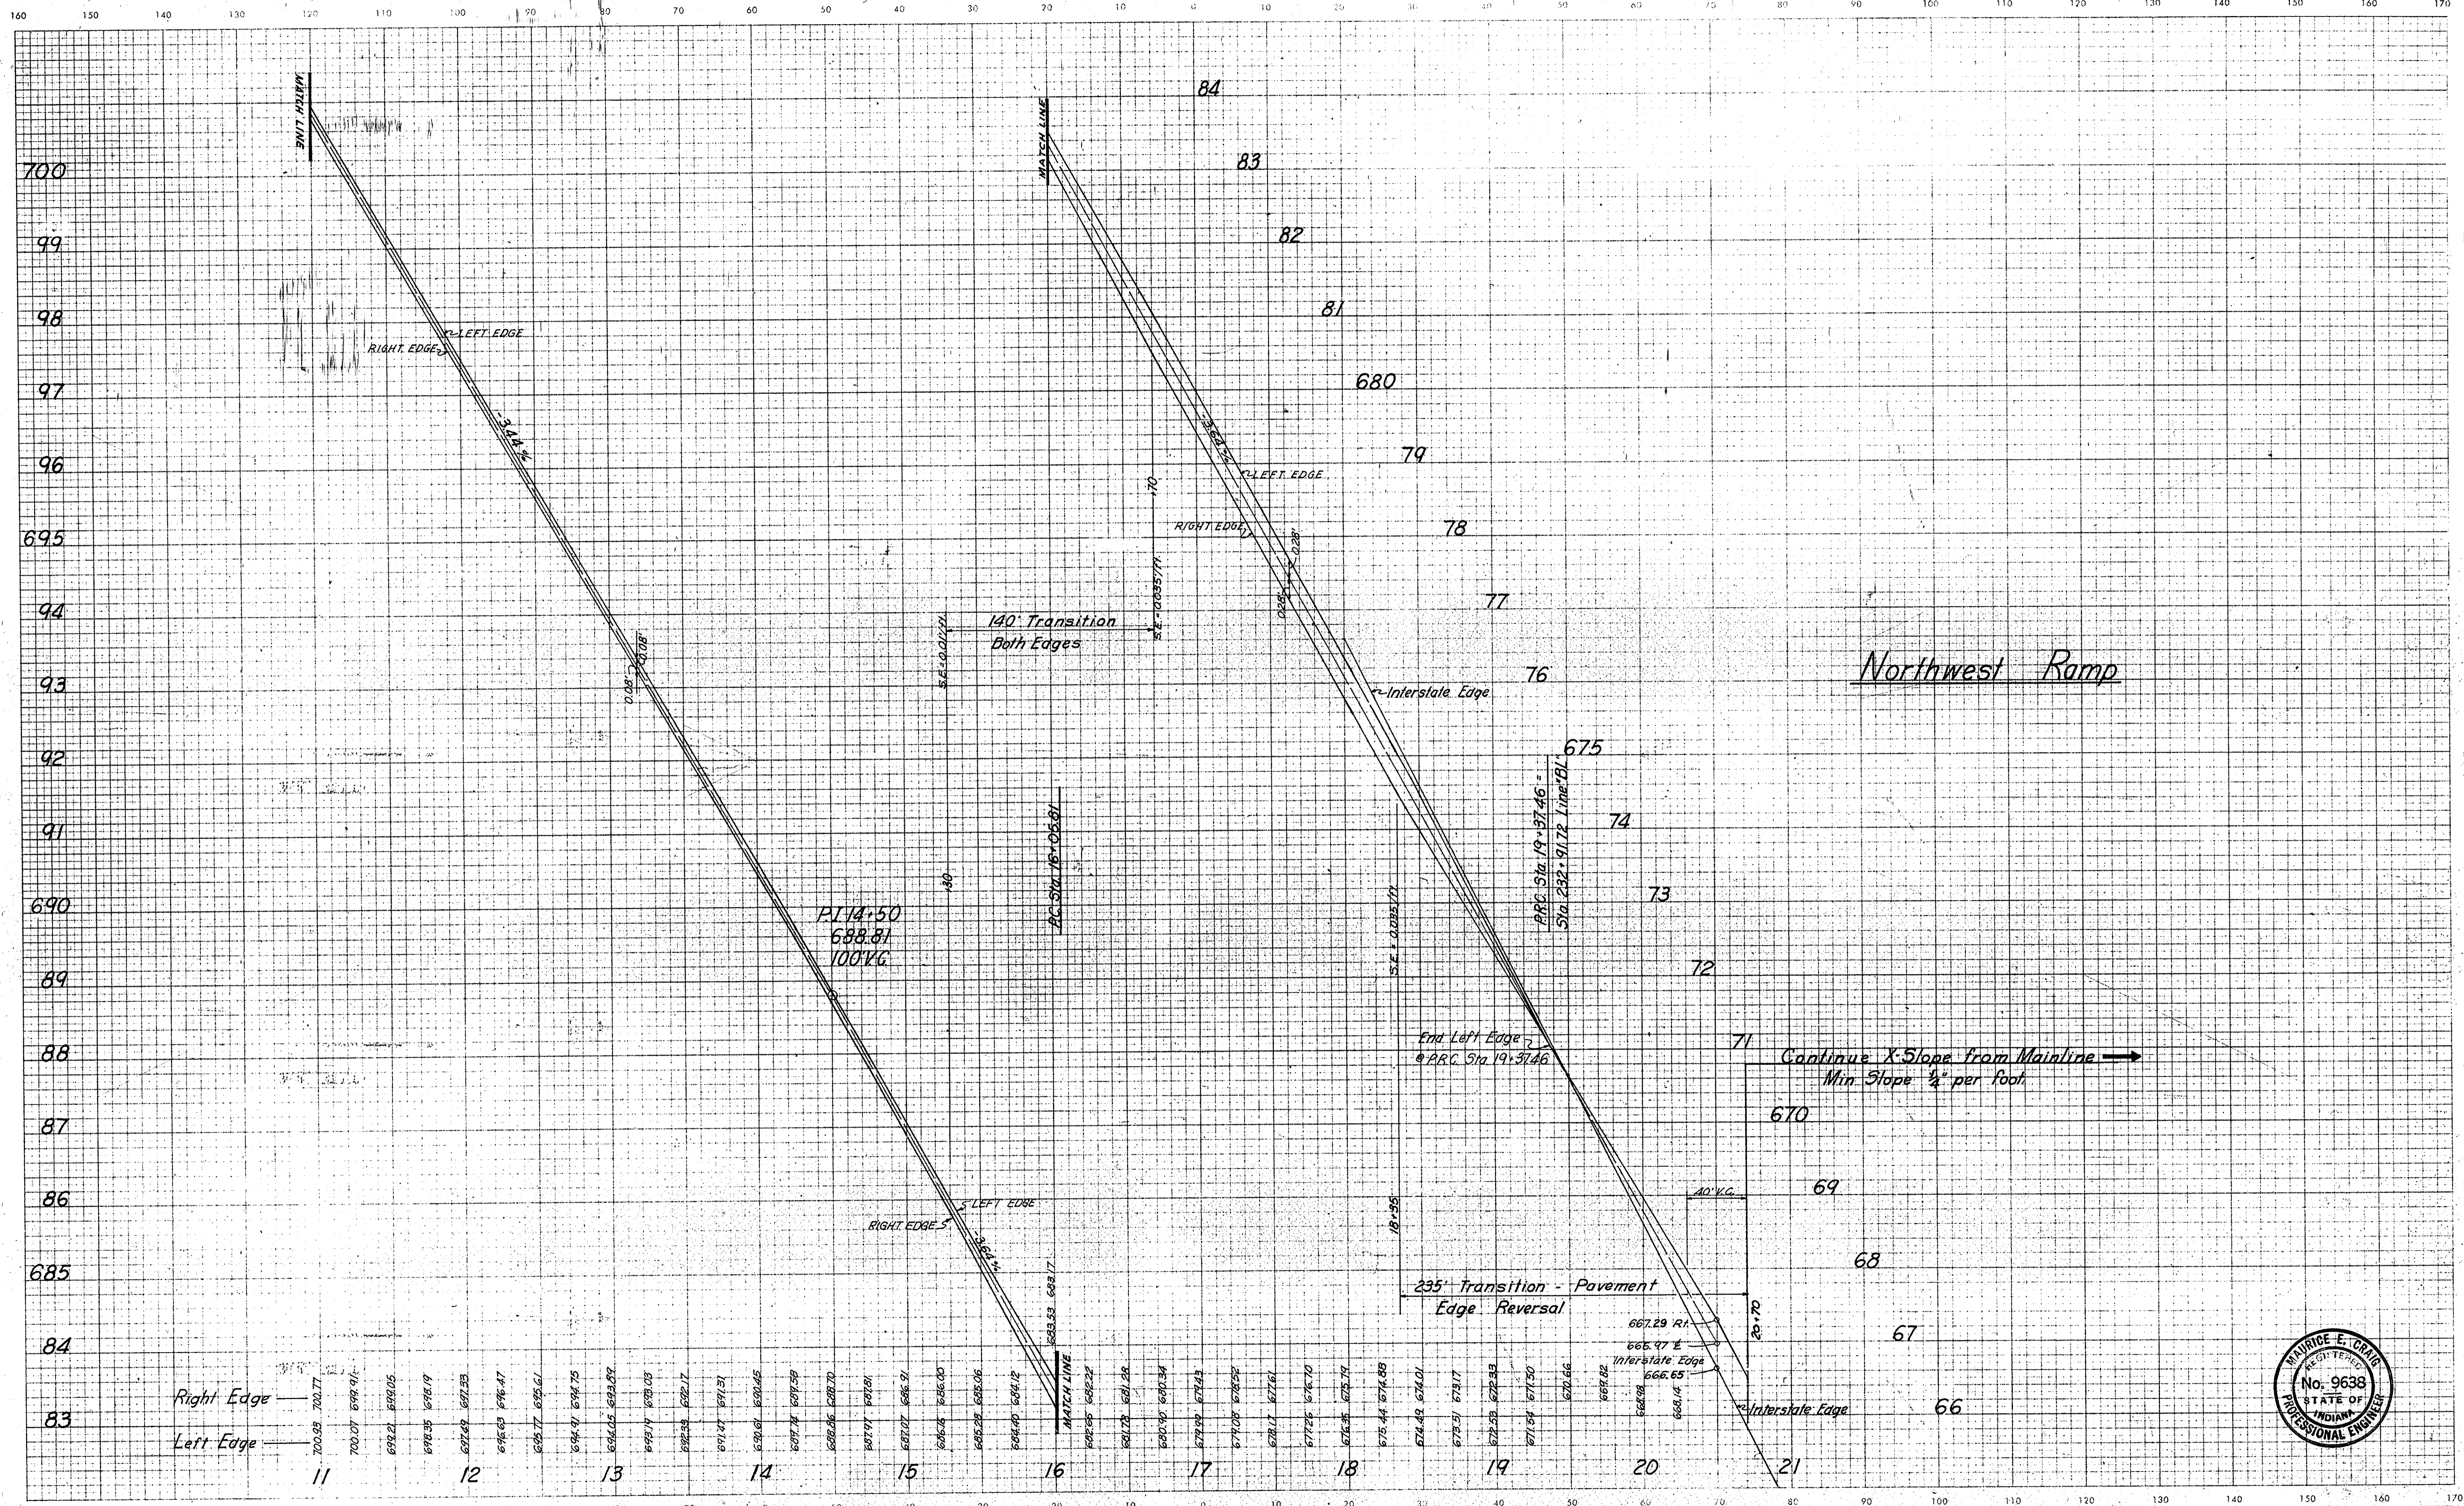


Right Edge	700.08	699.91	699.05	698.19	300.87	299.99	299.13	298.27	0.71	-0.15	-0.81	-1.47	-124.89	-12
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CUT CROSS SECTIONS FILL
Scale 1 inch = 10 feet

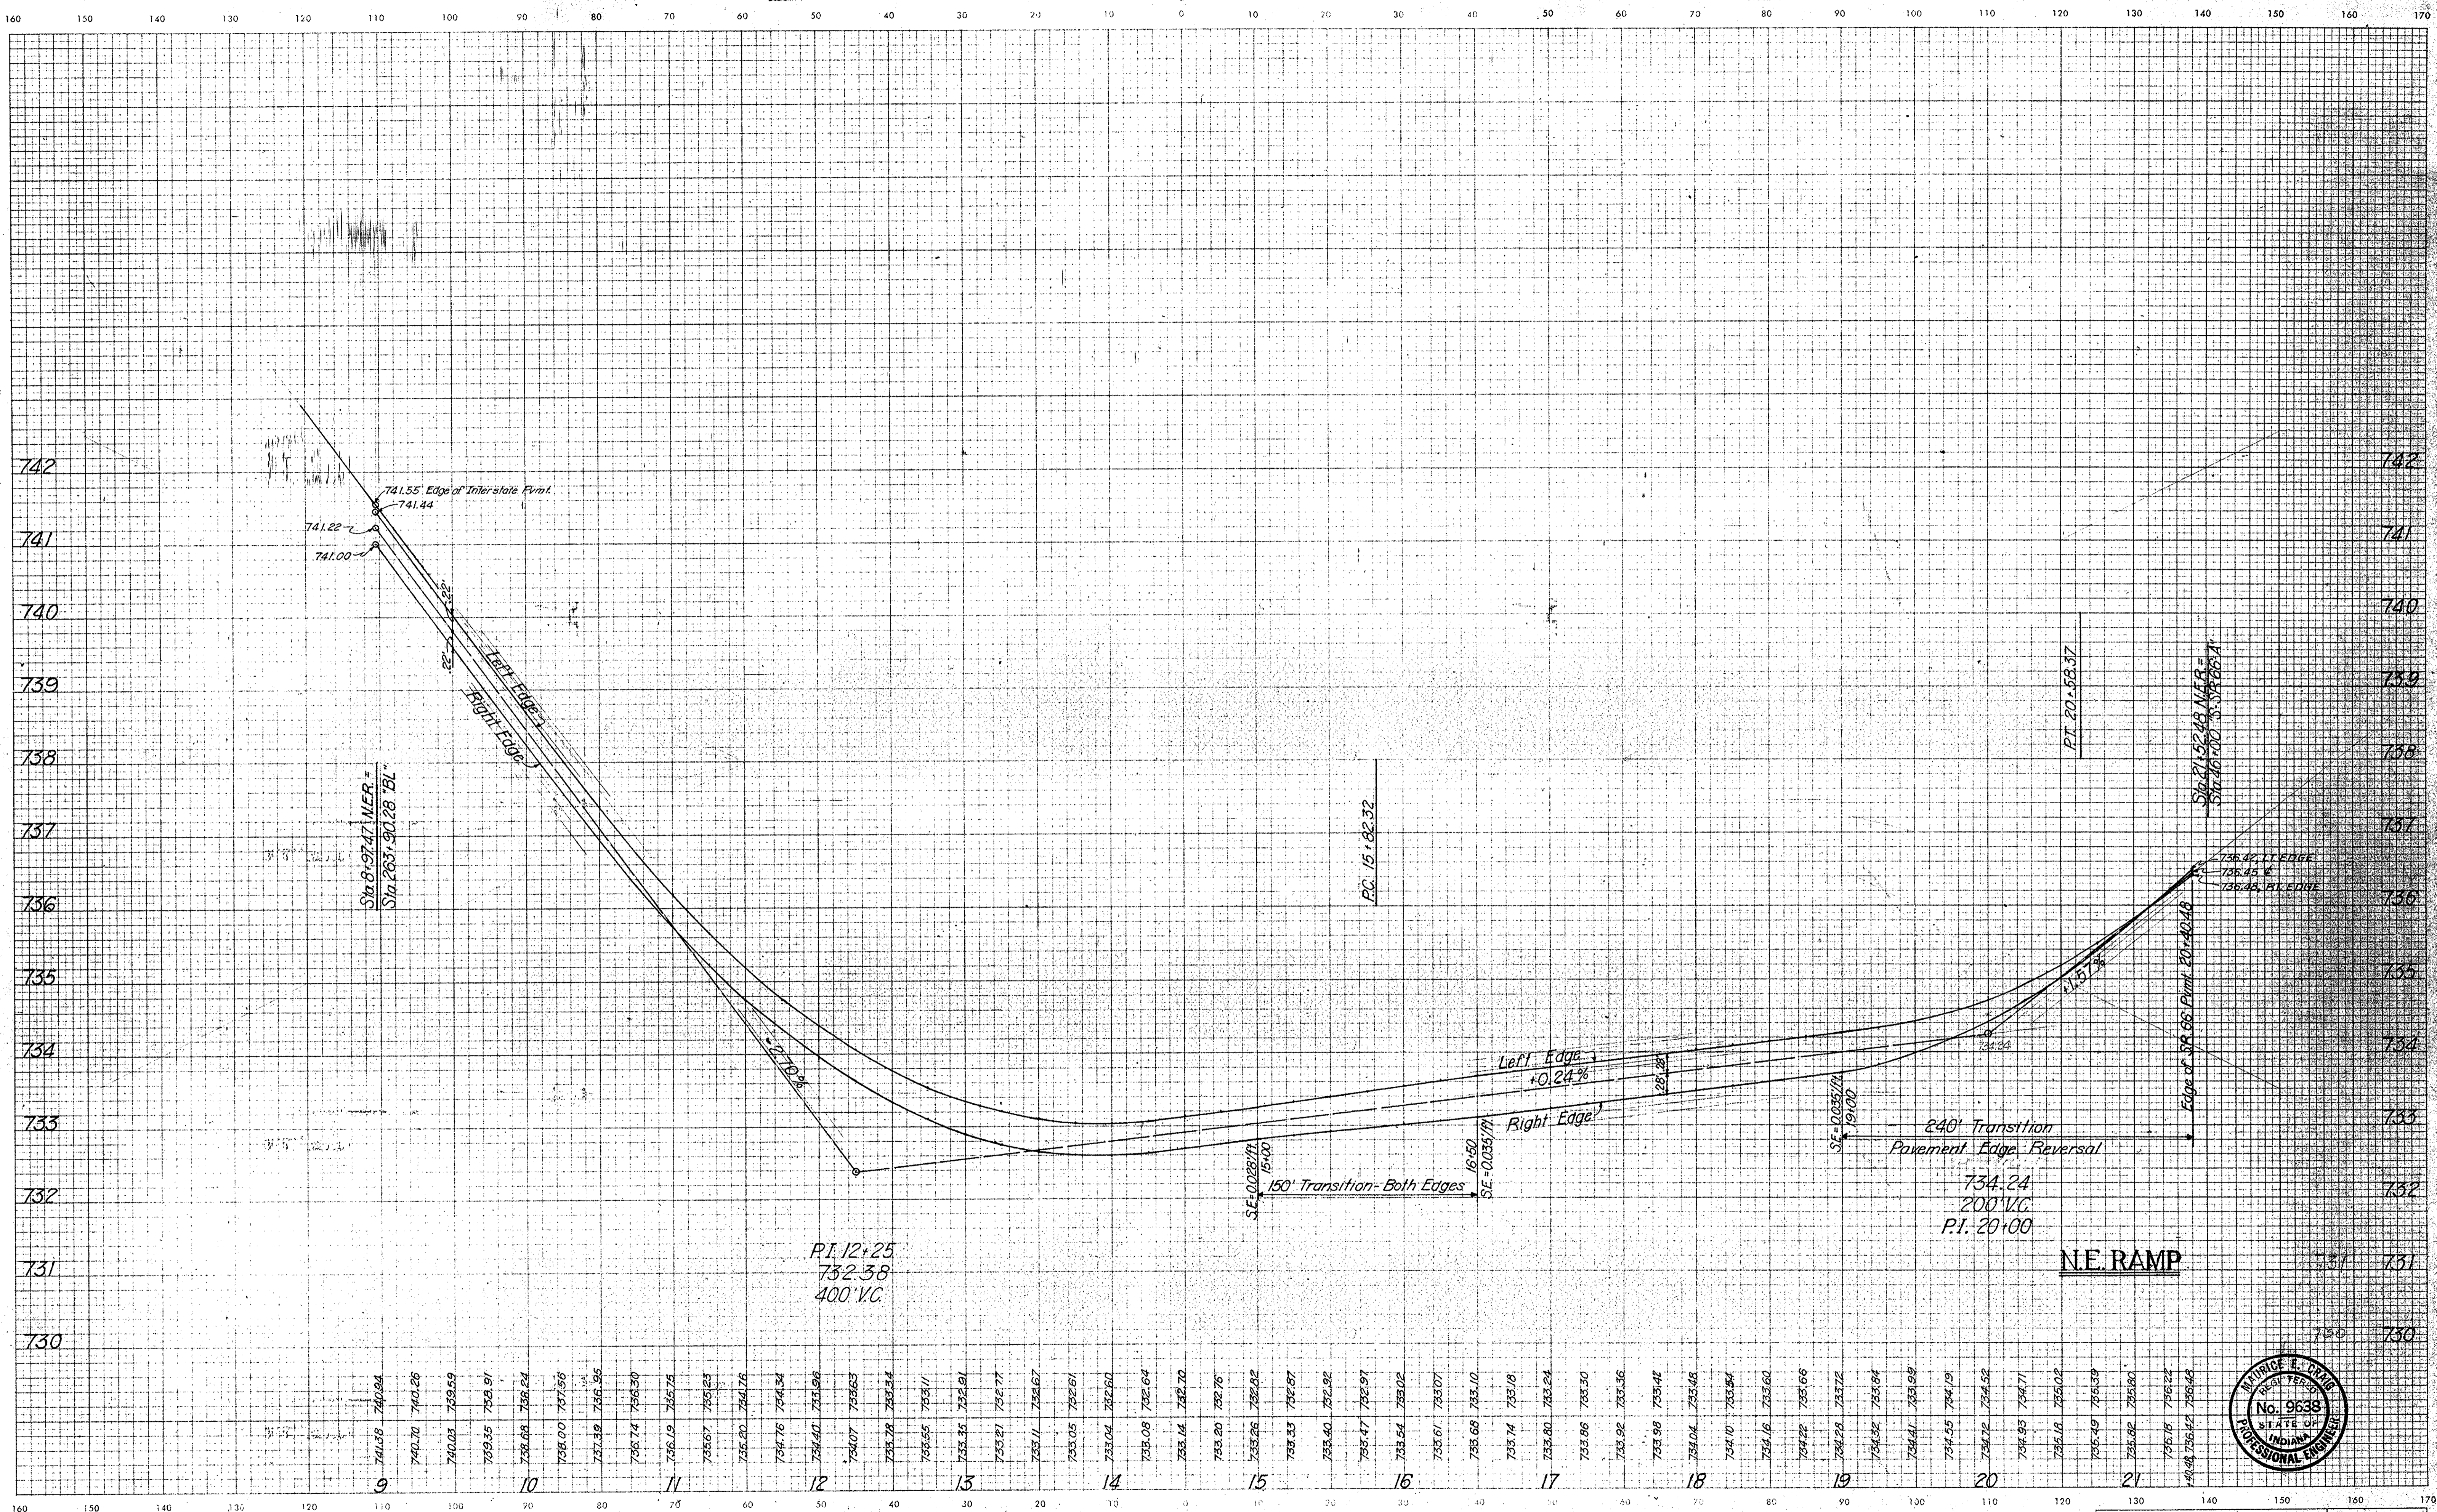

November 6, 1961


LEVEL BOOK NO.		FILE	
FEDERAL ROAD REGION NO.	STATE	PROJECT NO.	FISCAL YEAR
4	IND.	164333/86	1967
		SHEET NO.	TOTAL SHEETS
		128	

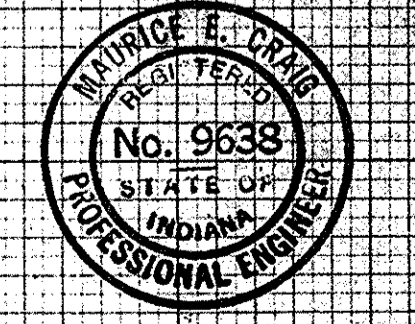

S.R. 66 Interchange LINE N.E. Ramp

FEDERAL ROAD DISTRICT NO.	STATE	PROJECT NO.	FISCAL YEAR	SHEET NO.	TOTAL SHEETS
4	IND.	I-64(33)86	1967	129	

Note:
For Continuation of N.E.R.
Line Data, See Sheet No. 119

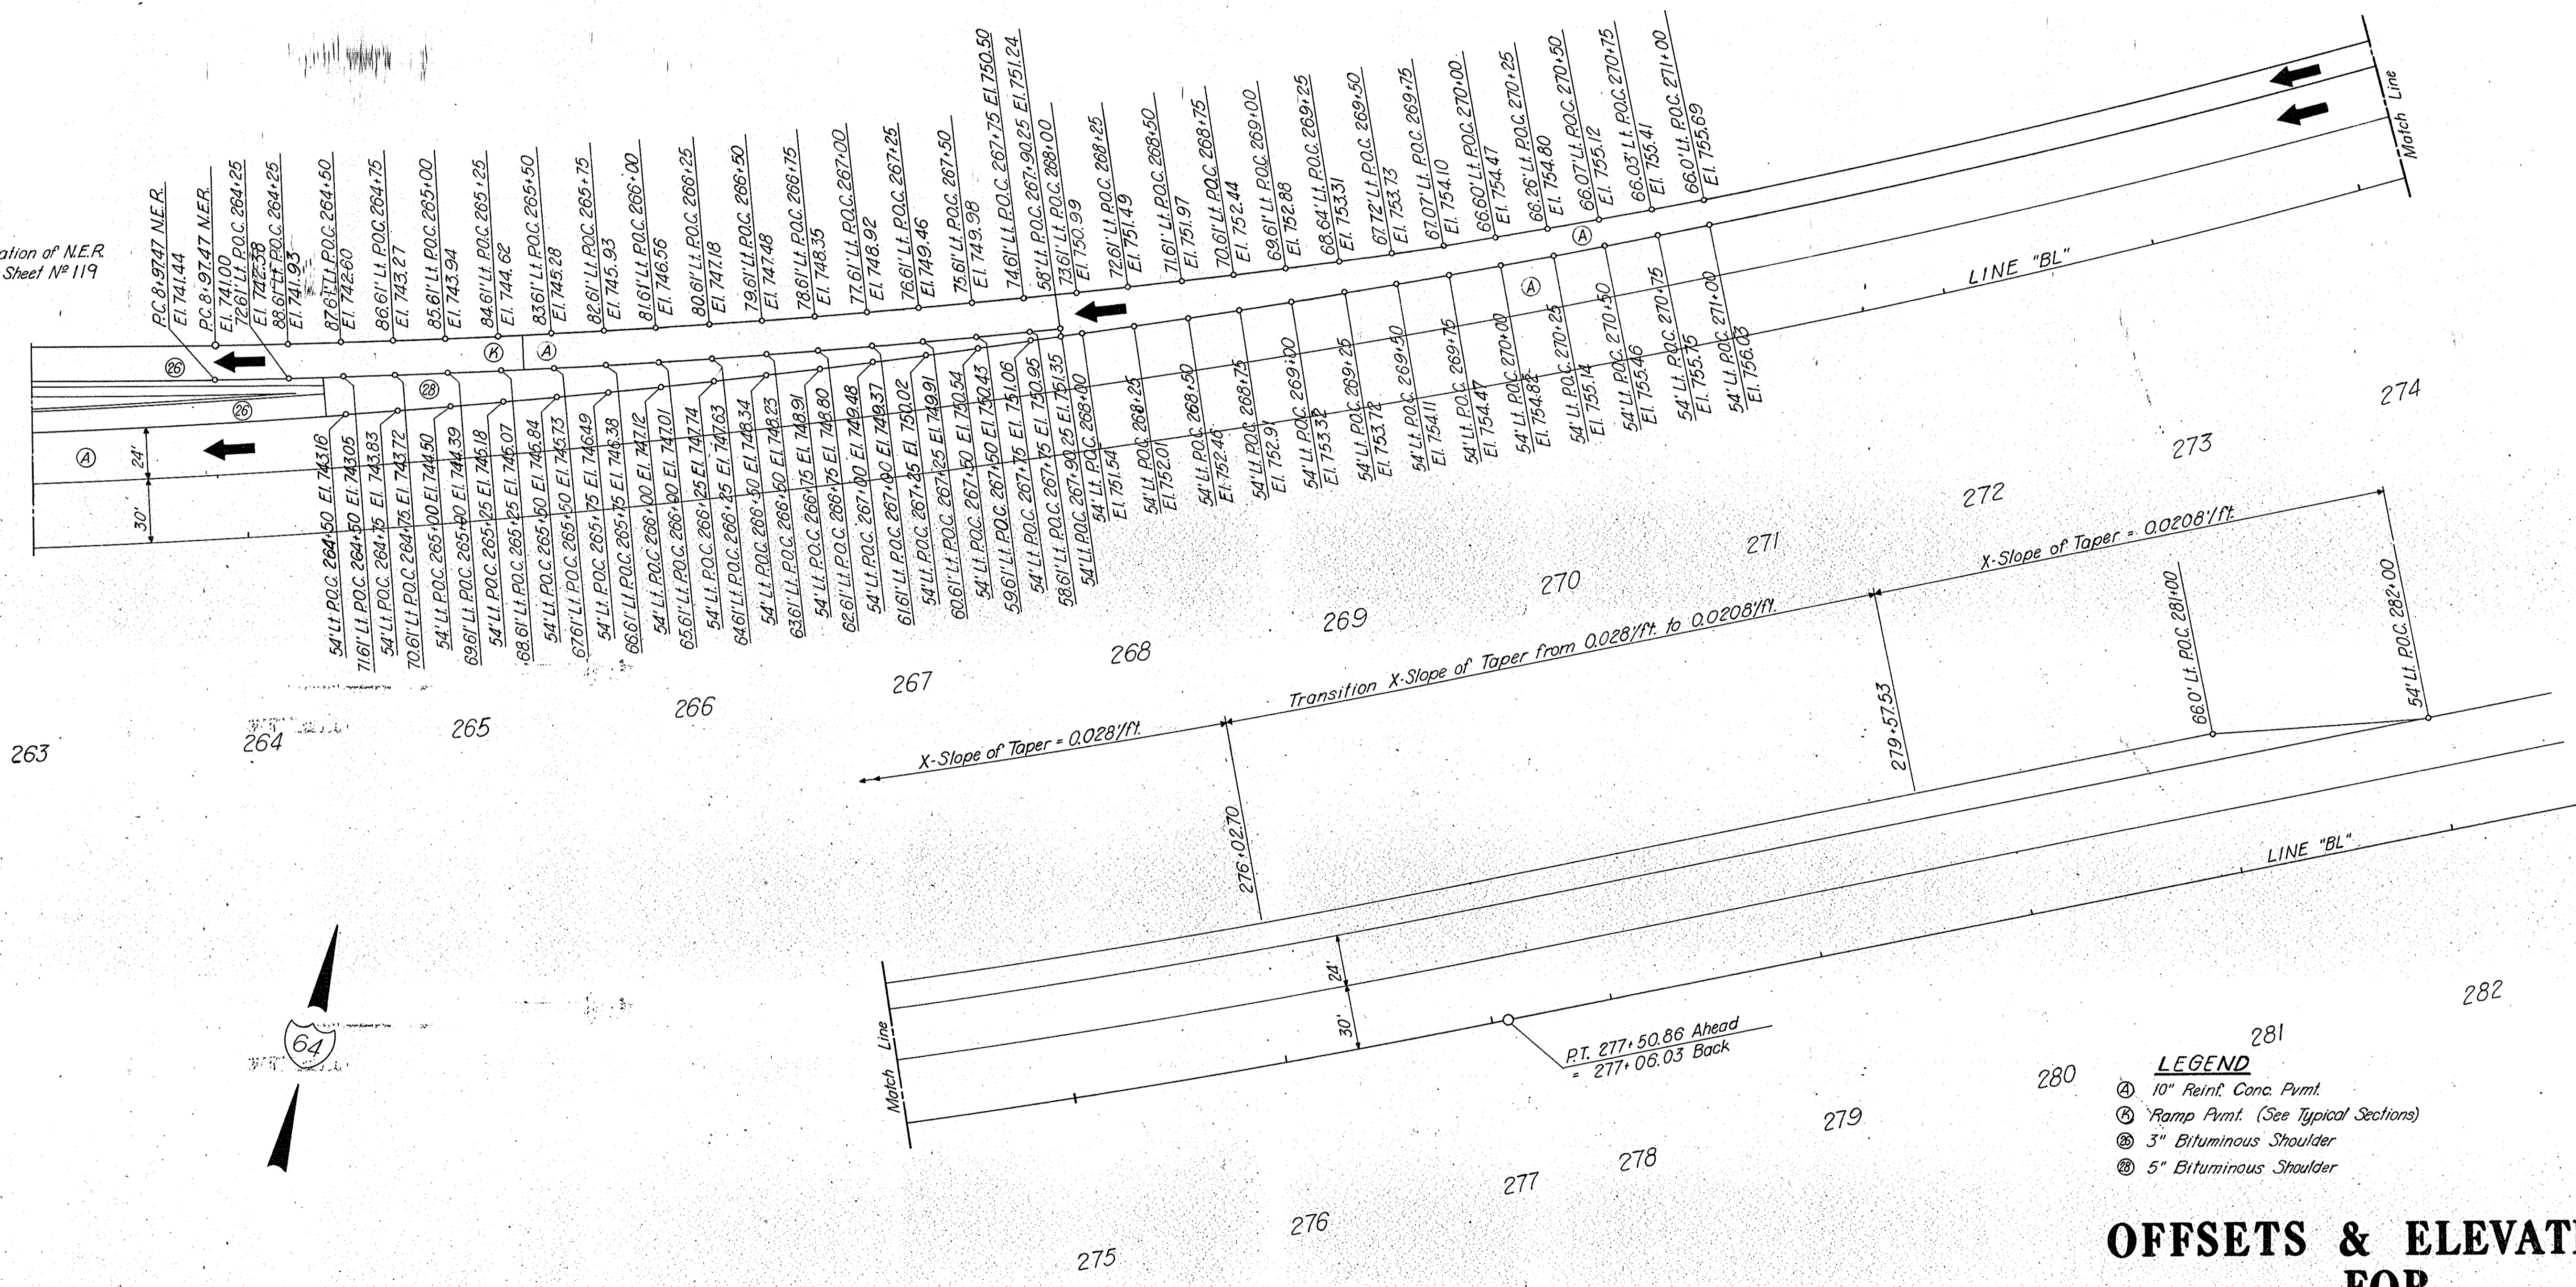

- LEGEND**
- Ⓐ 10" Reinf. Conc. Pymt.
 - Ⓑ Ramp Pymt. (See Typical Sections)
 - Ⓒ 3" Bituminous Shoulder
 - Ⓓ 5" Bituminous Shoulder



**OFFSETS & ELEVATIONS
FOR
SPECIAL N.E.R. EXIT
DETAILS**
SCALE: 1" = 40'
SR.66 INTERCHANGE




November 6, 1961

PROJECT NO.	LINE	SHEET NO.	TOTAL SHEETS	FILE
I-64(33)86	N.E.R.	129		

FEDERAL ROAD REGION NO.	STATE	PROJECT NO.	FISCAL YEAR	SHEET NO.	TOTAL SHEETS
4	IND.	F-64-3(33)86	1967	130	130

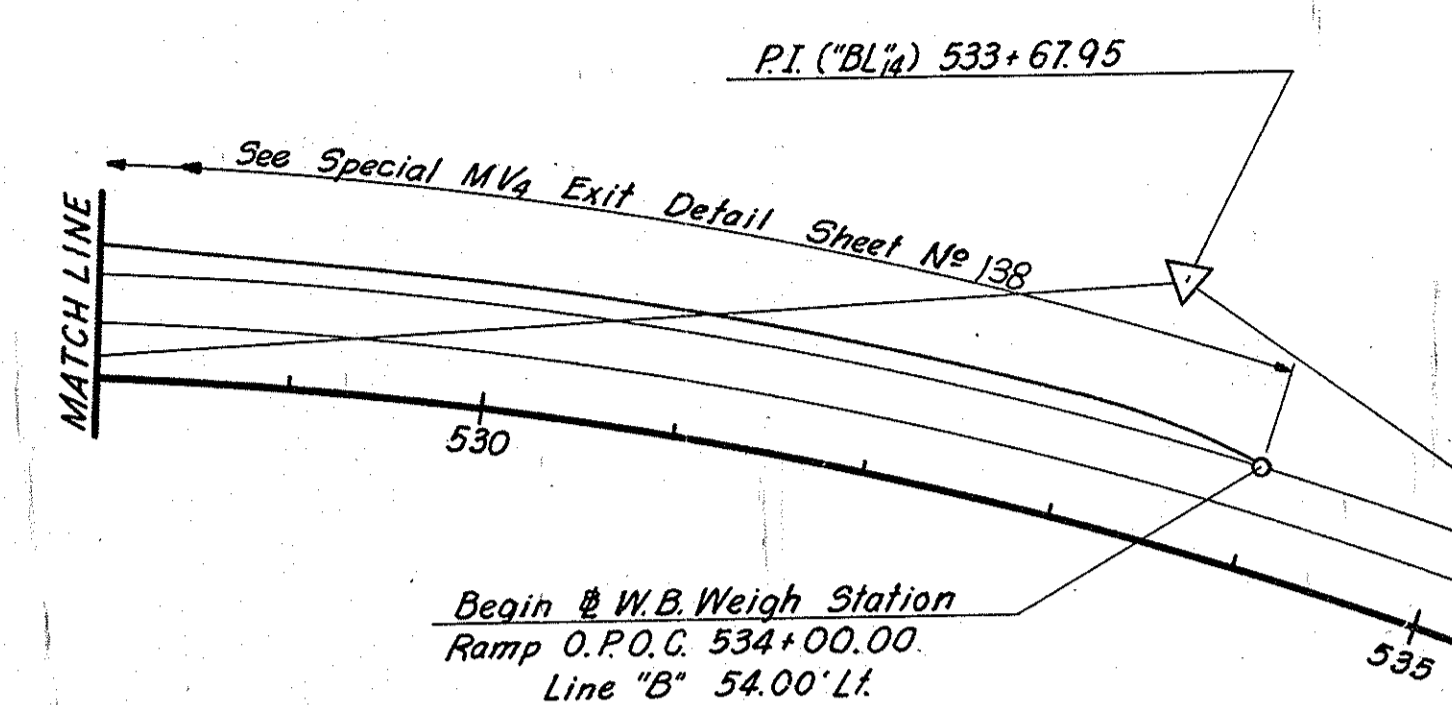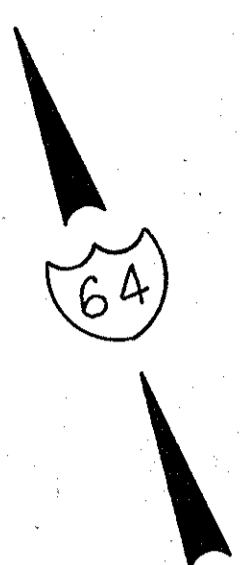

Note: See Sheet No. For Sec. A-A

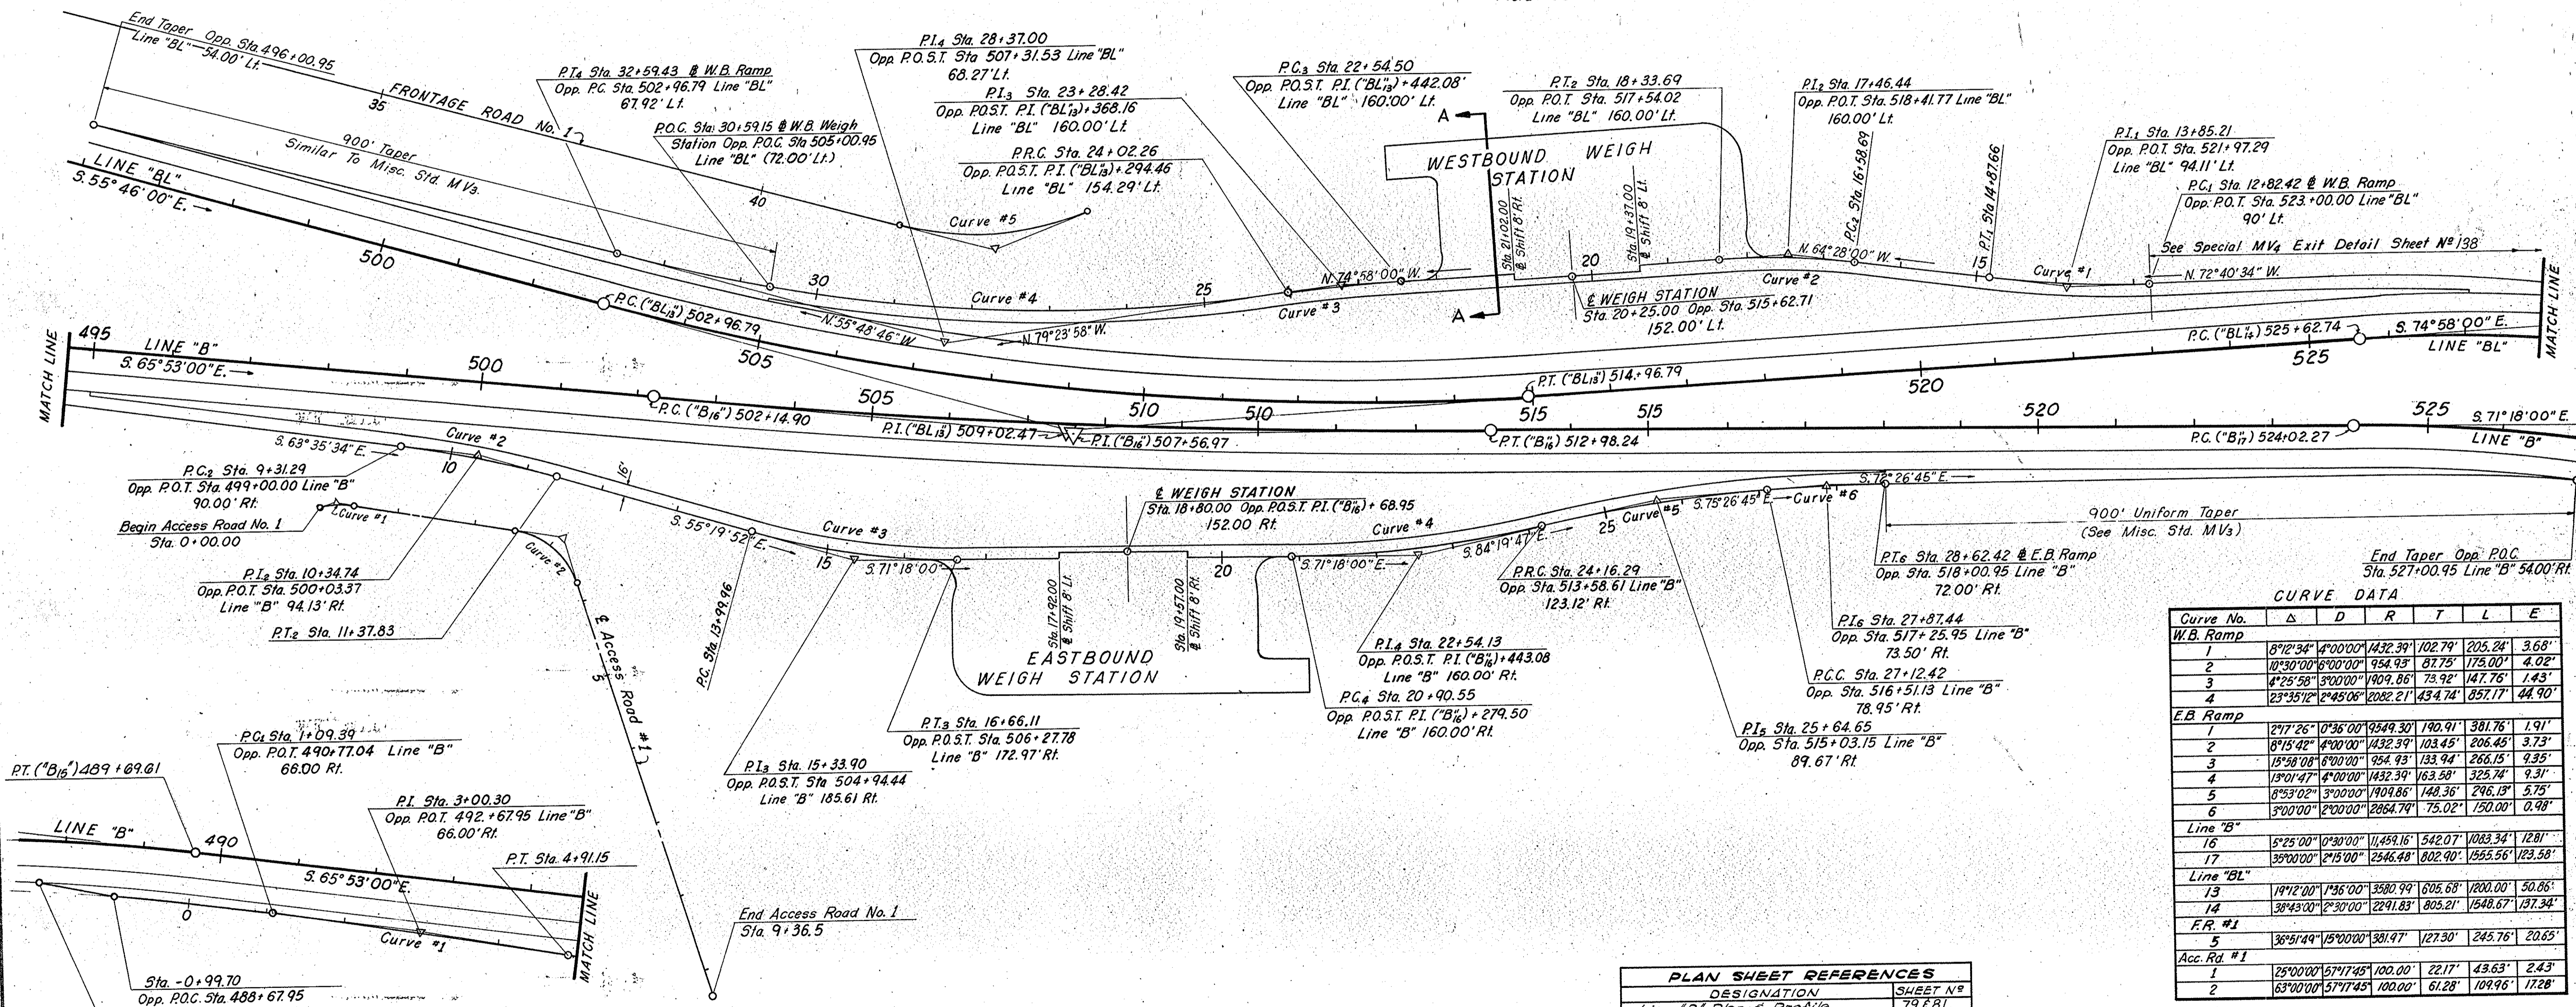

CURVE DATA


Curve No.	Δ	D	R	T	L	E
W.B. Ramp						
1	8°2'34"	4°00'00"	432.39'	102.79'	205.24'	3.68'
2	10°30'00"	6°00'00"	954.93'	87.75'	175.00'	4.02'
3	4°25'58"	3°00'00"	1409.86'	73.92'	147.76'	1.43'
4	23°35'12"	12°45'06"	2082.21'	434.74'	857.17'	44.90'
E.B. Ramp						
1	2°17'26"	0°36'00"	9949.30'	140.91'	381.76'	1.91'
2	8°15'42"	4°00'00"	432.39'	103.45'	206.45'	3.73'
3	15°58'08"	6°00'00"	954.93'	133.94'	266.15'	4.35'
4	13°01'47"	4°00'00"	432.39'	163.88'	325.74'	9.31'
5	8°53'02"	3°00'00"	1404.86'	148.36'	246.18'	5.75'
6	3°00'00"	2°00'00"	2864.74'	75.02'	150.00'	0.98'
Line "B"						
16	5°25'00"	0°30'00"	11,459.16'	542.07'	1,023.34'	12.81'
17	35°00'00"	2°15'00"	2,546.48'	802.90'	1,565.56'	123.58'
Line "BL"						
13	14°12'00"	1°36'00"	3,580.99'	605.68'	1,200.00'	50.66'
14	38°43'00"	2°30'00"	2,291.83'	805.21'	1,548.67'	137.34'
F.R. #1						
5	36°51'49"	15°00'00"	3,819.77'	1,273.0'	245.76'	20.65'
Acc. Rd. #1						
1	25°00'00"	15°17'45"	100.00'	22.17'	43.63'	2.43'
2	63°00'00"	5°17'45"	100.00'	61.28'	109.96'	17.28'

PLAN SHEET REFERENCES

DESIGNATION	SHEET NO.
Line "A" Plan & Profile	79 & 81
Line "B" Plan & Profile	80 & 82
Rel. Co. Rd. No. 4 Plan & Profile	103 & 104
A.R. No. 4 Plan & Profile	108
WEIGH STATION SHEETS	
DESIGNATION	SHEET NO.
R/W	131
Drainage	132
Weigh Station Area Details	133
Pavement Joints	134
Special W.B. Exit	138
Ramp Grades	135-137

WEIGH STATION DETAILS LINE DATA

Scale: 1" = 100'

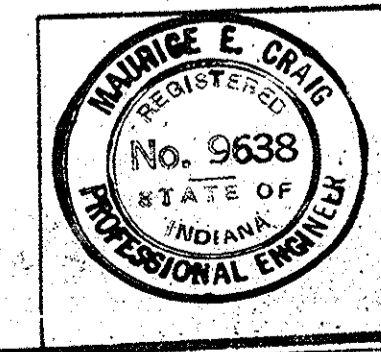


PROJECT NO.	LINE	SHEET NO.	TOTAL SHEETS	FILE
F-64-3(33)86	530-535	130	130	

FEDERAL ROAD REGION NO.	STATE	PROJECT NO.	FISCAL YEAR	SHEET NO.	TOTAL SHEETS
4	IND.	I-64-3(33)86	1967	131	131

6A
SUBJECT TO A BLANKET EASEMENT FOR R/W IN FAVOR OF IND. STATEWIDE RURAL ELECTRIC COOP, INC.

SUBJECT TO A BLANKET EASEMENT FOR R/W IN FAVOR OF INDIANA STATEWIDE RURAL ELECTRIC COOP, INC.

INDIANA DEPT. OF CONSERVATION
State of Indiana

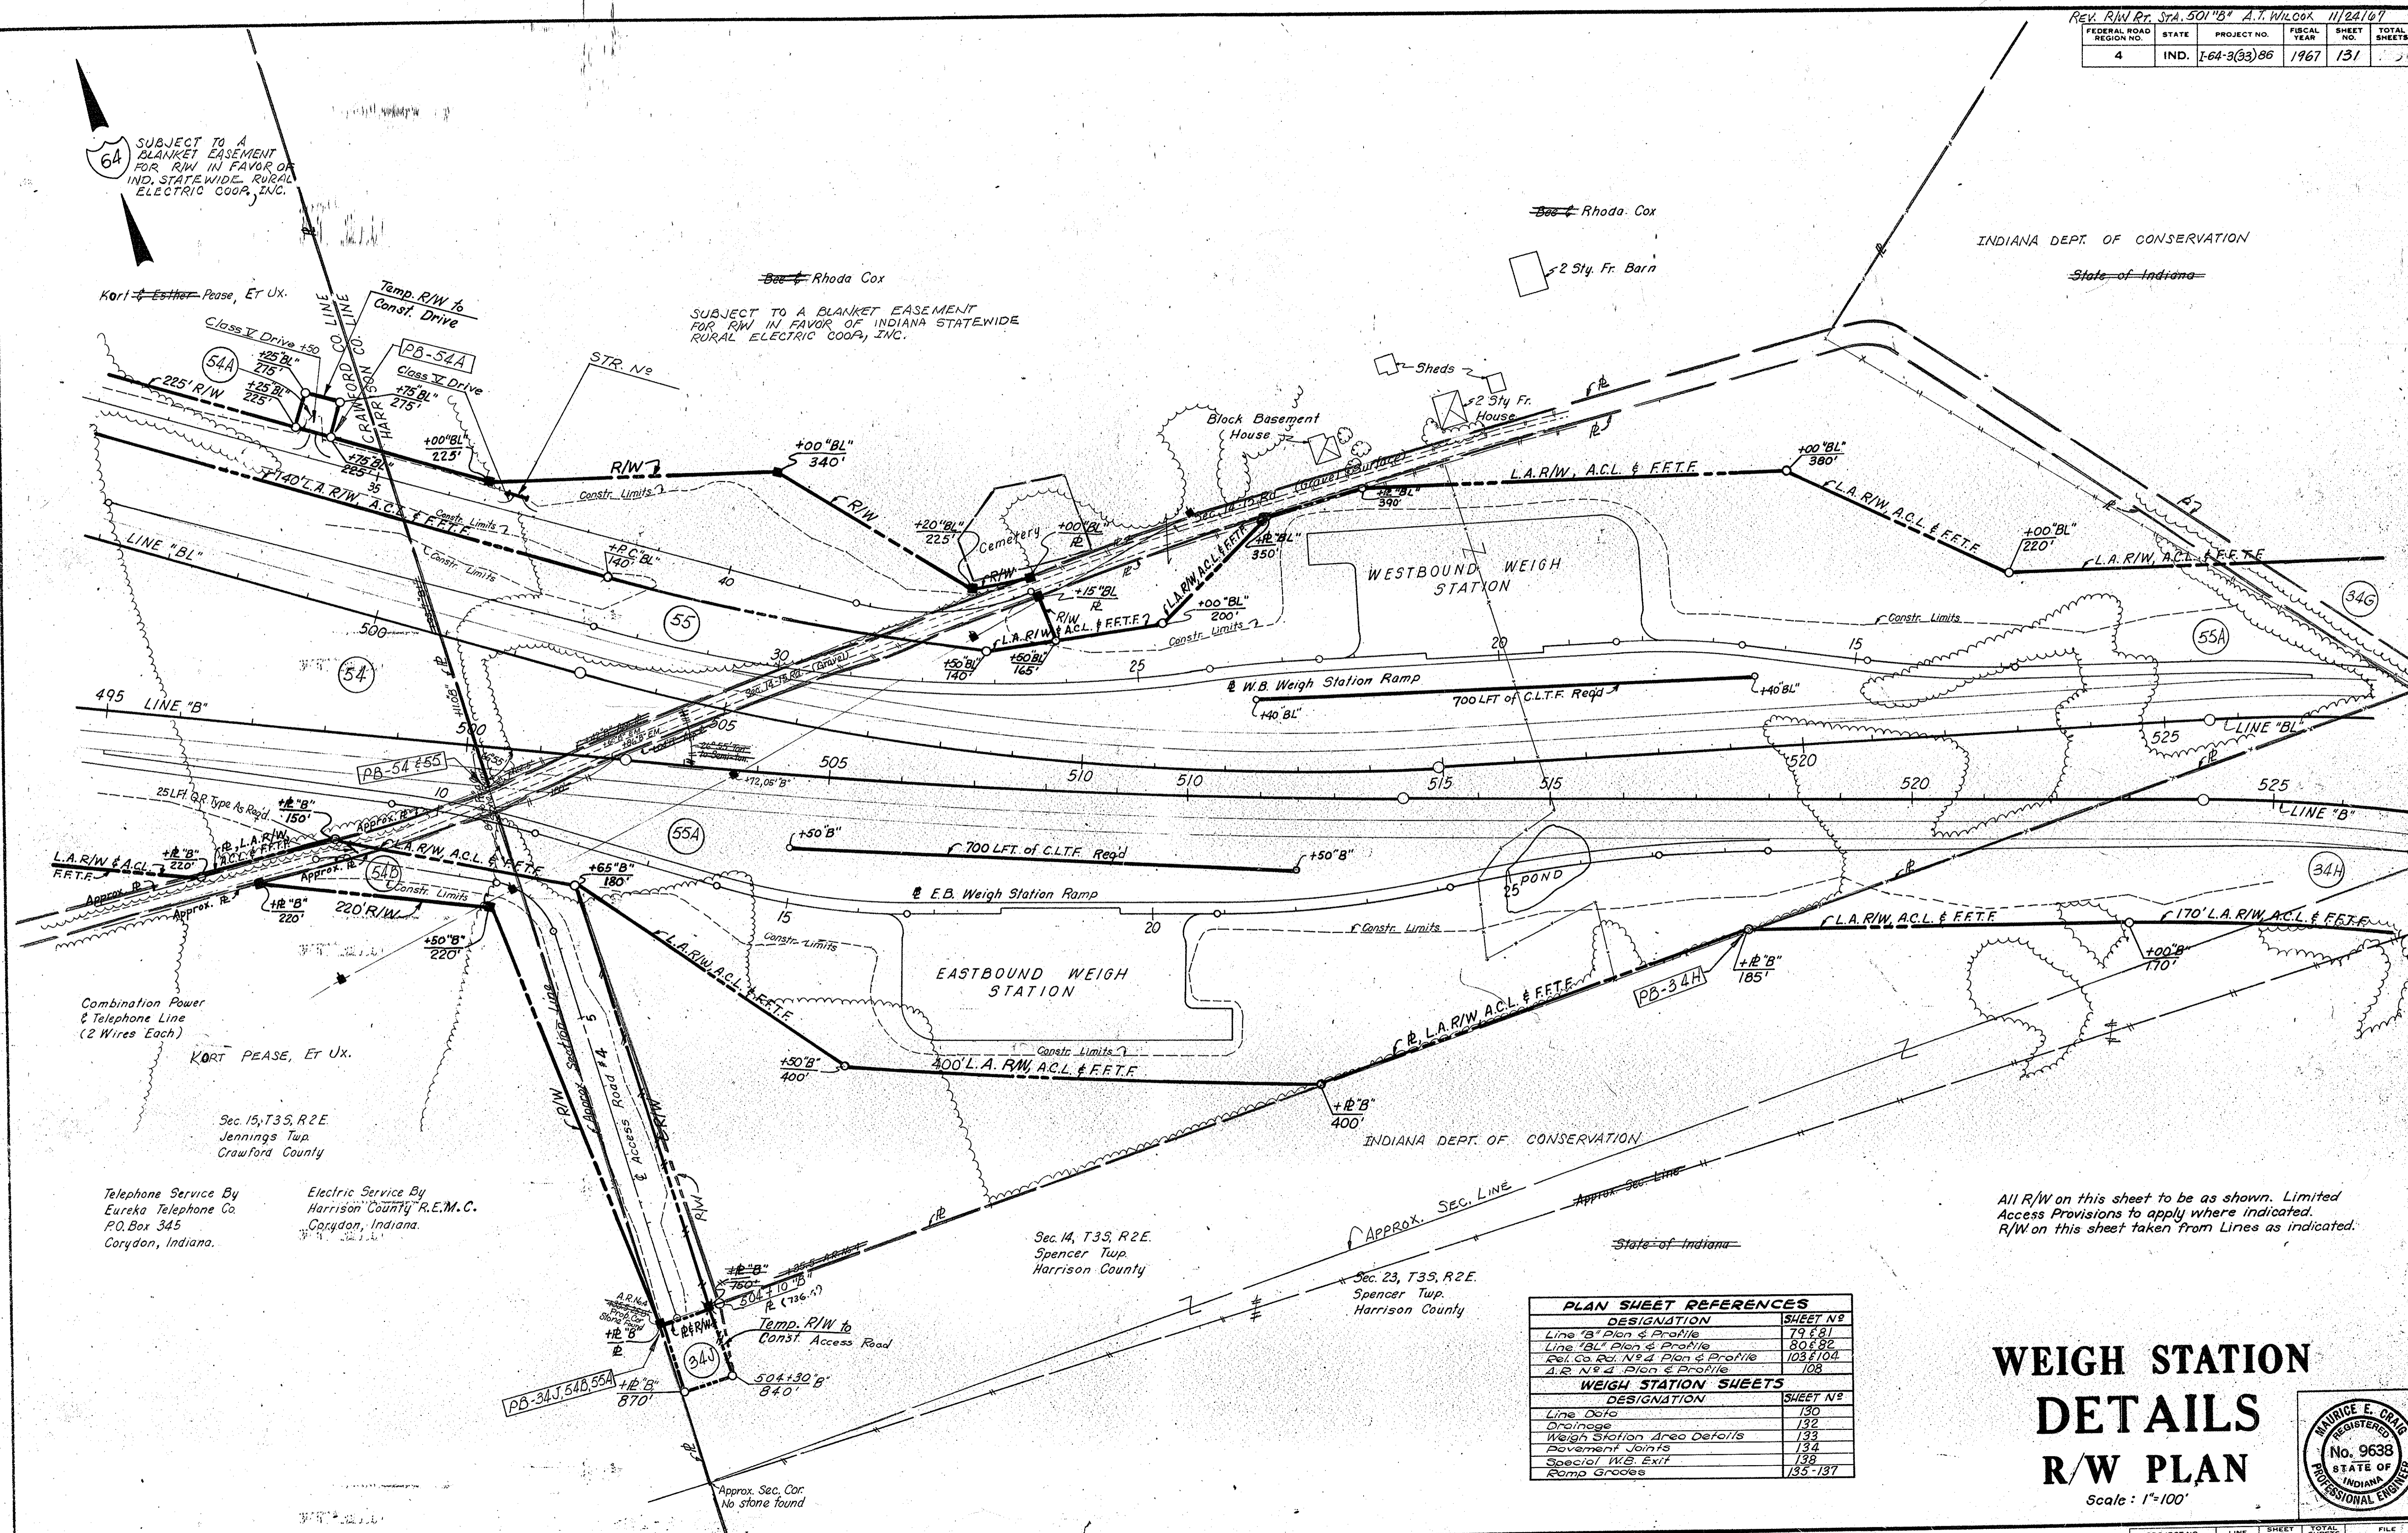

All R/W on this sheet to be as shown. Limited Access Provisions to apply where indicated. R/W on this sheet taken from Lines as indicated.

PLAN SHEET REFERENCES	
DESIGNATION	SHEET NO.
Line 'B' Plan & Profile	79 & 81
Line 'BL' Plan & Profile	80 & 82
Rel. Co. Rd. No. 4 Plan & Profile	103 & 104
A.R. No. 4 Plan & Profile	108
WEIGH STATION SHEETS	
DESIGNATION	SHEET NO.
Line Data	130
Drainage	132
Weigh Station Area Details	133
Pavement Joints	134
Special W.B. Exit	138
Ramp Grooves	135-137

WEIGH STATION DETAILS R/W PLAN

Scale: 1"=100'



PROJECT NO.	LINE	SHEET NO.	TOTAL SHEETS	FILE
I-64-3(33)86	WEIGH STATION	131	131	

GUARD RAIL TYPE "Bs"

"BL" LINE LT.	L.F.T.
502+50 TO 507+00	450
RELOC. CO. RD. #4	
38+00 TO 42+50 LT.	450
39+00 TO 42+00 RT.	300
"B" LINE RT.	
520+00 TO 525+00	500
"B" LINE LT.	
521+50 TO 525+00	350

STANDARD LIP GUTTER

L.F.T.	S. YDS.
11+00 TO 13+80 E.B.R. RT.	280
13+80 TO 17+00 E.B.R. LT.	320
14+00 TO 16+30 W.B.R. RT.	230
16+30 TO 18+50 W.B.R. LT.	220

SODDING


"B" LINE LT.	S. YDS.
494+75 TO 509+25	1450
516+00 TO 518+75	275
520+25 TO 525+00	475
"BL" LINE RT.	
503+75 TO 508+25	450
"BL" LINE LT.	
517+75 TO 521+25	350
E.B.R. RT.	
95 RT. 20+50 TO 24+35	385
25+30 TO 519+25 "B"	460
E.B.R. LT.	
13+52 TO 16+77	325
22+30 TO 23+60	130
W.B.R. RT.	
13+50 TO 17+15	365
24+40 TO 28+15	365
518+75 "BL" TO 523+25	450
E.B. WEIGH STATION AREA	
57 RT. 17+40 TO 57 RT. 19+75	209
W.B. WEIGH STATION AREA	
57 RT. 18+85 TO 57 RT. 21+00	192
"B" LINE RT.	
496+25 TO 11+55 E.B.R.	500

PAVED SIDE DITCH - TYPE "A"

"B" LINE RT.	P.S.D. L. FT.	SODDING S. YDS.
501+75 TO 503+25	160	45
511+75 TO 513+25	160	45
"B" LINE LT.		
518+75 TO 520+25	160	45
"BL" LINE RT.		
518+75 TO 519+75	105	30
E.B.R. RT.		
11+55 TO 12+65	120	32
E.B.R. LT.		
12+27 TO 13+52	135	38
W.B.R. LT.		
16+50 TO 18+10	170	51
23+55 TO 25+05	160	45
RELOC. CO. RD. #4 RT.		
35+00 TO 43+50	860	252
RELOC. CO. RD. #4 LT.		
35+12 TO 37+25	223	64
A.R. #4		
0+00 TO 9+90 RT.	1000	297
3+35 TO 5+60 LT.	263	76
6+12 TO 7+75 LT.	173	49
PAVED SIDE DITCH - TYPE "B"		
LINE "BL" RT.		
519+75 TO 521+67	197	57
W.B.R. RT.		
26+15 TO 28+95	90	24

STD. LIP GUTTER TURNOUT

L.F.T.	PAVED SIDE DITCH - TYPE "A"
14+00 W.B.R. RT.	10 L.F.T.
18+50 W.B.R. LT.	27 L.F.T.
11+00 E.B.R. RT.	10 L.F.T.
13+80 E.B.R. LT.	25 L.F.T.

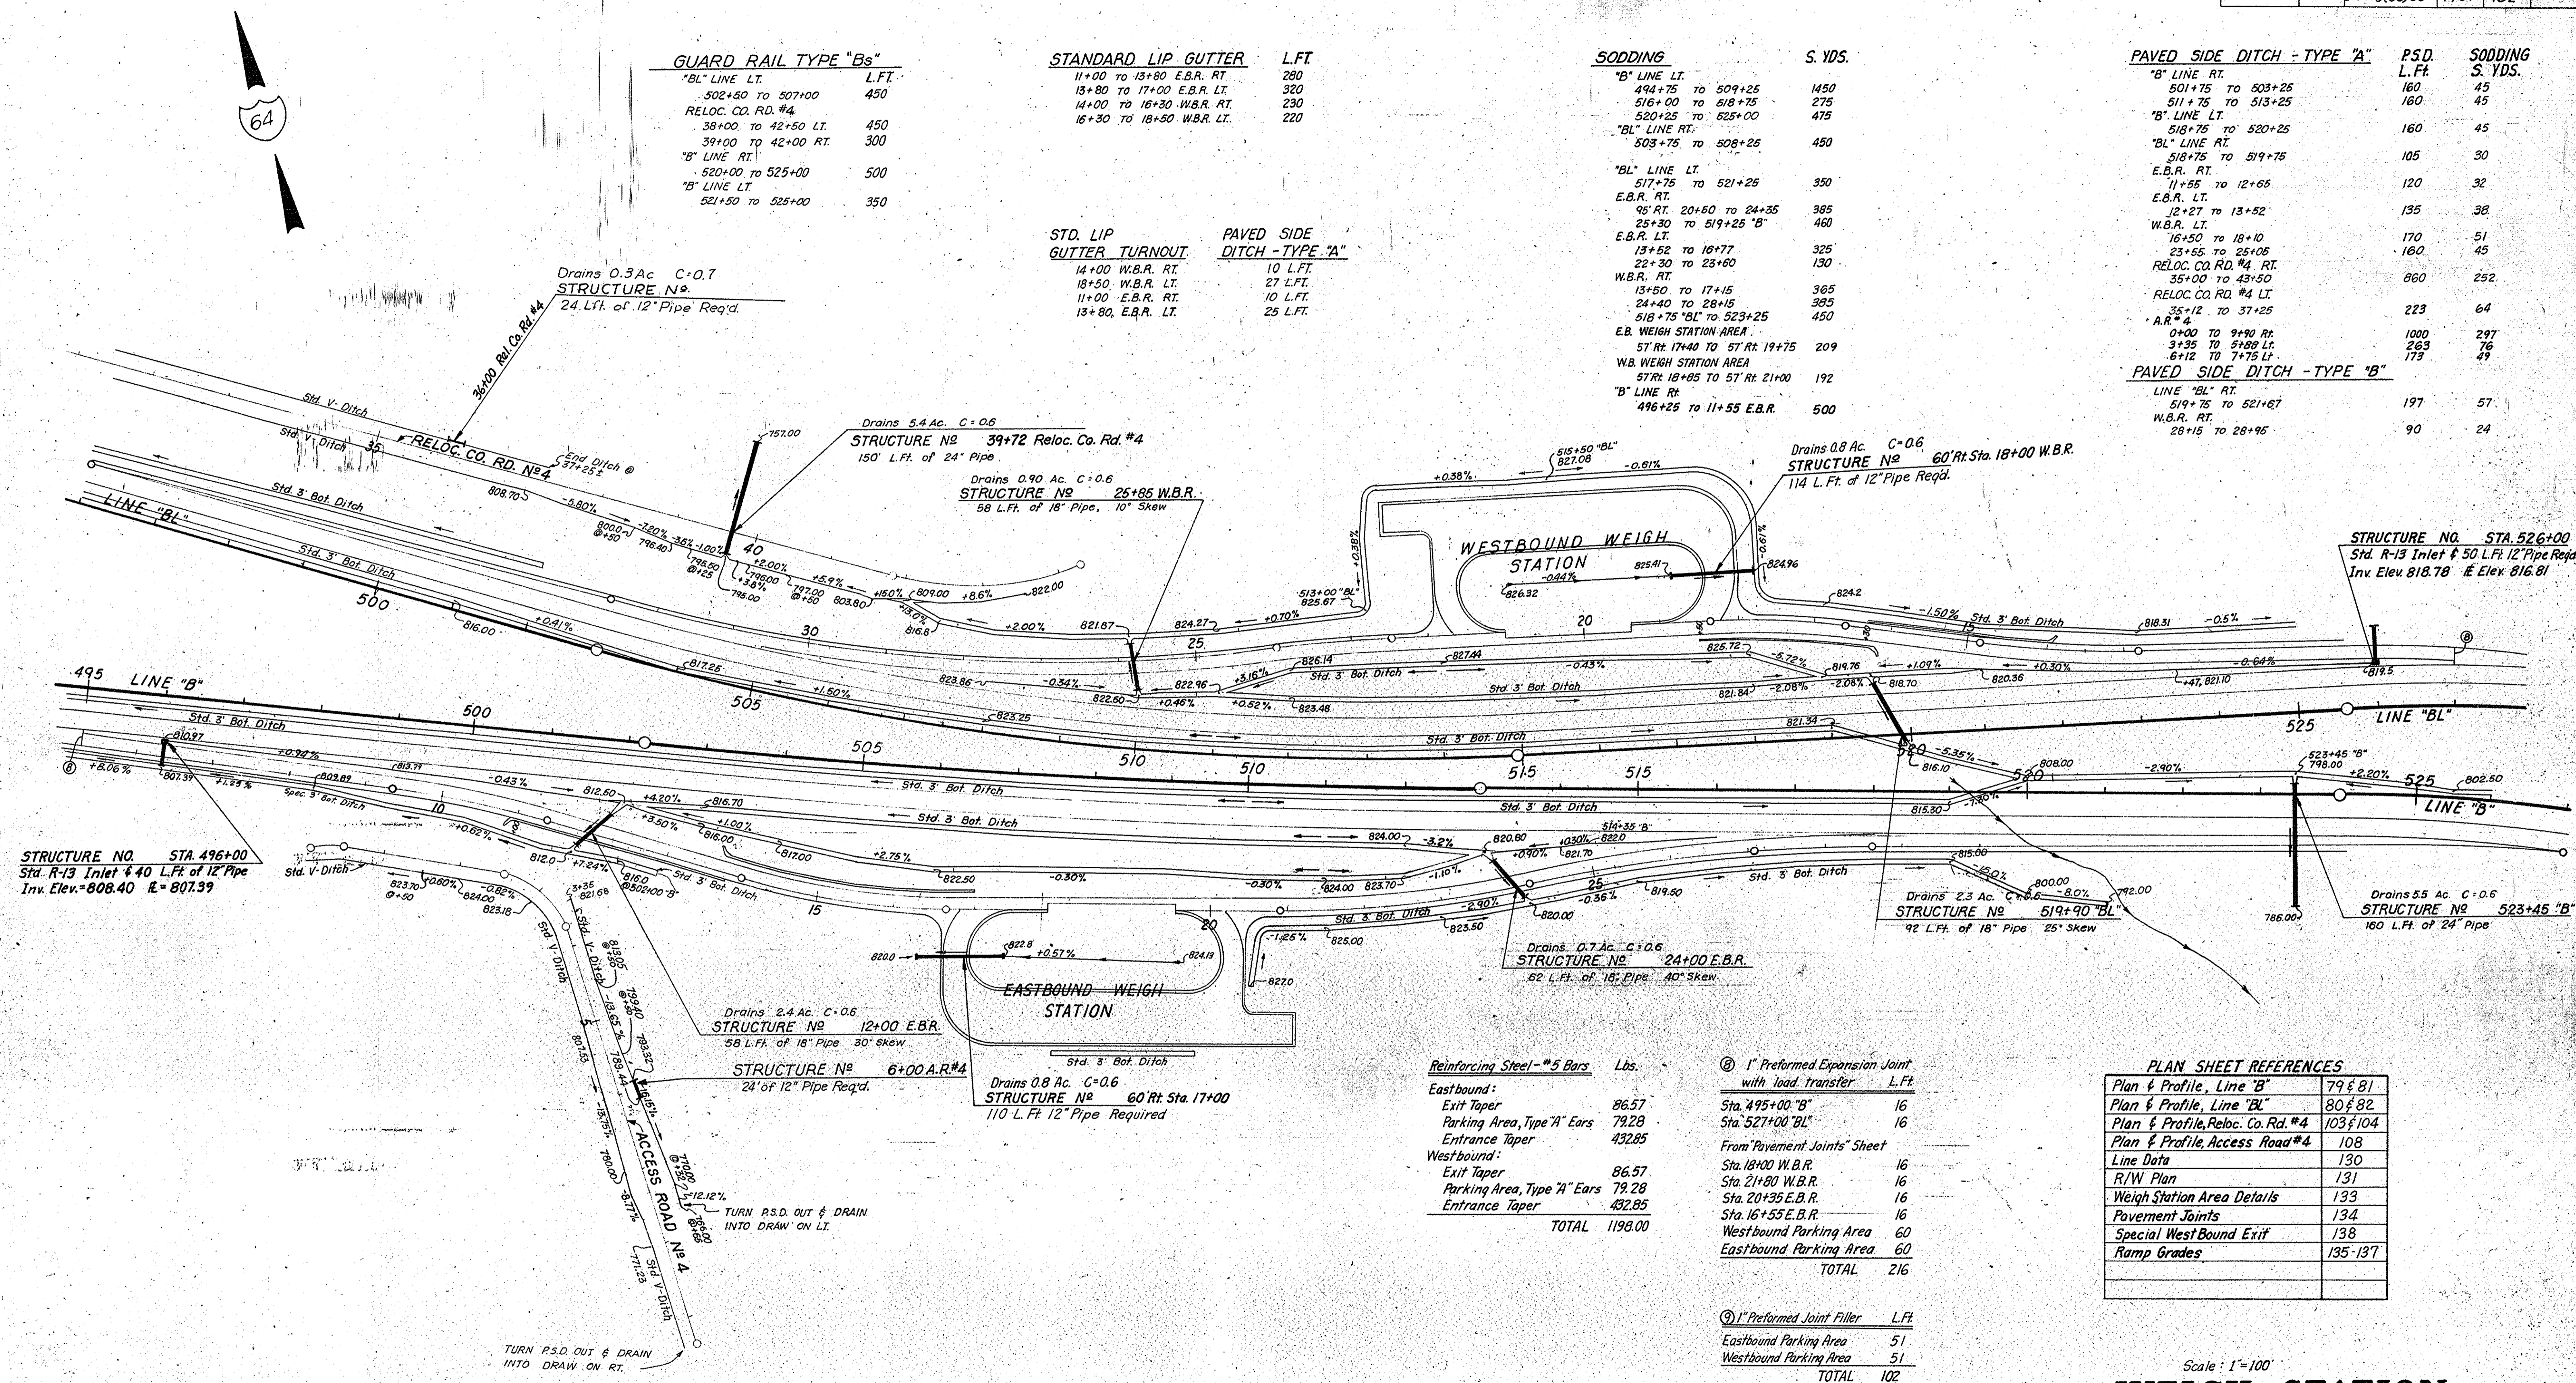

Reinforcing Steel - #5 Bars

Item	Lbs.
Eastbound:	
Exit Taper	86.57
Parking Area, Type "A" Ears	79.28
Entrance Taper	432.85
Westbound:	
Exit Taper	86.57
Parking Area, Type "A" Ears	79.28
Entrance Taper	432.85
TOTAL	1198.00

1" Preformed Expansion Joint with load transfer

Item	L.F.T.
Sta. 495+00 "B"	16
Sta. 527+00 "BL"	16
From Pavement Joints Sheet	
Sta. 18+00 W.B.R.	16
Sta. 21+80 W.B.R.	16
Sta. 20+35 E.B.R.	16
Sta. 16+55 E.B.R.	16
Westbound Parking Area	60
Eastbound Parking Area	60
TOTAL	216

1" Preformed Joint Filler


Item	L.F.T.
Eastbound Parking Area	51
Westbound Parking Area	51
TOTAL	102

PLAN SHEET REFERENCES


Plan & Profile, Line "B"	79 & 81
Plan & Profile, Line "BL"	80 & 82
Plan & Profile, Reloc. Co. Rd. #4	103 & 104
Plan & Profile, Access Road #4	108
Line Data	130
R/W Plan	131
Weigh Station Area Details	133
Pavement Joints	134
Special Westbound Exit	138
Ramp Grades	135-137

Scale: 1"=100'

WEIGH STATION DETAILS DRAINAGE PLAN

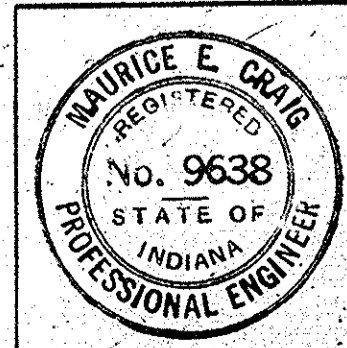

FEDERAL ROAD REGION NO.	STATE	PROJECT NO.	FISCAL YEAR	SHEET NO.	TOTAL SHEETS
4	IND.	I-64-3(33)86	1967	134	

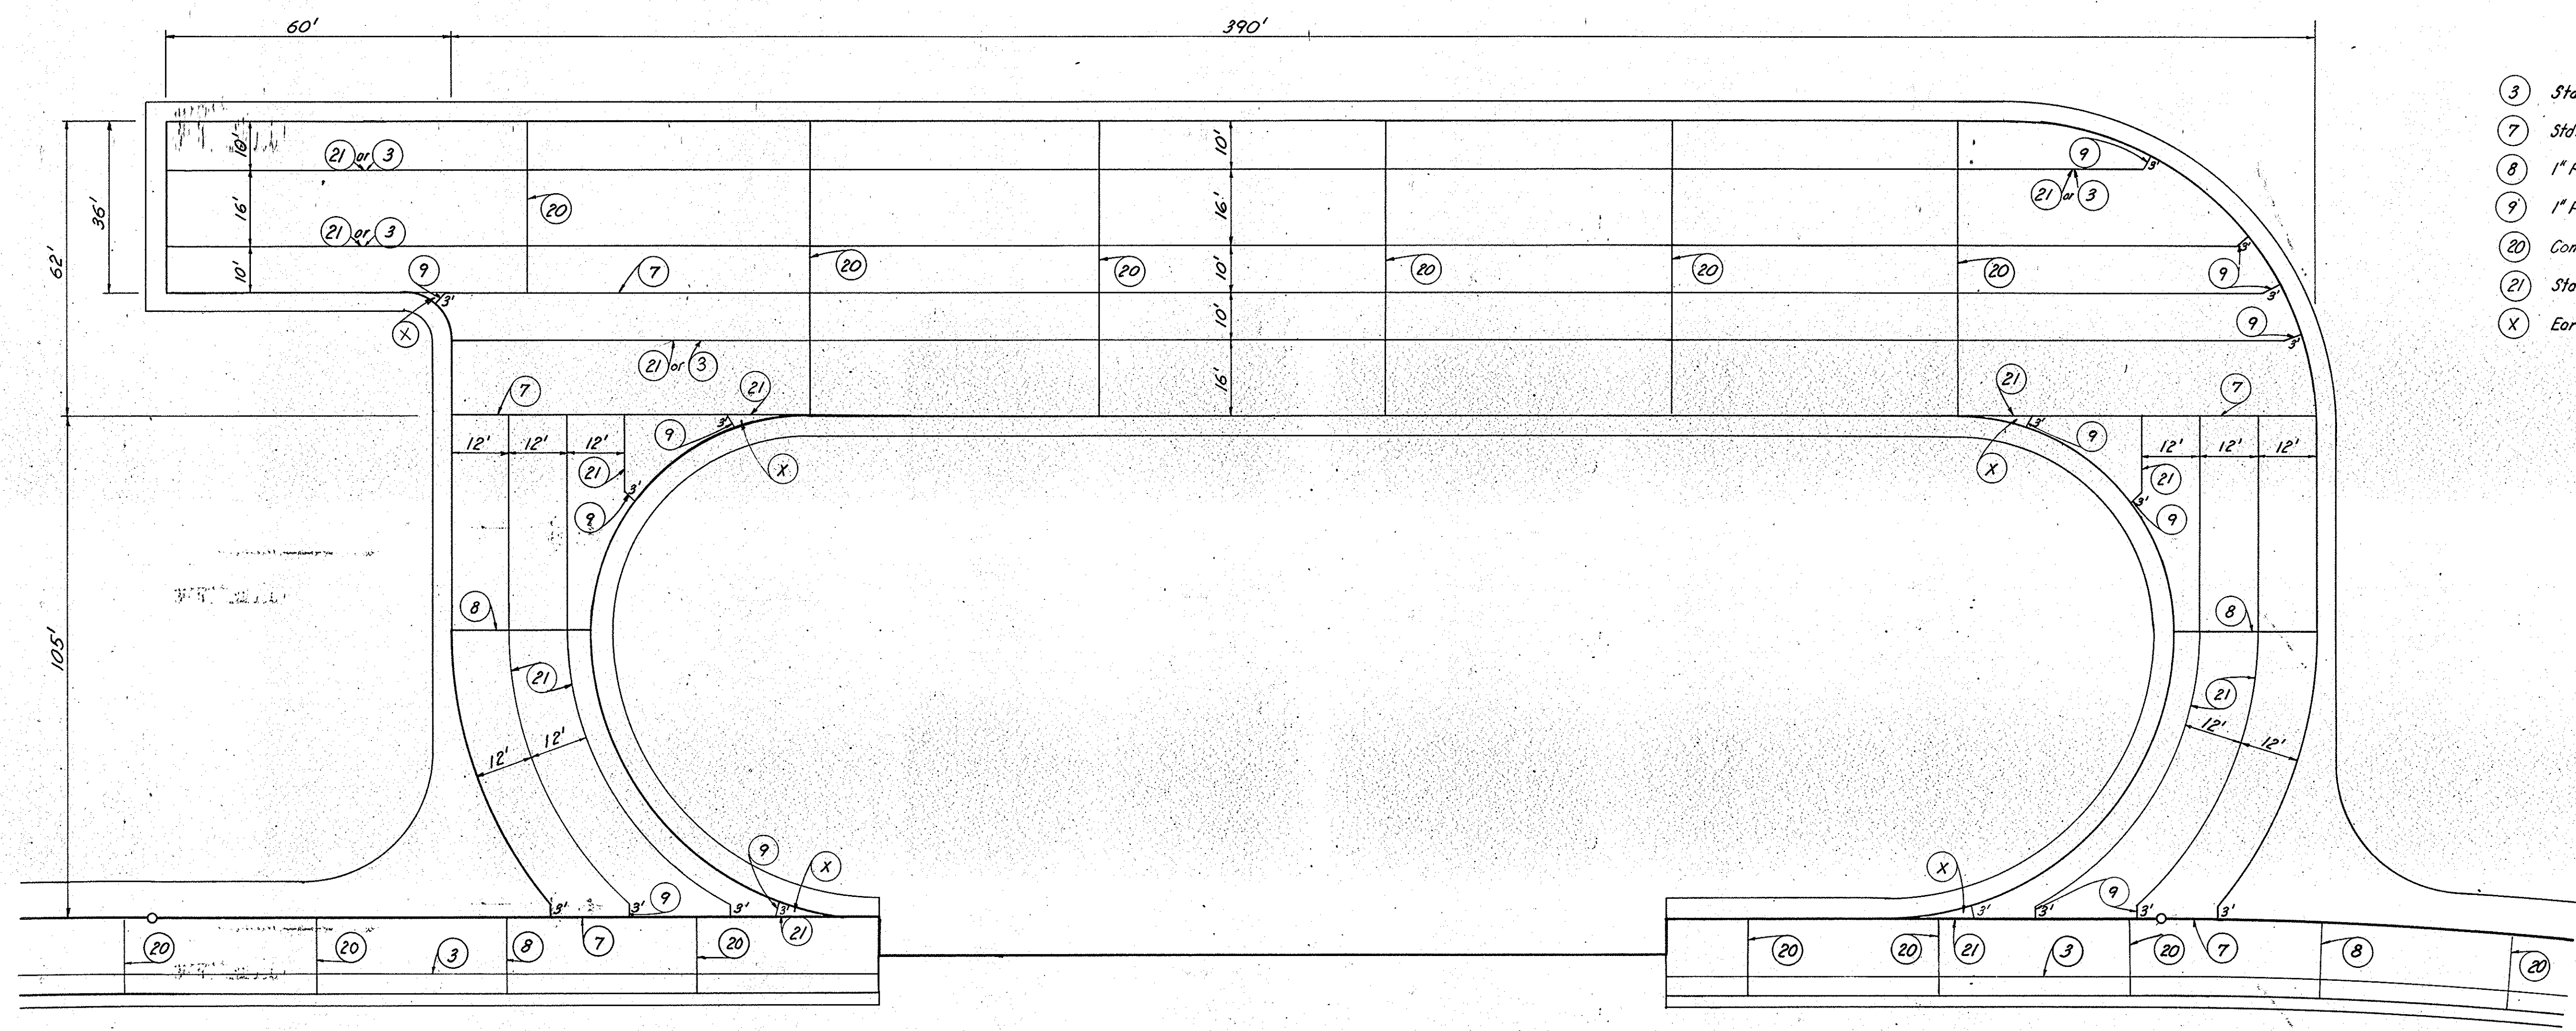


- LEGEND**
- ③ Std. Longitudinal Joint
 - ⑦ Std. Keyway Joint
 - ⑧ 1" Pref. Expansion Joint with Load Transfer
 - ⑨ 1" Pref. Joint Filler
 - ⑳ Contraction Joint Type D-1
 - ㉑ Std. Keyway Construction Joint
 - X Eor Construction Type "A"

PLAN SHEET REFERENCES	
DESIGNATION	SHEET NO.
Line "B" Plan & Profile	79 & 81
Line "BL" Plan & Profile	80 & 82
WEIGH STATION SHEETS	
DESIGNATION	SHEET NO.
Line Data	130
R/W	131
Drainage	132
Weigh Station Area Details	133
Ramp Grades	135-137

PAVEMENT JOINTS DETAILS



SCALE: 1" = 20'

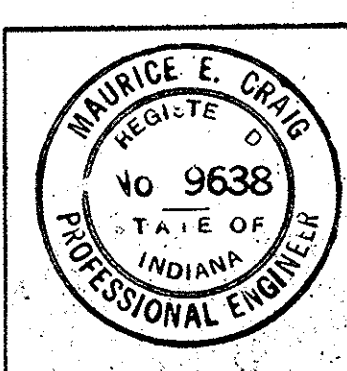

November 6, 1961

PROJECT NO.	LINE	SHEET NO.	TOTAL SHEETS	FILE
I-64-3(33)86	WEIGH STATION	134		


CUT CROSS SECTIONS FILL
Scale 1 inch = 10 feet

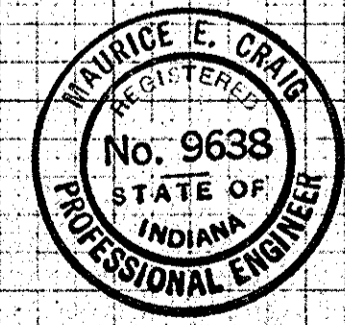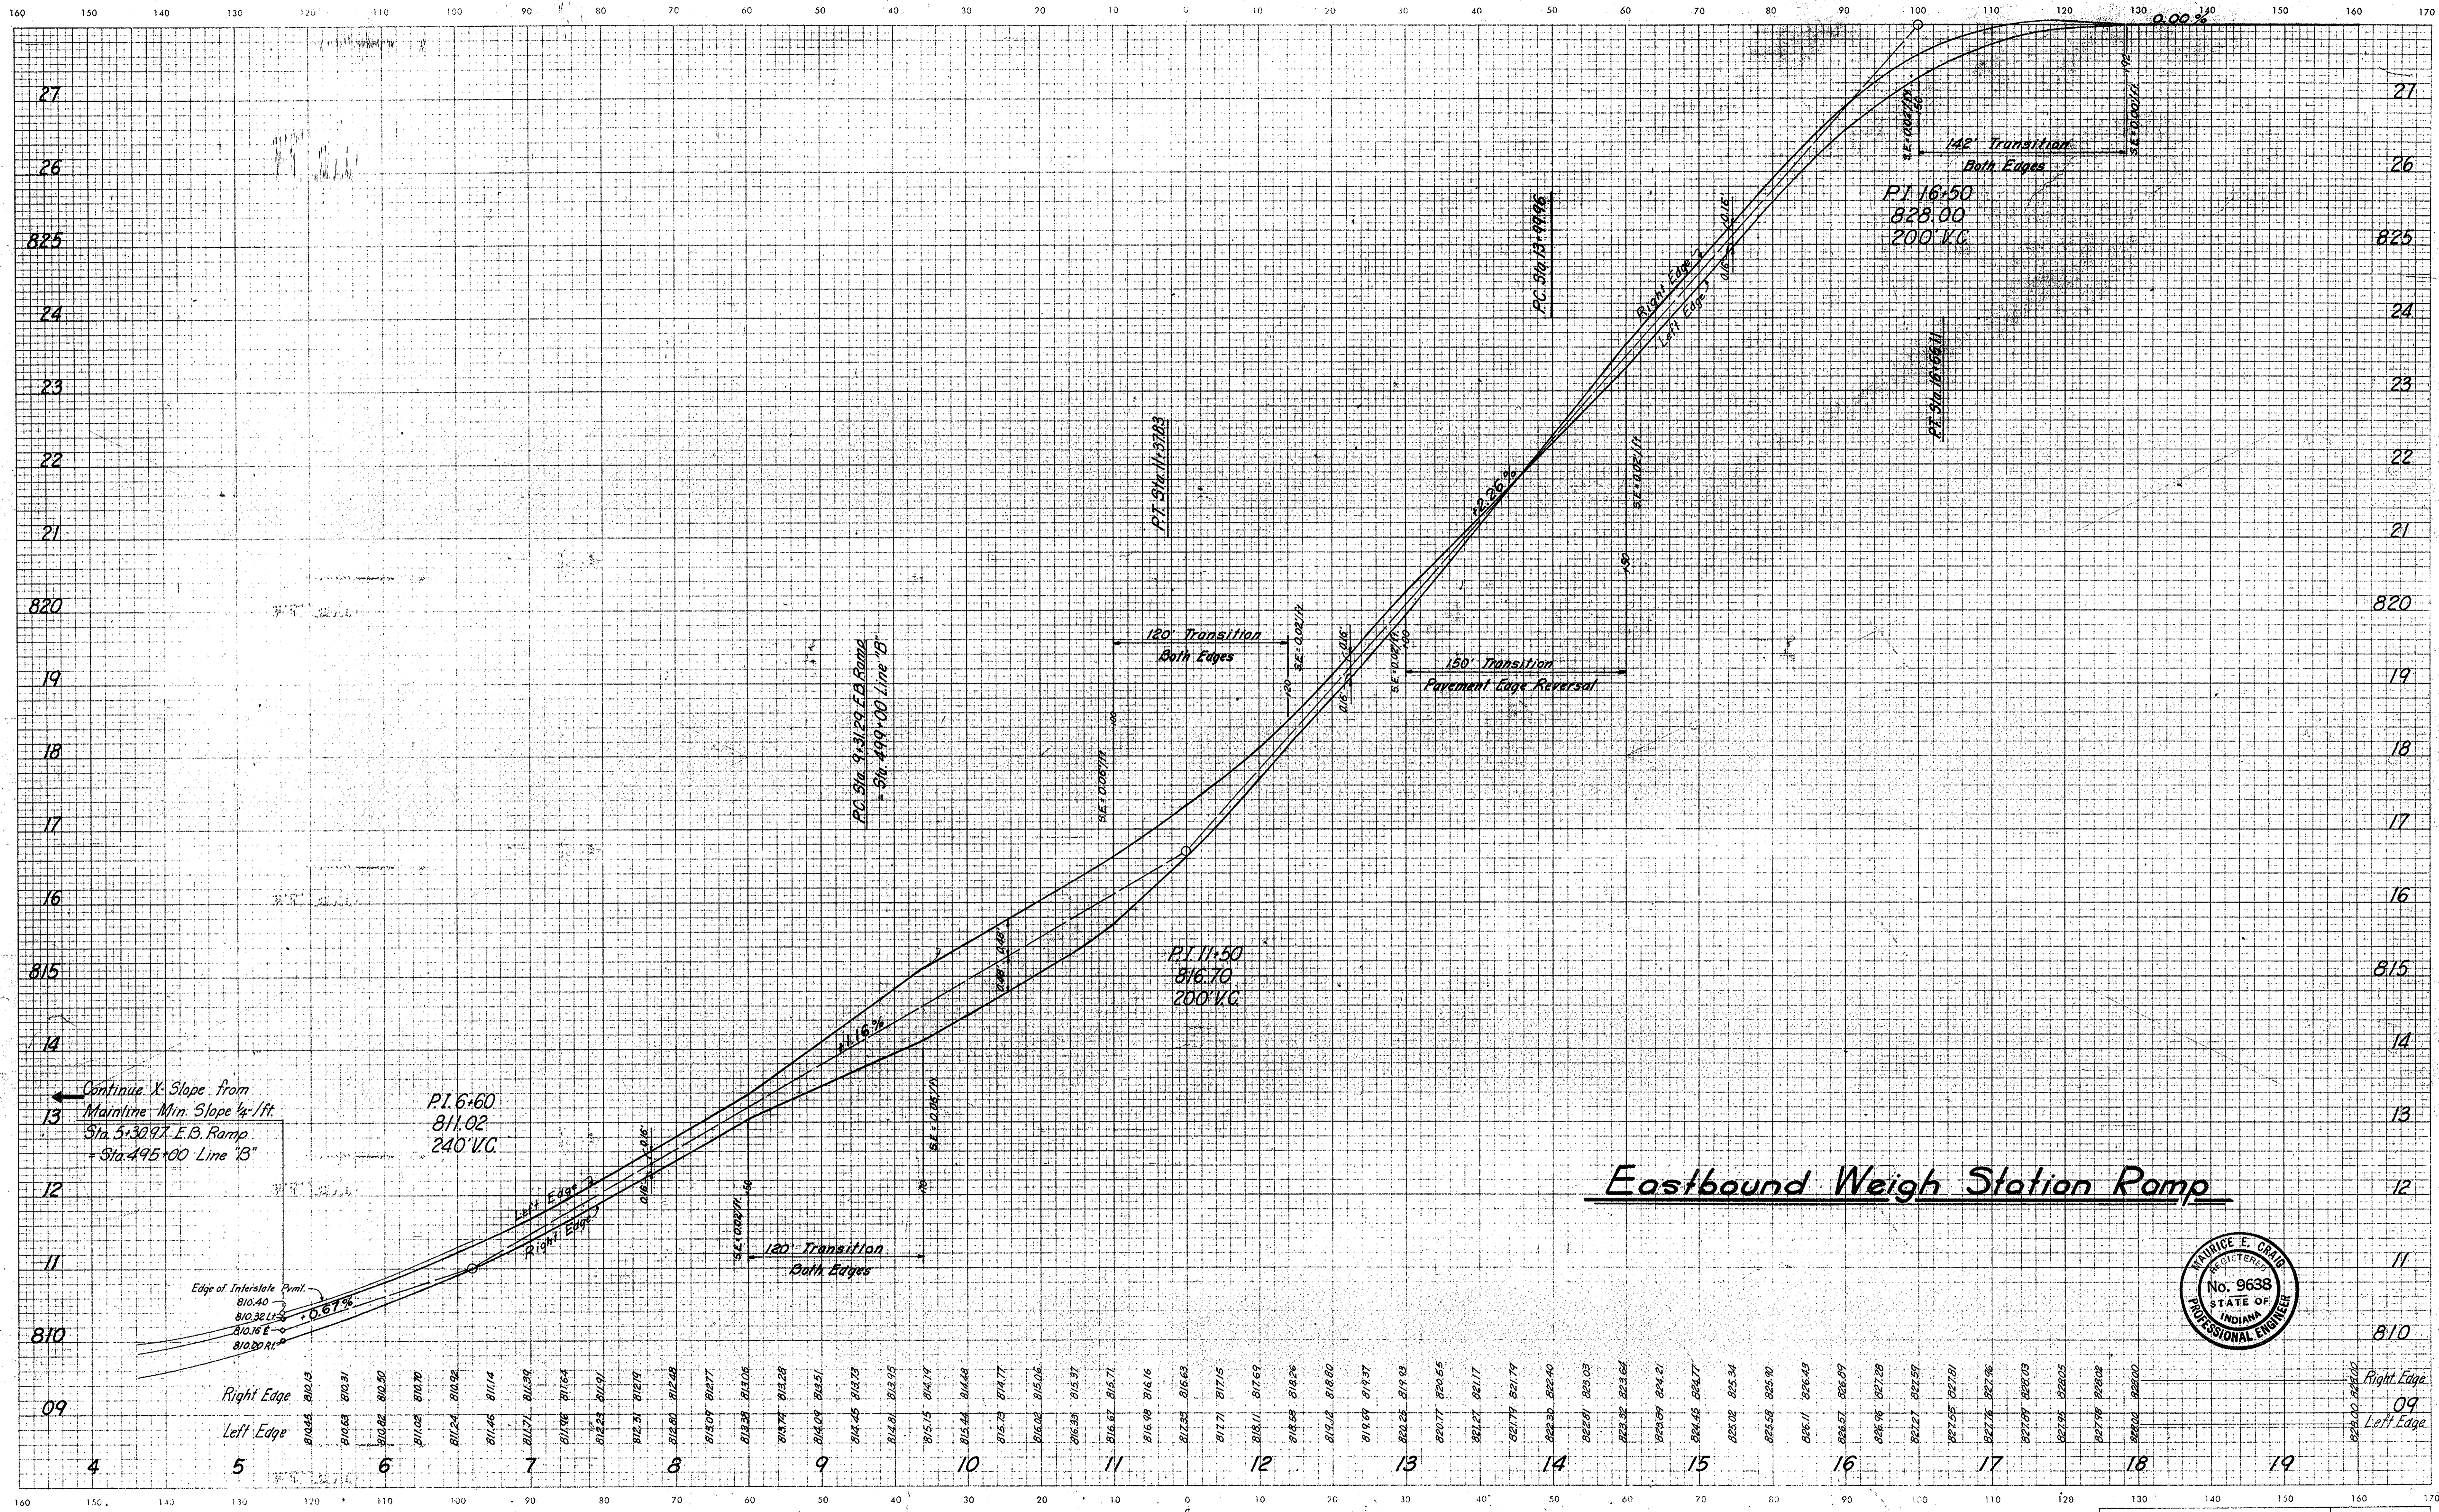


November 6, 1961

LEVEL BOOK NO.	FILE				
FEDERAL ROAD REGION NO.	STATE	PROJECT NO.	FISCAL YEAR	SHEET NO.	TOTAL SHEETS
4	IND.	I-64-3(33) 86	1967	135	
E.B. WEIGH STATION				LINE E.B. WEIGH STATION RAMP	

CUT CROSS SECTIONS FILL
Scale: 1 inch = 10 feet

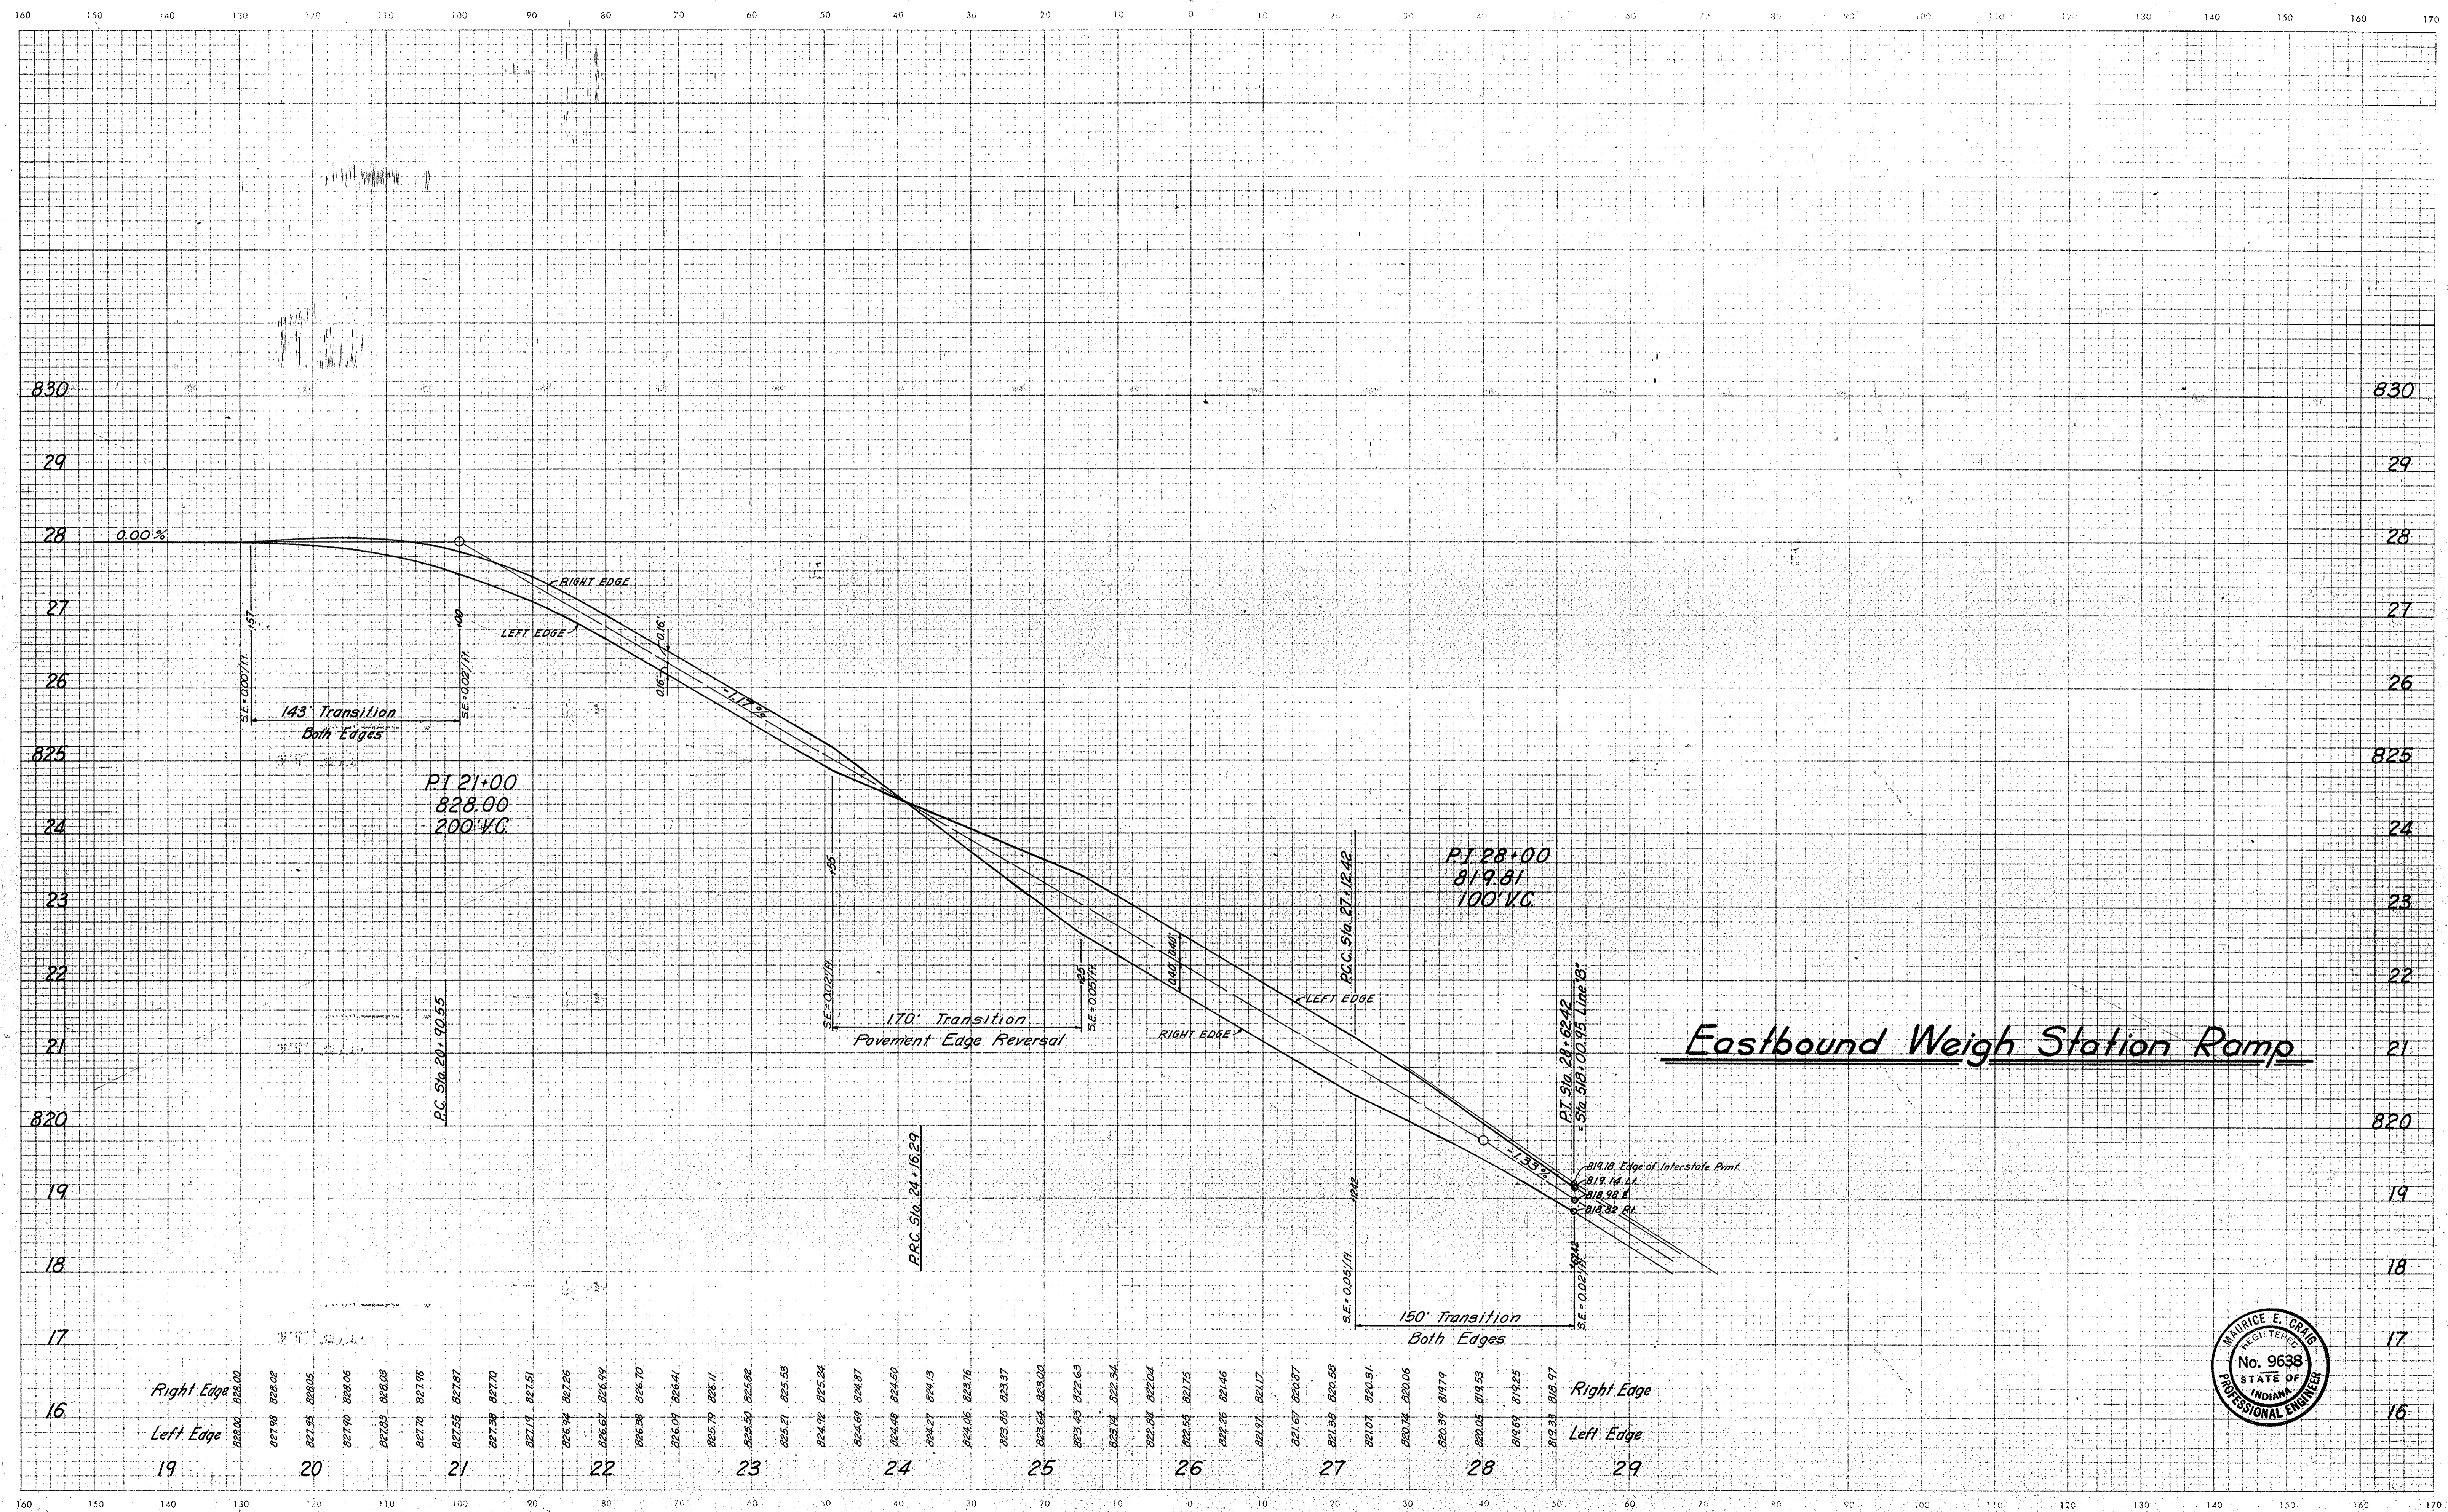


Eastbound Weigh Station Ramp

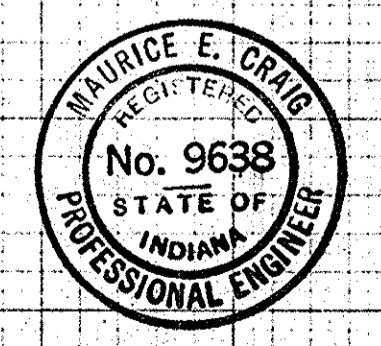

Right Edge	828.00	828.02	828.05	828.06	828.08	828.10	828.11	828.12	828.14	828.15	828.16	829.00
Left Edge	828.00	828.02	828.05	828.06	828.08	828.10	828.11	828.12	828.14	828.15	828.16	829.00


November 6, 1961

CUT Scale 1 inch = 10 feet FILL

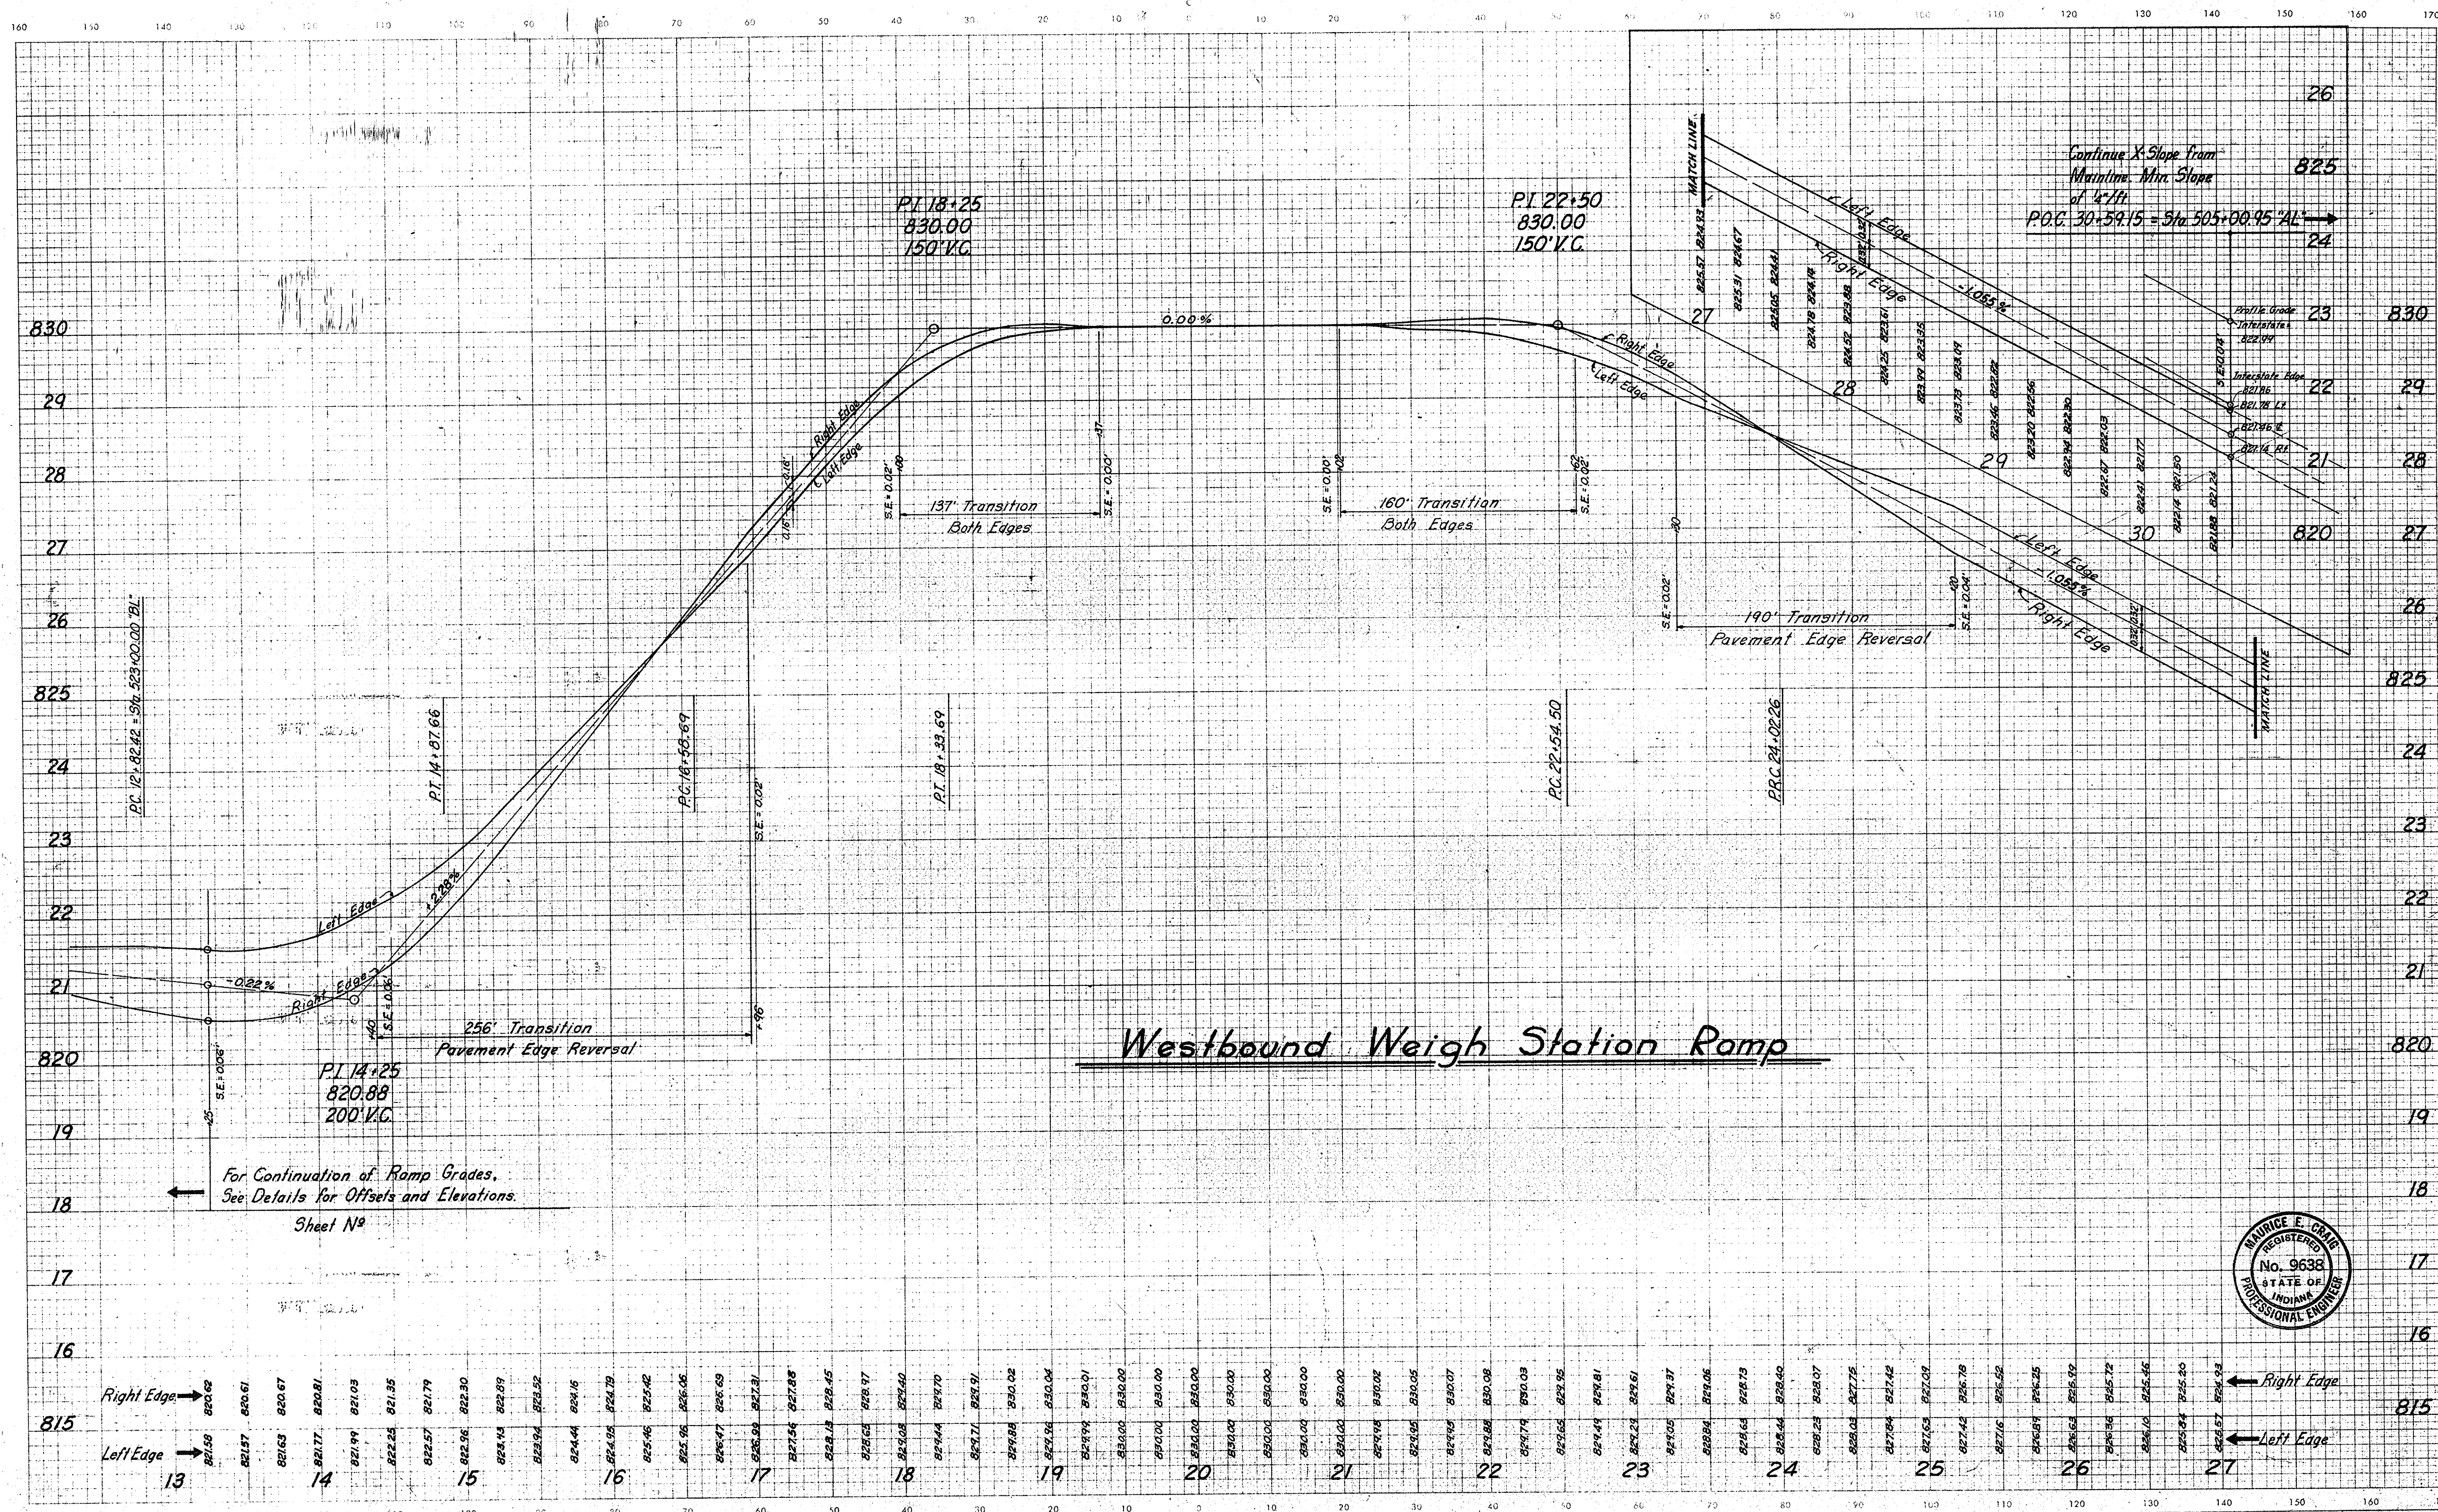

For Continuation of Ramp Grades,
See Details for Offsets and Elevations.

Sheet No. 13

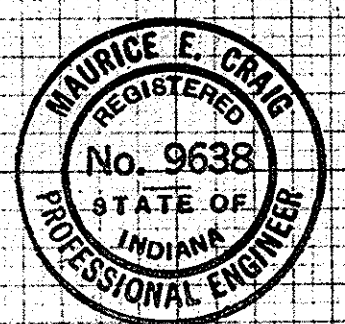


APPROACH TABLE

DESIGN DATA AND QUANTITIES BASED ON MAX. OF 10% GRADE EXCEPT AS NOTED

STATION	LINE	DESCRIPTION	EXCAVATION CU. YDS.		WIDTH "W"	RADI "R"	GRADE LESS THAN 10% NOT SHOWN	LENGTH "L"	DISTANCE BEYOND R/W LINE	BITUMINOUS SURFACE SYS.		BITUMINOUS BASE SYS.		COMP. AGG. BASE TYPE "P" SYS.	
			CUT	FILL						110 #	220 #	3"	8"		
38+00	Rt.	S-SR66B TYPE "B" APPR.	*	*	18	38-38		60		245	245		245		
62+00	Lt.	S-SR66B TYPE "B" APPR.	*	*	18	38-38		60		245	245		245		
32+00	Rt.	S-SR37A CL. II DRIVE	0	20	12	15-25		138							
33+30	Lt.	S-SR37A TYPE "D" APPR.	0	4300	18	25-25	11%	260		557	557		557		
64+00	Lt.	S-SR37A TYPE "D" APPR.	0	0	18	25-25		68		157	157		157		
68+00	Rt.	S-SR37A CL. II DRIVE	0	50	12	15-25	26%	248							
13+80	(38%)	S-SR37C CL. II DRIVE			12	15-25									
14+30	(10%)	R.C.R.#1 CL. II DRIVE	0	10	12	15-25		15							
14+50	Rt.	R.C.R.#1 TYPE "D" APPR.	265	0	18	25-25	10%	62	151		151		151		
42+00	Lt.	S-11B CL. II DRIVE	0	10	12	15-25		33							
42+00	Rt.	S-11B CL. II DRIVE	0	10	12	15-25	11%	28							
47+10	Rt.	S-11B TYPE "D" APPR.	*	*	18	25-25		35	107		107		107		
53+00	Rt.	S-11B TYPE "B" APPR.	*	*	18	38-38		60	245		245		245		
57+30	Lt.	S-11B TYPE "B" APPR.	0	195	20	38-38		70	266		266		266		
57+50	(10%)	S-11B CL. II DRIVE	0	10	12	15-25		8							
58+40	Lt.	S-11B CL. II DRIVE	0	0	12	15-25		14							
58+40	Rt.	S-11B CL. II DRIVE	0	0	12	15-25		14							
149+05	(34%)	"B" CL. II DRIVE	0	10	12	15-25		10							
149+20	(34%)	"B" CL. II DRIVE	0	10	12	15-25		5							
1+30	Lt.	R.C.R.#2 CL. II DRIVE	0	7	12	15-25		380	340	62	62		62	454	
1+30	Rt.	R.C.R.#2 CL. II DRIVE	0	5	12	15-25		22							
7+00	Rt.	R.C.R.#2 CL. II DRIVE	2	6	12	15-25		17							
14+80	Lt.	R.C.R.#2 CL. II DRIVE	35	5	12	15-25	20%	50		43	43		43		
18+00	Lt.	R.C.R.#3 CL. II DRIVE	0	5	12	15-25		21							
18+00	Rt.	R.C.R.#3 CL. II DRIVE	0	5	12	15-25		21							
21+90	Lt.	A.R.#2 CL. II DRIVE	0	10	12	15-25	20%	51							
26+50	Lt.	A.R.#3 CL. II DRIVE	0	4	12	15-25		175							
39+64.78	Lt.	S-1-28 TYPE "B" APPR.	*	*	18	36.3-58		81		317	317		317		
39+64.78	Rt.	S-1-28 TYPE "B" APPR.	*	*	18	36.3-58		81		317	317		317		
55+50	Lt.	S-1-28 TYPE "D" APPR.	*	*	18	25-25		230		507	507		507		
4+00	Rt.	R.C.R.#4 CL. II DRIVE	0	5	12	15-25		21							
13+00	Lt.	R.C.R.#4 CL. II DRIVE	0	26	12	15-25		45							
16+15	Lt.	R.C.R.#4 CL. II DRIVE	0	23	12	15-25		28		41	41		41		
34+00	Lt.	R.C.R.#4 CL. II DRIVE	30	5	12	15-25	10%	67	27						
37+00	Lt.	R.C.R.#4 CL. II DRIVE	10	0	12	15-25		41							
6+00	Lt.	A.R.#4 CL. II DRIVE	0	13	12	15-25		38							
13+00	Rt.	A.R.#5 CL. II DRIVE	0	10	12	15-25		50							
19+50	Rt.	A.R.#5 CL. II DRIVE	0	10	12	15-25		35							
25+50	Lt.	A.R.#5 CL. II DRIVE	0	5	12	15-25		38							

* Included in Access Road or Relocated County Road Earthwork.
 ** Temporary RW Required For Drive Construction.
 ① Out of Sequence

DETAILS

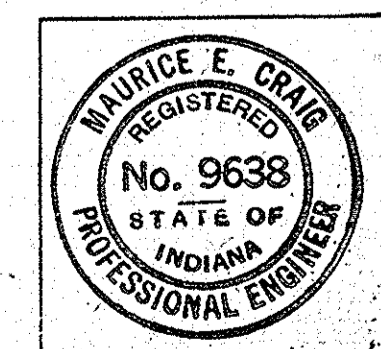



RIGHT-OF-WAY PLAT #3
PROJECT: I-64-3(33)86
MOSAIC SCALE 1" = 400' SHEET 1 of 11
DATE OF PHOTOGRAPHY: 3-31-65
SOURCE:
UNCONTROLLED PHOTO MOSAIC
INDIANA STATE HIGHWAY COMMISSION
BUREAU OF PHOTOGRAMMETRIC & ELECTRONIC PROCESSES




RIGHT-OF-WAY PLAT #3
PROJECT: I-64-3(33)86
MOSAIC SCALE 1" = 400' SHEET 2 of 11
DATE OF PHOTOGRAPHY: 3-31-65
SOURCE: UNCONTROLLED PHOTO MOSAIC
INDIANA STATE HIGHWAY COMMISSION
BUREAU OF PHOTOGRAMMETRIC & ELECTRONIC PROCESSES



RIGHT-OF-WAY PLAT #3
PROJECT: I-64-3(33)86
MOSAIC SCALE 1" = 400' SHEET 3 of 11
DATE OF PHOTOGRAPHY: 3-31-65
SOURCE: UNCONTROLLED PHOTO MOSAIC
INDIANA STATE HIGHWAY COMMISSION
BUREAU OF PHOTOGRAMMETRIC & ELECTRONIC PROCESSES




RIGHT-OF-WAY PLAT #3
PROJECT: I-64-3(33)86
MOSAIC SCALE: 1" = 400' SHEET 4 of 11
DATE OF PHOTOGRAPHY: 3-31-65
SOURCE: UNCONTROLLED PHOTO MOSAIC
INDIANA STATE HIGHWAY COMMISSION
BUREAU OF PHOTOGRAMMETRIC & ELECTRONIC PROCESSES

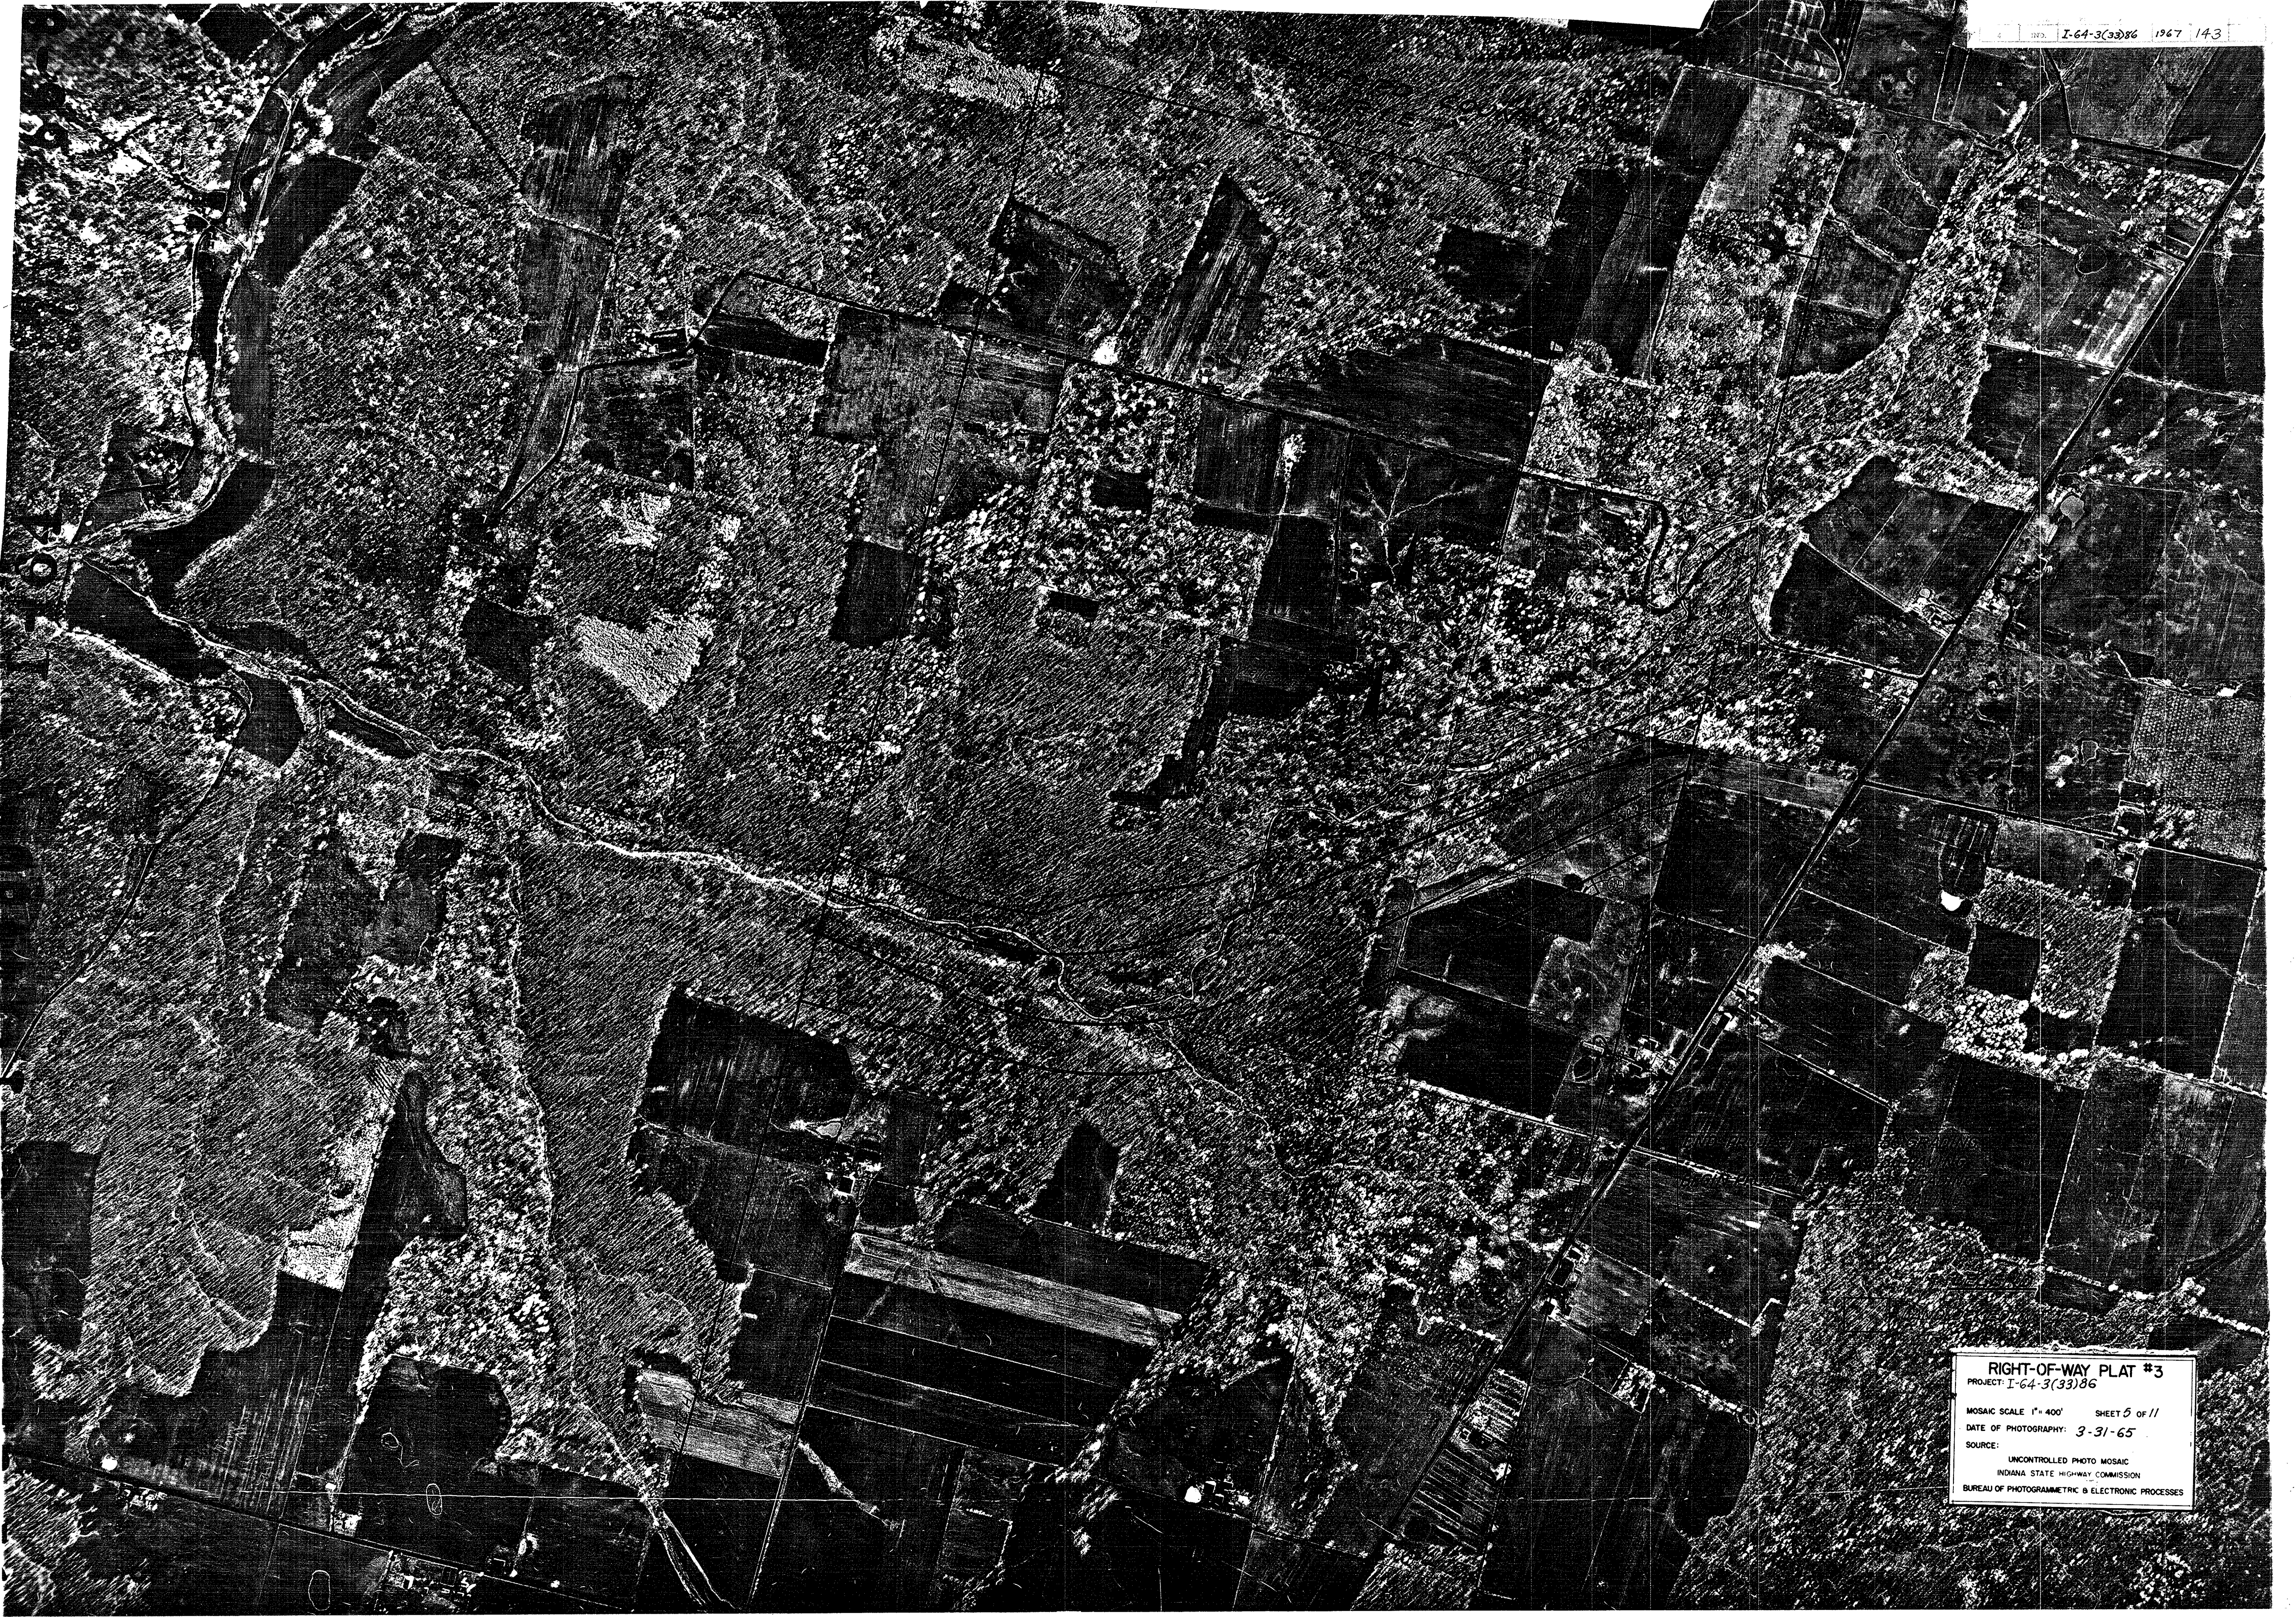

RIGHT-OF-WAY PLAT #3
PROJECT: I-64-3(33)86
MOSAIC SCALE: 1" = 400' SHEET 5 OF 11
DATE OF PHOTOGRAPHY: 3-31-65
SOURCE:
UNCONTROLLED PHOTO MOSAIC
INDIANA STATE HIGHWAY COMMISSION
BUREAU OF PHOTOGRAMMETRIC & ELECTRONIC PROCESSES




RIGHT-OF-WAY PLAT #3
PROJECT: I-64-3(33)86
MOSAIC SCALE 1" = 400' SHEET 6 OF 11
DATE OF PHOTOGRAPHY: 3-31-65
SOURCE:
UNCONTROLLED PHOTO MOSAIC
INDIANA STATE HIGHWAY COMMISSION
BUREAU OF PHOTOGRAMMETRIC & ELECTRONIC PROCESSES

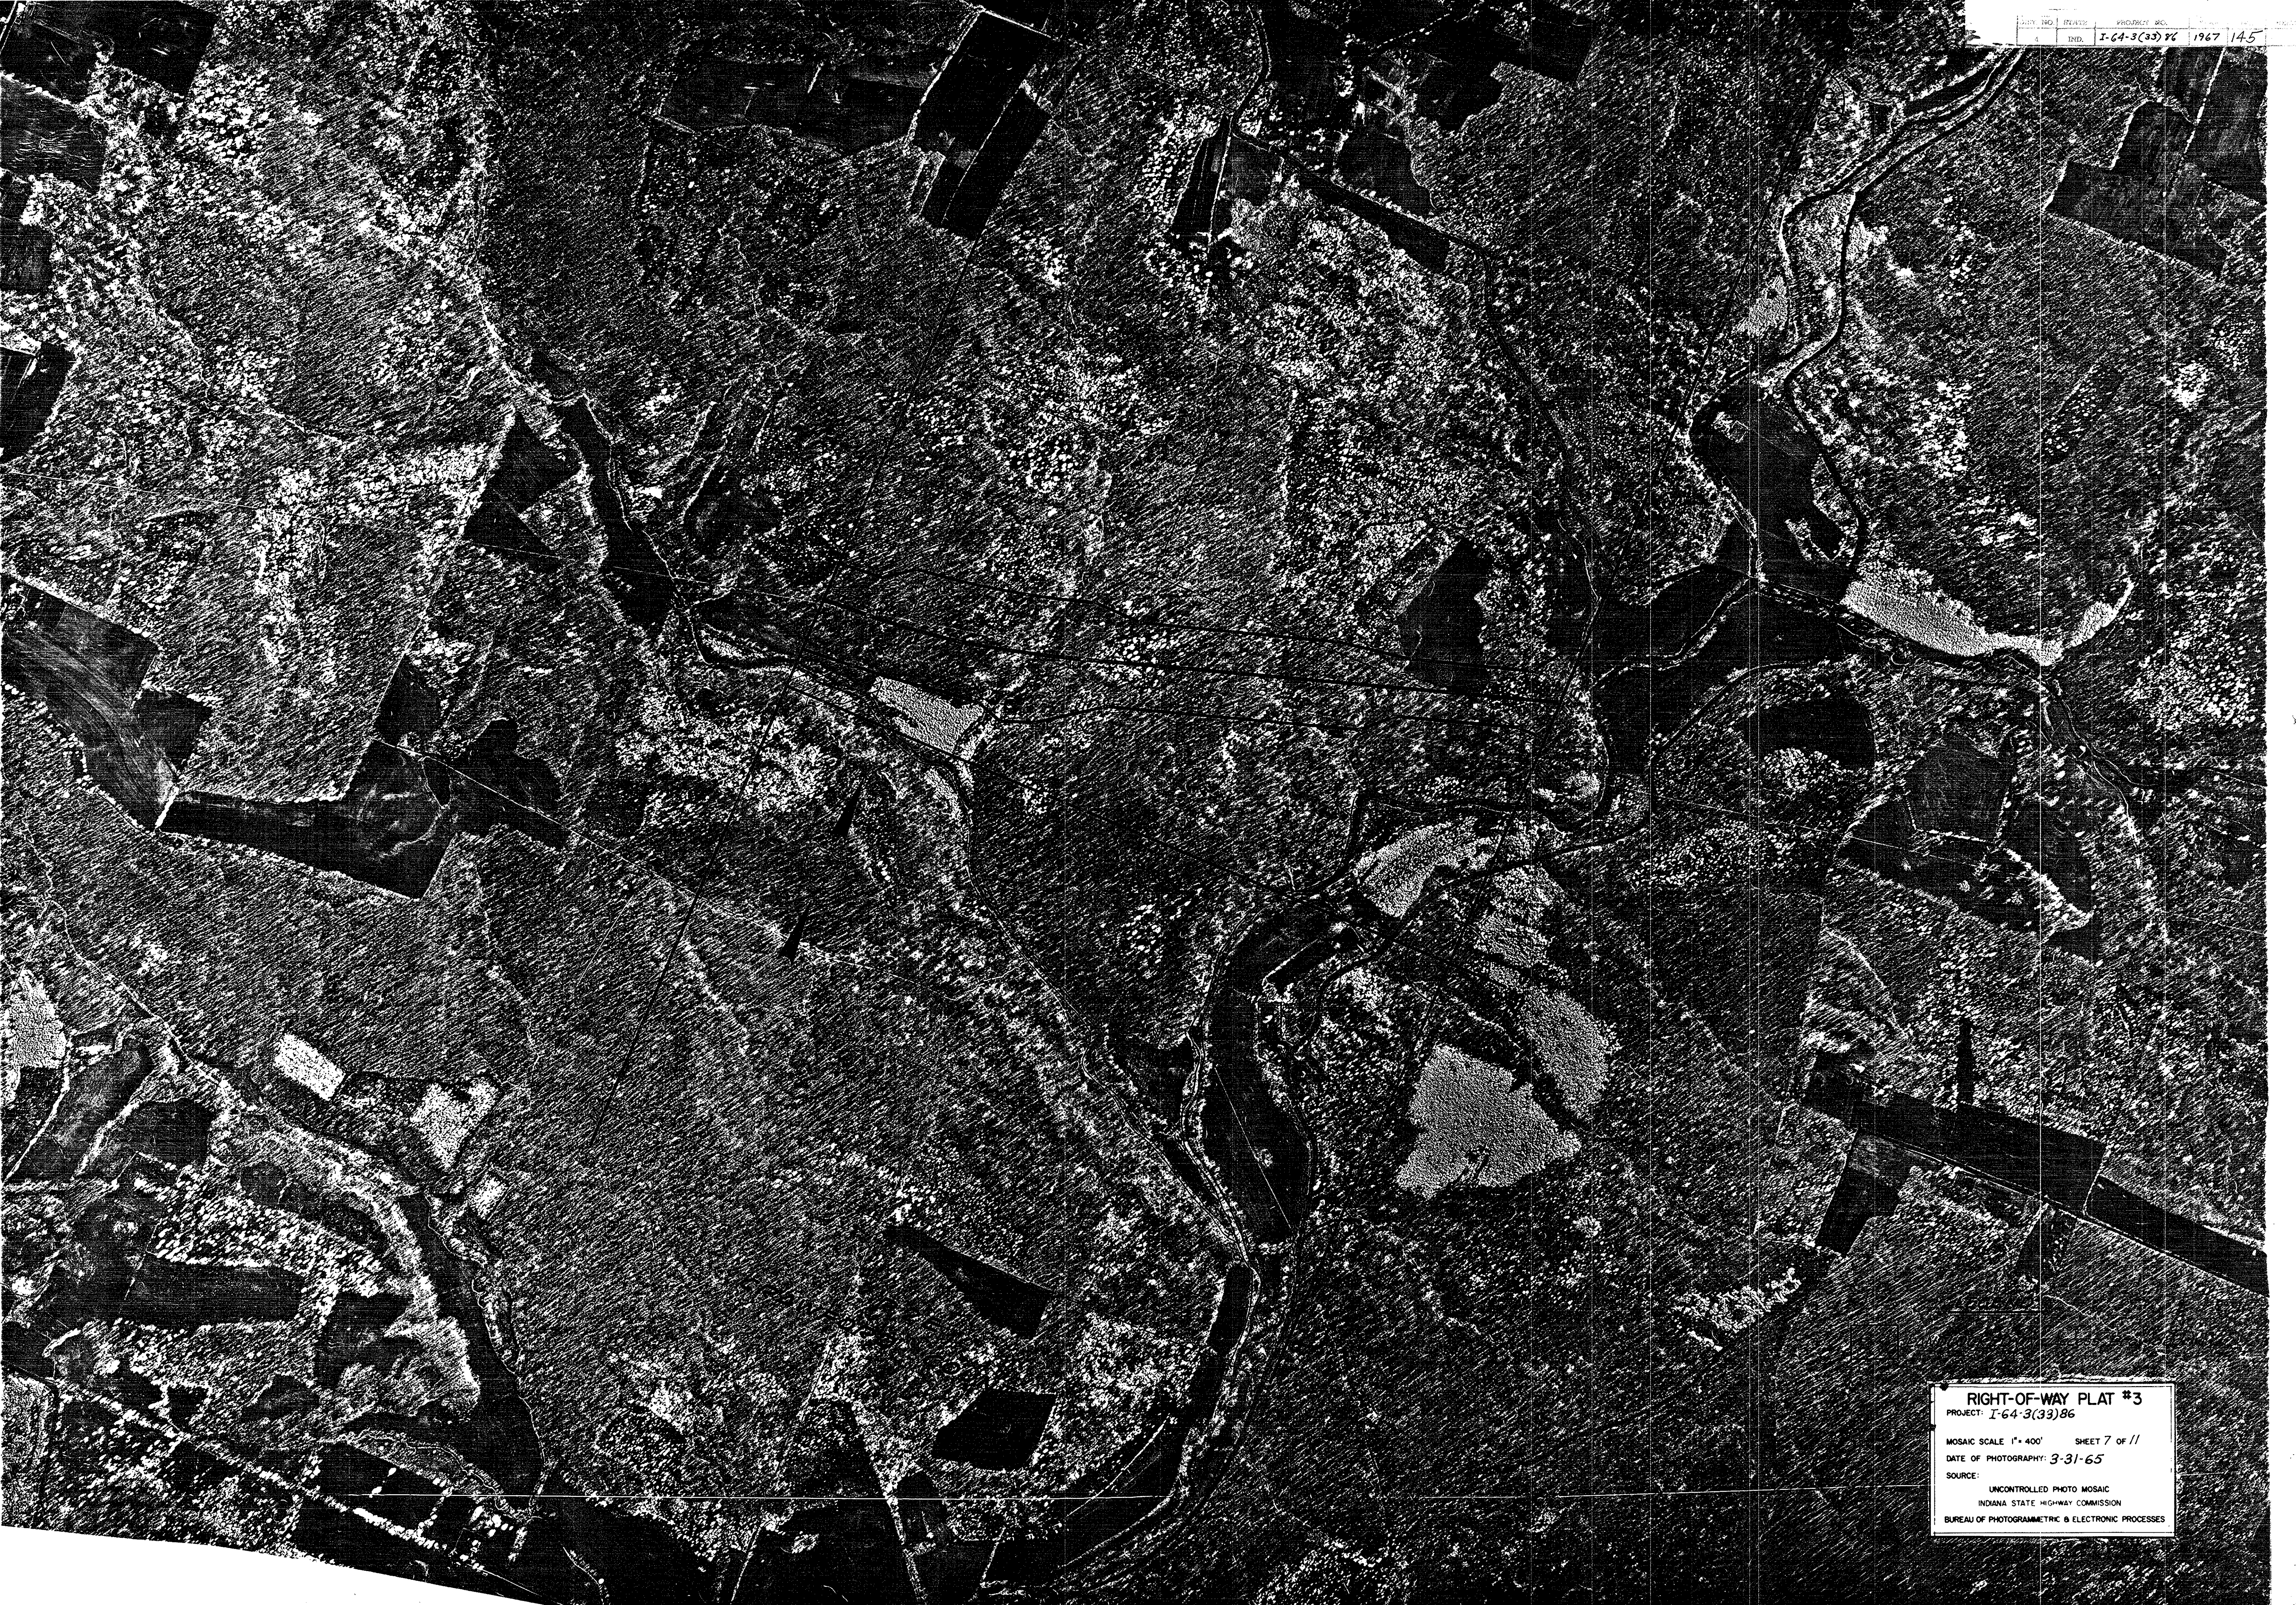

RIGHT-OF-WAY PLAT #3
PROJECT: I-64-3(33)86
MOSAIC SCALE 1" = 400' SHEET 7 OF 11
DATE OF PHOTOGRAPHY: 3-31-65
SOURCE: UNCONTROLLED PHOTO MOSAIC
INDIANA STATE HIGHWAY COMMISSION
BUREAU OF PHOTOGRAMMETRIC & ELECTRONIC PROCESSES



RIGHT-OF-WAY PLAT #3
PROJECT I-64-3(33)86
MOSAIC SCALE 1" = 400' SHEET 8 OF 11
DATE OF PHOTOGRAPHY 3-31-65
SOURCE: UNCONTROLLED PHOTO MOSAIC
INDIANA STATE HIGHWAY COMMISSION
BUREAU OF PHOTOGRAMMETRIC & ELECTRONIC PROCESSES

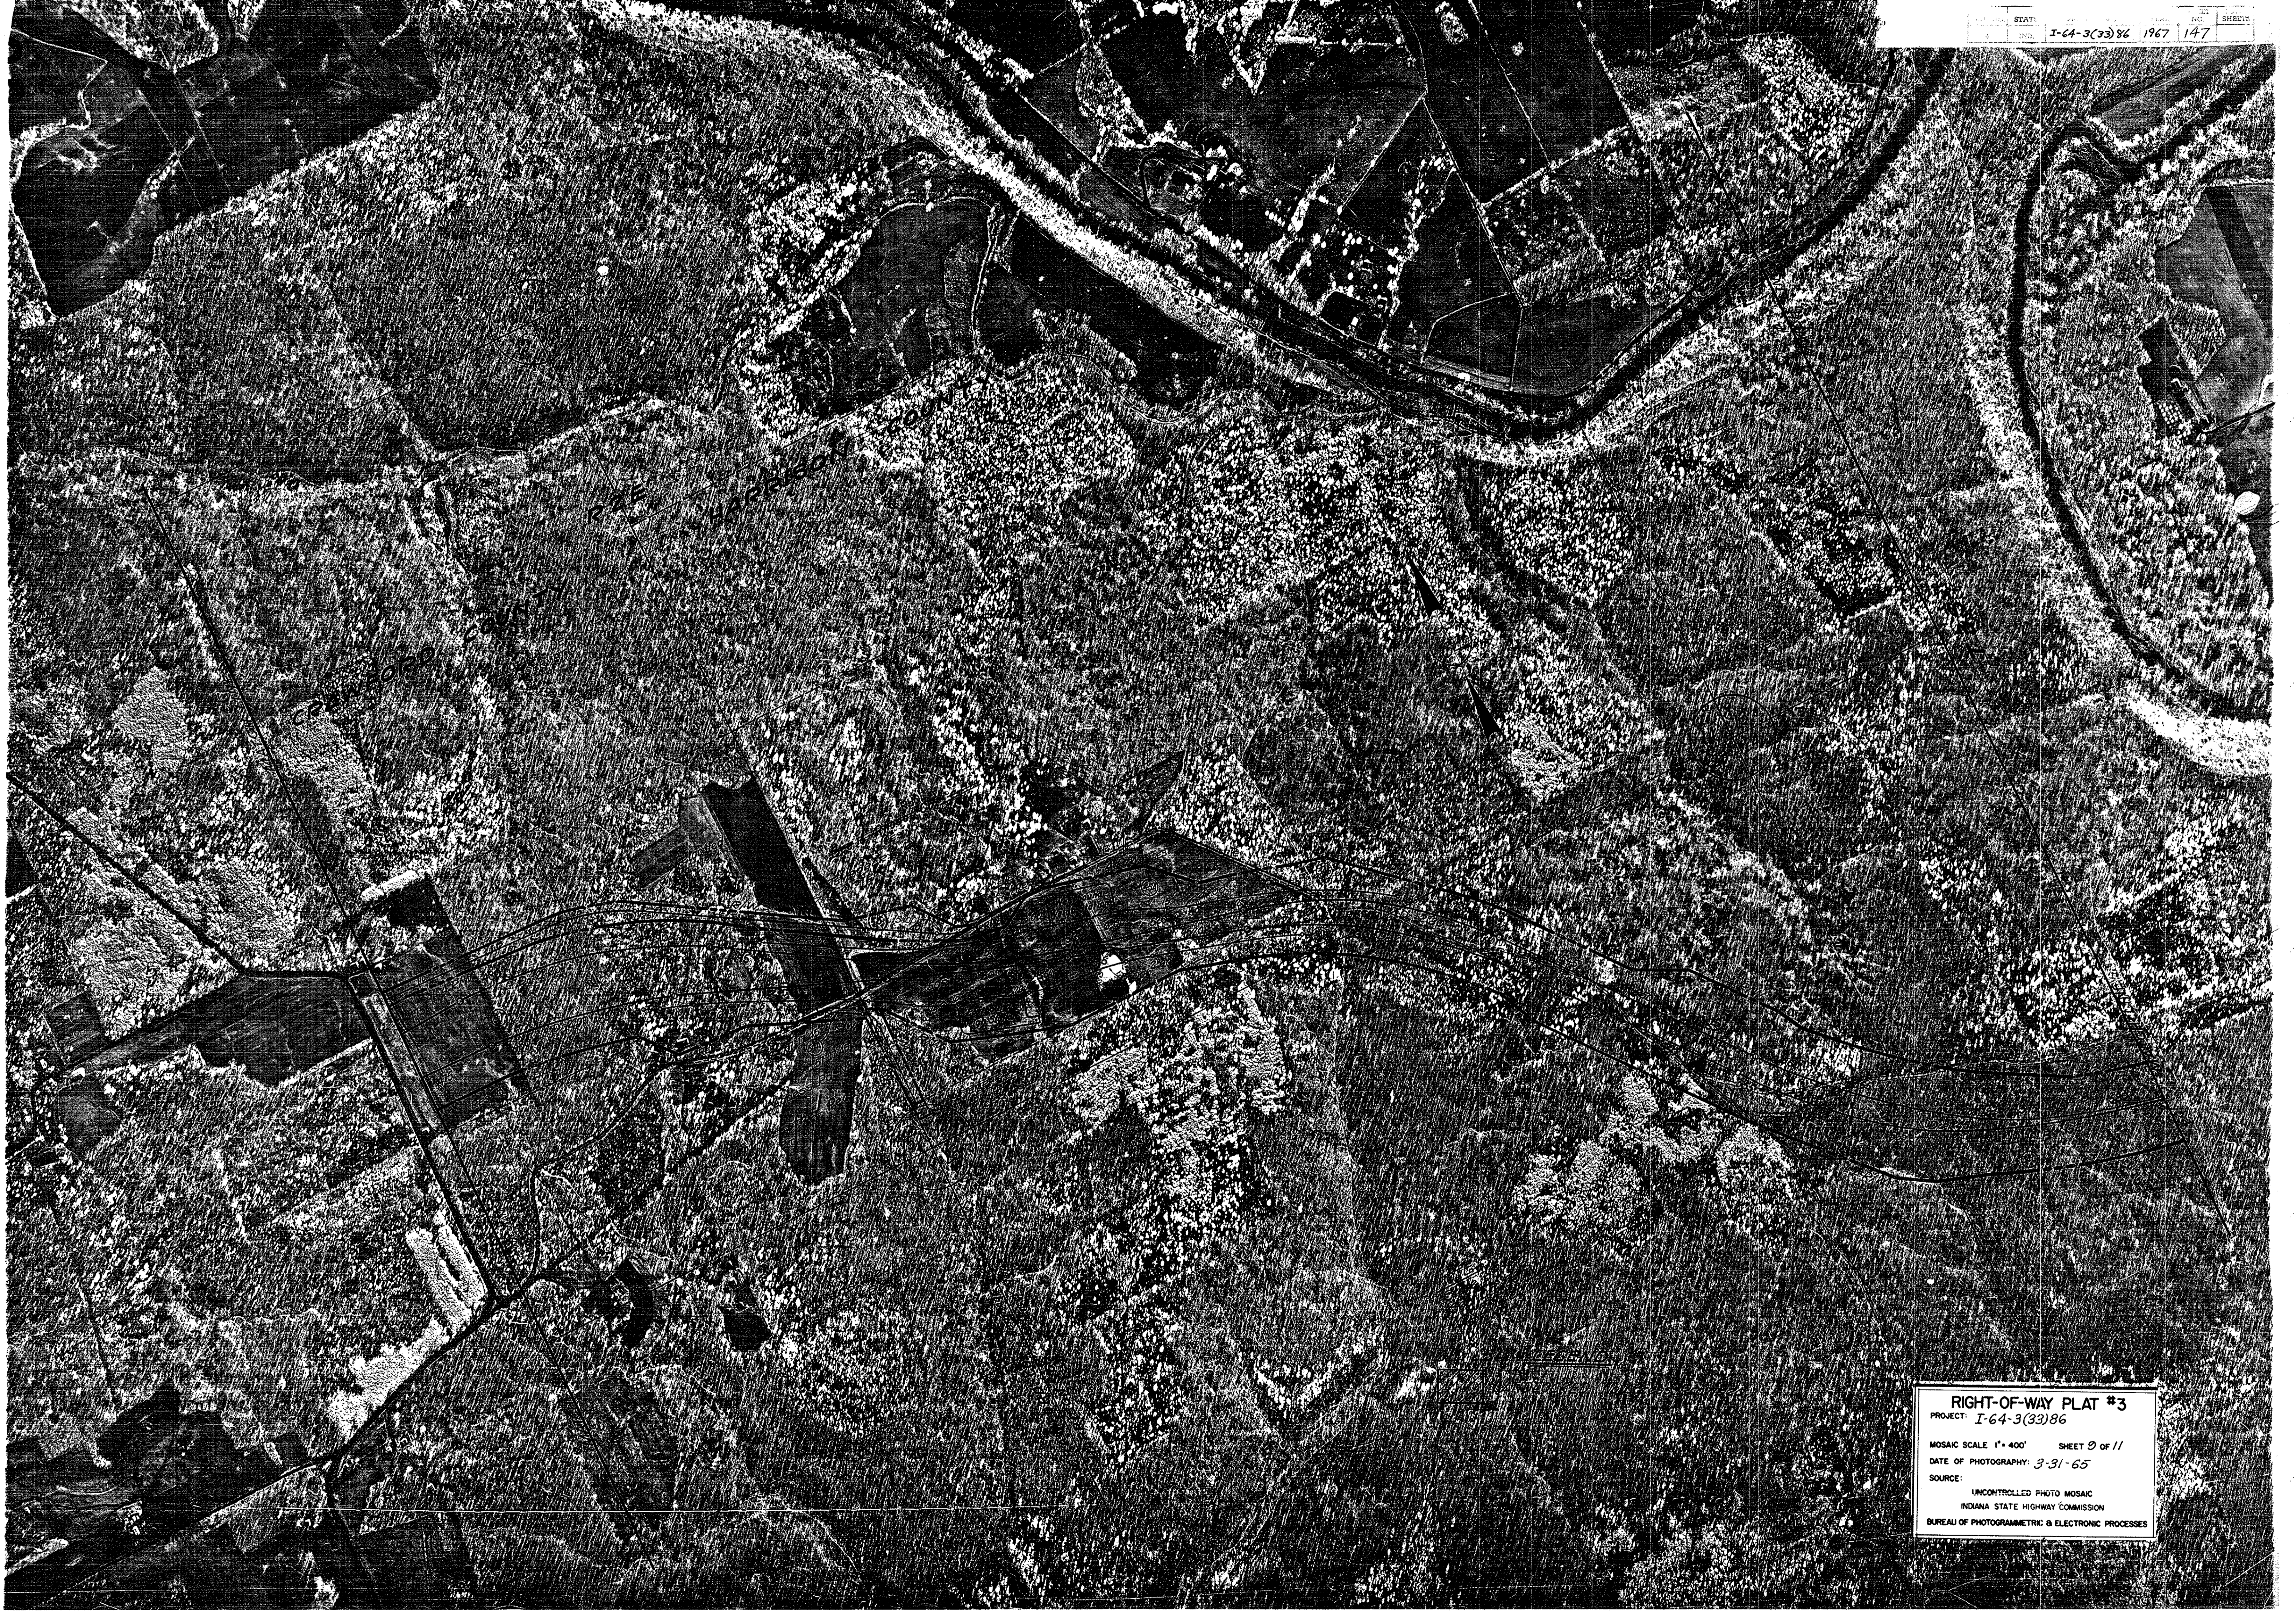

RIGHT-OF-WAY PLAT #3
PROJECT: I-64-3(33)86
MOSAIC SCALE 1" = 400' SHEET 2 of 11
DATE OF PHOTOGRAPHY: 3-31-65
SOURCE:
UNCONTROLLED PHOTO MOSAIC
INDIANA STATE HIGHWAY COMMISSION
BUREAU OF PHOTOGRAMMETRIC & ELECTRONIC PROCESSES

HARRISON
22E

RIGHT-OF-WAY PLAT #3
PROJECT: I-64-3(33)86
MOSAIC SCALE: 1" = 400' SHEET 10 OF 11
DATE OF PHOTOGRAPHY: 3-31-65
SOURCE: UNCONTROLLED PHOTO MOSAIC
INDIANA STATE HIGHWAY COMMISSION
BUREAU OF PHOTOGRAMMETRIC & ELECTRONIC PROCESSES



RIGHT-OF-WAY PLAT #3
PROJECT: I-64-3(33)86
MOSAIC SCALE: 1" = 400' SHEET 11 of 11
DATE OF PHOTOGRAPHY: 3-31-65
SOURCE: UNCONTROLLED PHOTO MOSAIC
INDIANA STATE HIGHWAY COMMISSION
BUREAU OF PHOTOGRAMMETRIC & ELECTRONIC PROCESSES