ROAD CONTRACT NO. INDEX DATE ADOPTED "A" or LATEST REVISION "R" DESIGNATION SHEET NO. TITLE SHEET
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TYPICAL CROSS SECTION ST'D. 8 INCH RAMP SECTION ST'D. 10 INCH RAMP SECTION ST'D. PAVEMENT JOINTS SHEET "A" PLAN AND PROFILE OF PROPOSED STRUCTURE DATA
STRUCTURE DATA
ESTIMATE OF QUANTITIES STATE HIGHWAY ESTIMATE OF QUANTITIES MISCELLANEOUS STANDARDS, SHEET "MA".

MISCELLANEOUS STANDARDS, SHEET "MB"

MISCELLANEOUS STANDARDS, SHEET "MC"

MISCELLANEOUS STANDARDS, SHEET "MC"

MISCELLANEOUS STANDARDS, SHEET "MD"

MISCELLANEOUS STANDARDS, SHEET "MD"

MISCELLANEOUS STANDARDS, SHEET "ME"

MISCELLANEOUS STANDARDS, SHEET "MF"

MISCELLANEOUS STANDARDS, SHEET "MG"

MISCELLANEOUS STANDARDS, SHEET "MG"

MISCELLANEOUS STANDARDS, SHEET "MH"

MISCELLANEOUS STANDARDS, SHEET "MH" ST-F PROJECT NO. 95 MISCELLANEOUS STANDARDS, SHEET "MI MISCELLANEOUS STANDARDS, SHEET "MJ"

MISCELLANEOUS STANDARDS, SHEET "MK"

MISCELLANEOUS STANDARDS, SHEET "MN"

MISCELLANEOUS STANDARDS, SHEET "MP"

MISCELLANEOUS STANDARDS, SHEET "MQ"

MISCELLANEOUS STANDARDS, SHEET "MR"

MISCELLANEOUS STANDARDS, SHEET "S"

MISCELLANEOUS STANDARDS, SHEET "S" Commencing At A Point Approximately 2,050 Feet West Of And 875 Feet South Of The Northeast Corner Of Section 20, Township 22 North, Range 8 West in Warren County And Running In A Northerly Direction For A Distance Of 39,506 Feet To A Point Approximately 2,353 Feet East Of And 154 Feet North Of The Southwest Corner Of Section 7, Township 23 North, Range 8 West, All In Warren County MISCELLANEOUS STANDARDS, SHEET "S-I MISCELLANEOUS STANDARDS, SHEET "MT GROSS LENGTH:- 7.482 MI. MISCELL'ANEOUS STANDARDS, SHEET "M'V" NET LENGTH:-SCALES:-Sta. 708+00.00 Line "J" PROFILE (HORIZ:-1"=100' LONG: 1"=100' End Project ST-F-95(9) PLAN TRANS:-1"=100" Begin Project ST-F-95(10) ST'D. GUARD RAIL STEEL BEAM GUARD RAIL T24N T23N ST'D. FOR SUPERELEVATION AND WIDENING OF CURVES ST'D. DETOUR SIGNS, SHEET ! ST'D. DETOUR SIGNS, SHEET 2 ST'D. DETOUR SIGNS, SHEET 3 ST'D. DETOUR SIGNS, SHEET 4 CROSS SECTIONS R/W INDEX REVISIONS REVISED DESIGNATION SHEET NO. -12-71, 1-26-71 R/W, DELTA. 5-24-71 ADD SIGN IN R/W. TITLE
TYPICAL CROSS SECTION 8,24\$32 5-6 PLAT NO. I 6-29-21 MOVED R 9,27,14,15,29 PLAN & PROFILE 6-29-71 PARCEL 3-D DETAILS 31-42 ADDED R.R. 5,7,25,31 6-29-71 APPROACH TABLE 6-29-71 EXTENDED L.S.R. 11-18-71 Rd. D. Apprl. noted 2-2-72 ADDED TOPO-BLDGS. 2-4-72 ADDED TEMP. R/W. RIGHT - OF- WAY PLATS 3 44-47 9,4,15, 21, 25 7 **\$ 25** 2 & 2A PARCEL LISTING 9/1-6/72 CORRECTED REARERS. 2,6,17,18 \$46 9-10-72 NAME REVISED, PARCEL 20.
2,5,7,25 \$44 10-31-72 NAME CHANGE - PARCEL 1
2,5,11,12,28,45 11-8-72 NAME CHANGE - PARCEL 10
2,5,14,29\$45 7-24-72 NAME CHANGE - PARCEL 13. 2,5,13,14,29445 8-4-72 NAME CHANGE - PARCEL 12. 9-20-72 CORRECTED AREAS. T23N 11-9-72 CORRECTED AREAS: X-REFERENCE PARCELS 1, 243 W 2,7,8,9,71,22,73, 24,25 \$31 PARCELS 28, 29430-5TF-307(12). B "3-3-1"

STRUCTURE NO. 1
To Be Built in Combination

Bridge File No. 41-P9-5983 Project No. ST-F-95(9)

Sta. 329 + 60.03 LINE "J-SB"

With Road Contract

No Exception:

INDIANA STATE HIGHWAY COMMISSION

TO BE USED WITH THESE PLANS.

STANDARD SPECIFICATIONS DATED 1963

STATE OF INDIANA

INDIANA STATE HIGHWAY COMMISSION

CODE 1000

D	ESIGN DA	TA	
A.D.T. (1970)		6,590	V. P.D.
A.D.T. (1990) PRO	JECTED	11, 260	
D.H.V.			
DIRECTIONAL DIS	STRIBUTION		- 45 %
TRUCKS	DHV(8)	ADT(21)	%
DESIGN SPEED		70/	M.P.H.
ACCESS CONTRO)L	PAR	TIAL

ST-F-95(9) (969

IND.

WHEREVER IN THESE PLANS PROJECT NO. ST-F-95(9) APPEARS IT SHALL BE CONSTRUED AS MEANING PROJECT F-95(9)

LEGEND

BARRICADE, TYPE "A"


BARRICADE, TYPE"B"

TYPICAL SIGN STANDARDS

CONSTRUCTION IDENTIFICATION SIGNS

Plans Prepared

Engineer Associates, Inc. 425 S. THIRD AVE. EVANSVILLE, IND.

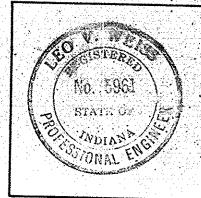

APPROVED

| ST-F-95(**9**) | - J | i |

November 6, 1961

LIBERTY

Begin Project ST-F-95 (9) Sta. 319 +96.4 Line "L"

CHICAGO & EASTERN

JORDAN

ENGINEER OF ROAD DESIGN, INDIANA STATE HIGHWAY COMMISSION

RECOMMENDED FOR APPROVAL

Scale 1"= | Mile

STRUCTURE NO. 2

With Road Contract

To Be Built In Combination

Bridge File No. 41-P9-5923 Project No. ST-F-95 (9) No Exception: Sta. 680 + 65.00 LINE "J"

WARREN

-(++) CONST.


MAX. GRADE 2.60%


RAINSVILLE


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			900																								
UE BLDG.	.82AC .88AC .*		45AC 61AC 61AC 61AC 61AC 74AE 5.0.79/ AC 30AC 92AC 77AC		* *							988 93AC * 73AC *	7.1AC	12AC 50AC 37AC 31AC	68AC 20AC 53AC	27AC 21AC 37AC		94AC 50AC 35AC		44ACC	SAG OAC	34C 77C	.2AC :8AC :5AC	546 646 140 740	24C	8AC 8AC	(AC 6AC * 8AG *
RESID AREA	C A= 49.22 B= 64.3 W ITH	O O O O O O O O O O O O O O O O O O O	A A B A B B B B B B B B B B B B B B B B		76/4	4 m m n n n n n n n n n n n n n n n n n	ш ш ш ш					A=146.1 B=199.7	, , , , , , , , , , , , , , , , , , ,	B= 37.81 C=201.80 A= 50.90 B= 13.1	A= 17.2 B= 16.4 C= 0.4	E= 0.8; A= 19.47		A= 39.39 B=248.45 C= 14.66		A=148.64 B= 70.54 A= 61.33	C= 155.18 A= 302.04	A=170.27 B= 60.23 C=158.66	A= 59.11 B=120.98 A=298.43	A= 70.86 B=197.98 A=125.94 B= 87.45	C=248.41 232.98 A=172.98 B=141.64 A=201.02	6 = 98.67 C= 65.75	A=374.75 B= 30.43 C= 39.46
URE LAND LE ACQUIRE	S 0.885A(E 0.009A(E 0.009A(E LA)	S 0.675AU E 0.067AU S 0.663AU HE SAME LAN	S 5-136A	E 0.614AC S 1.214AC S 2.737AC E 0.060AC	S <u>16 576 AC</u> E 0.091 AC E 0.095 AC S 1.424 AC	S 49.035AG P CONTR.SAL P CONTR.SAL	P CONTR.SAL P CONTR.SAL P CONTR.SAL P CONTR.SAL	SP CONTR.SALE SP CONTR.SALE SP CONTR.SALE SP MINERALS	MINERALS MINERALS MINERALS	P MINERALS P MINERALS P MINERALS	P MINERALS P MINERALS P MINERALS P MINERALS	2.04/ 2.030AC 3.978	3.005AC 0.189AC 1.036AC	8 -202AC	5 0.002AC 5 23.530AC	\$ 15.696AC	1.507AC 0.069AC	14.337AC	1.143AC 0.014AC	18.813AC	0.331AC 18.293AC	8.019AC 0.378AC	20.309AC 0.509AC 18.777AC	0.341AC 20.602AC	18.485AC 36.359AC	0 -115AC	22.245AC
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JUSR 41 COL D. FEL GRAF BER PARCEL	ACQUISTI KELL;JOH KELL;JOH KELL;JOH ACQUISTI	L-AMD N. I. C. C. S. C. C. ACQUIST	WYLTTI							4 , 6 , U	ကြာ မာျားမျိုး မွာ	SMILEY,M	WARRENC	JONE S.	SMITH. R	SWARNER.		CTTIZENS		ODEE, ME	ROHWEDDES POINTS	KRAMER	BANKEY, C.	BRIER, JA FREED, RUE	PENCE, MIL	YEOMAN	PROTSMAN.
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PLAT NO. I (For Design Dept.) Scale: 1"=1,000"

DETAILS

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PROJECT NO. LINE SHEET TOTAL NO. SHEETS
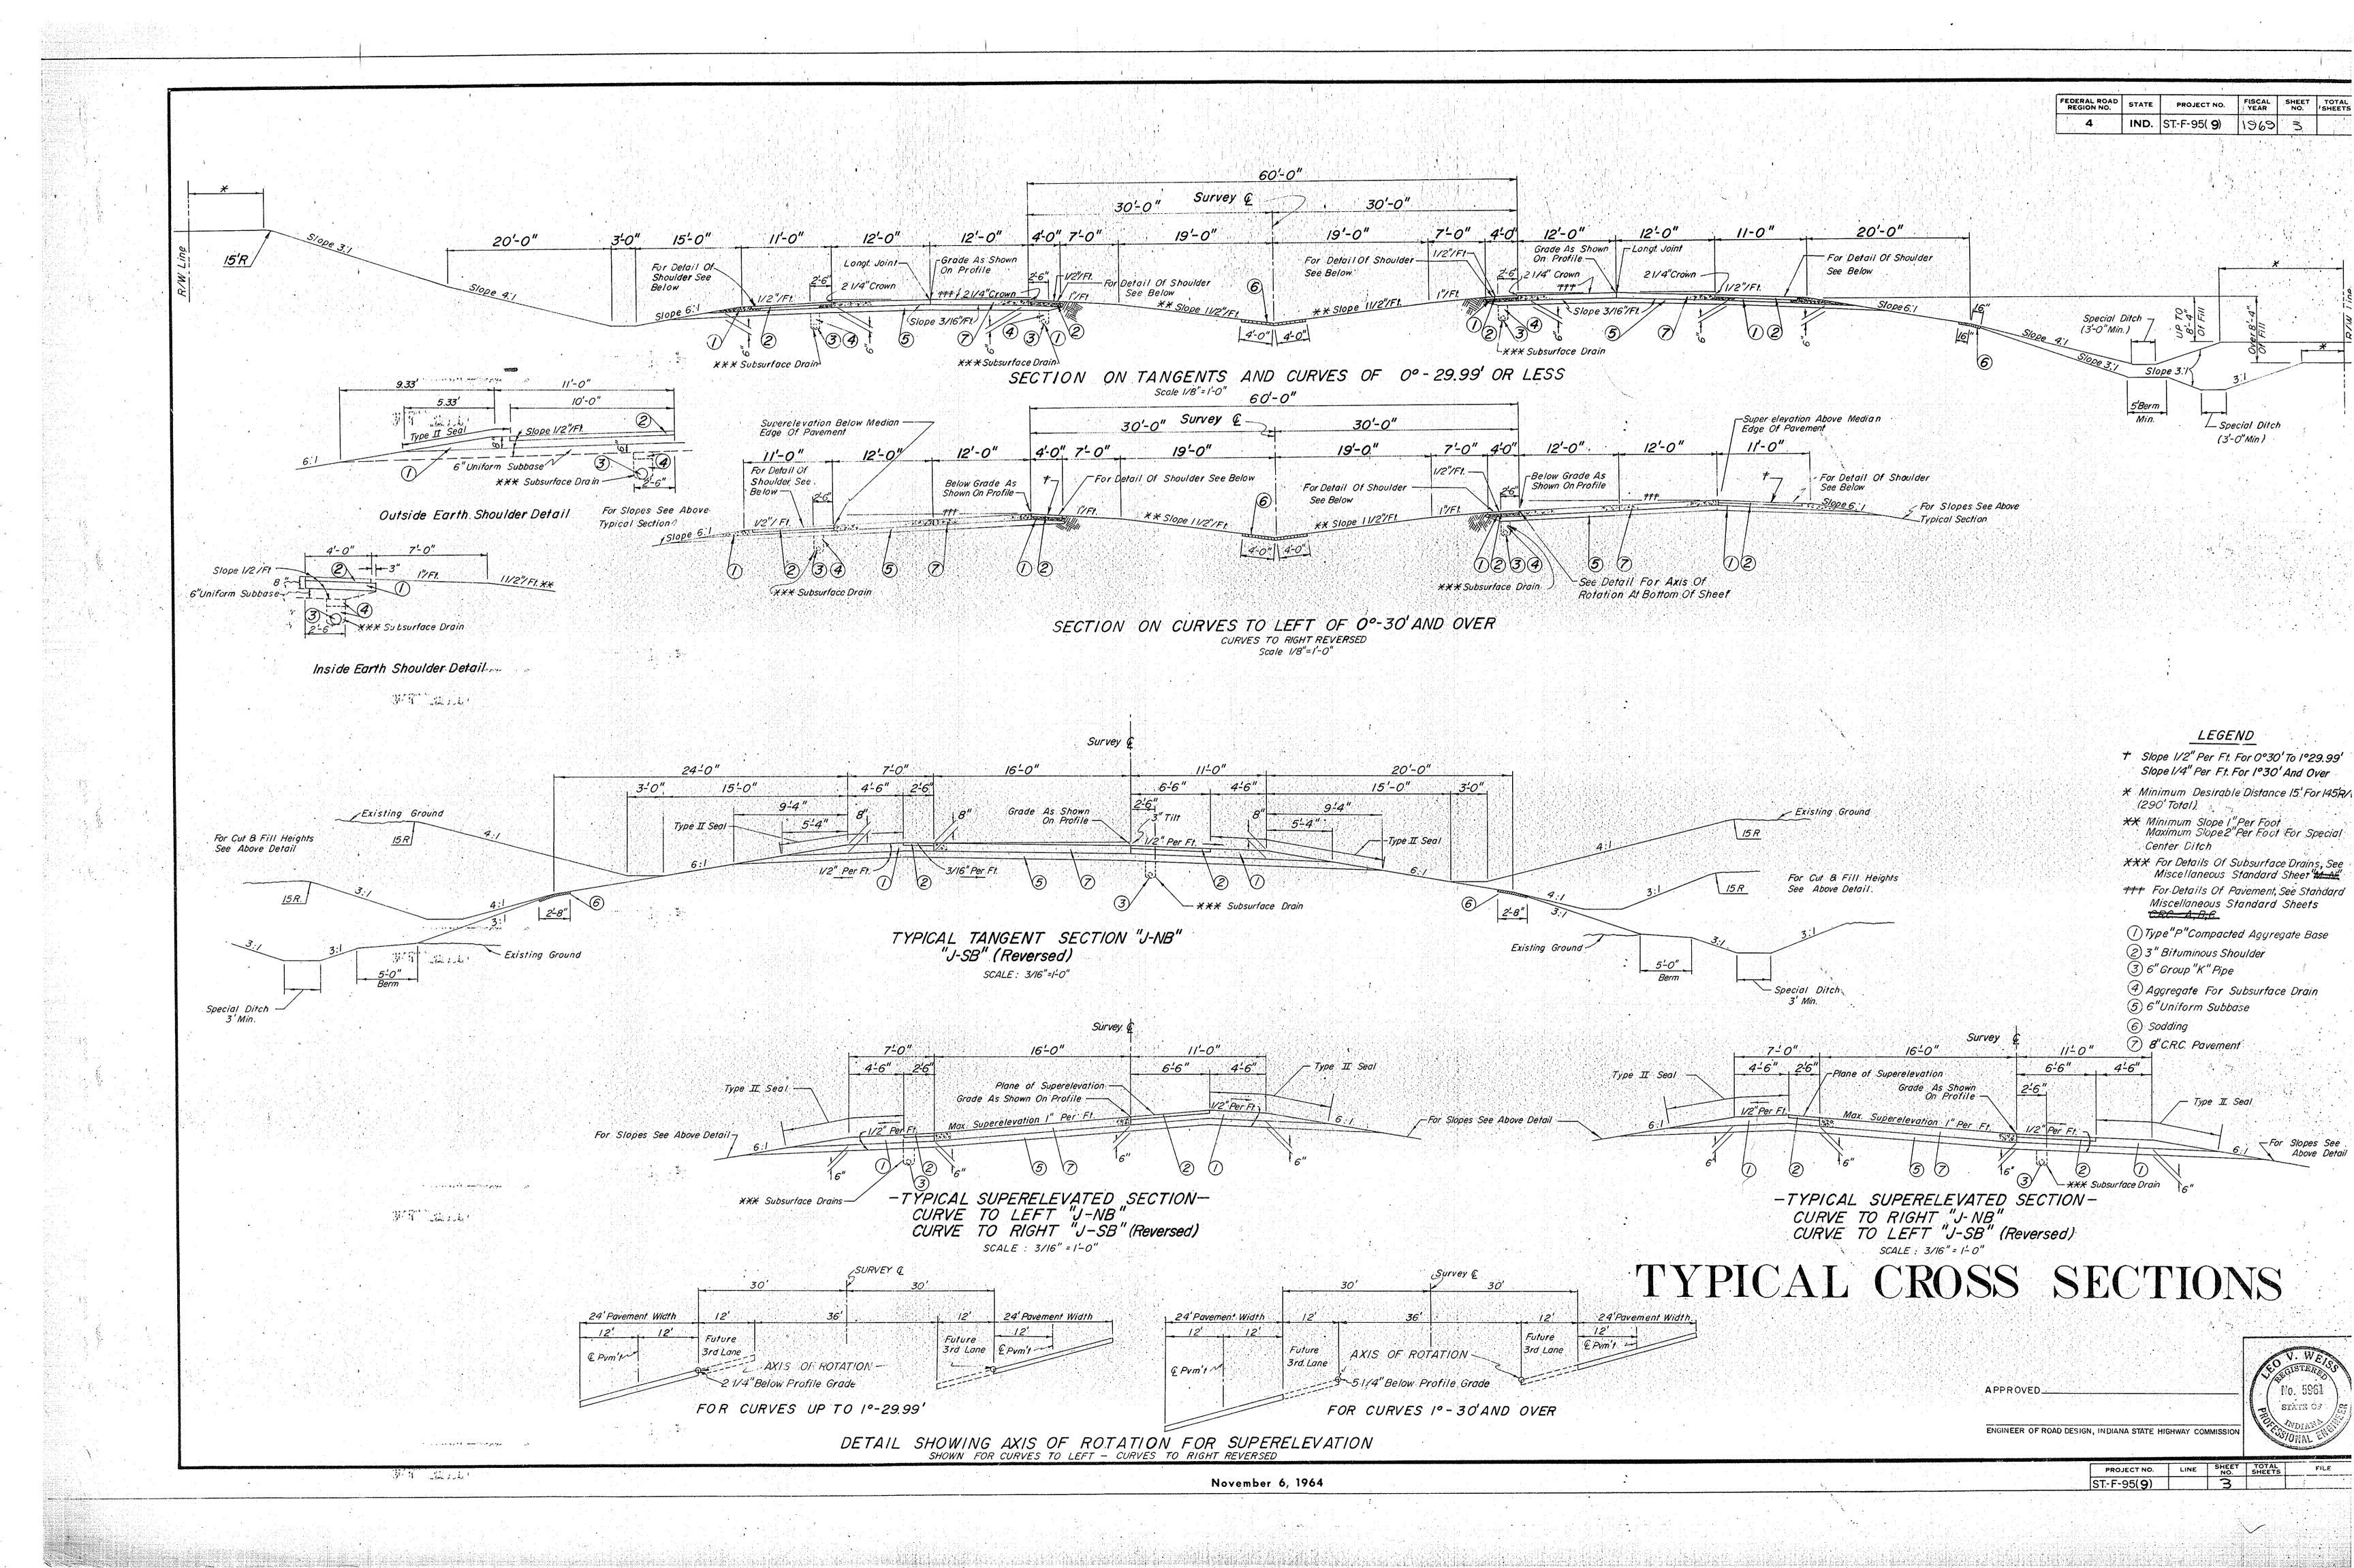
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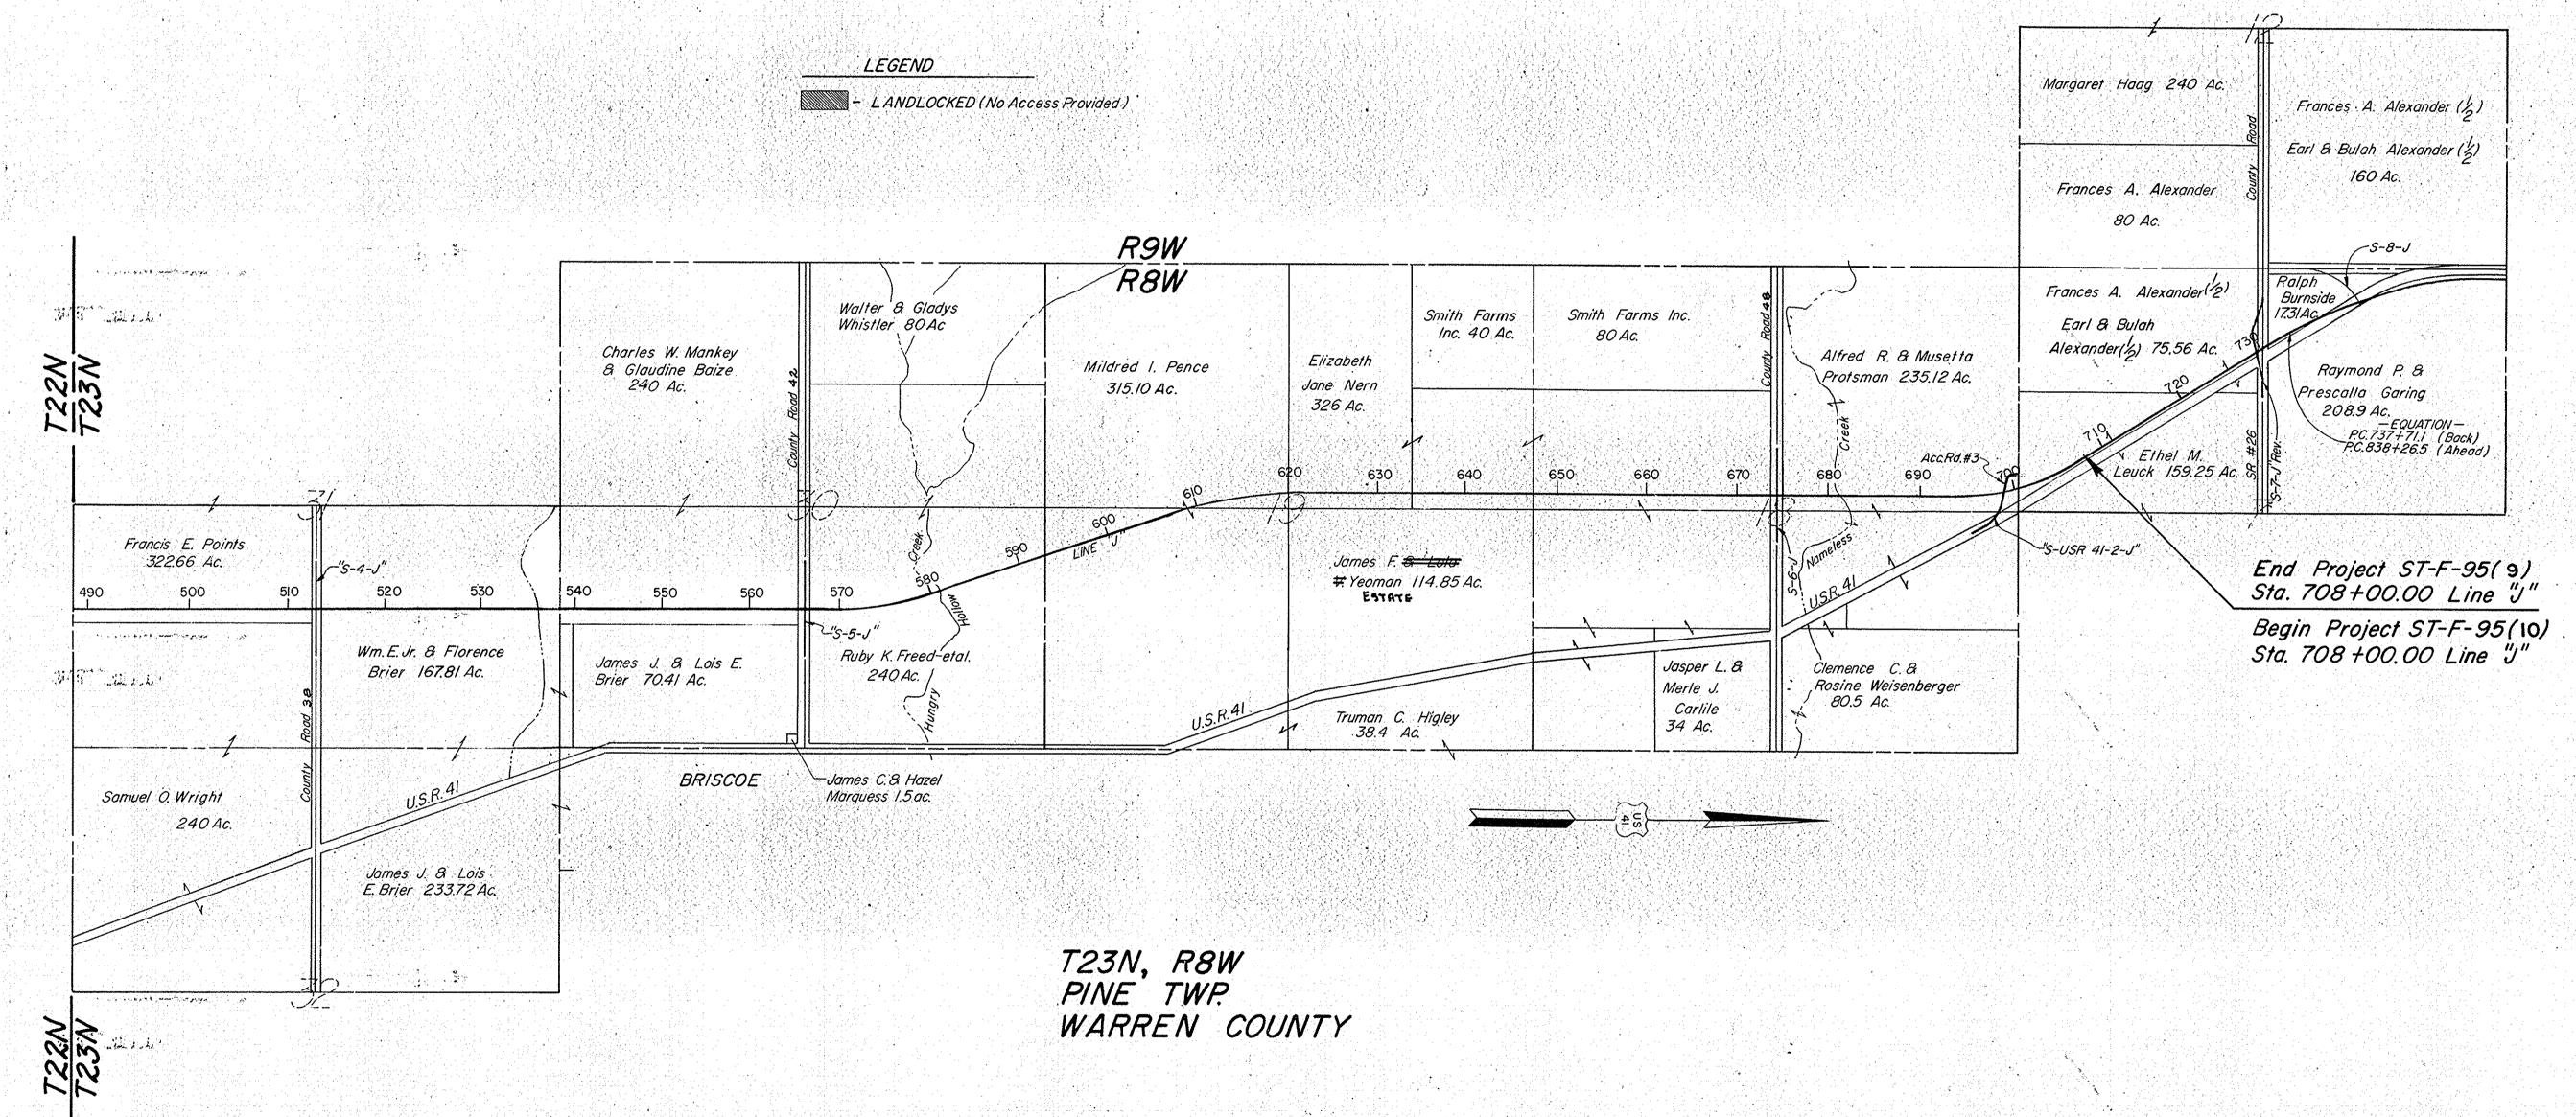
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T23N, R9W PRAIRIE TWP WARREN COUNTY

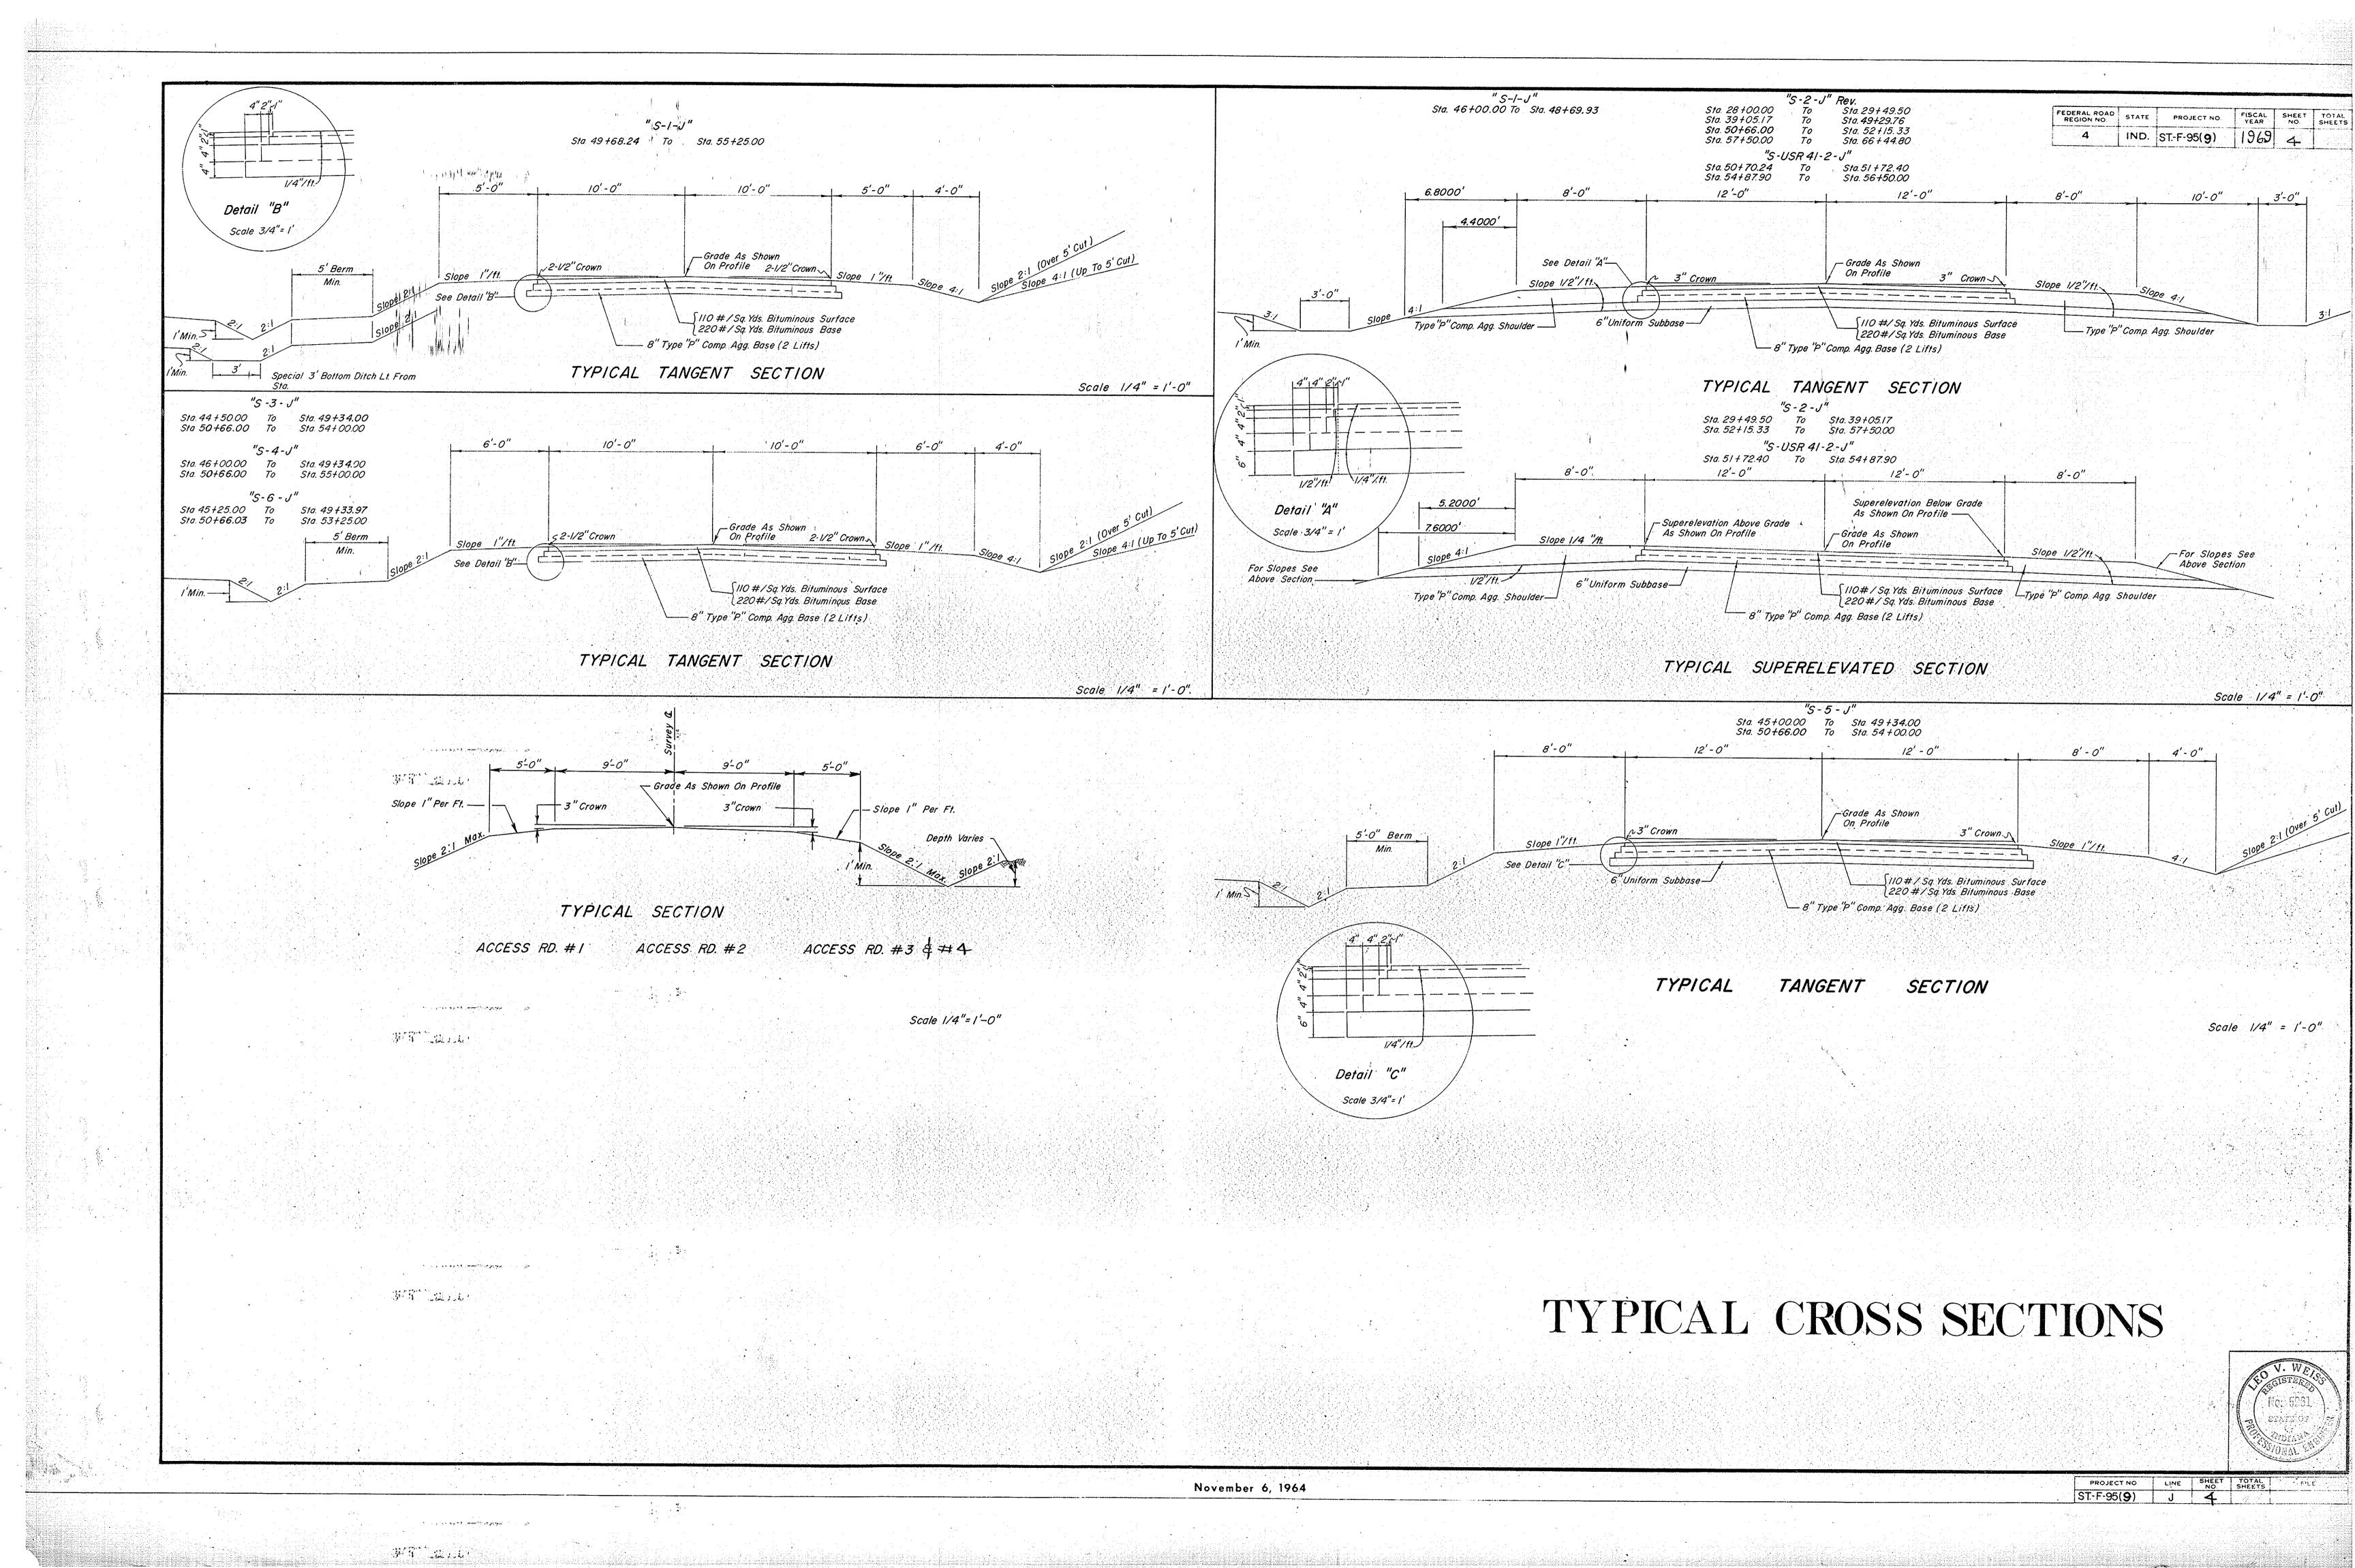


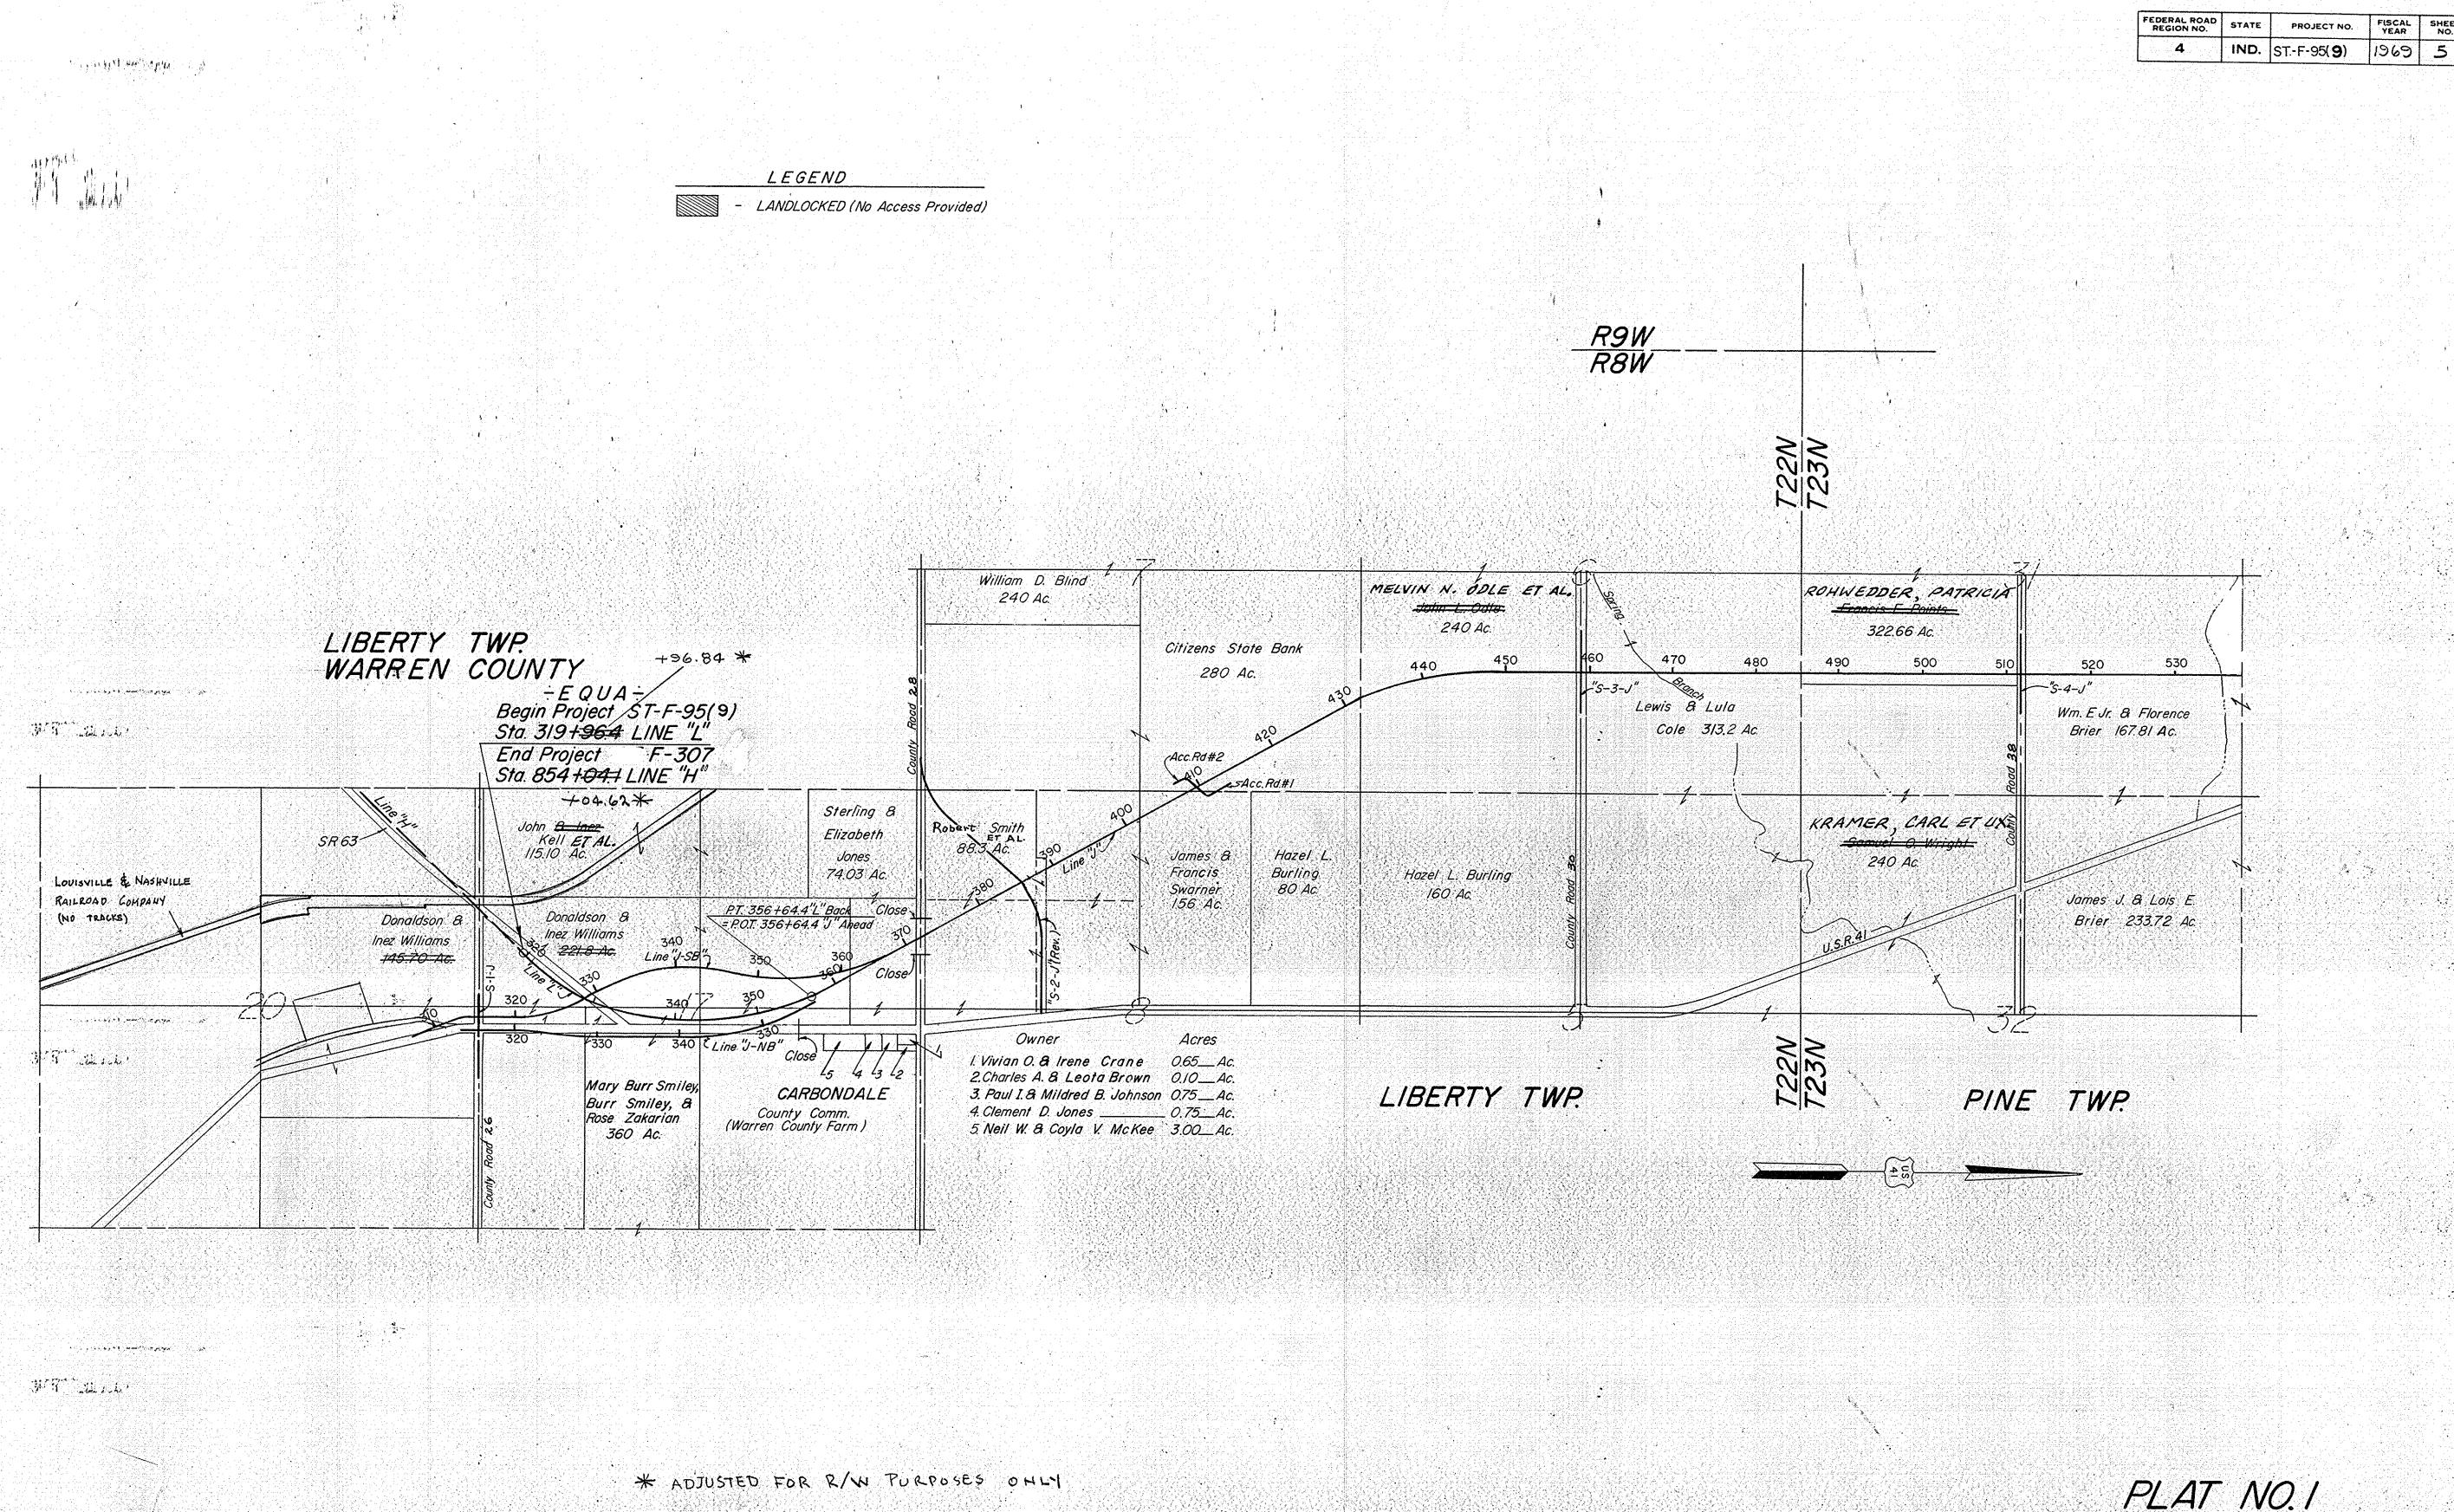
PLAT NO.1


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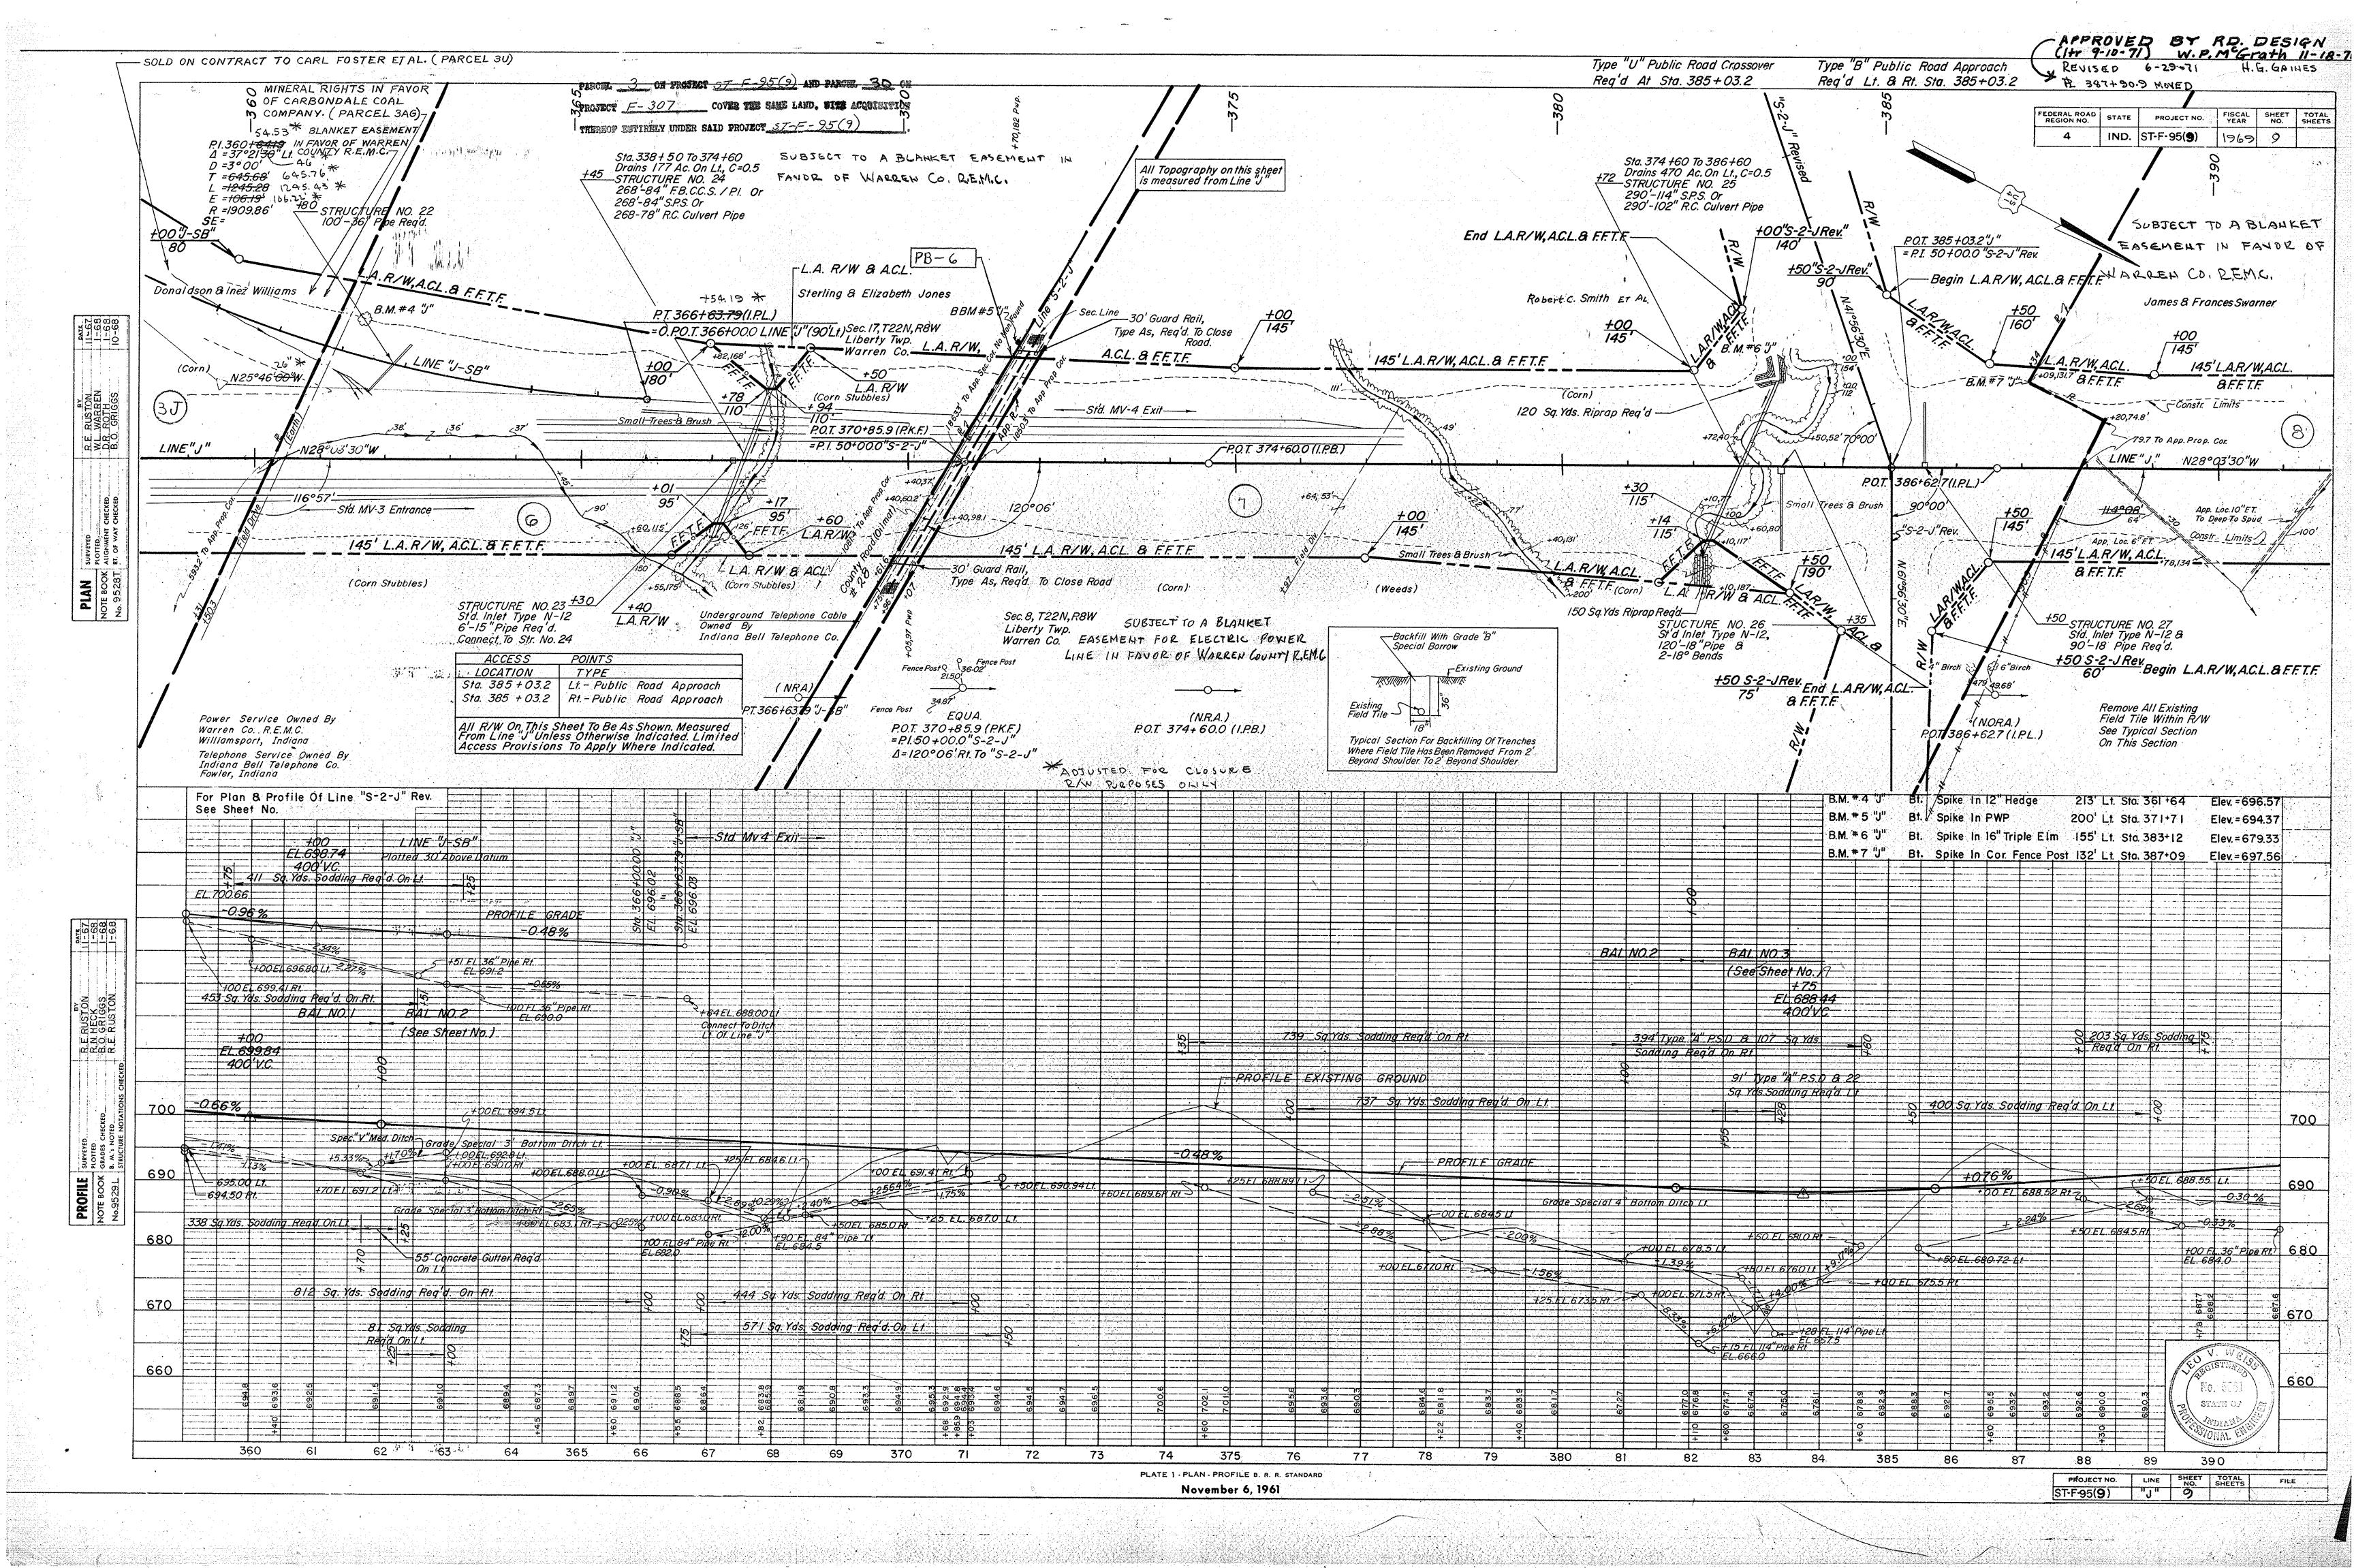
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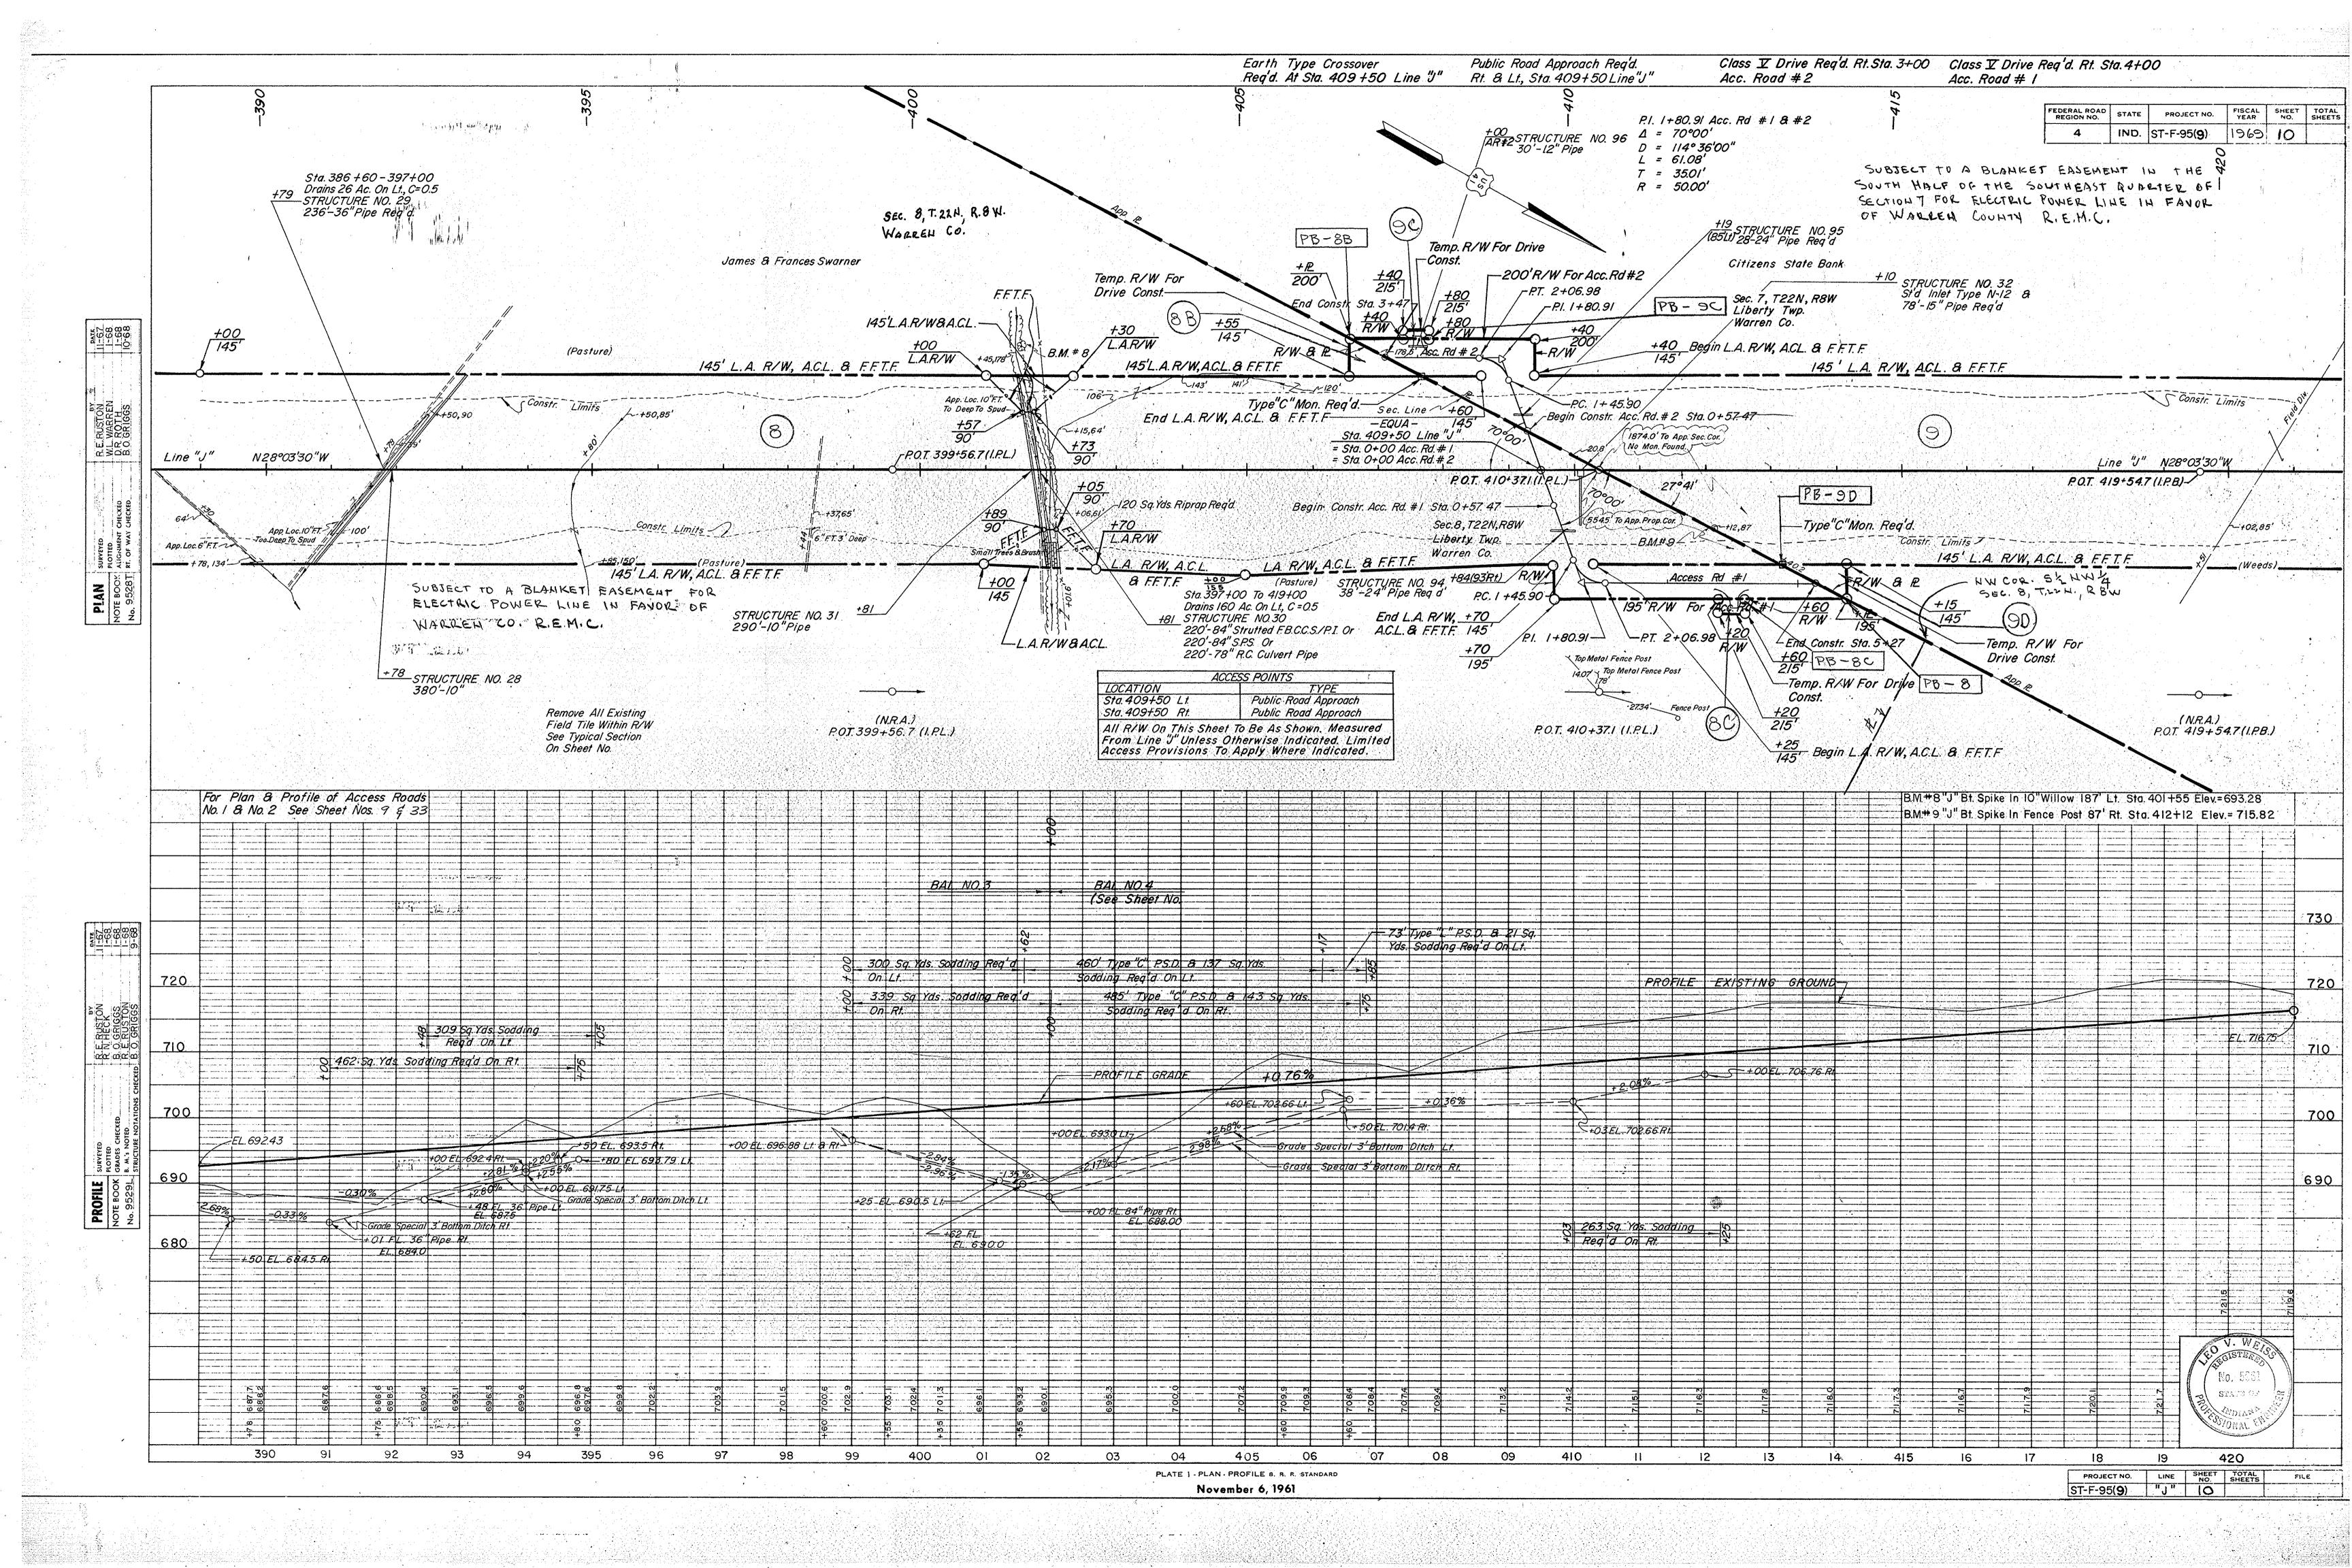
DETAILS







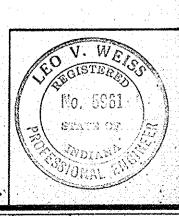


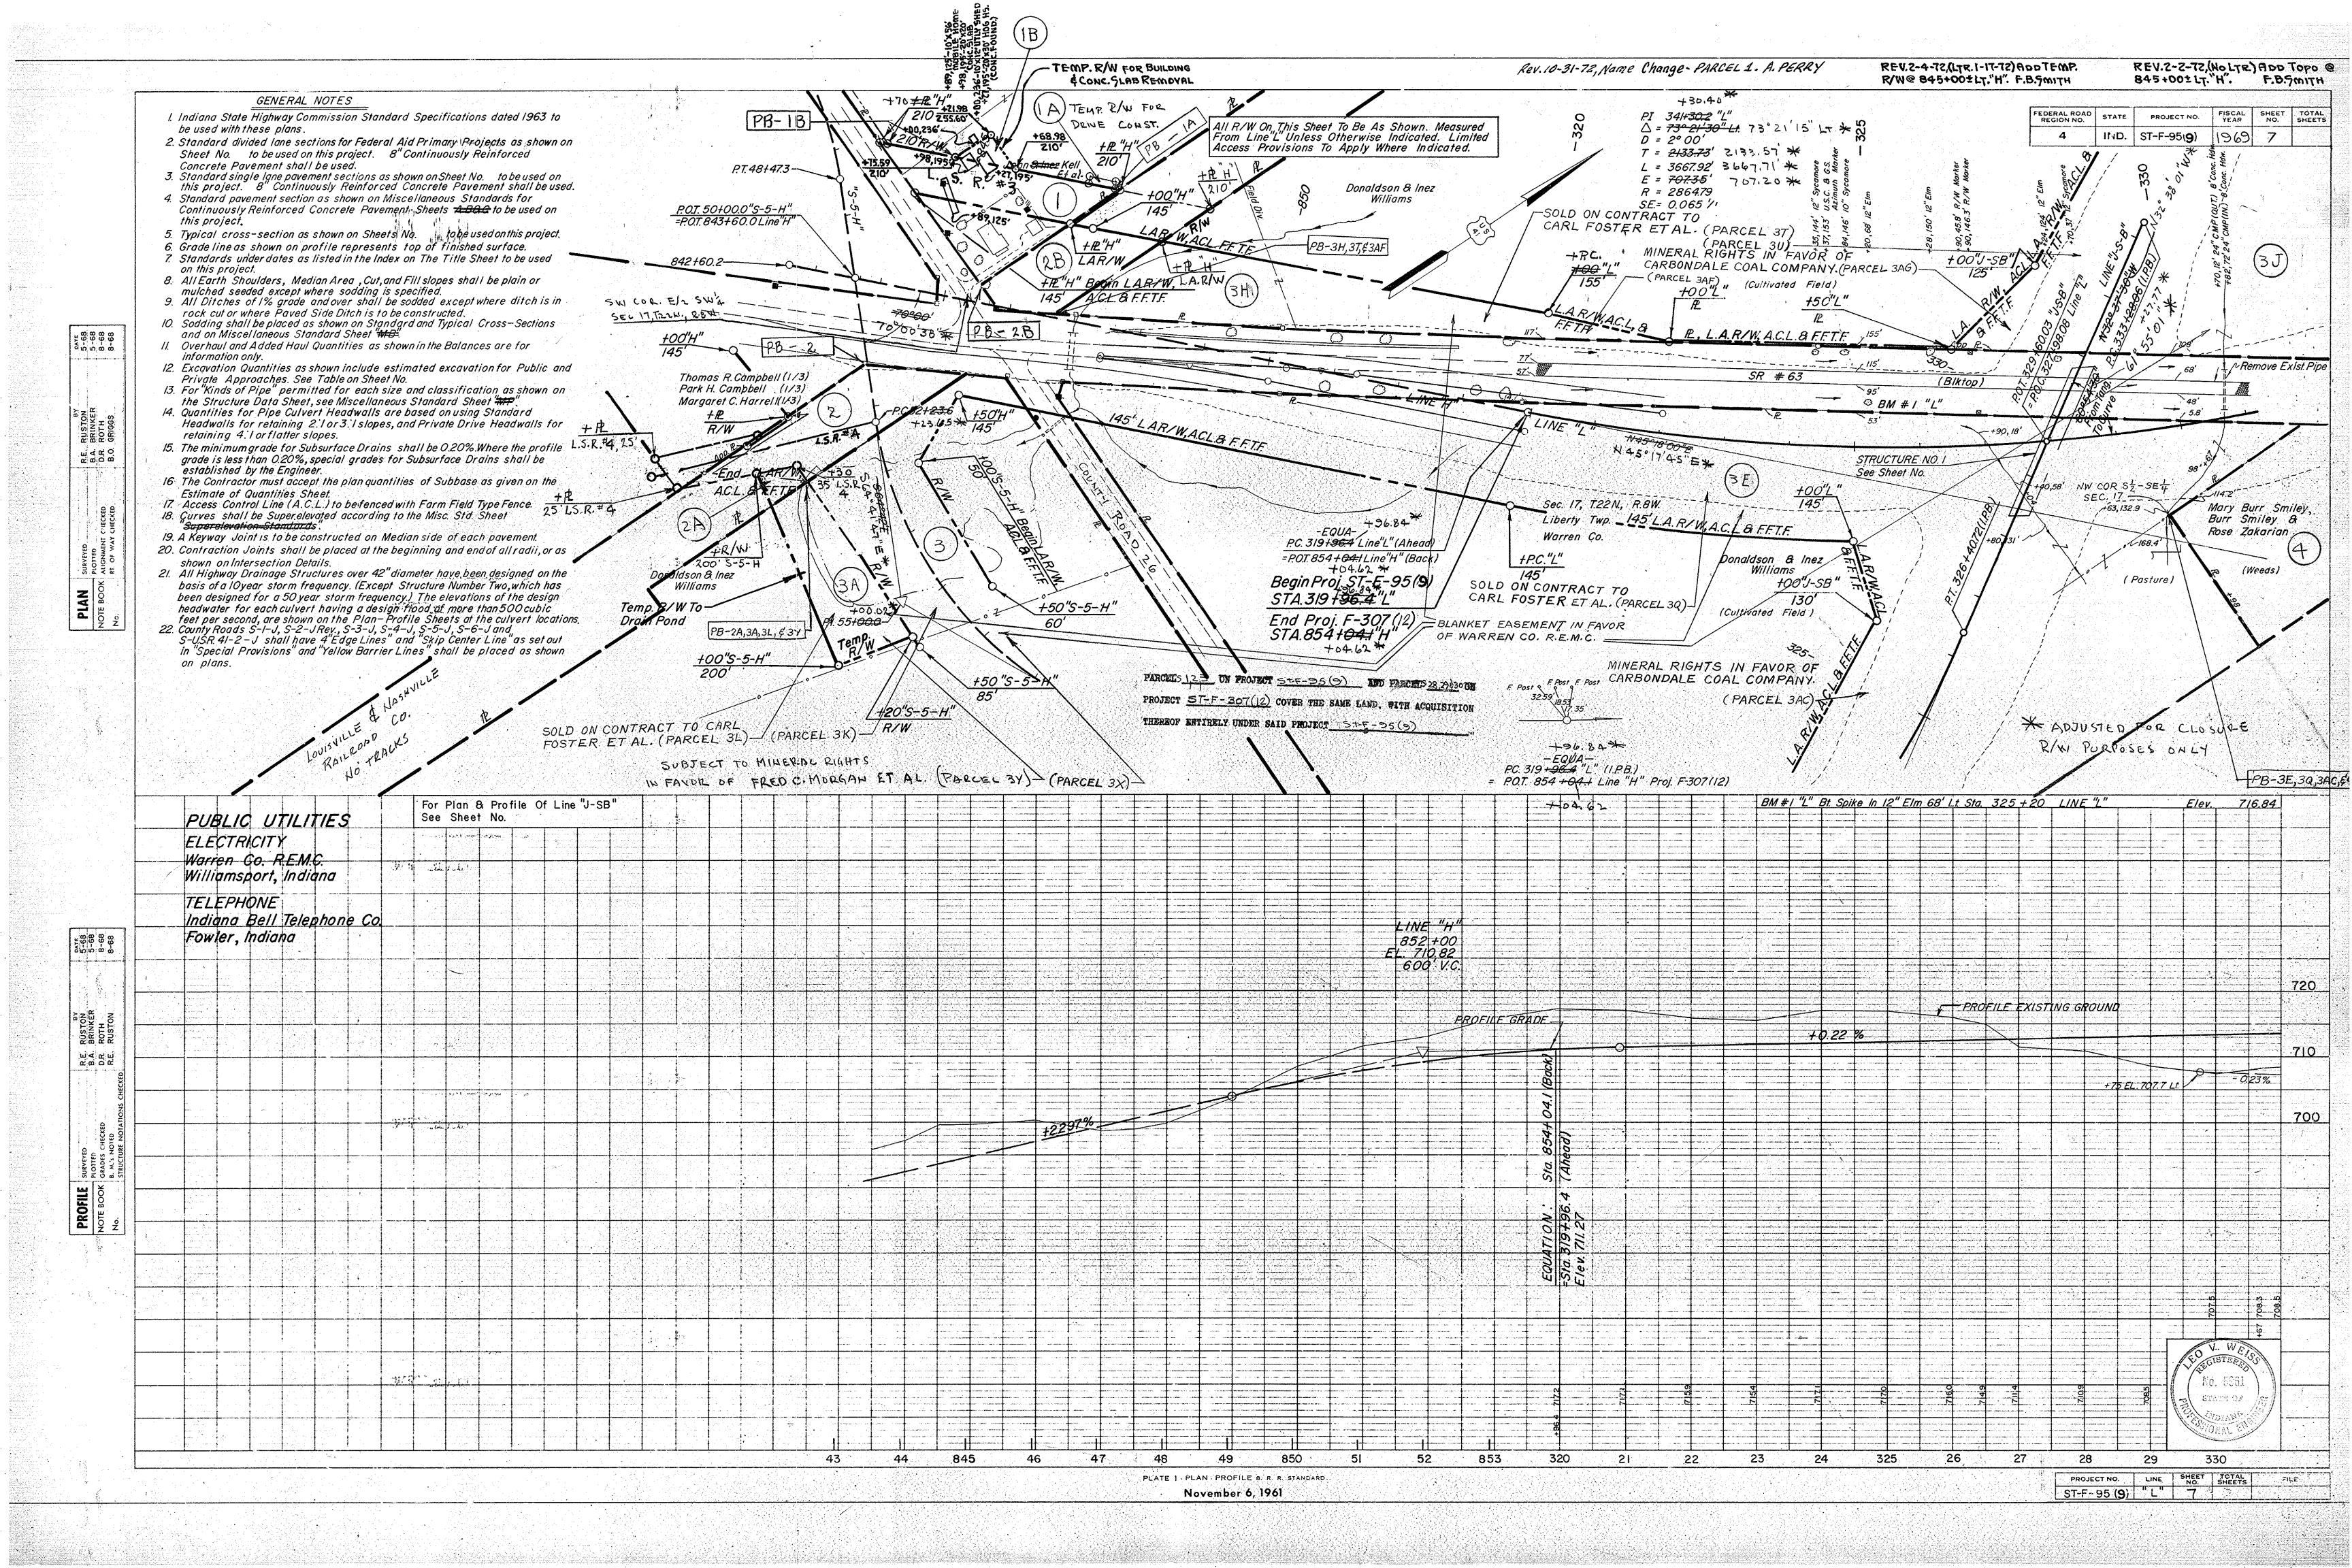


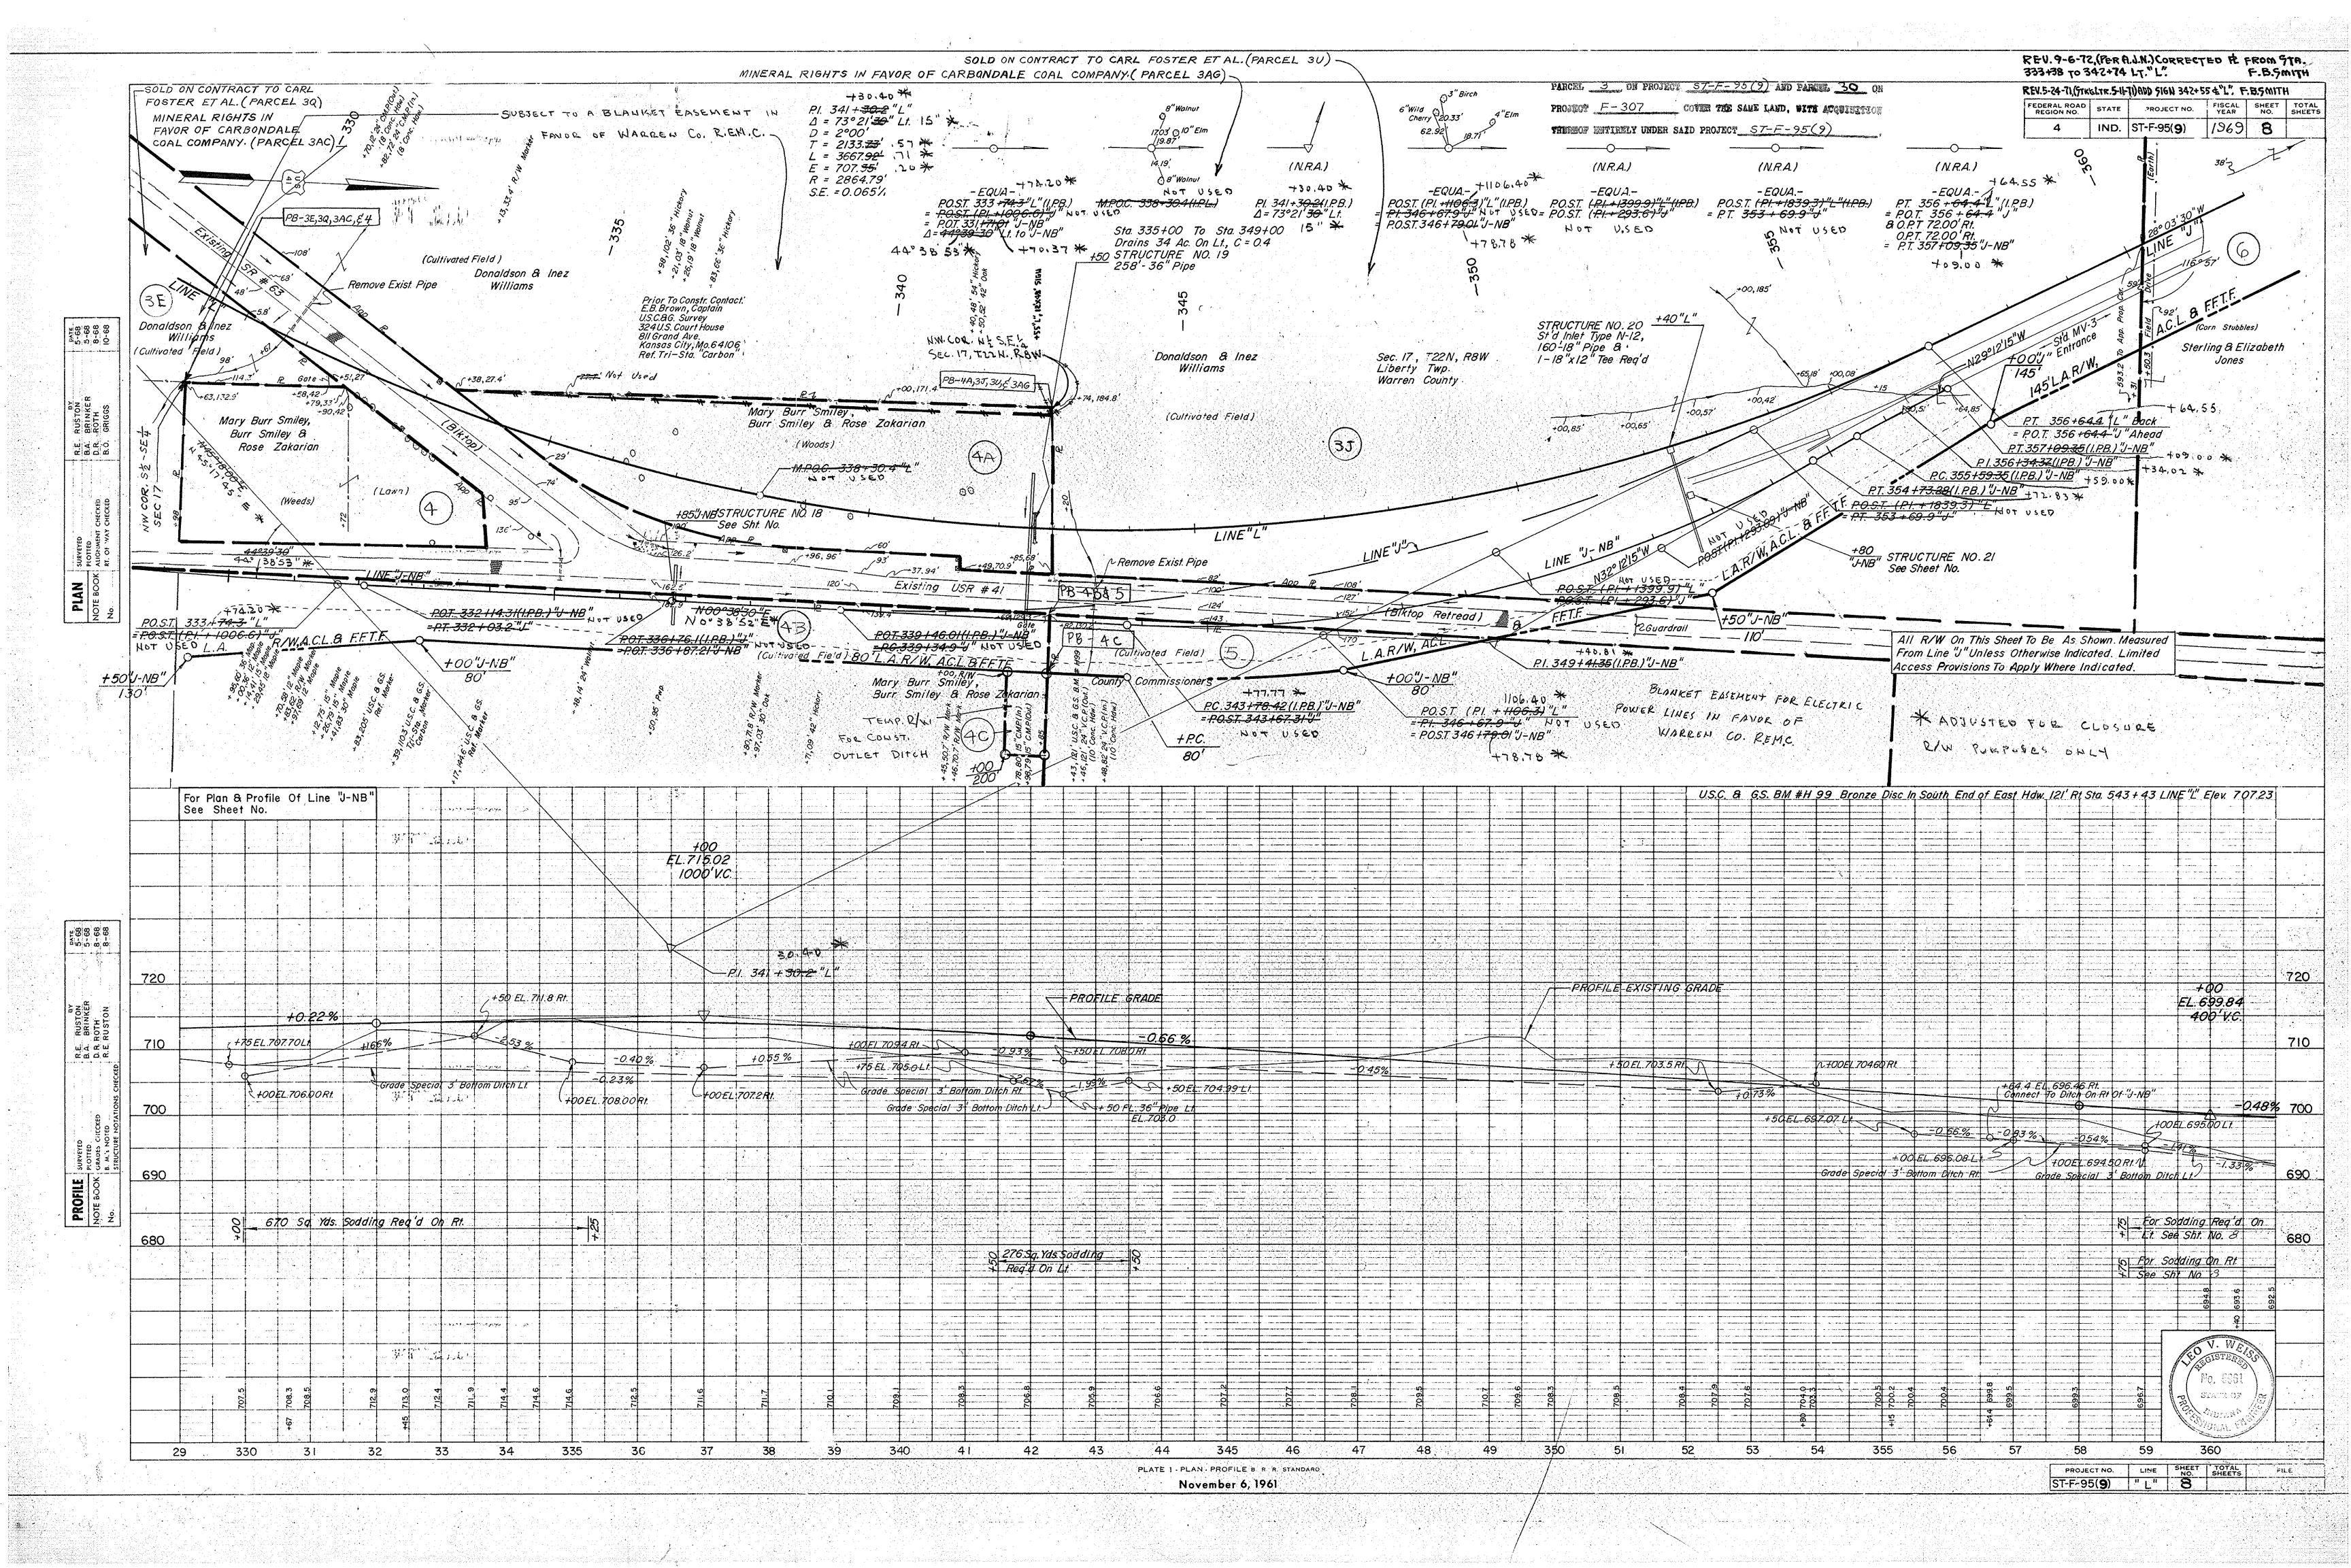


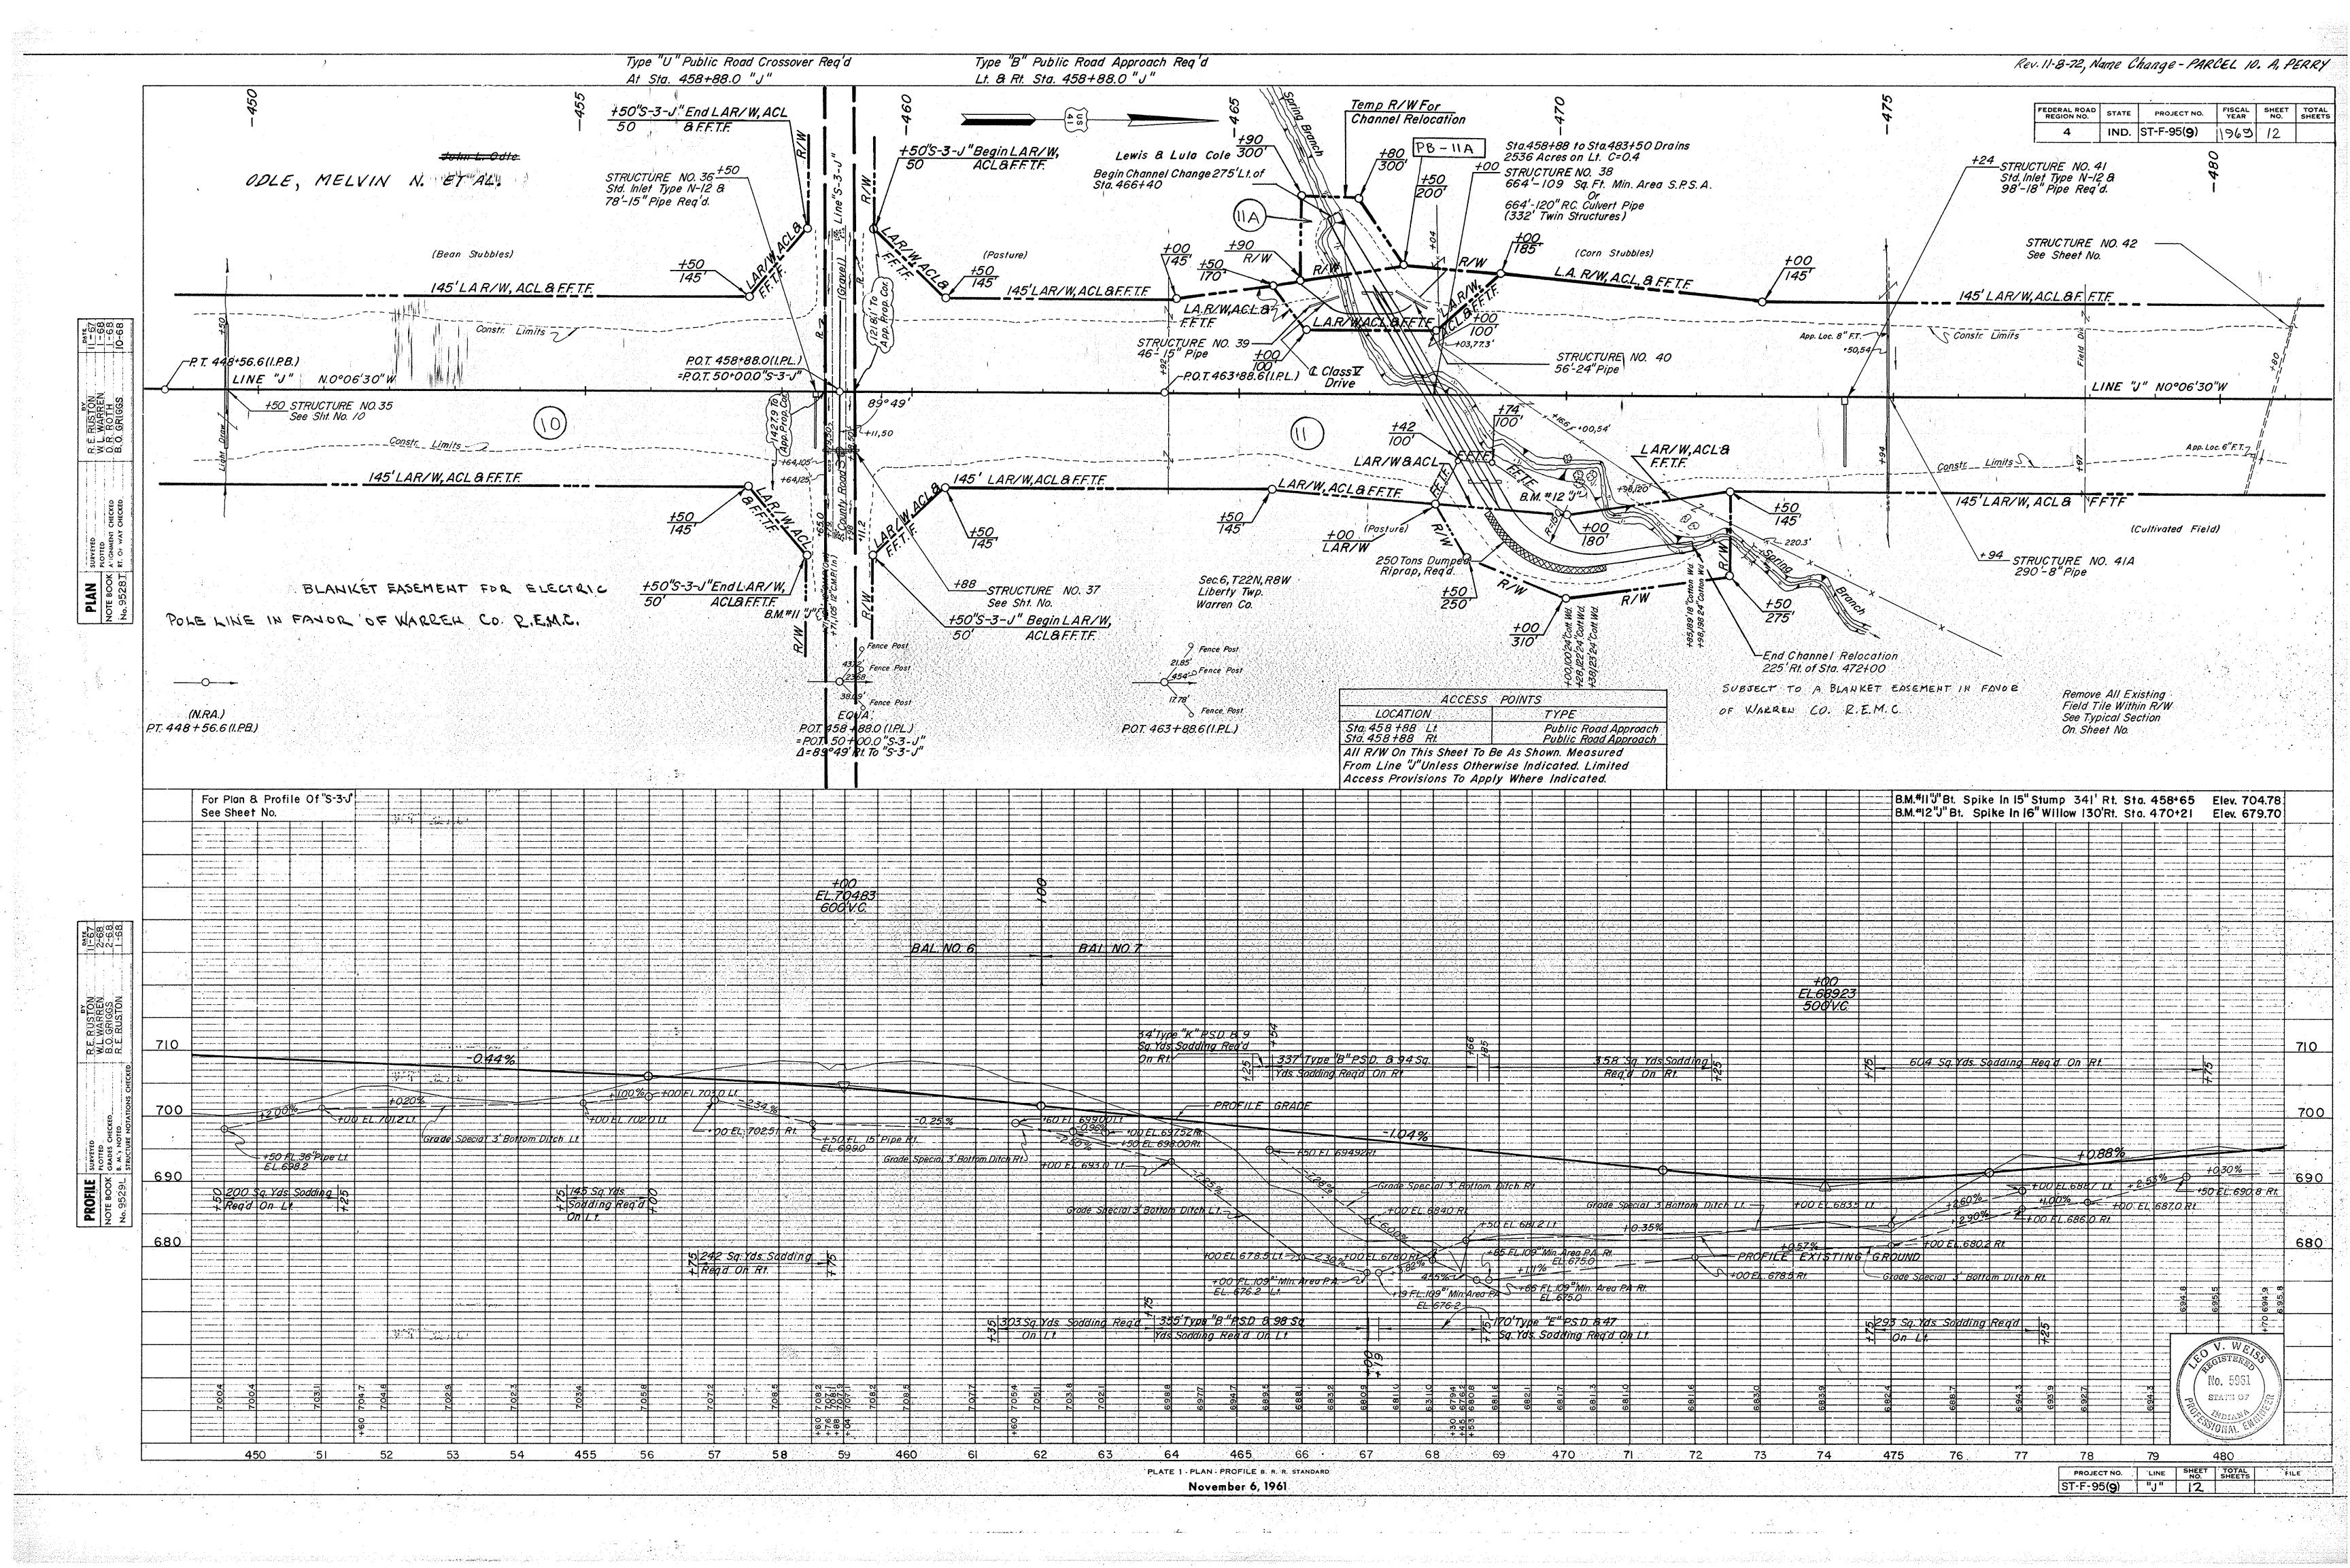


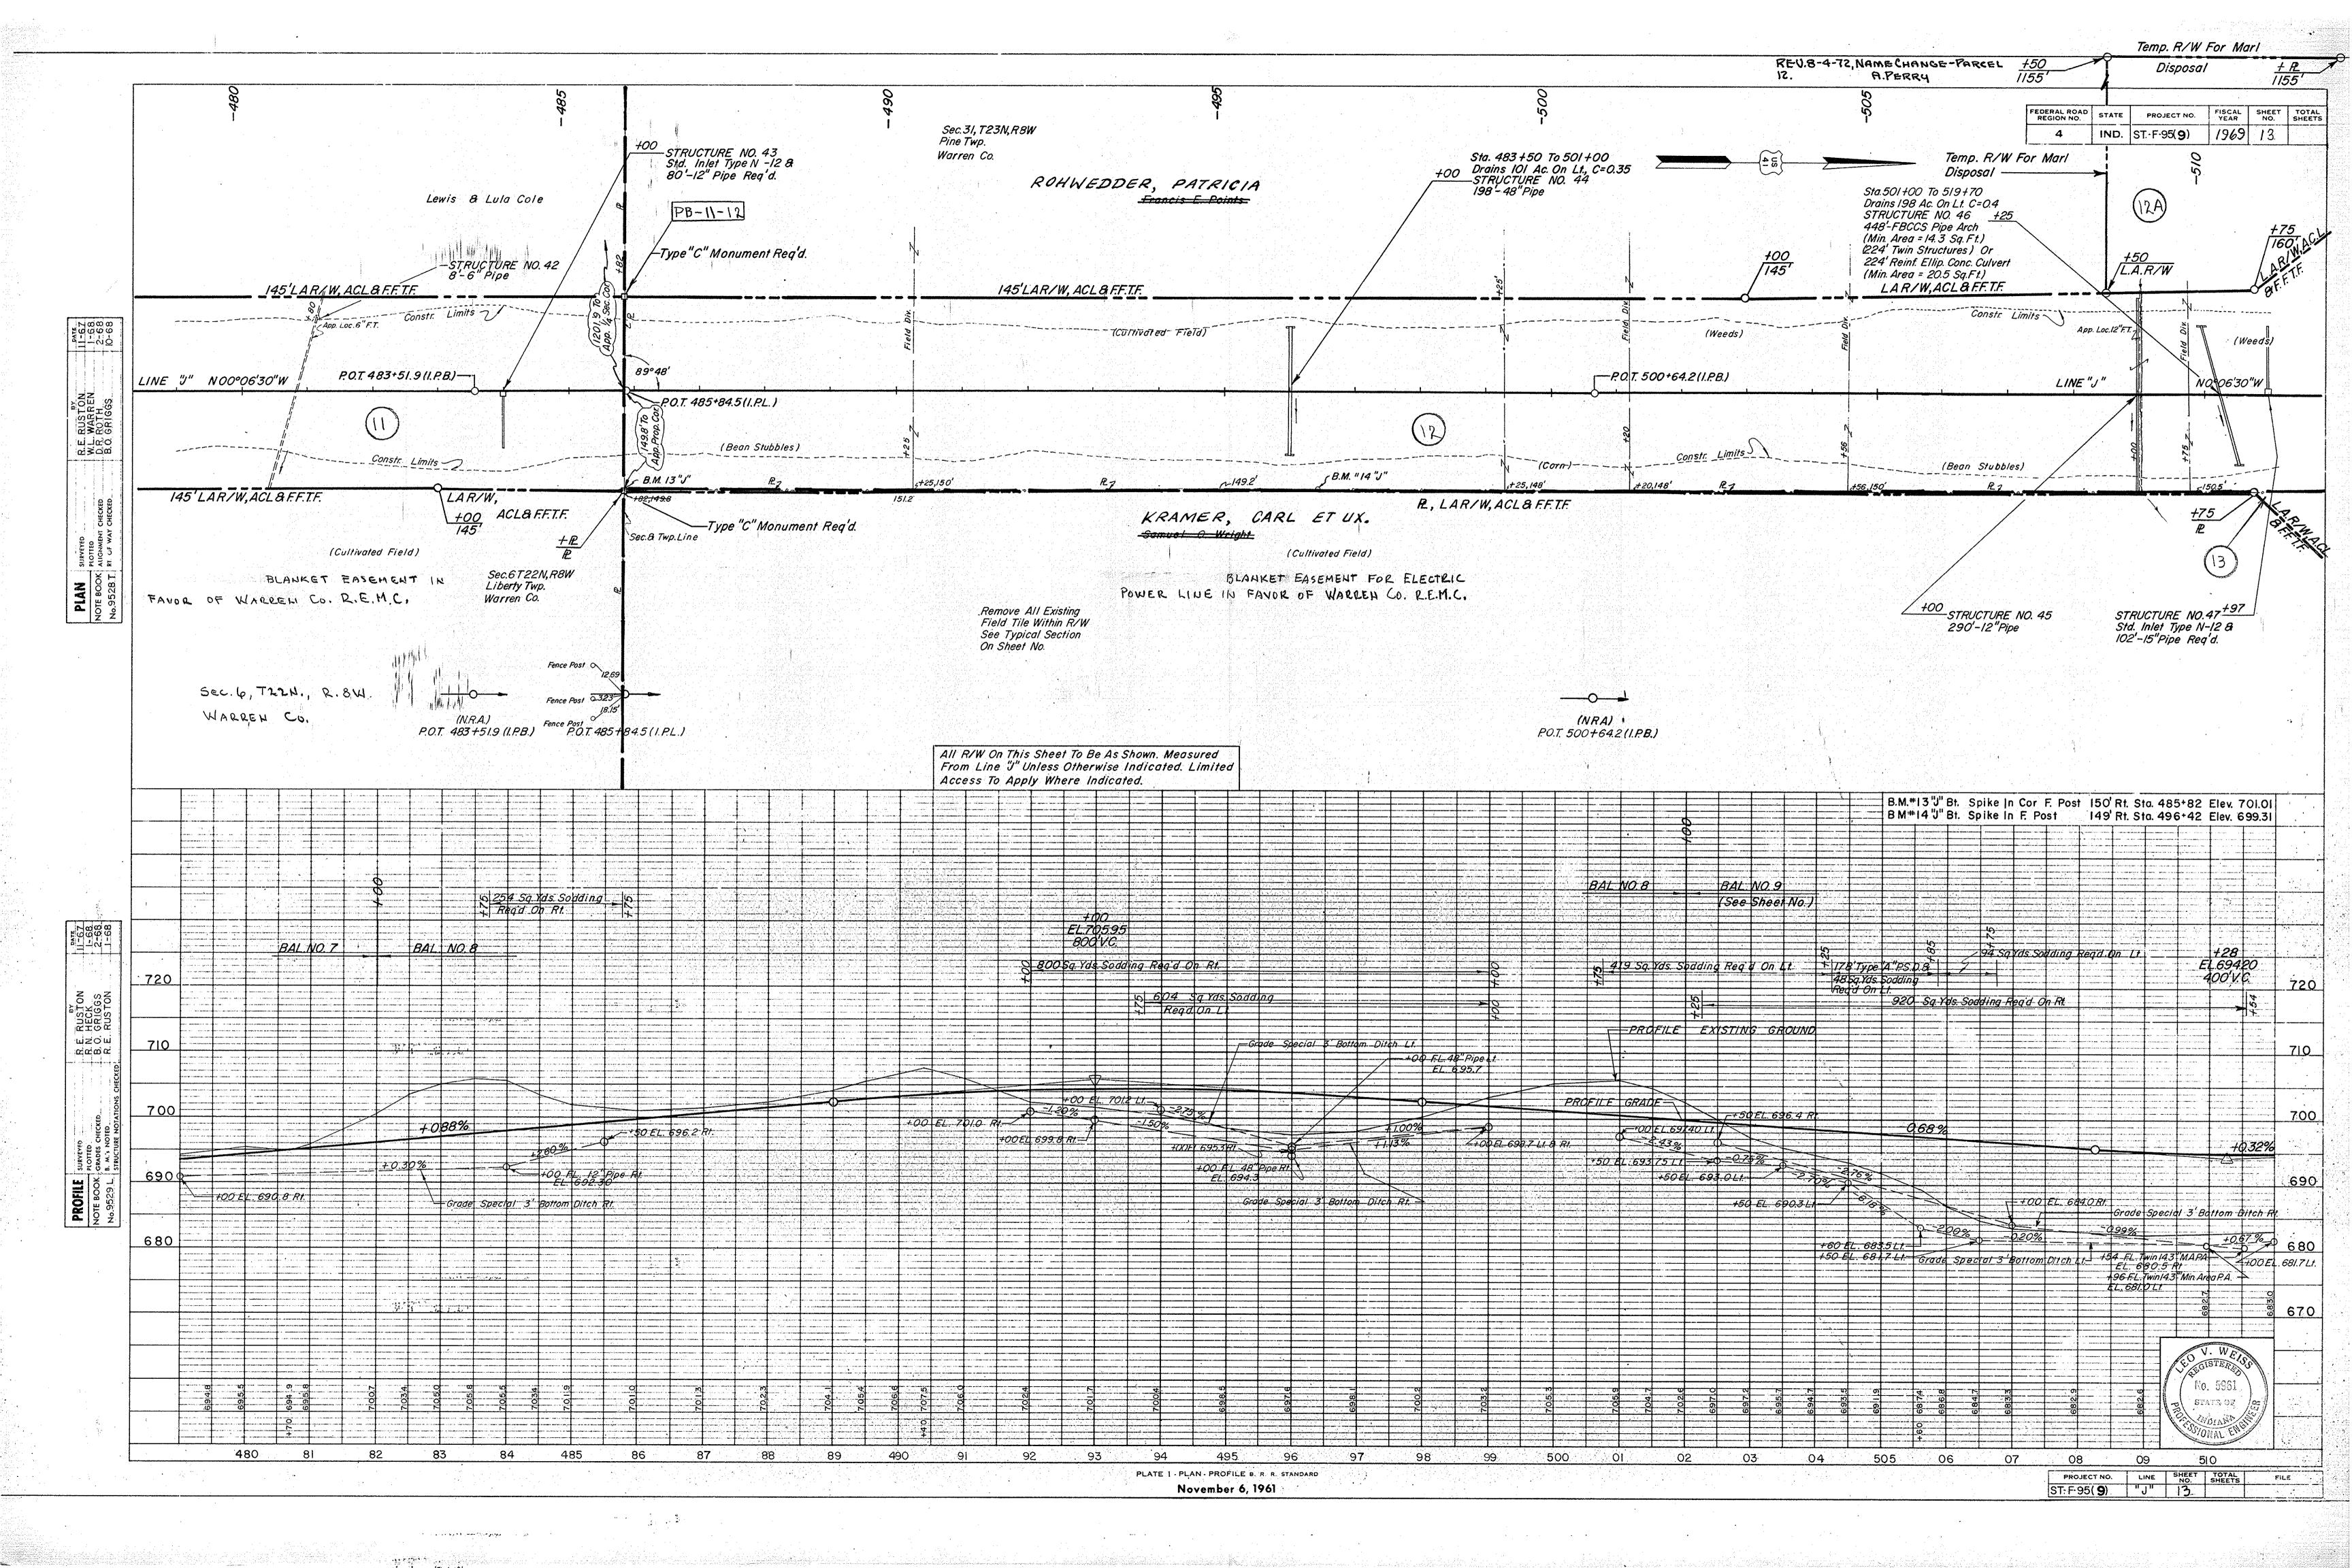

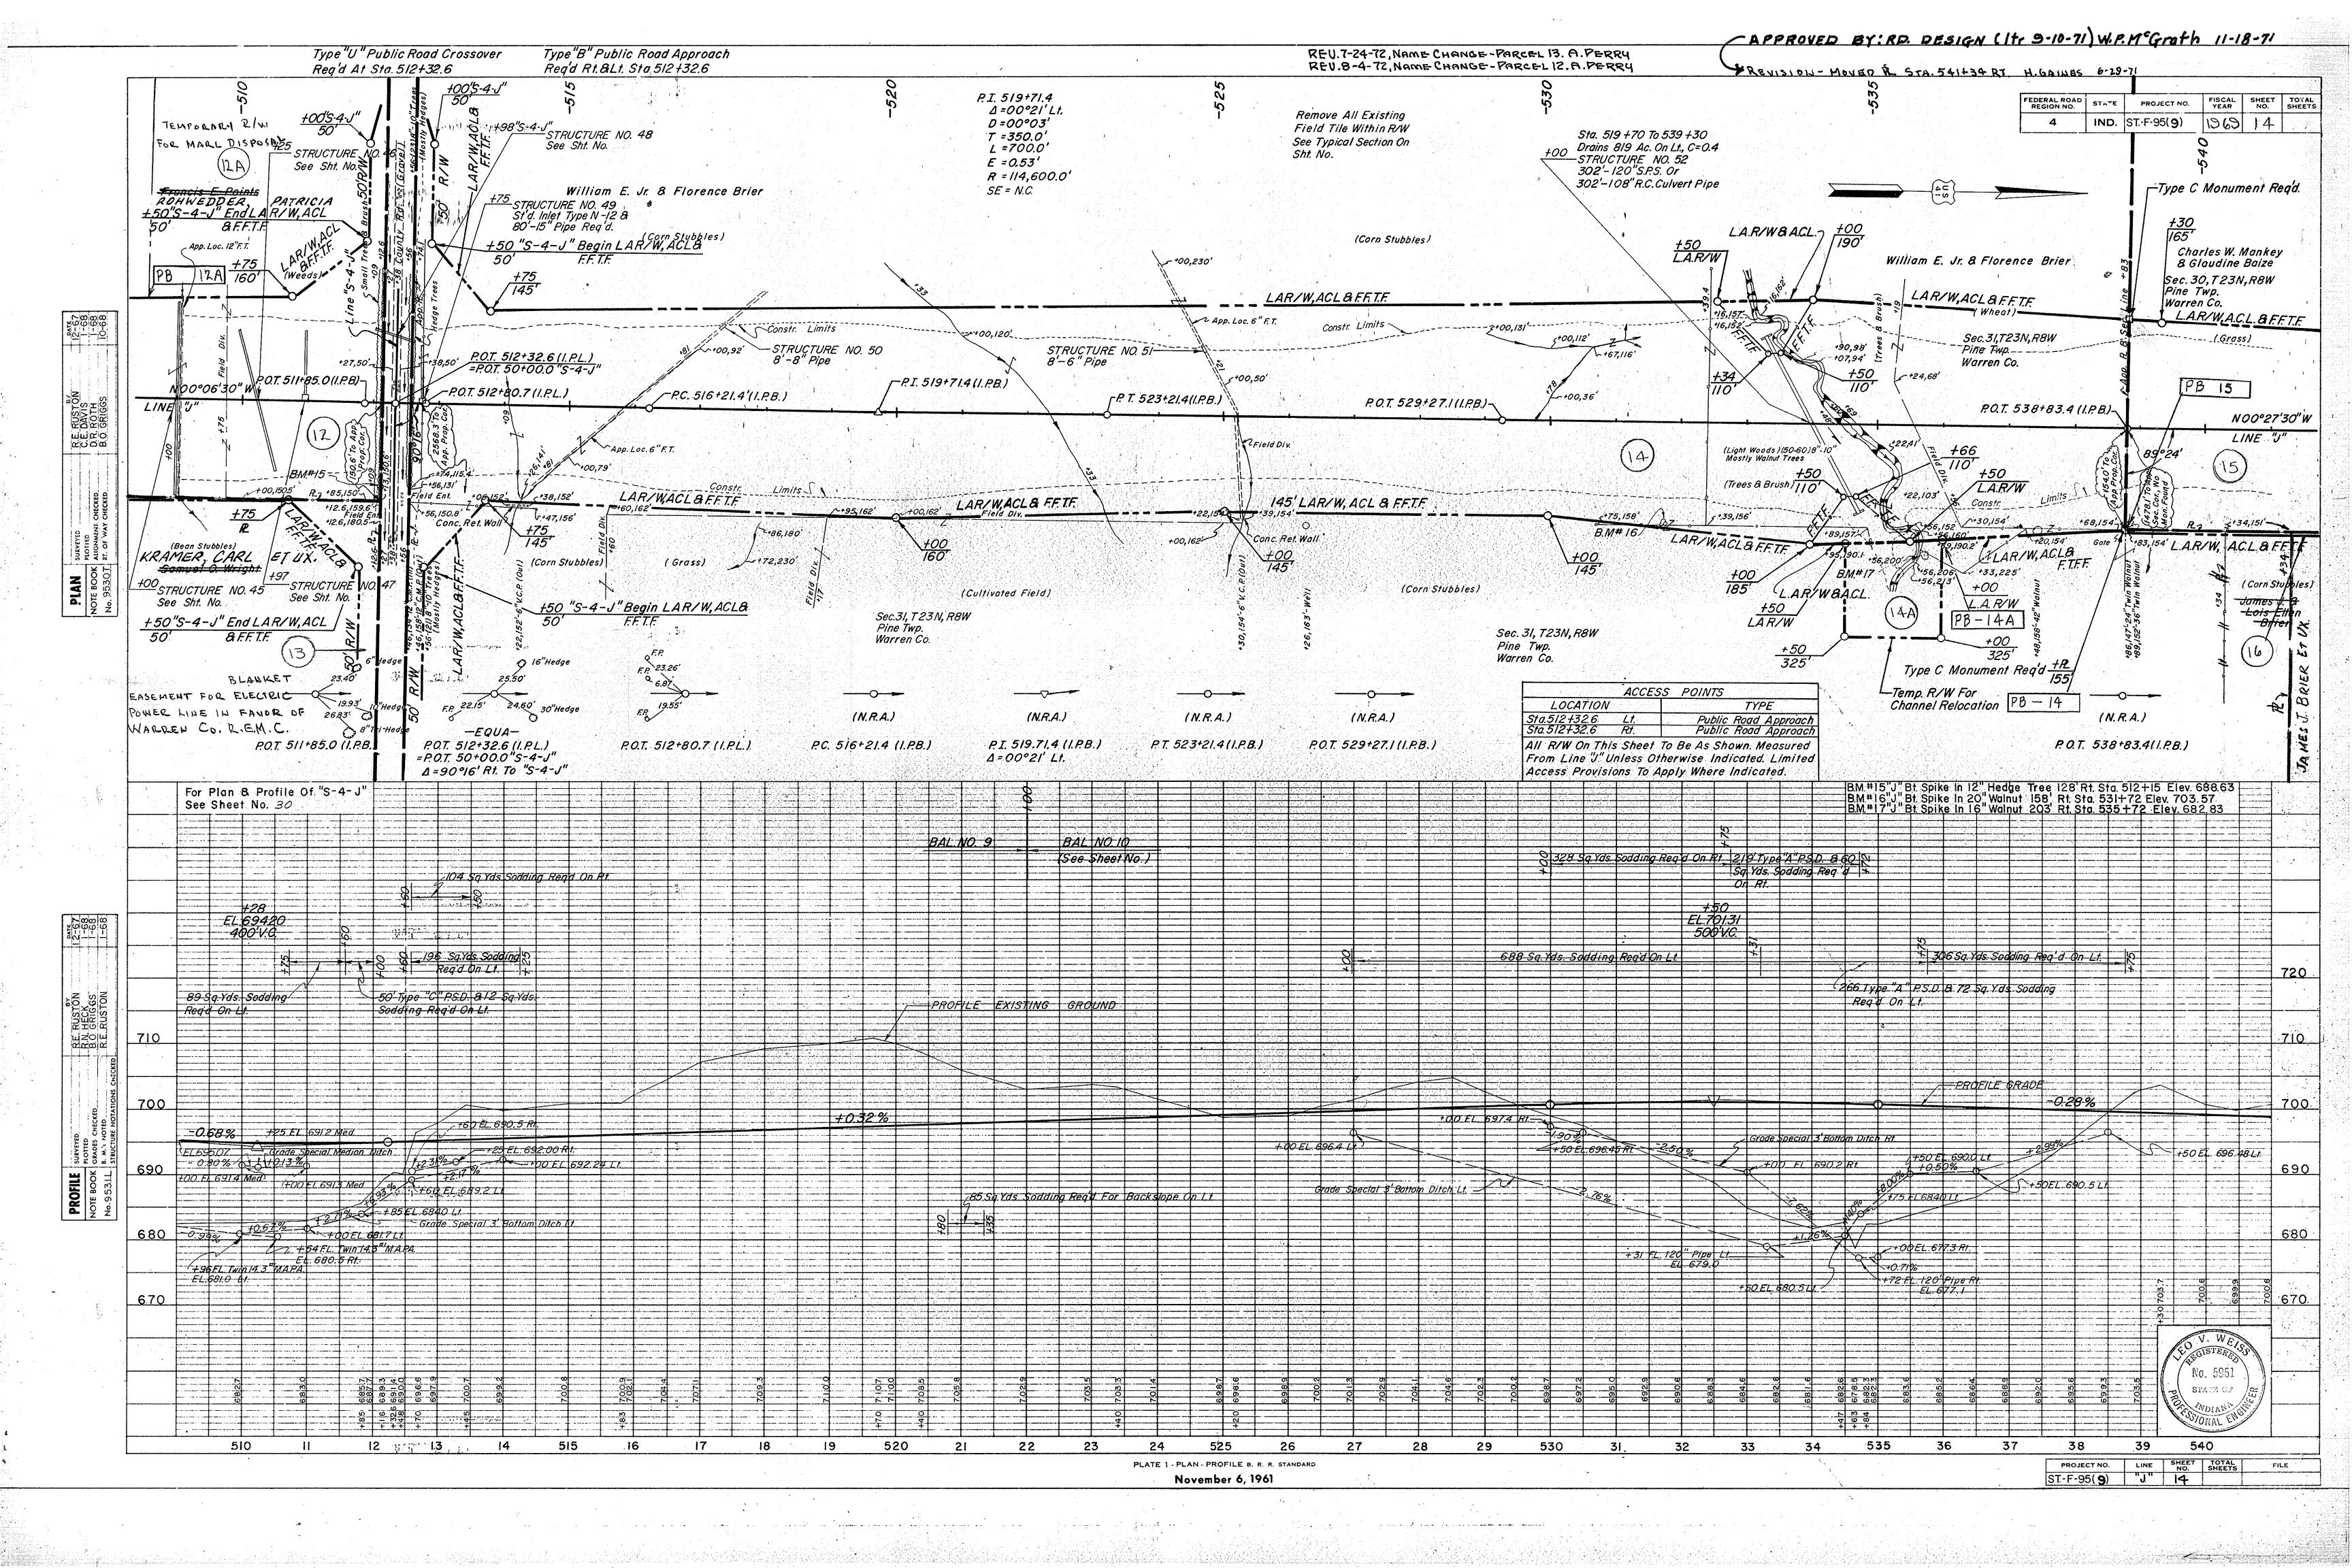


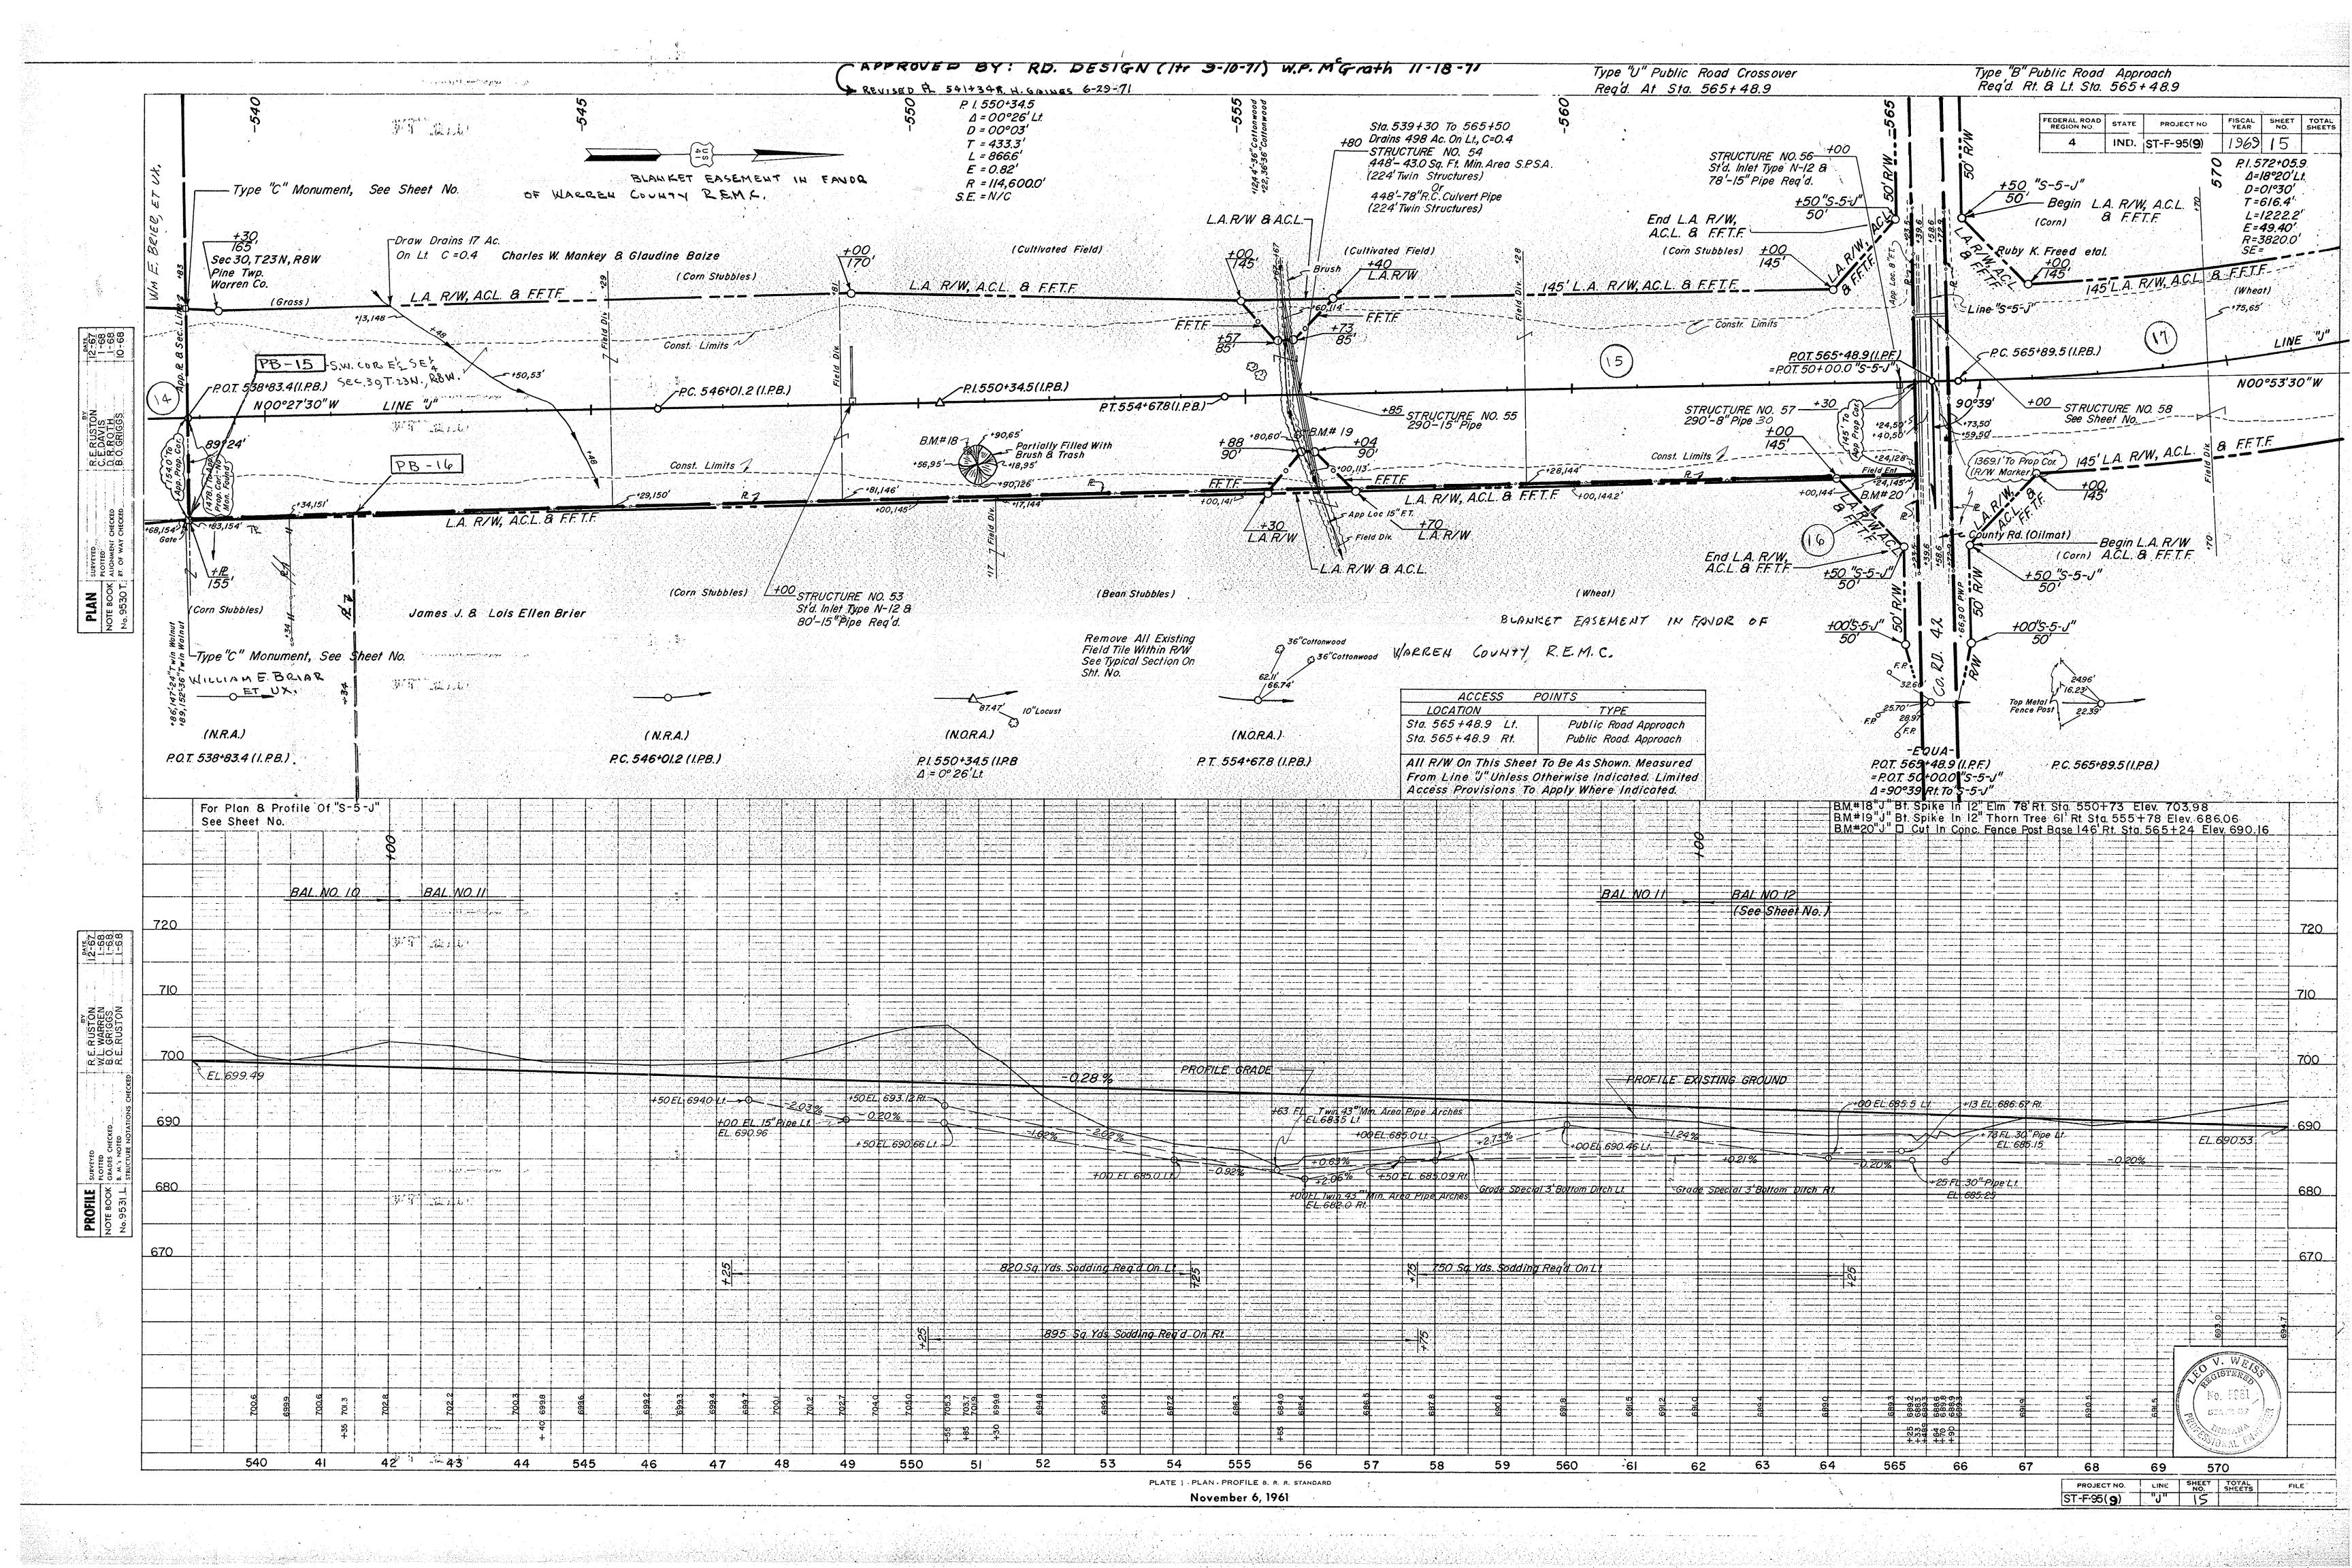


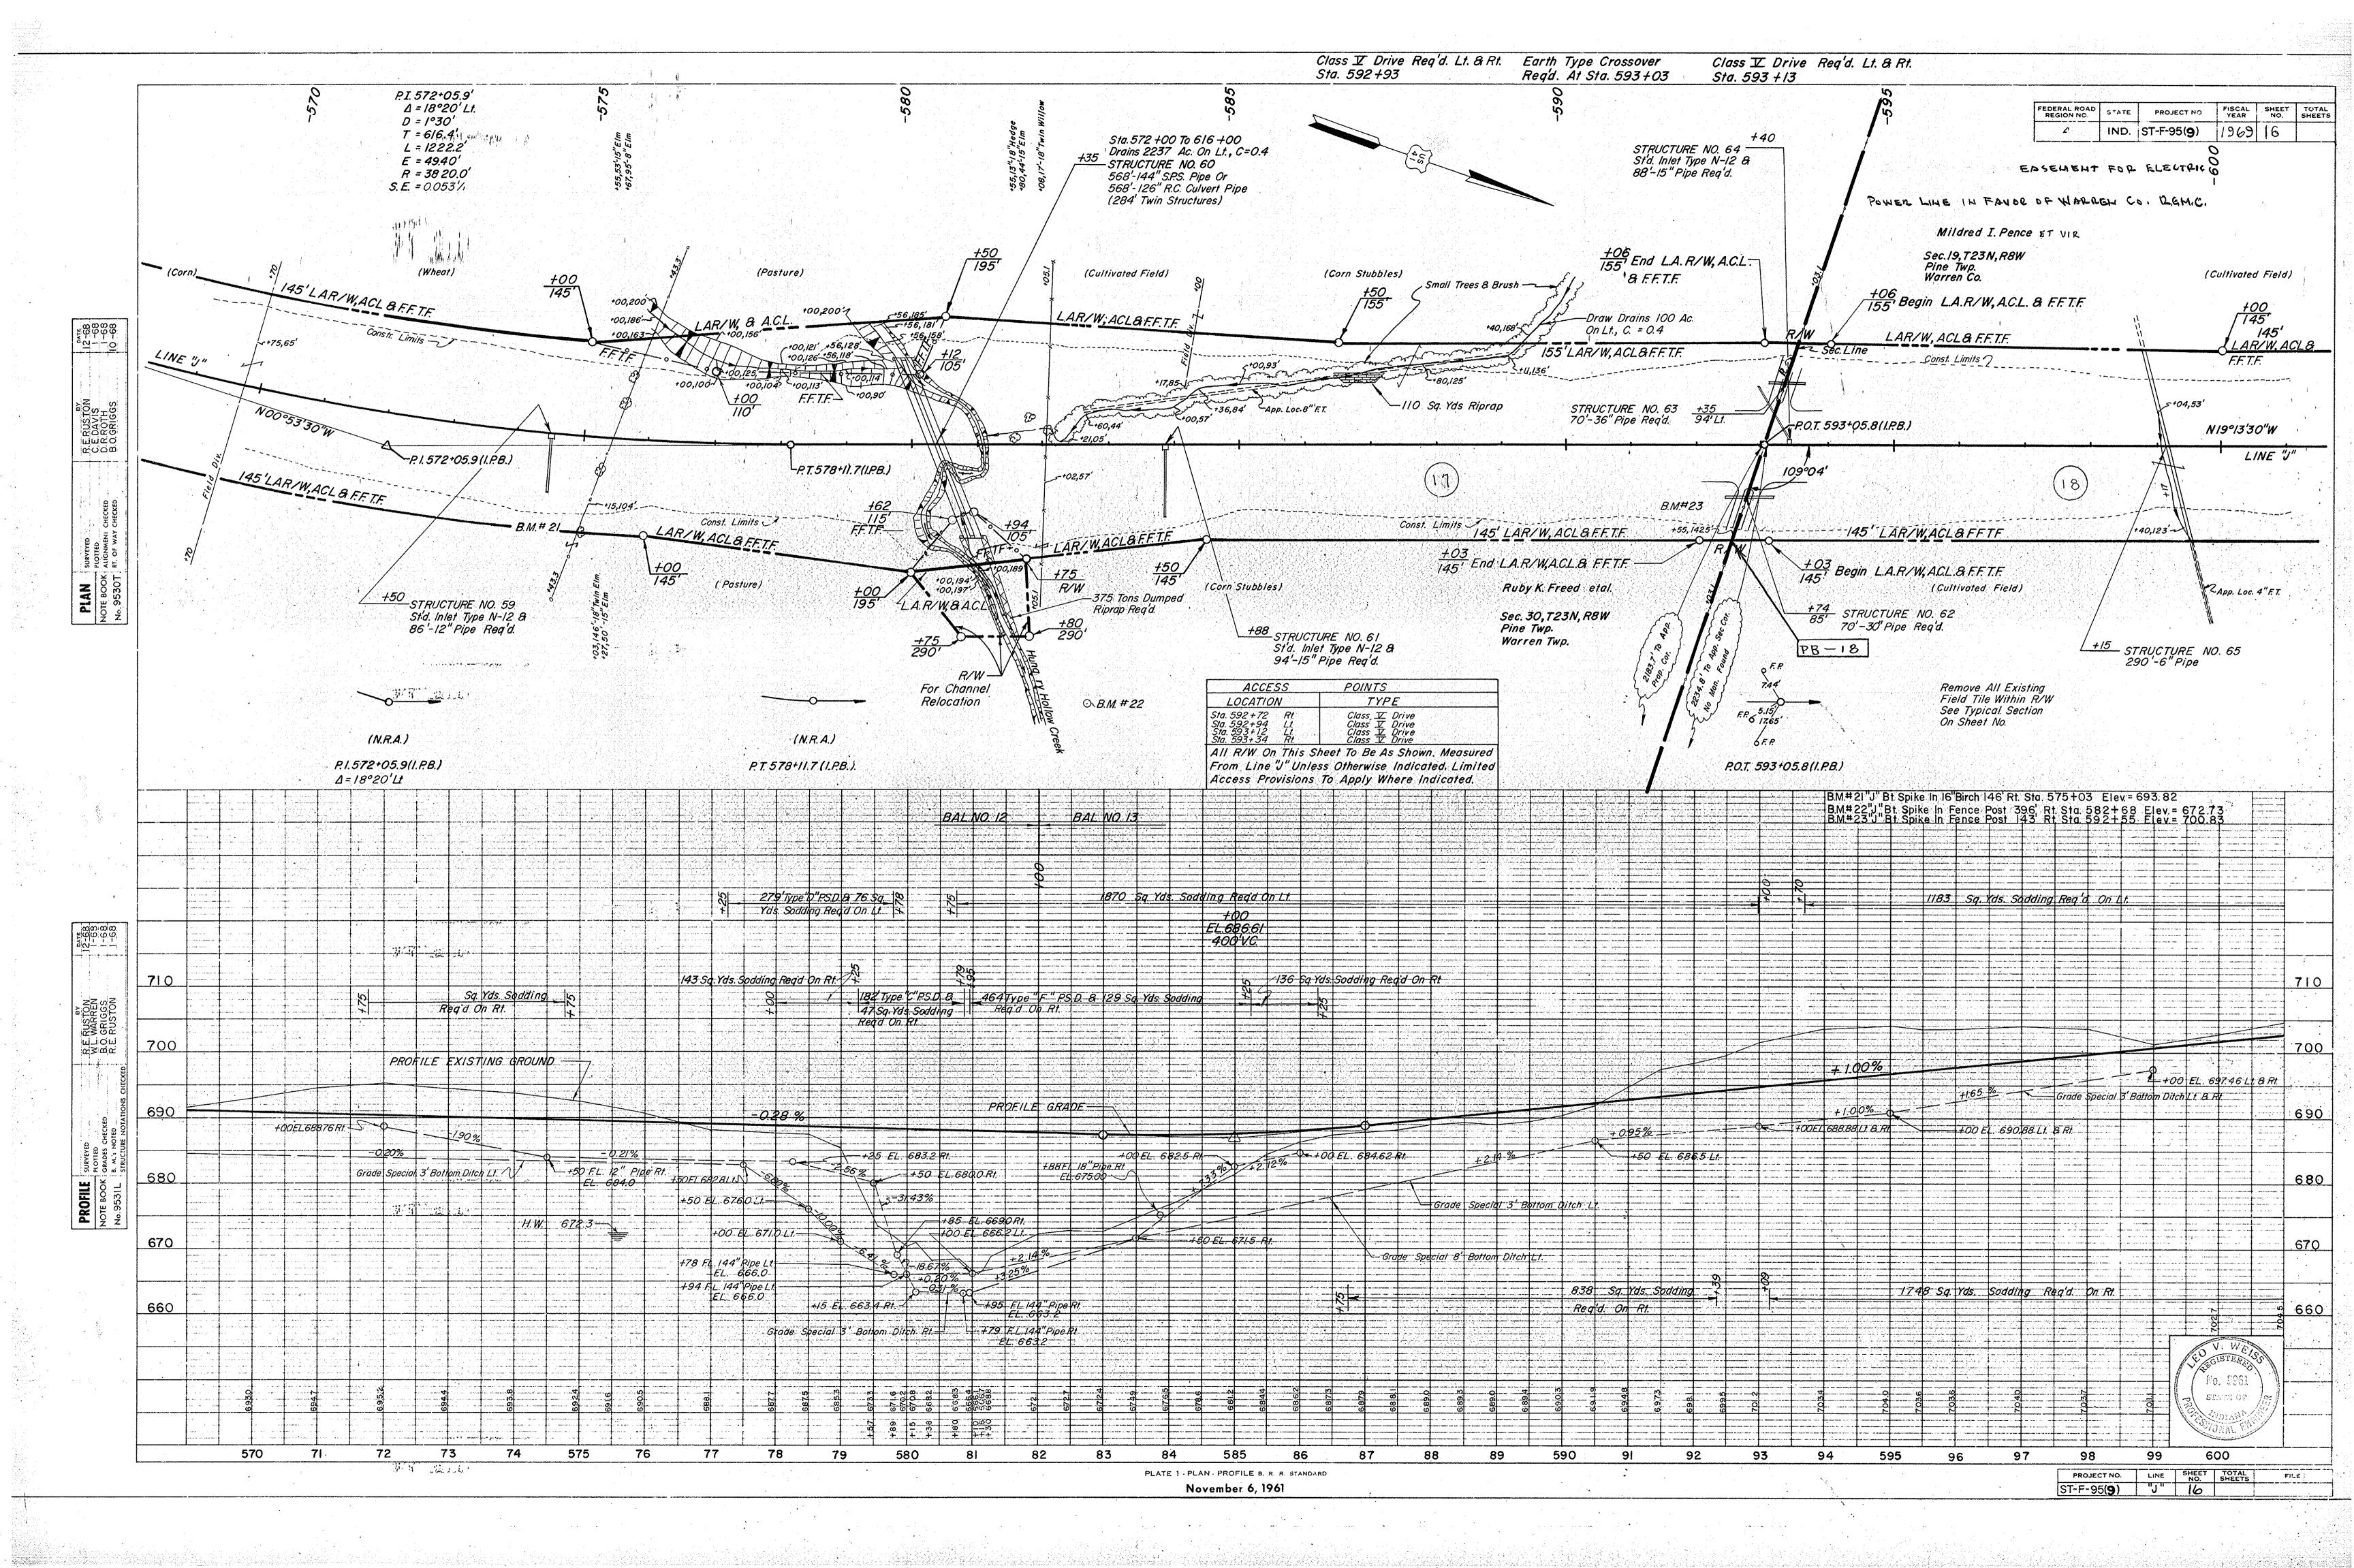


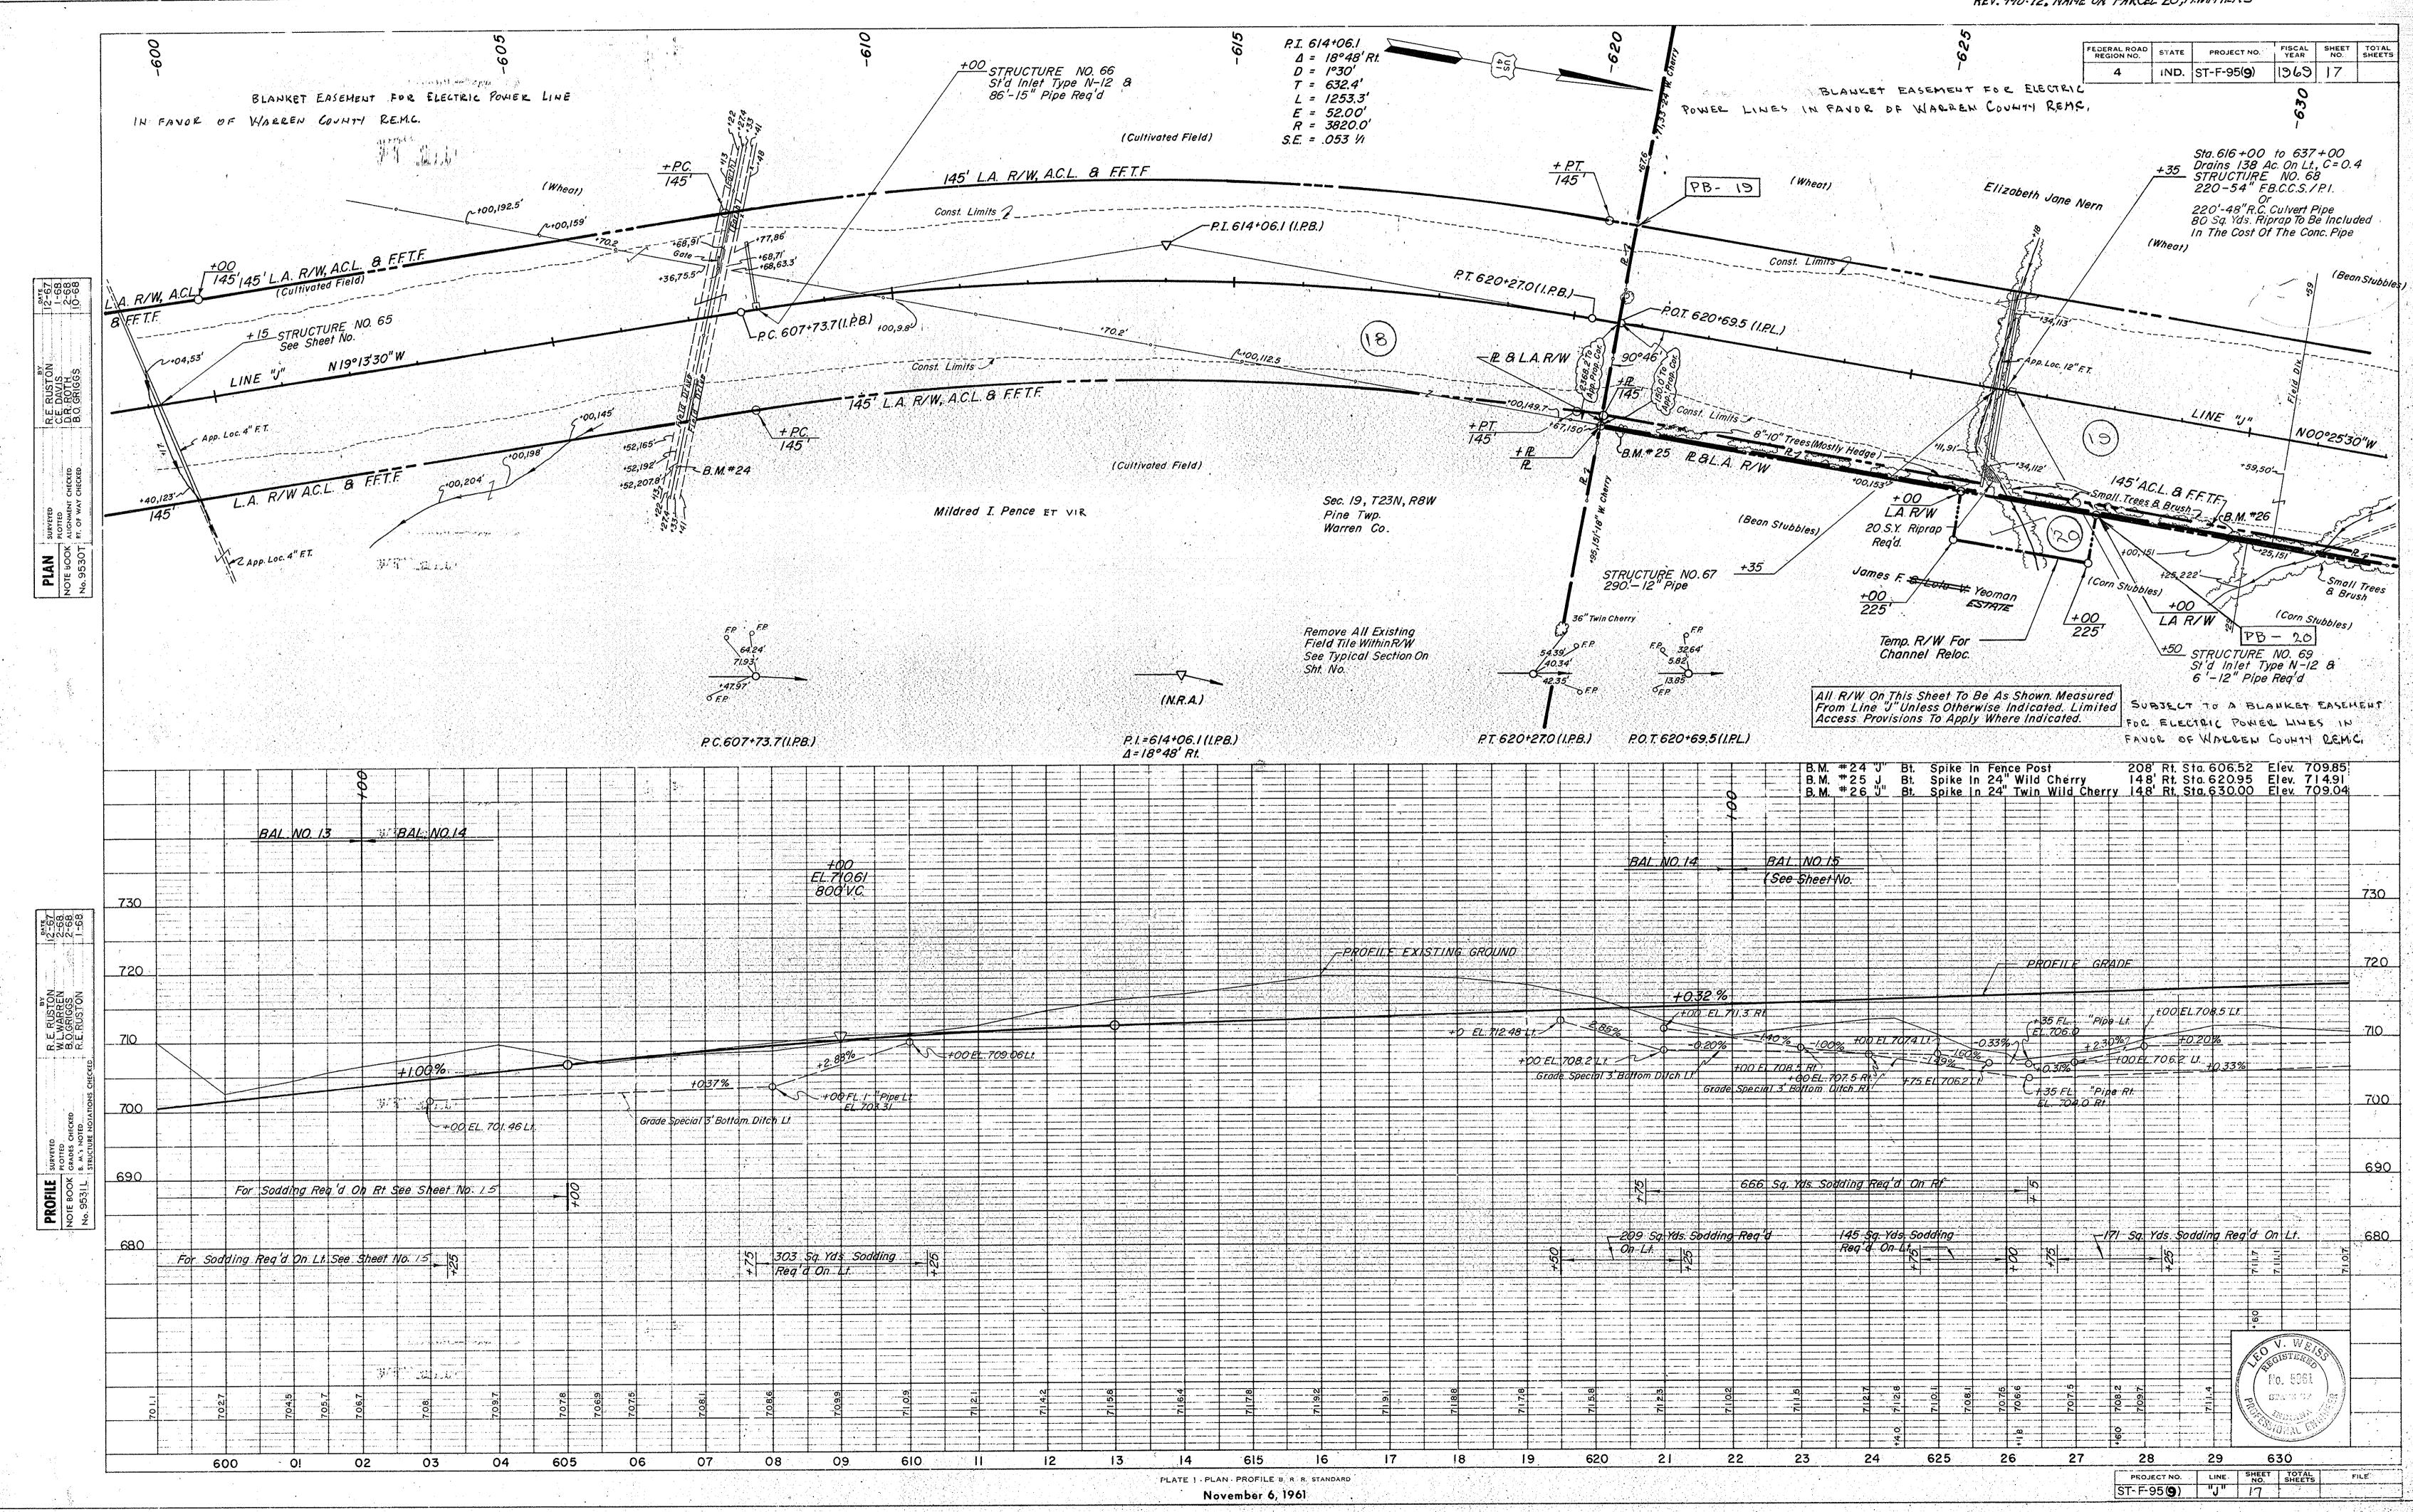



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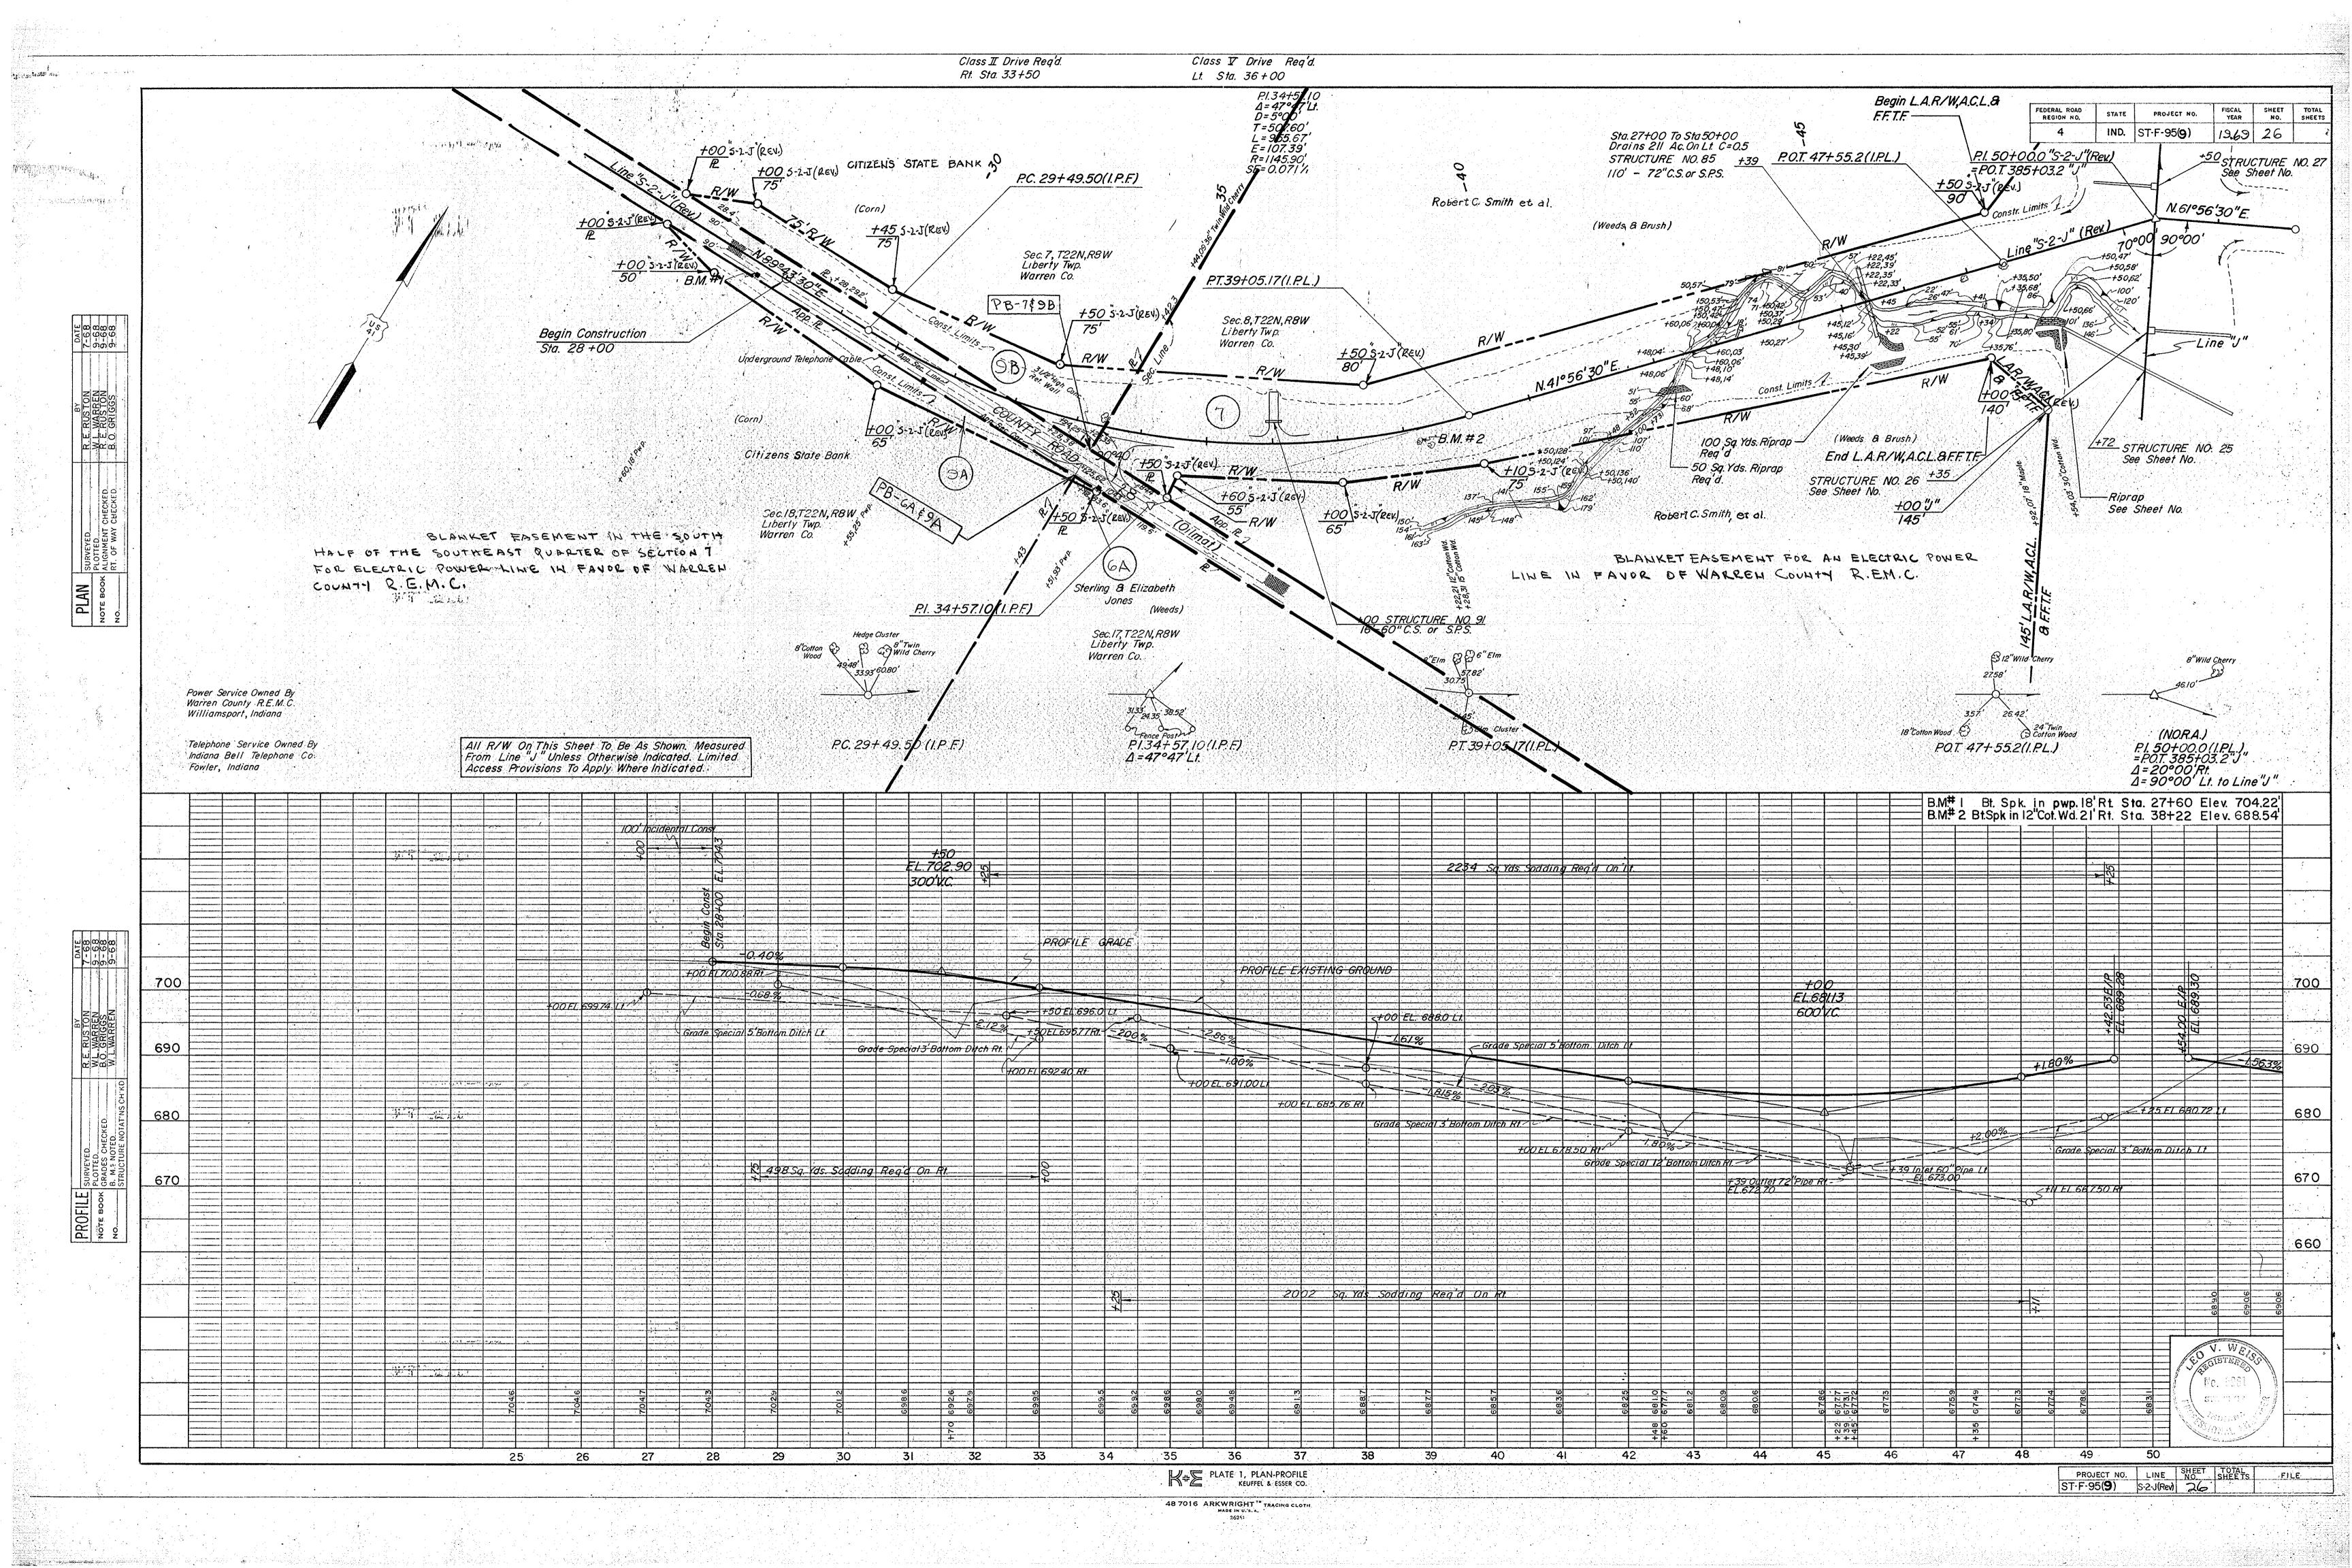


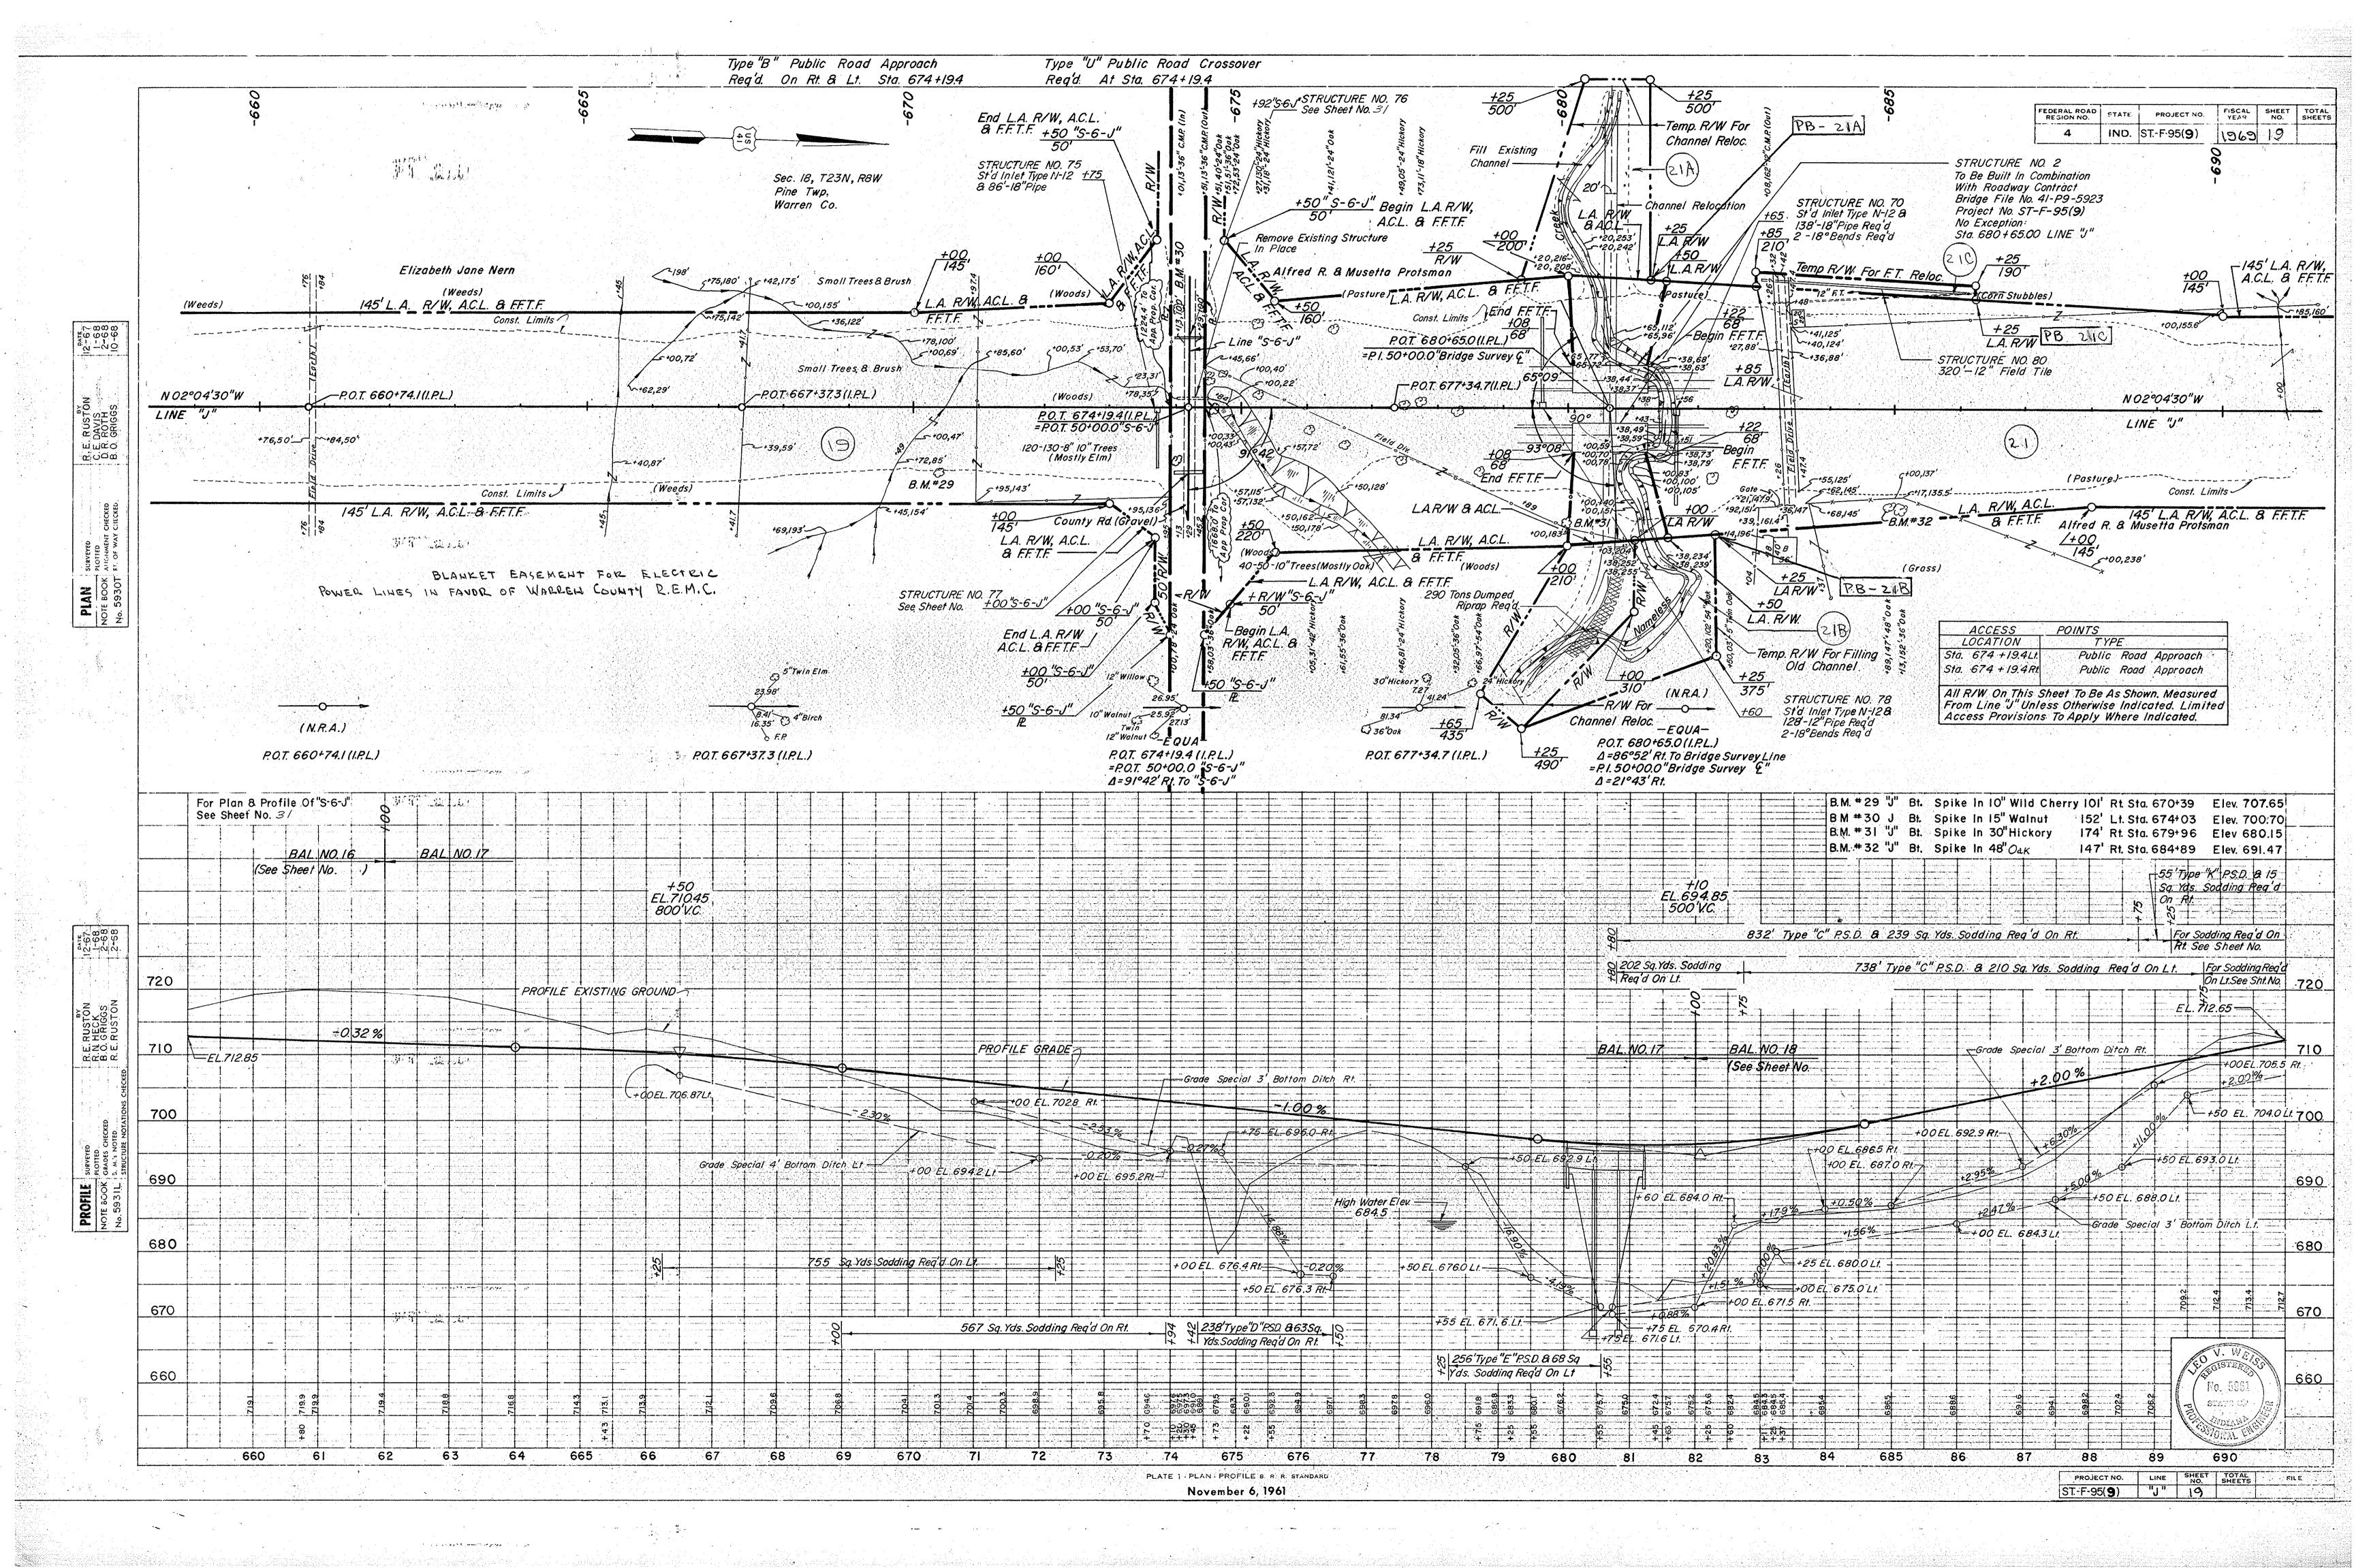


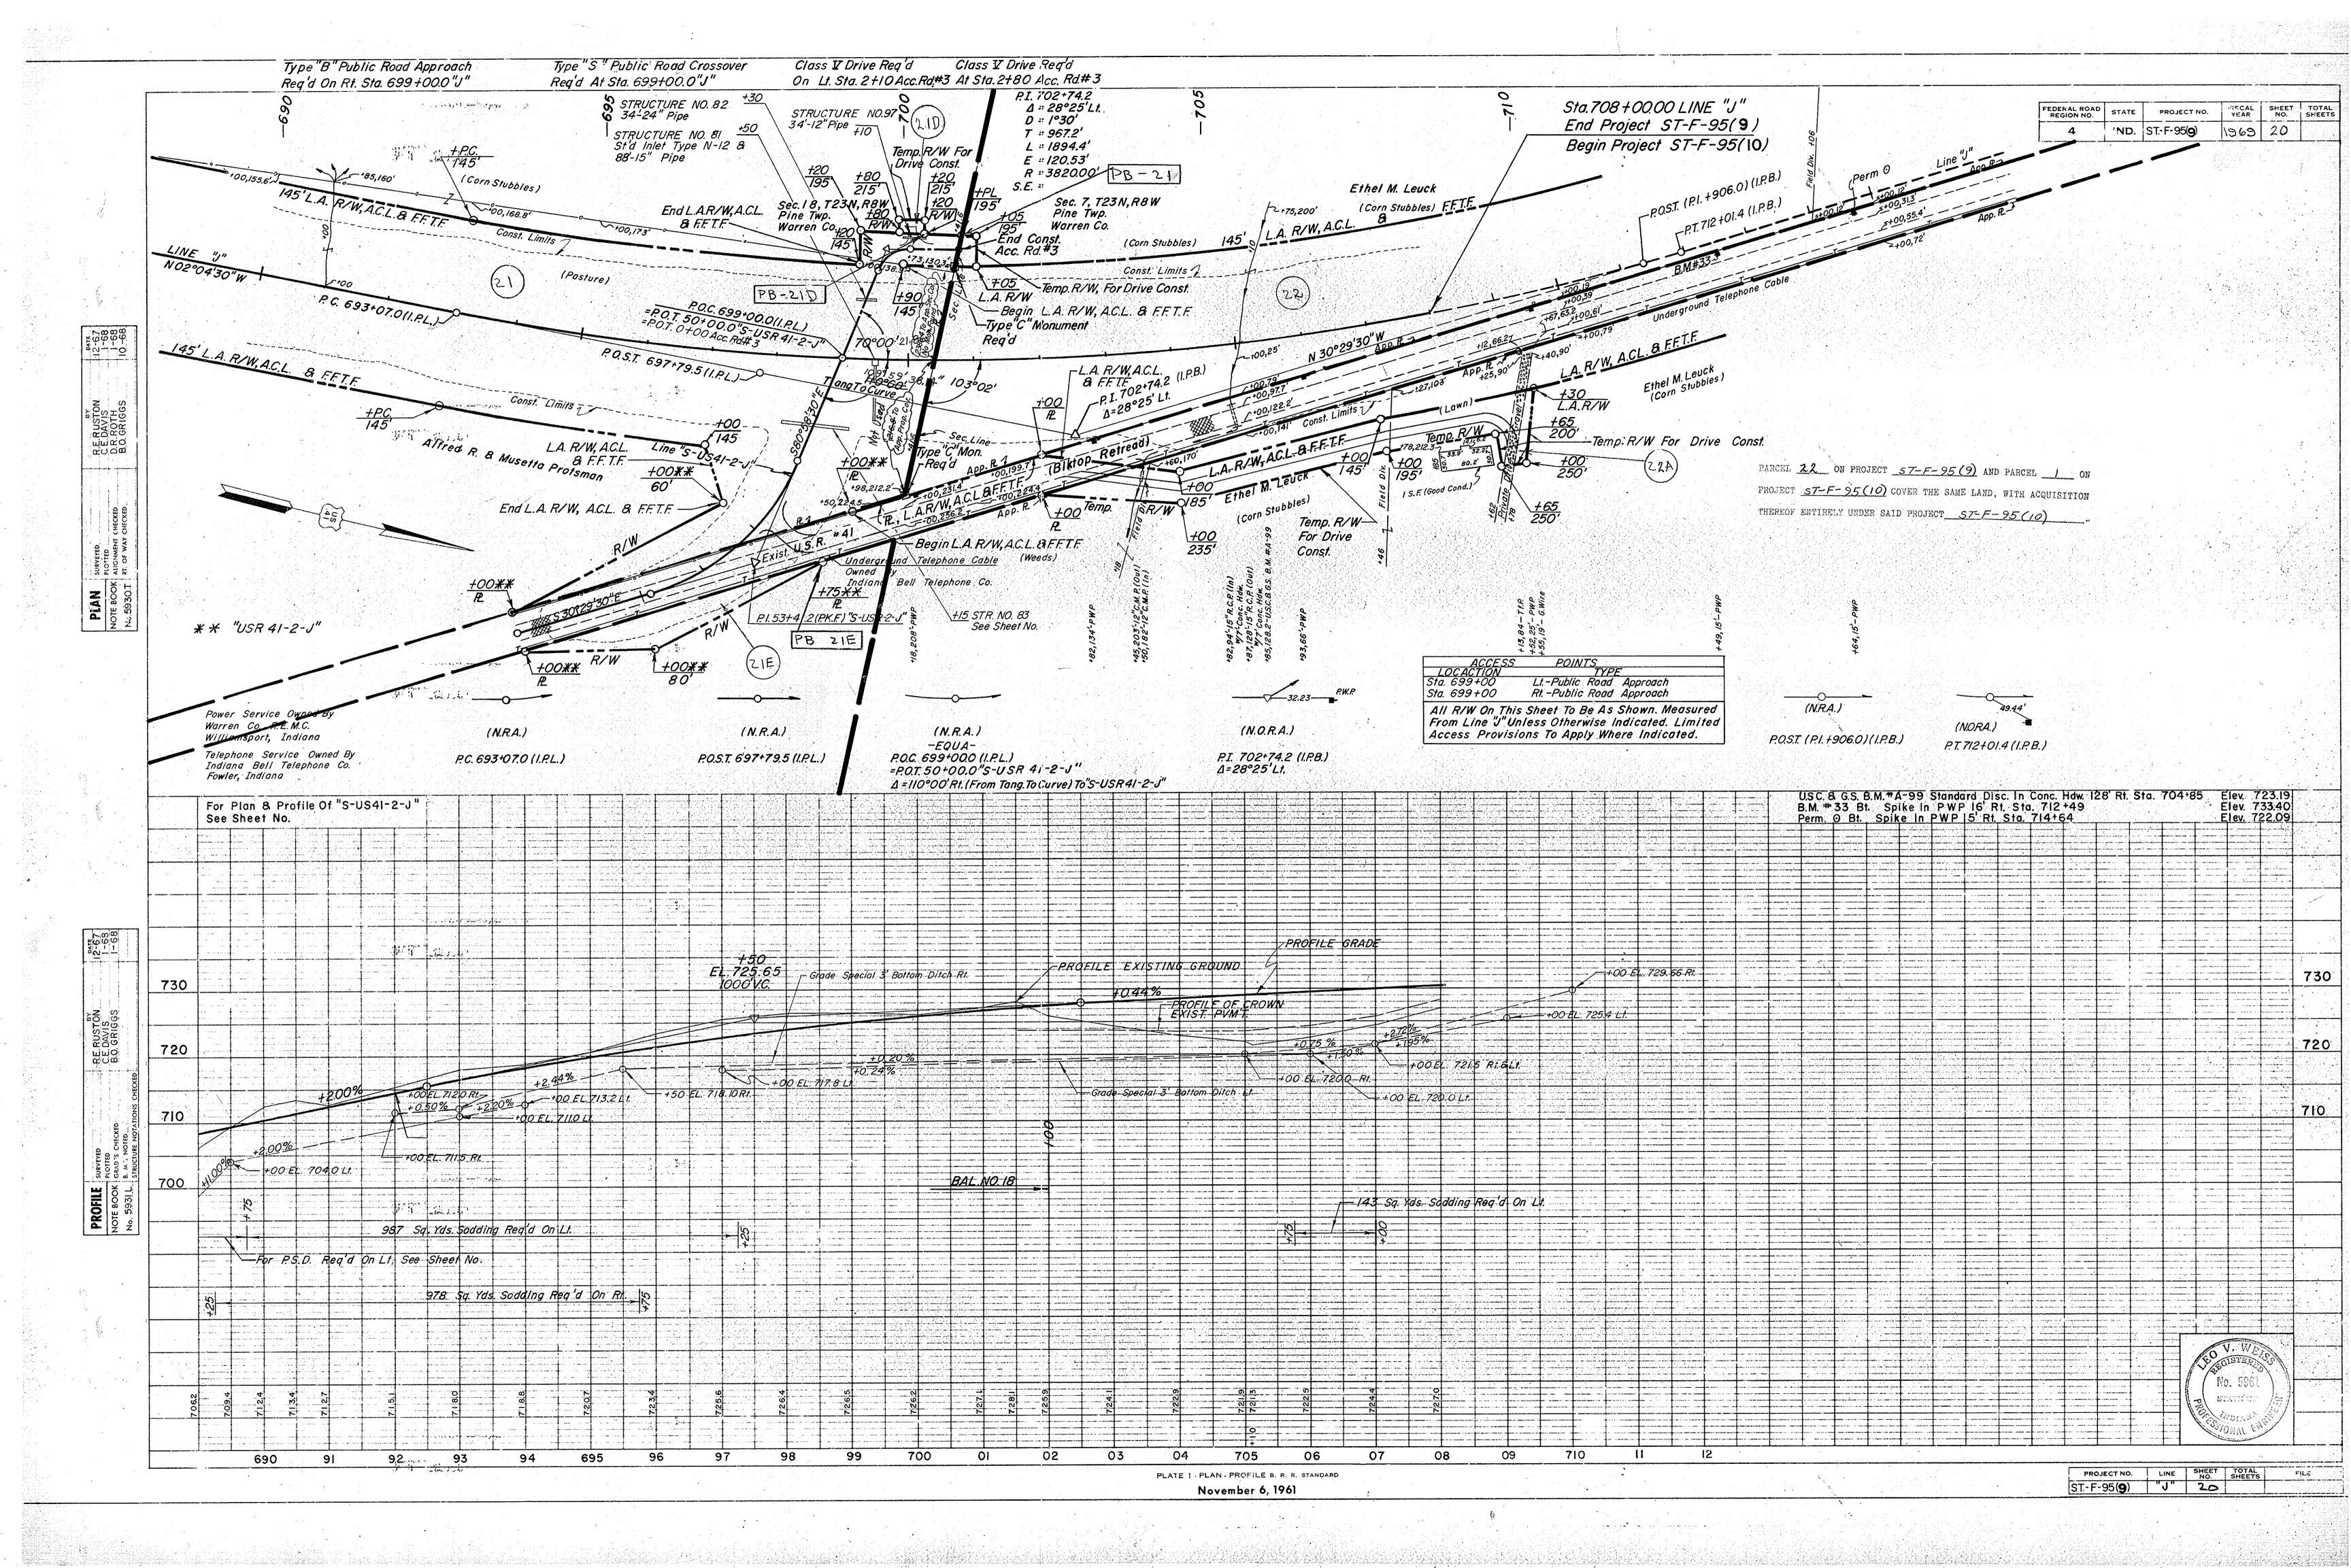


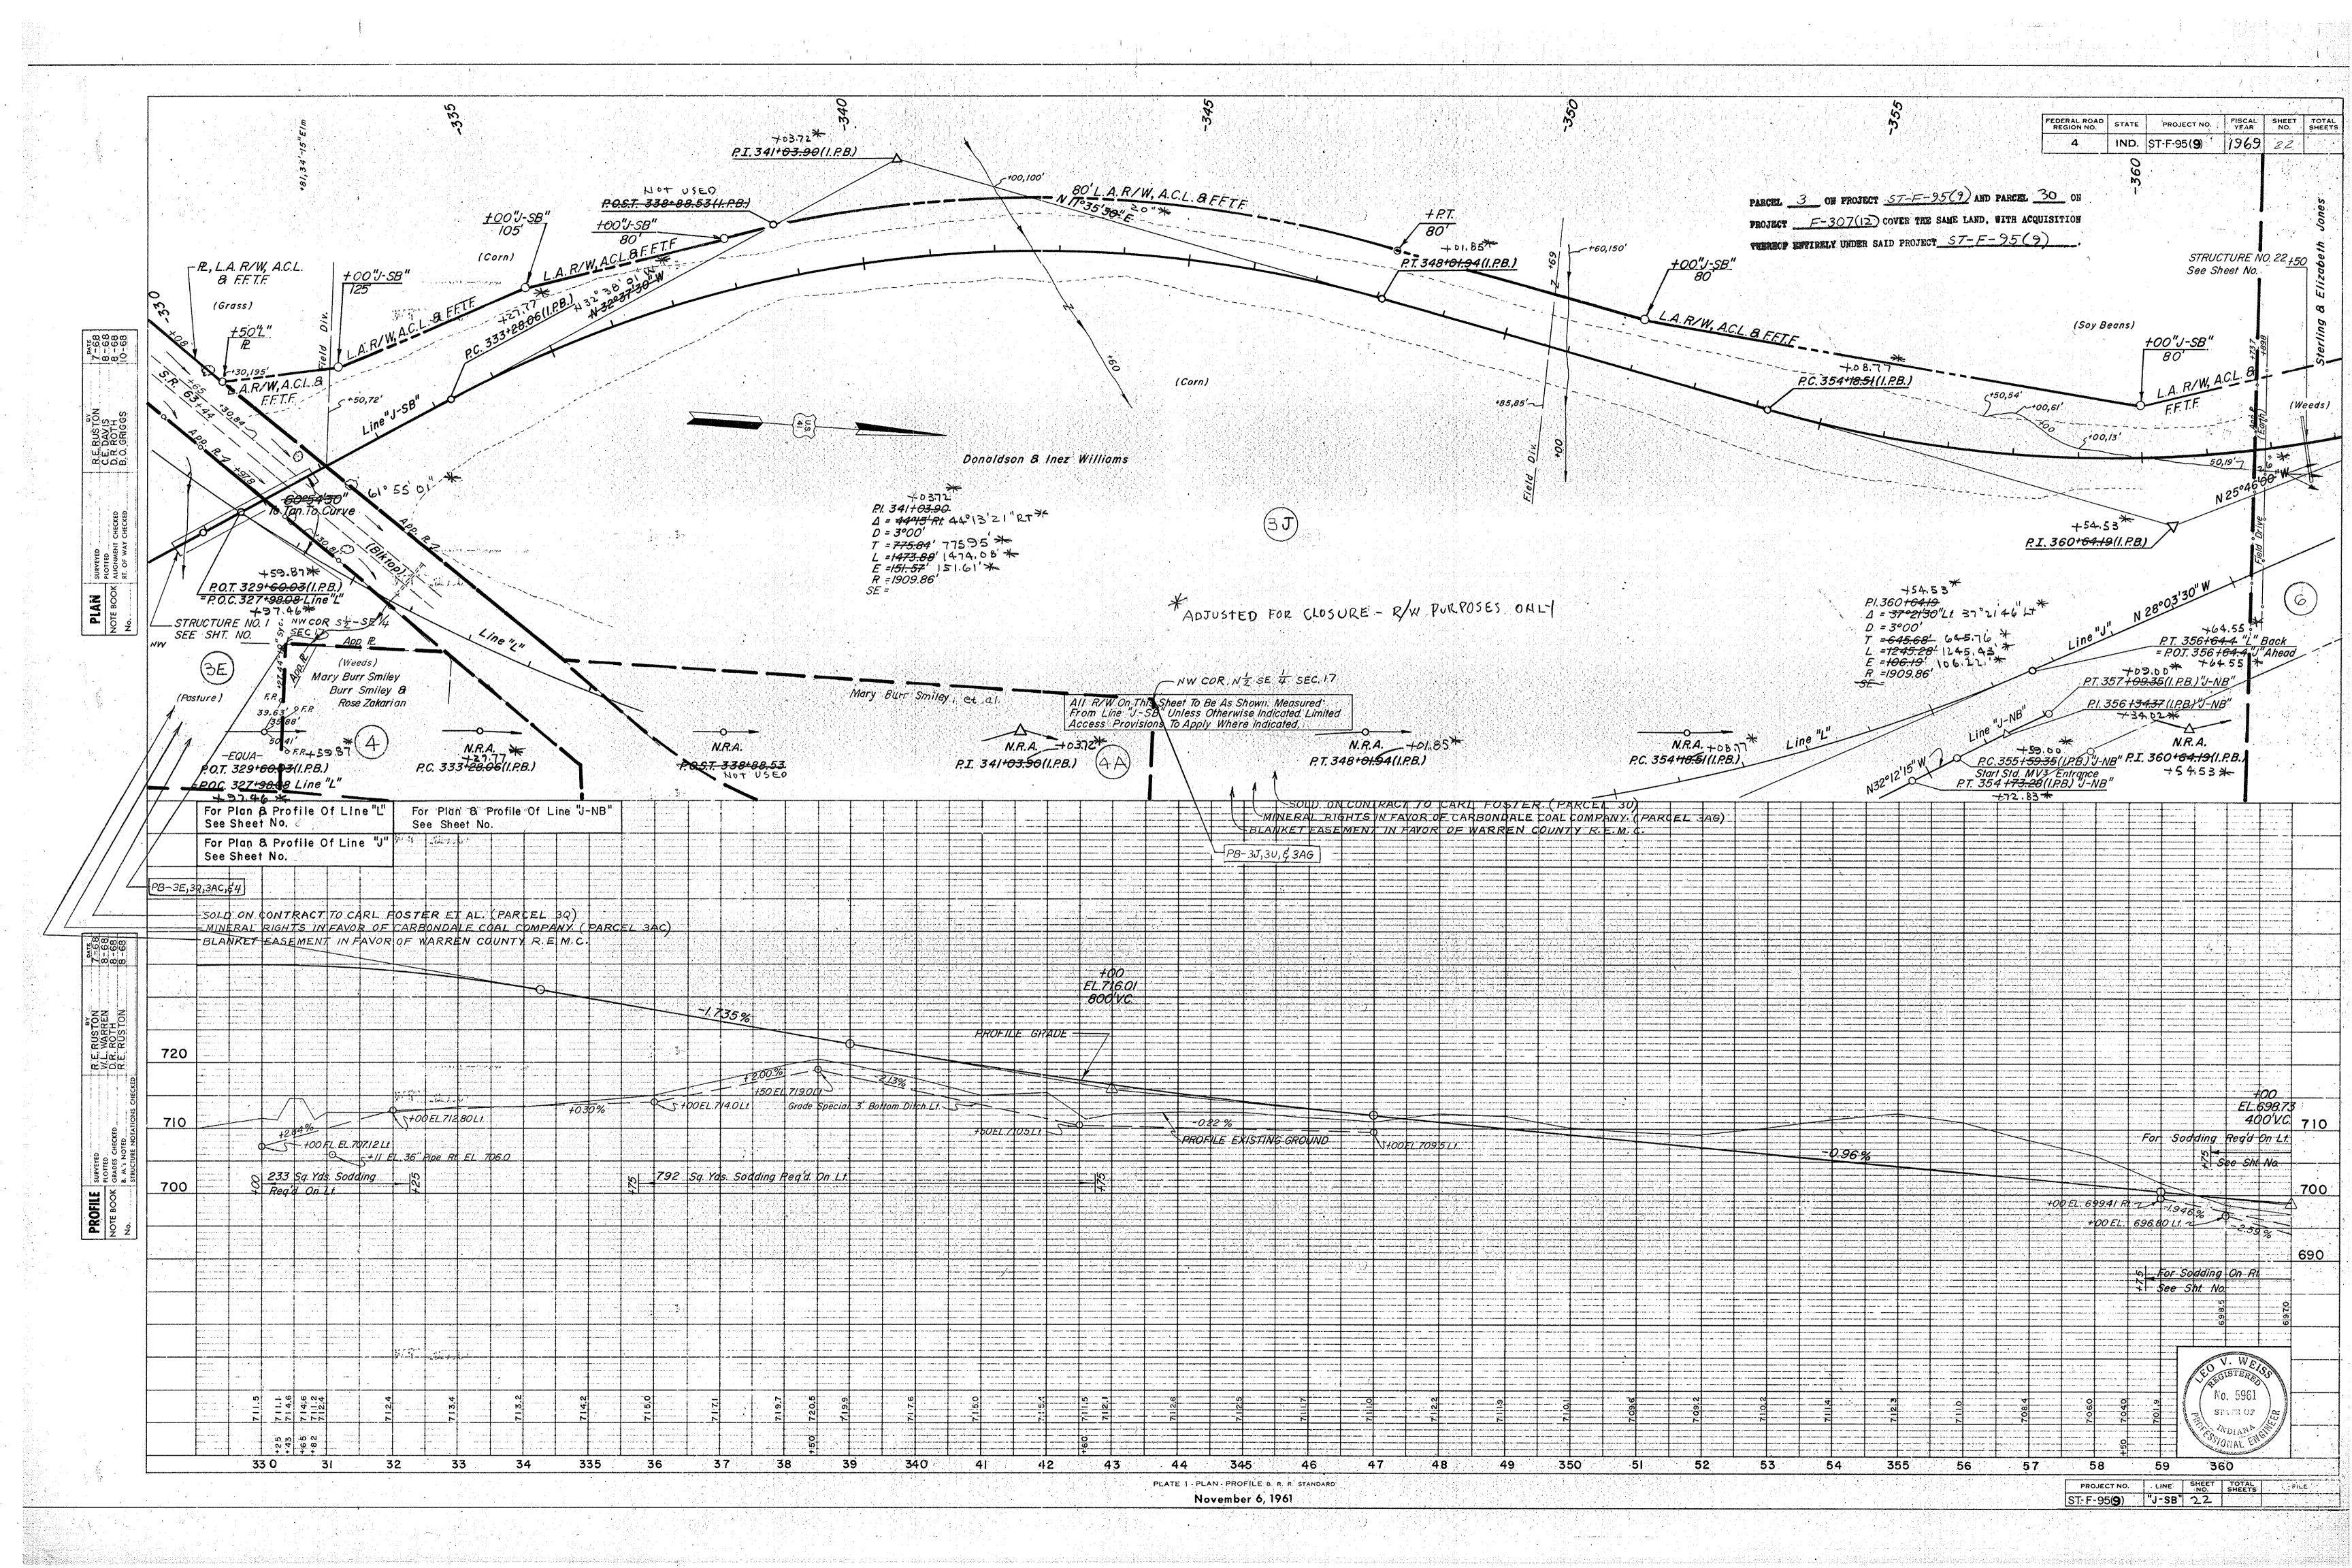


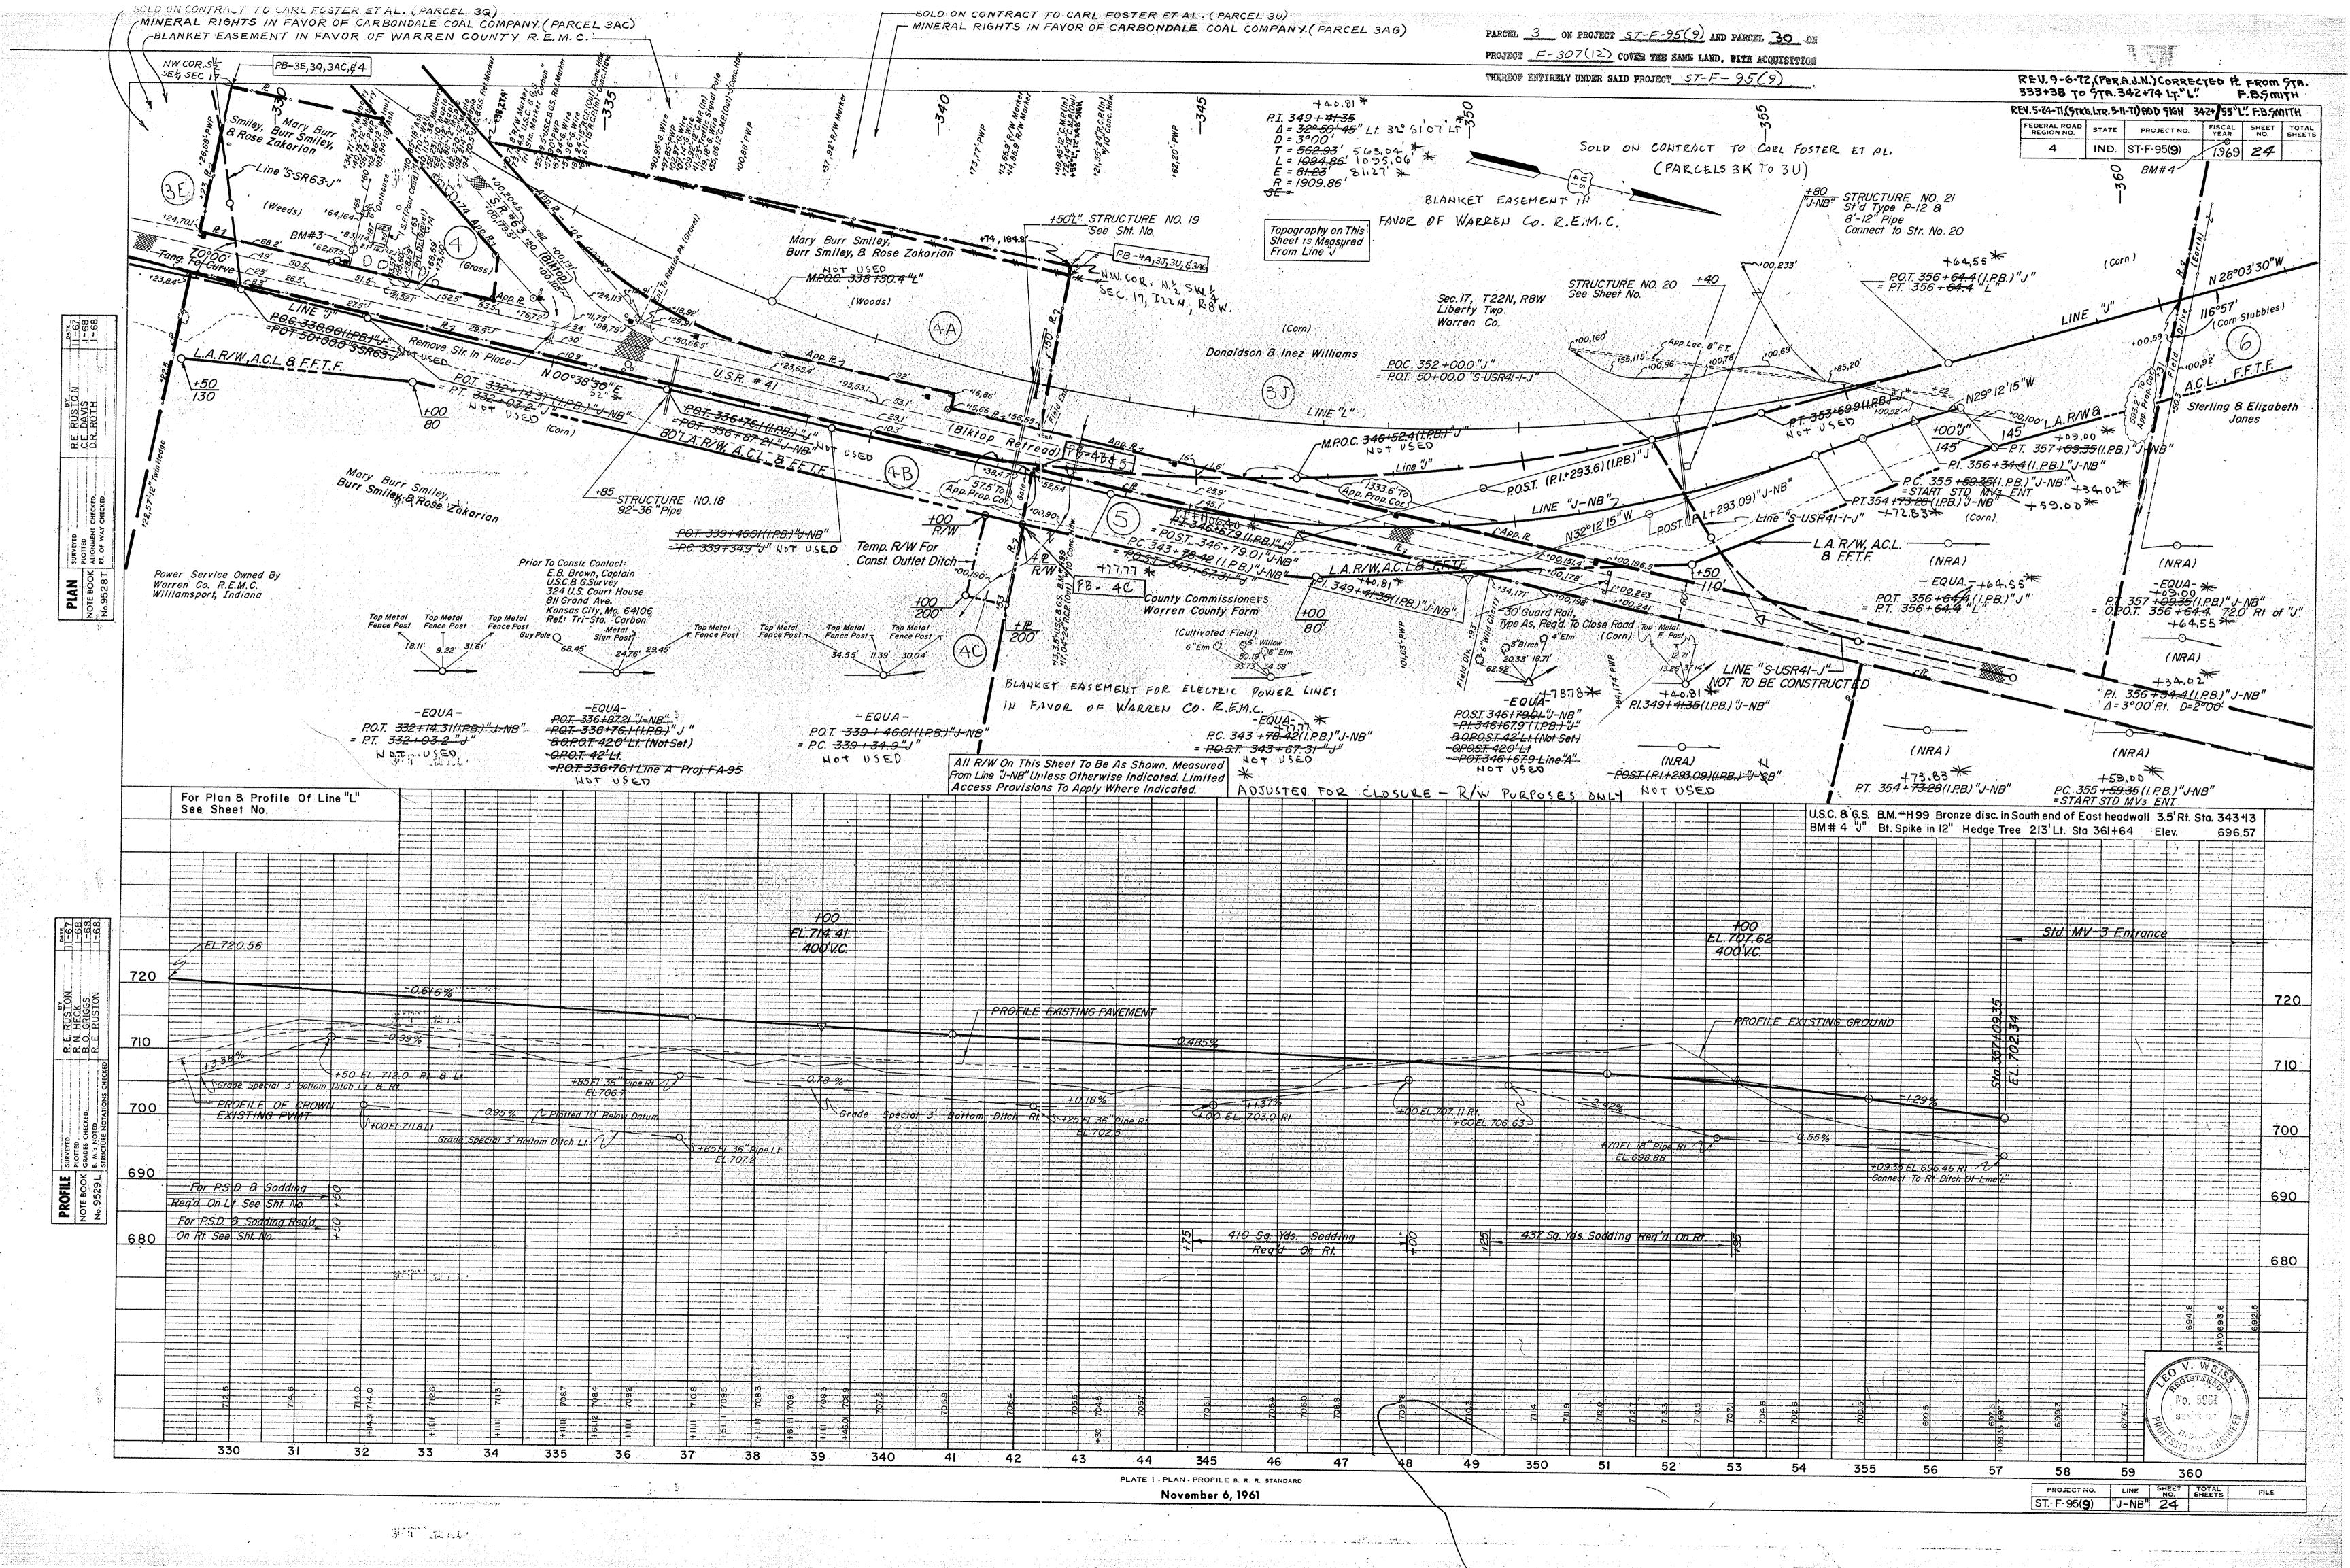


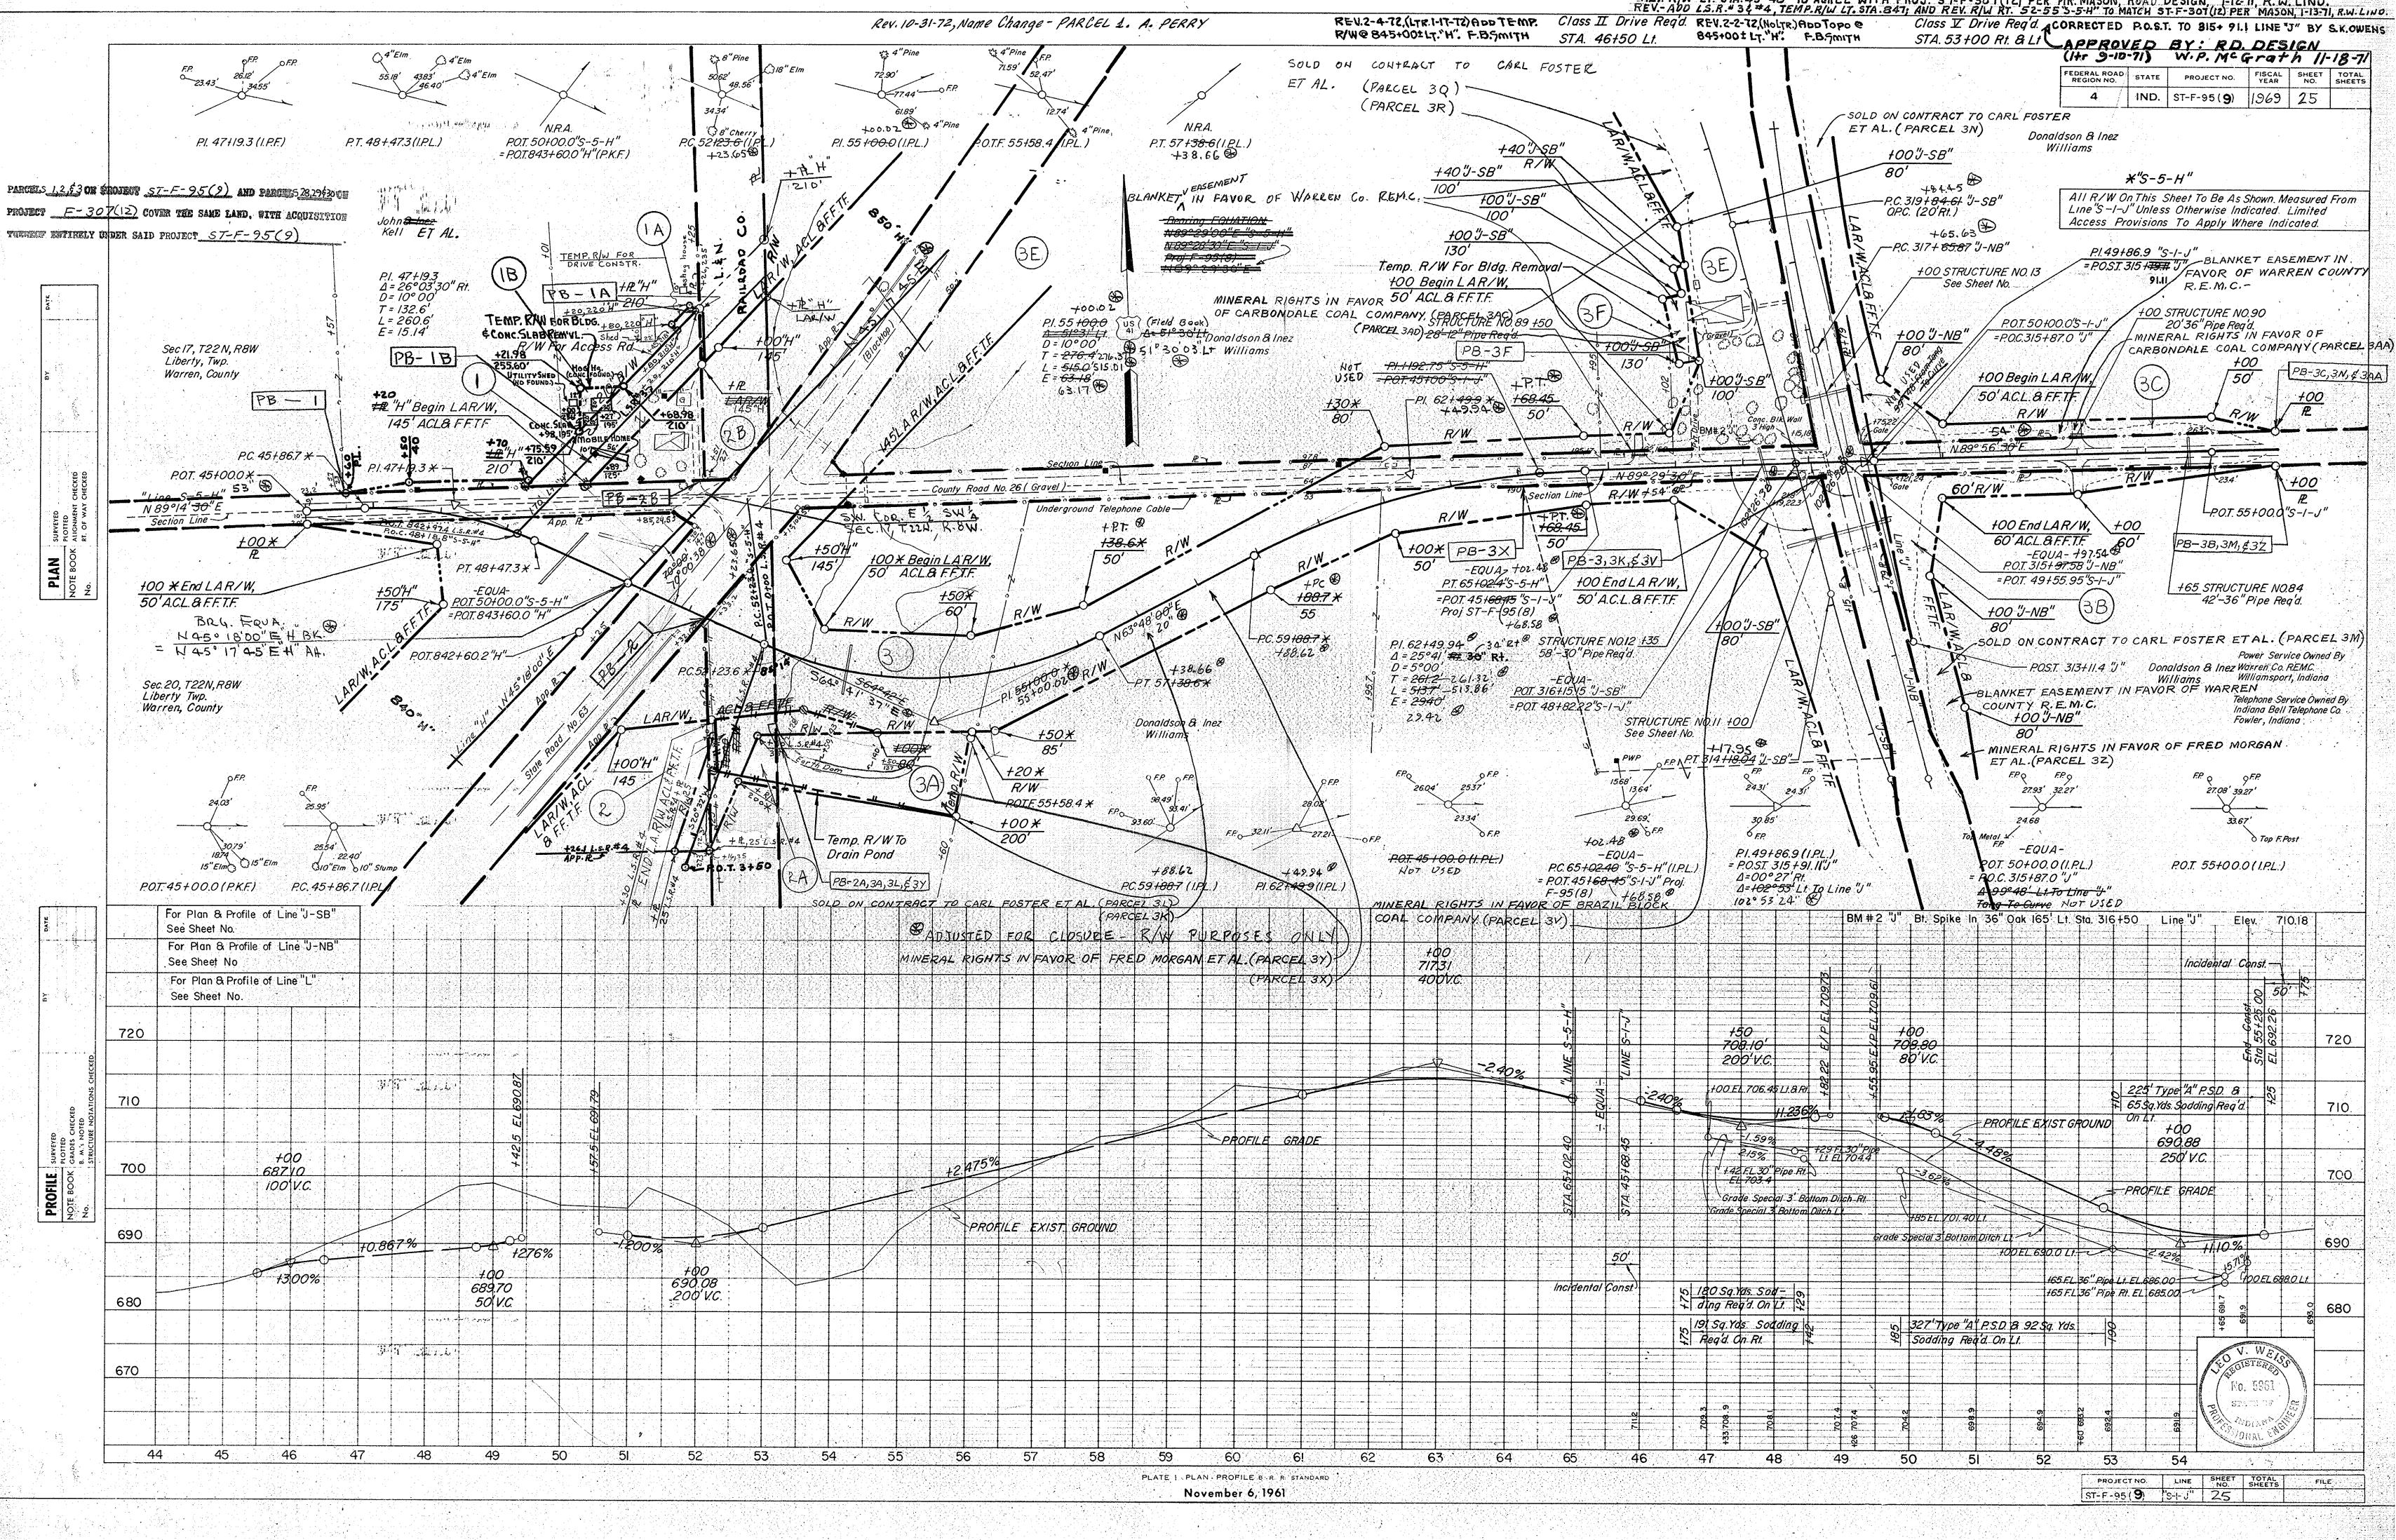


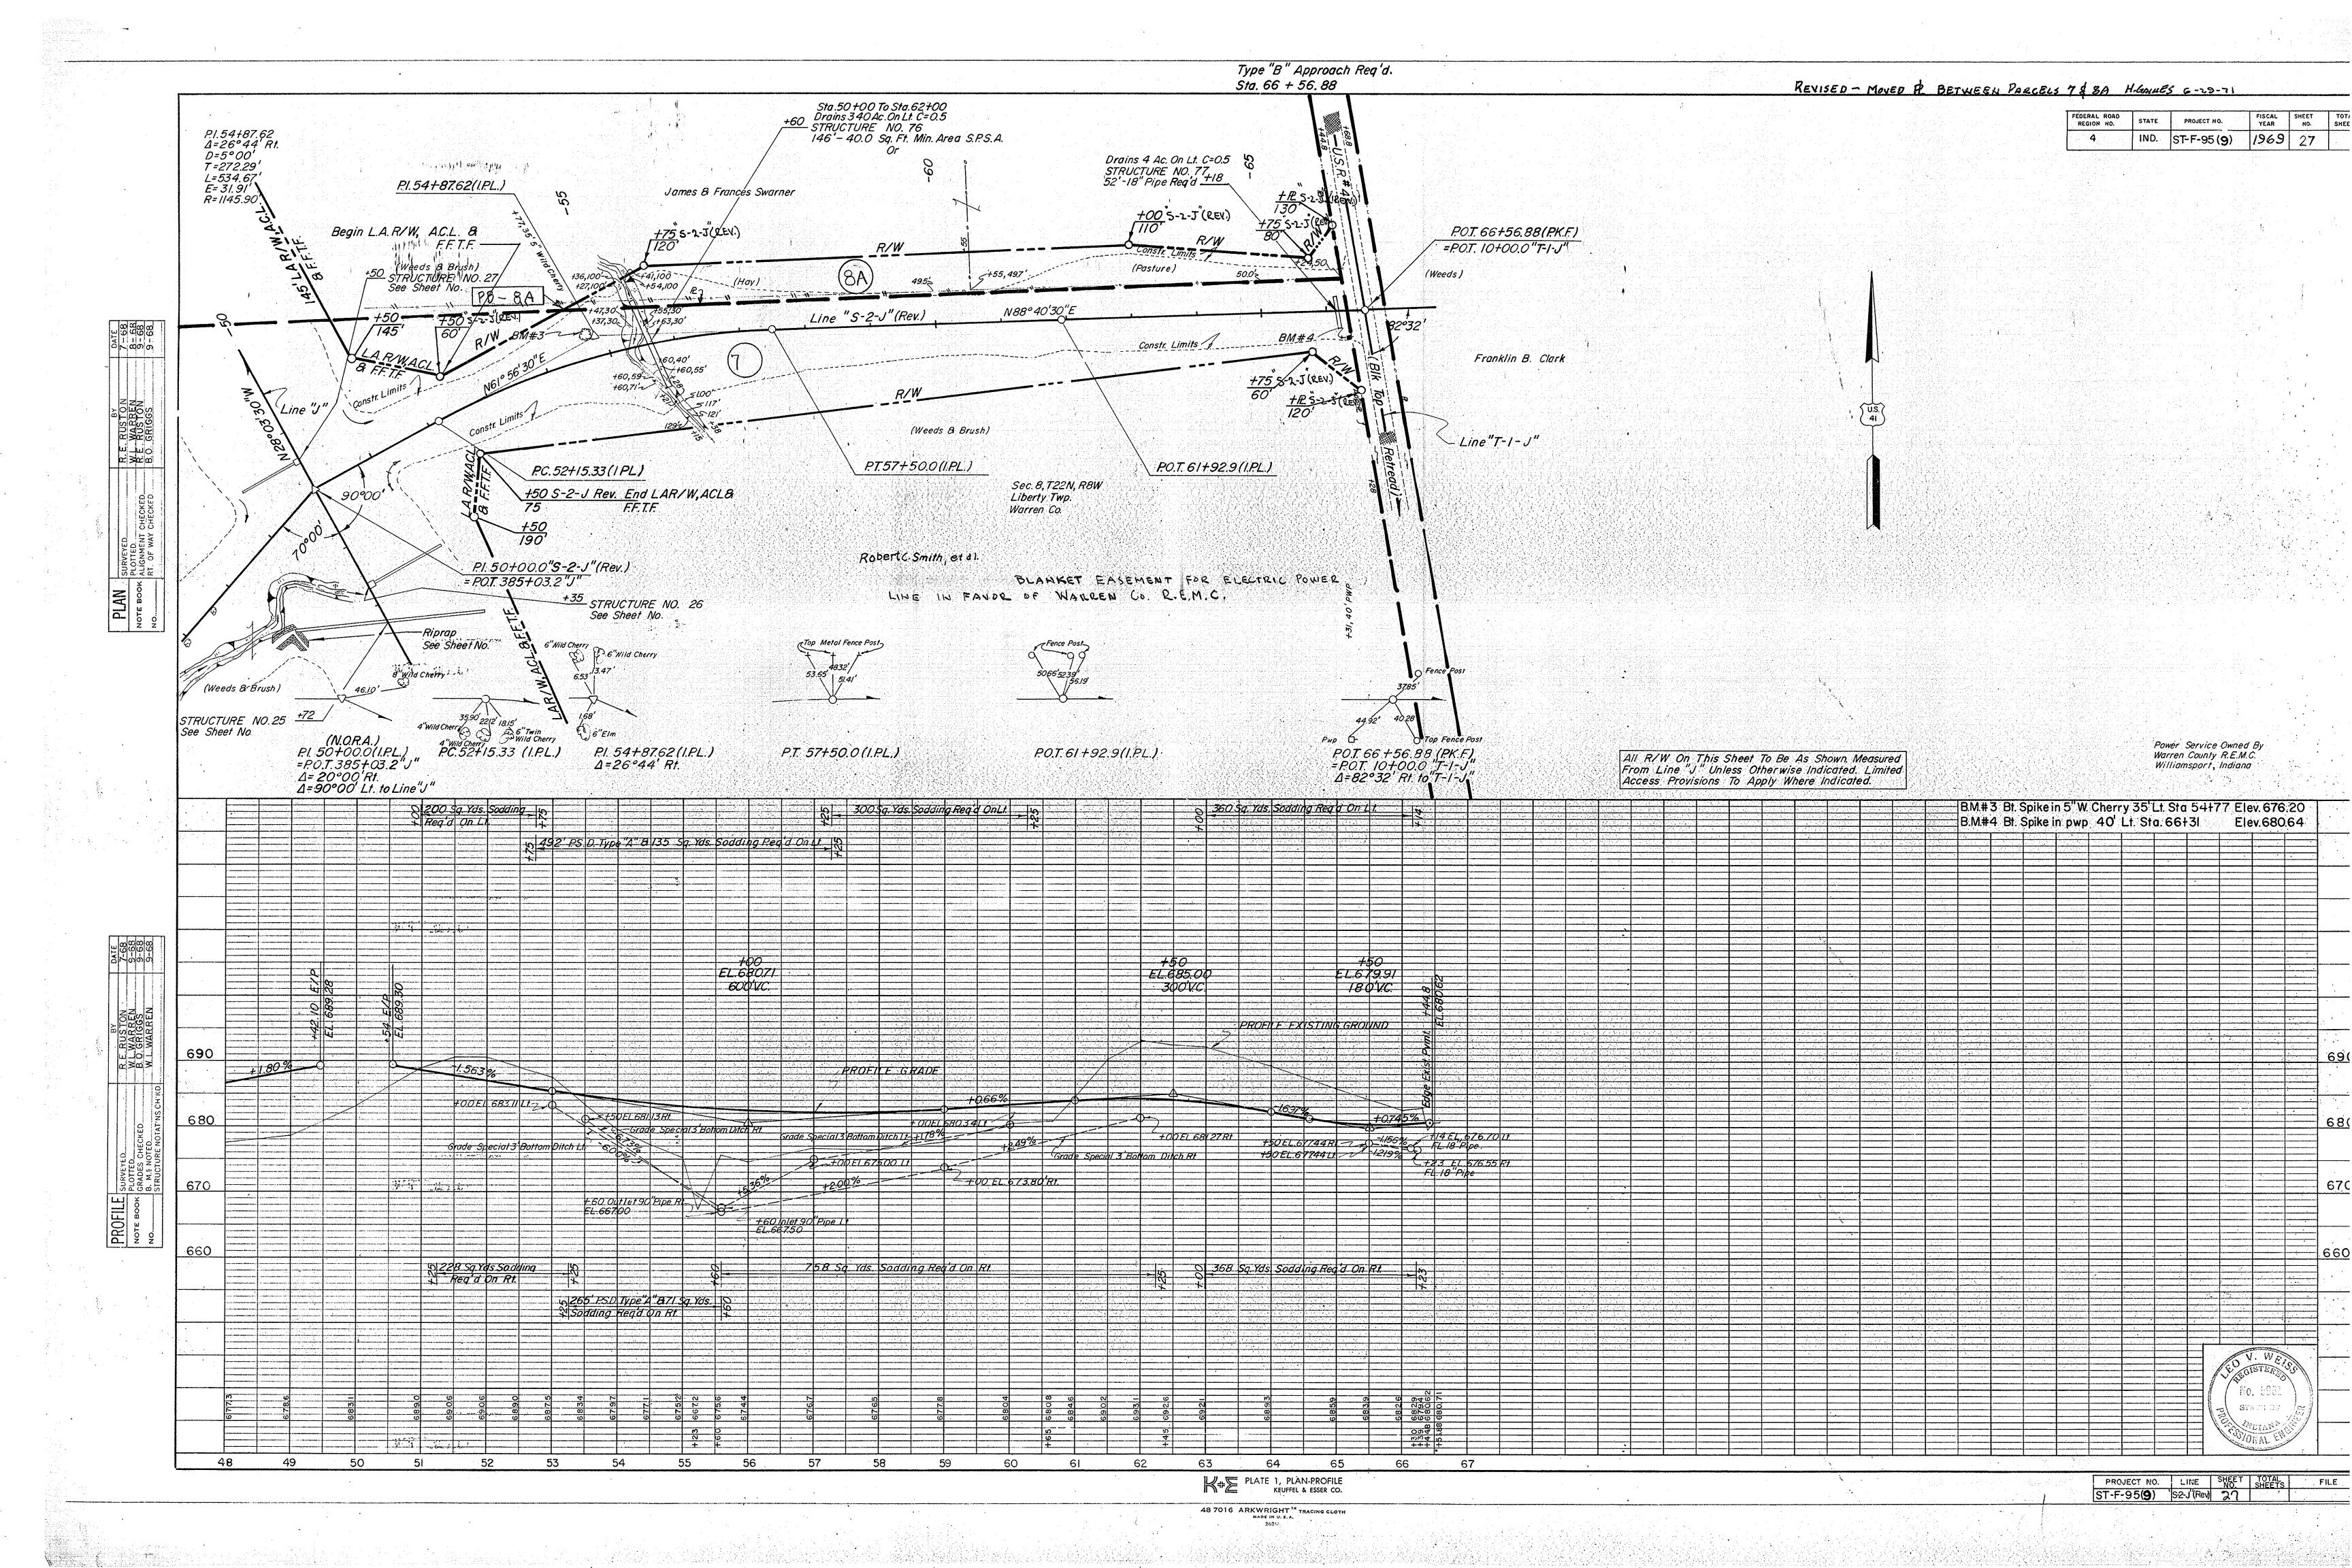


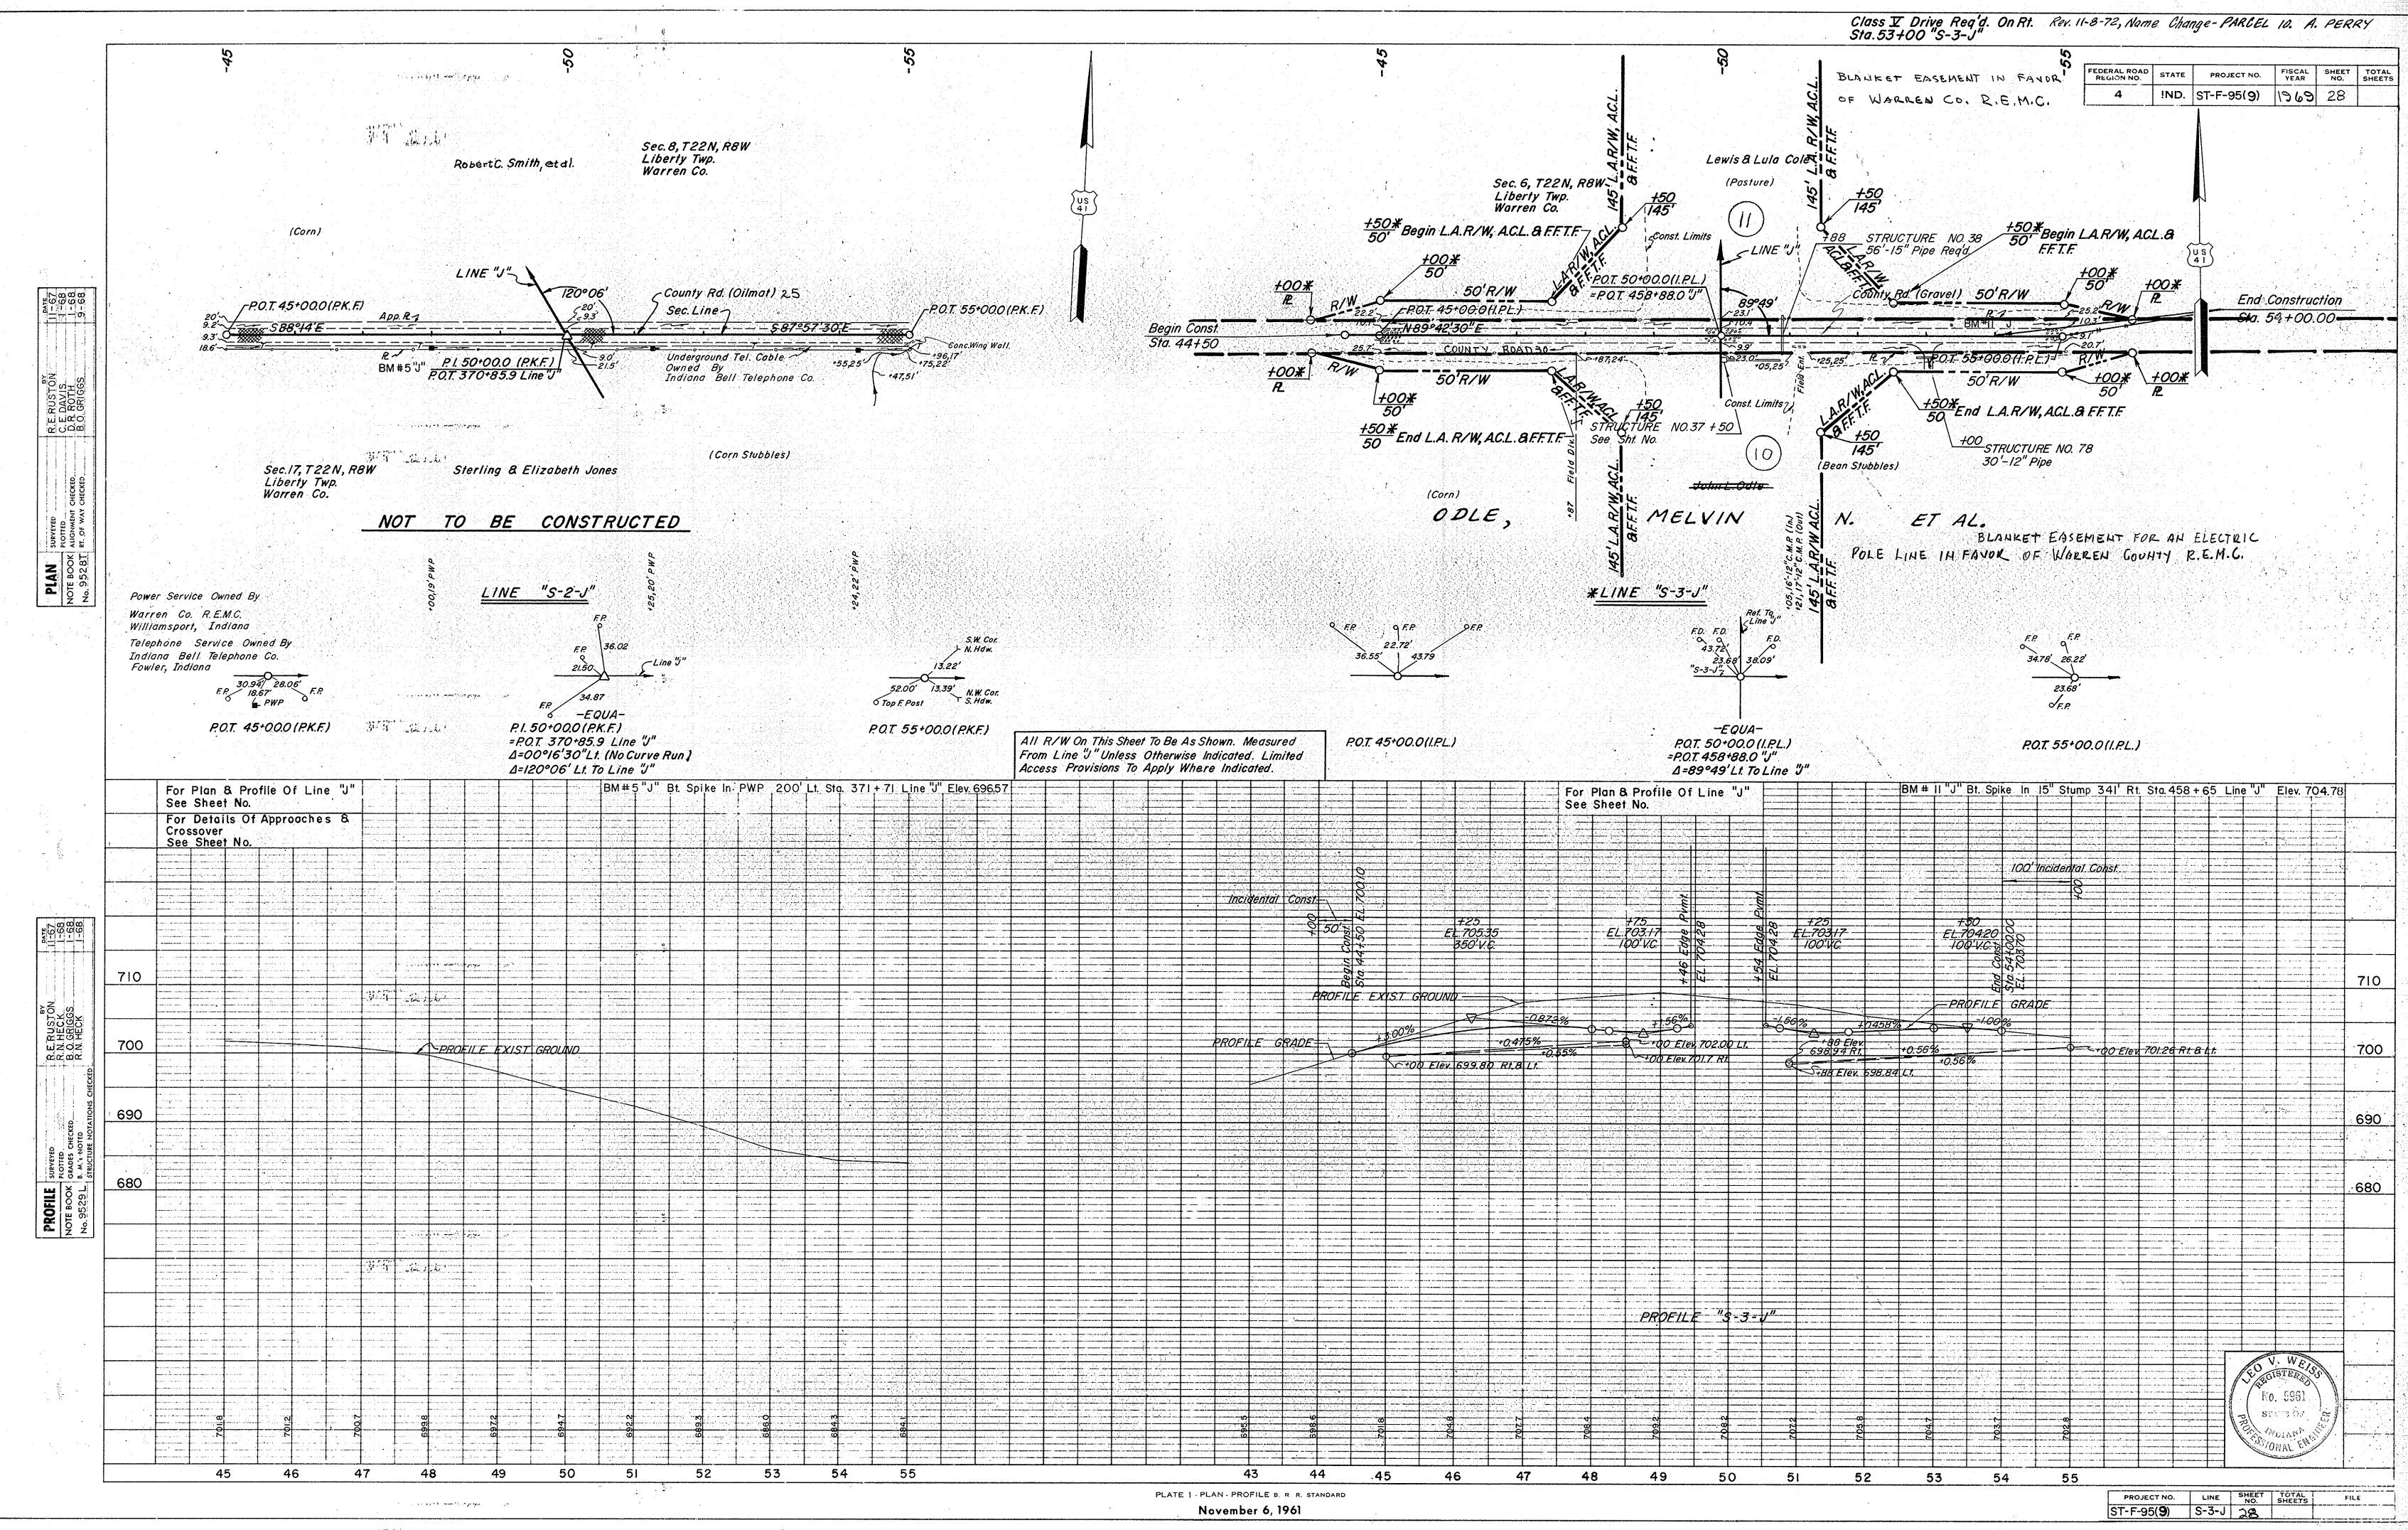


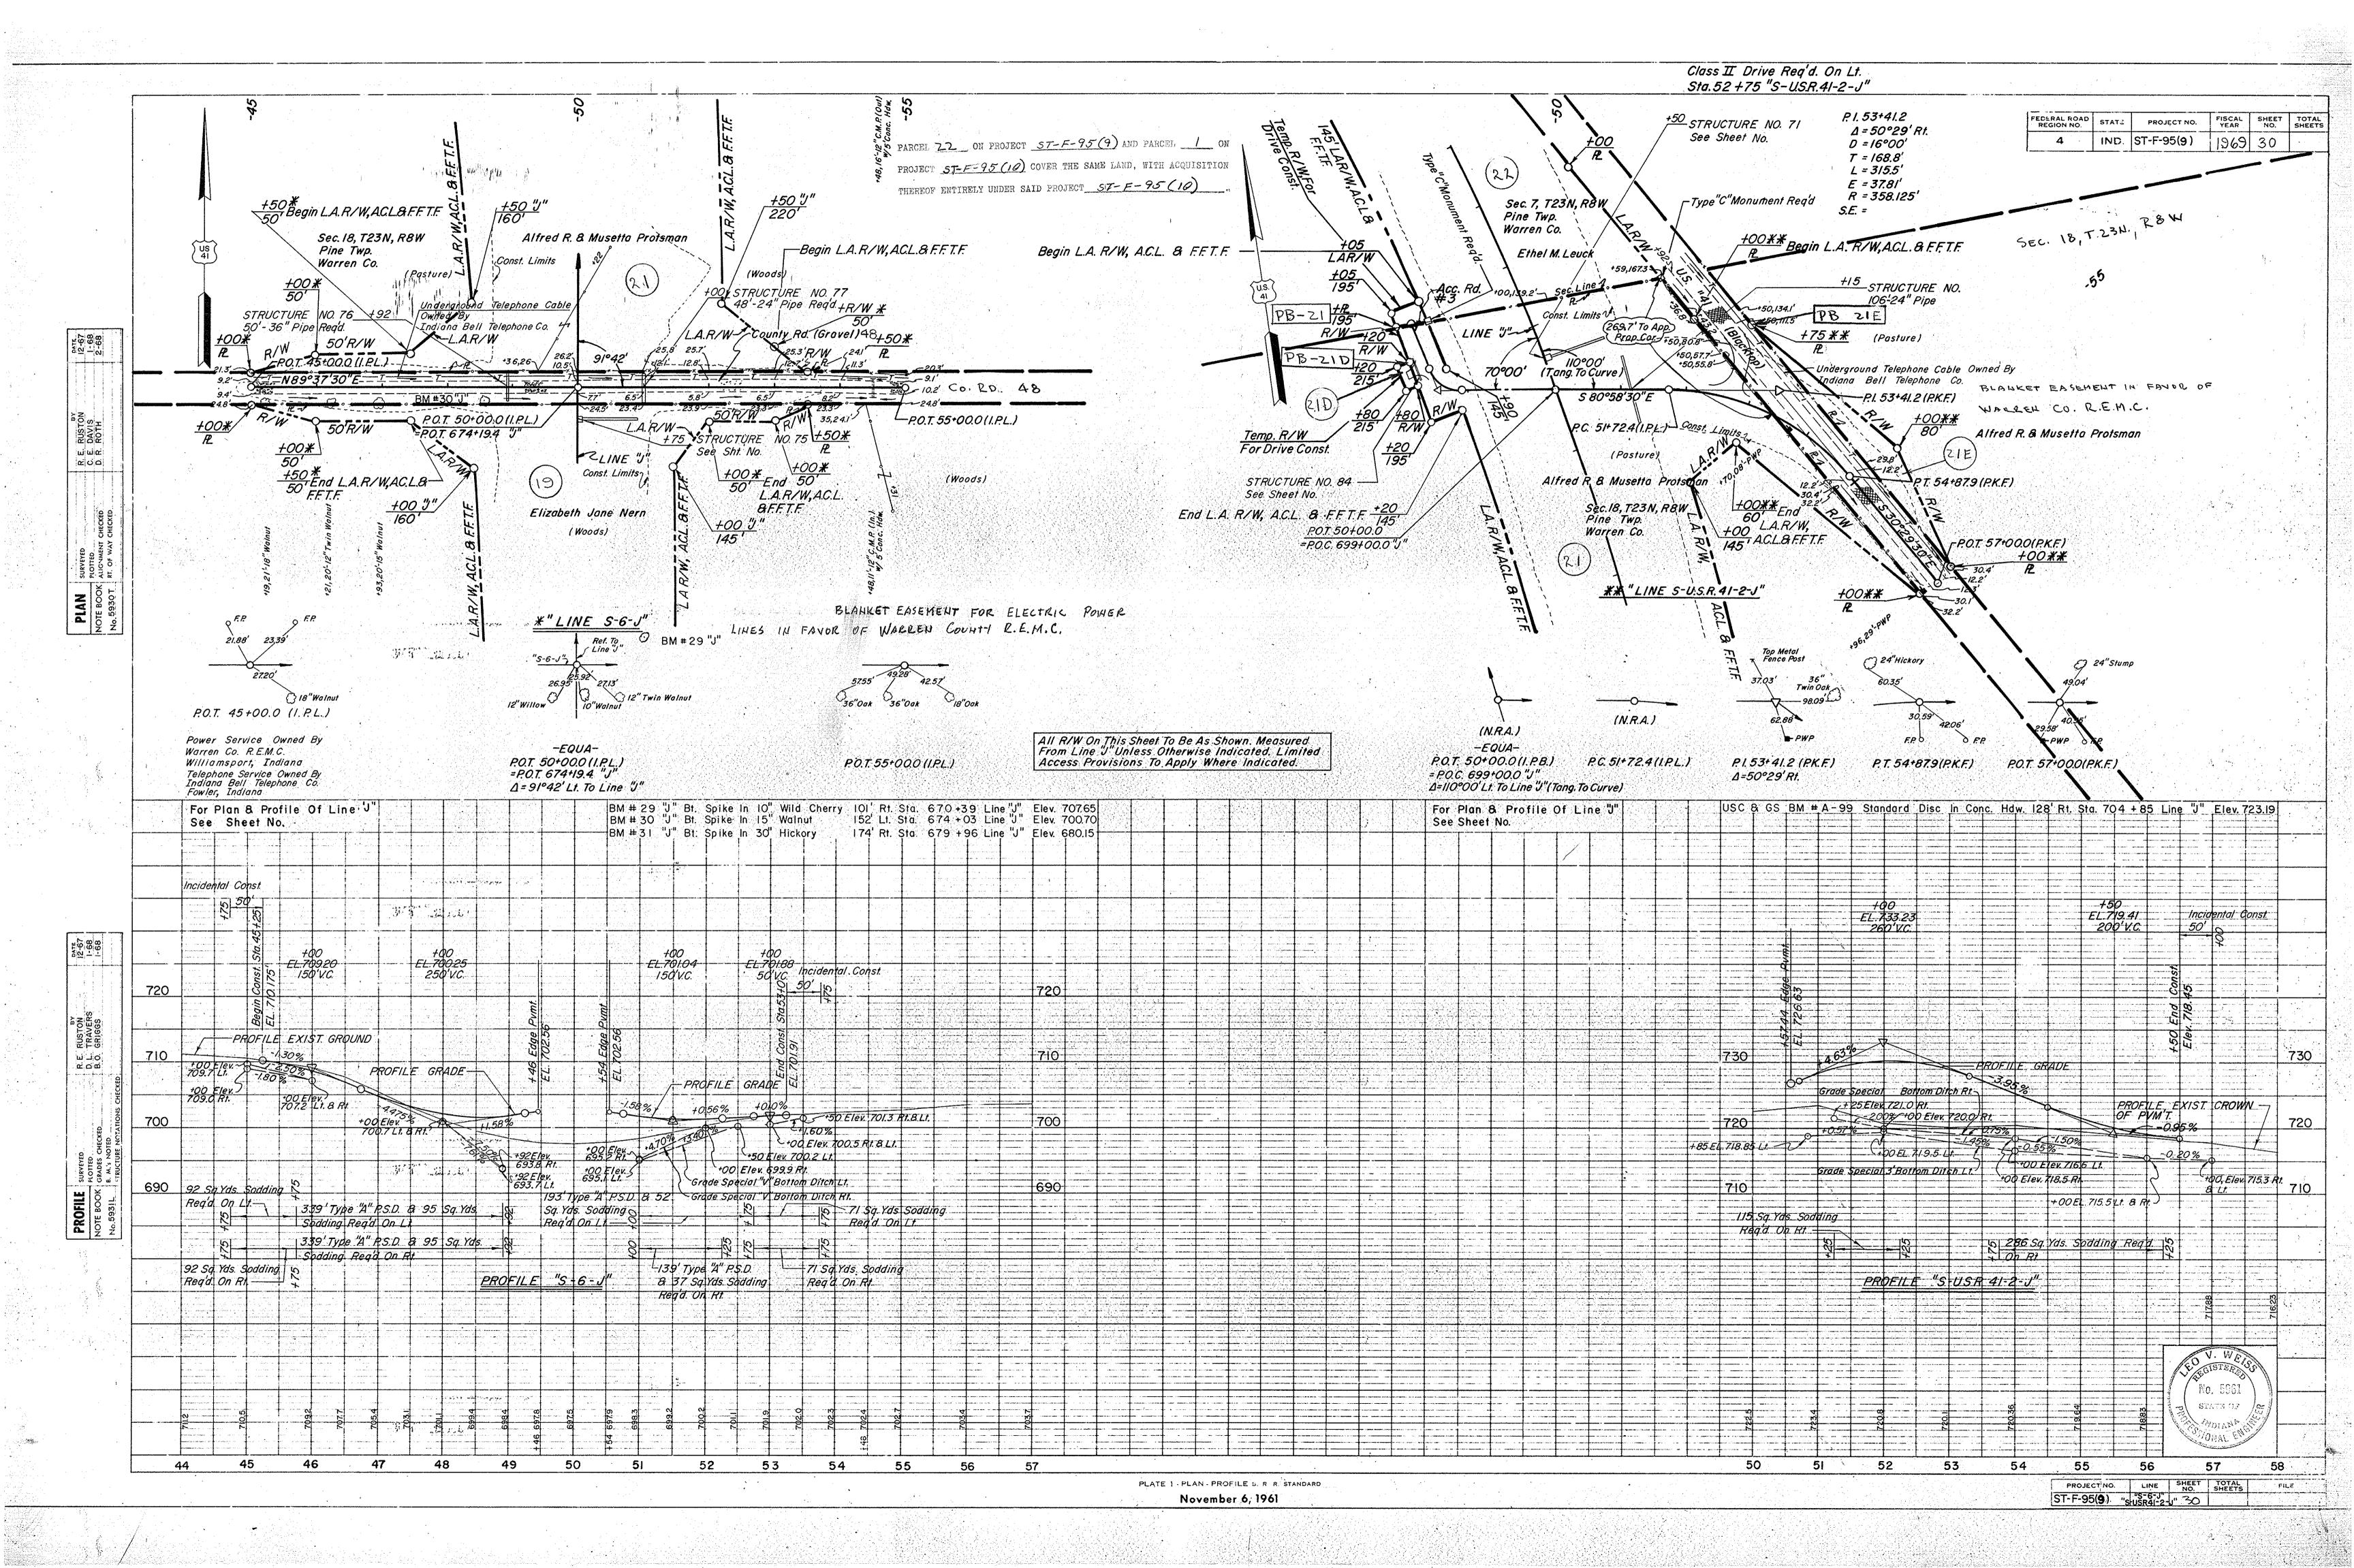


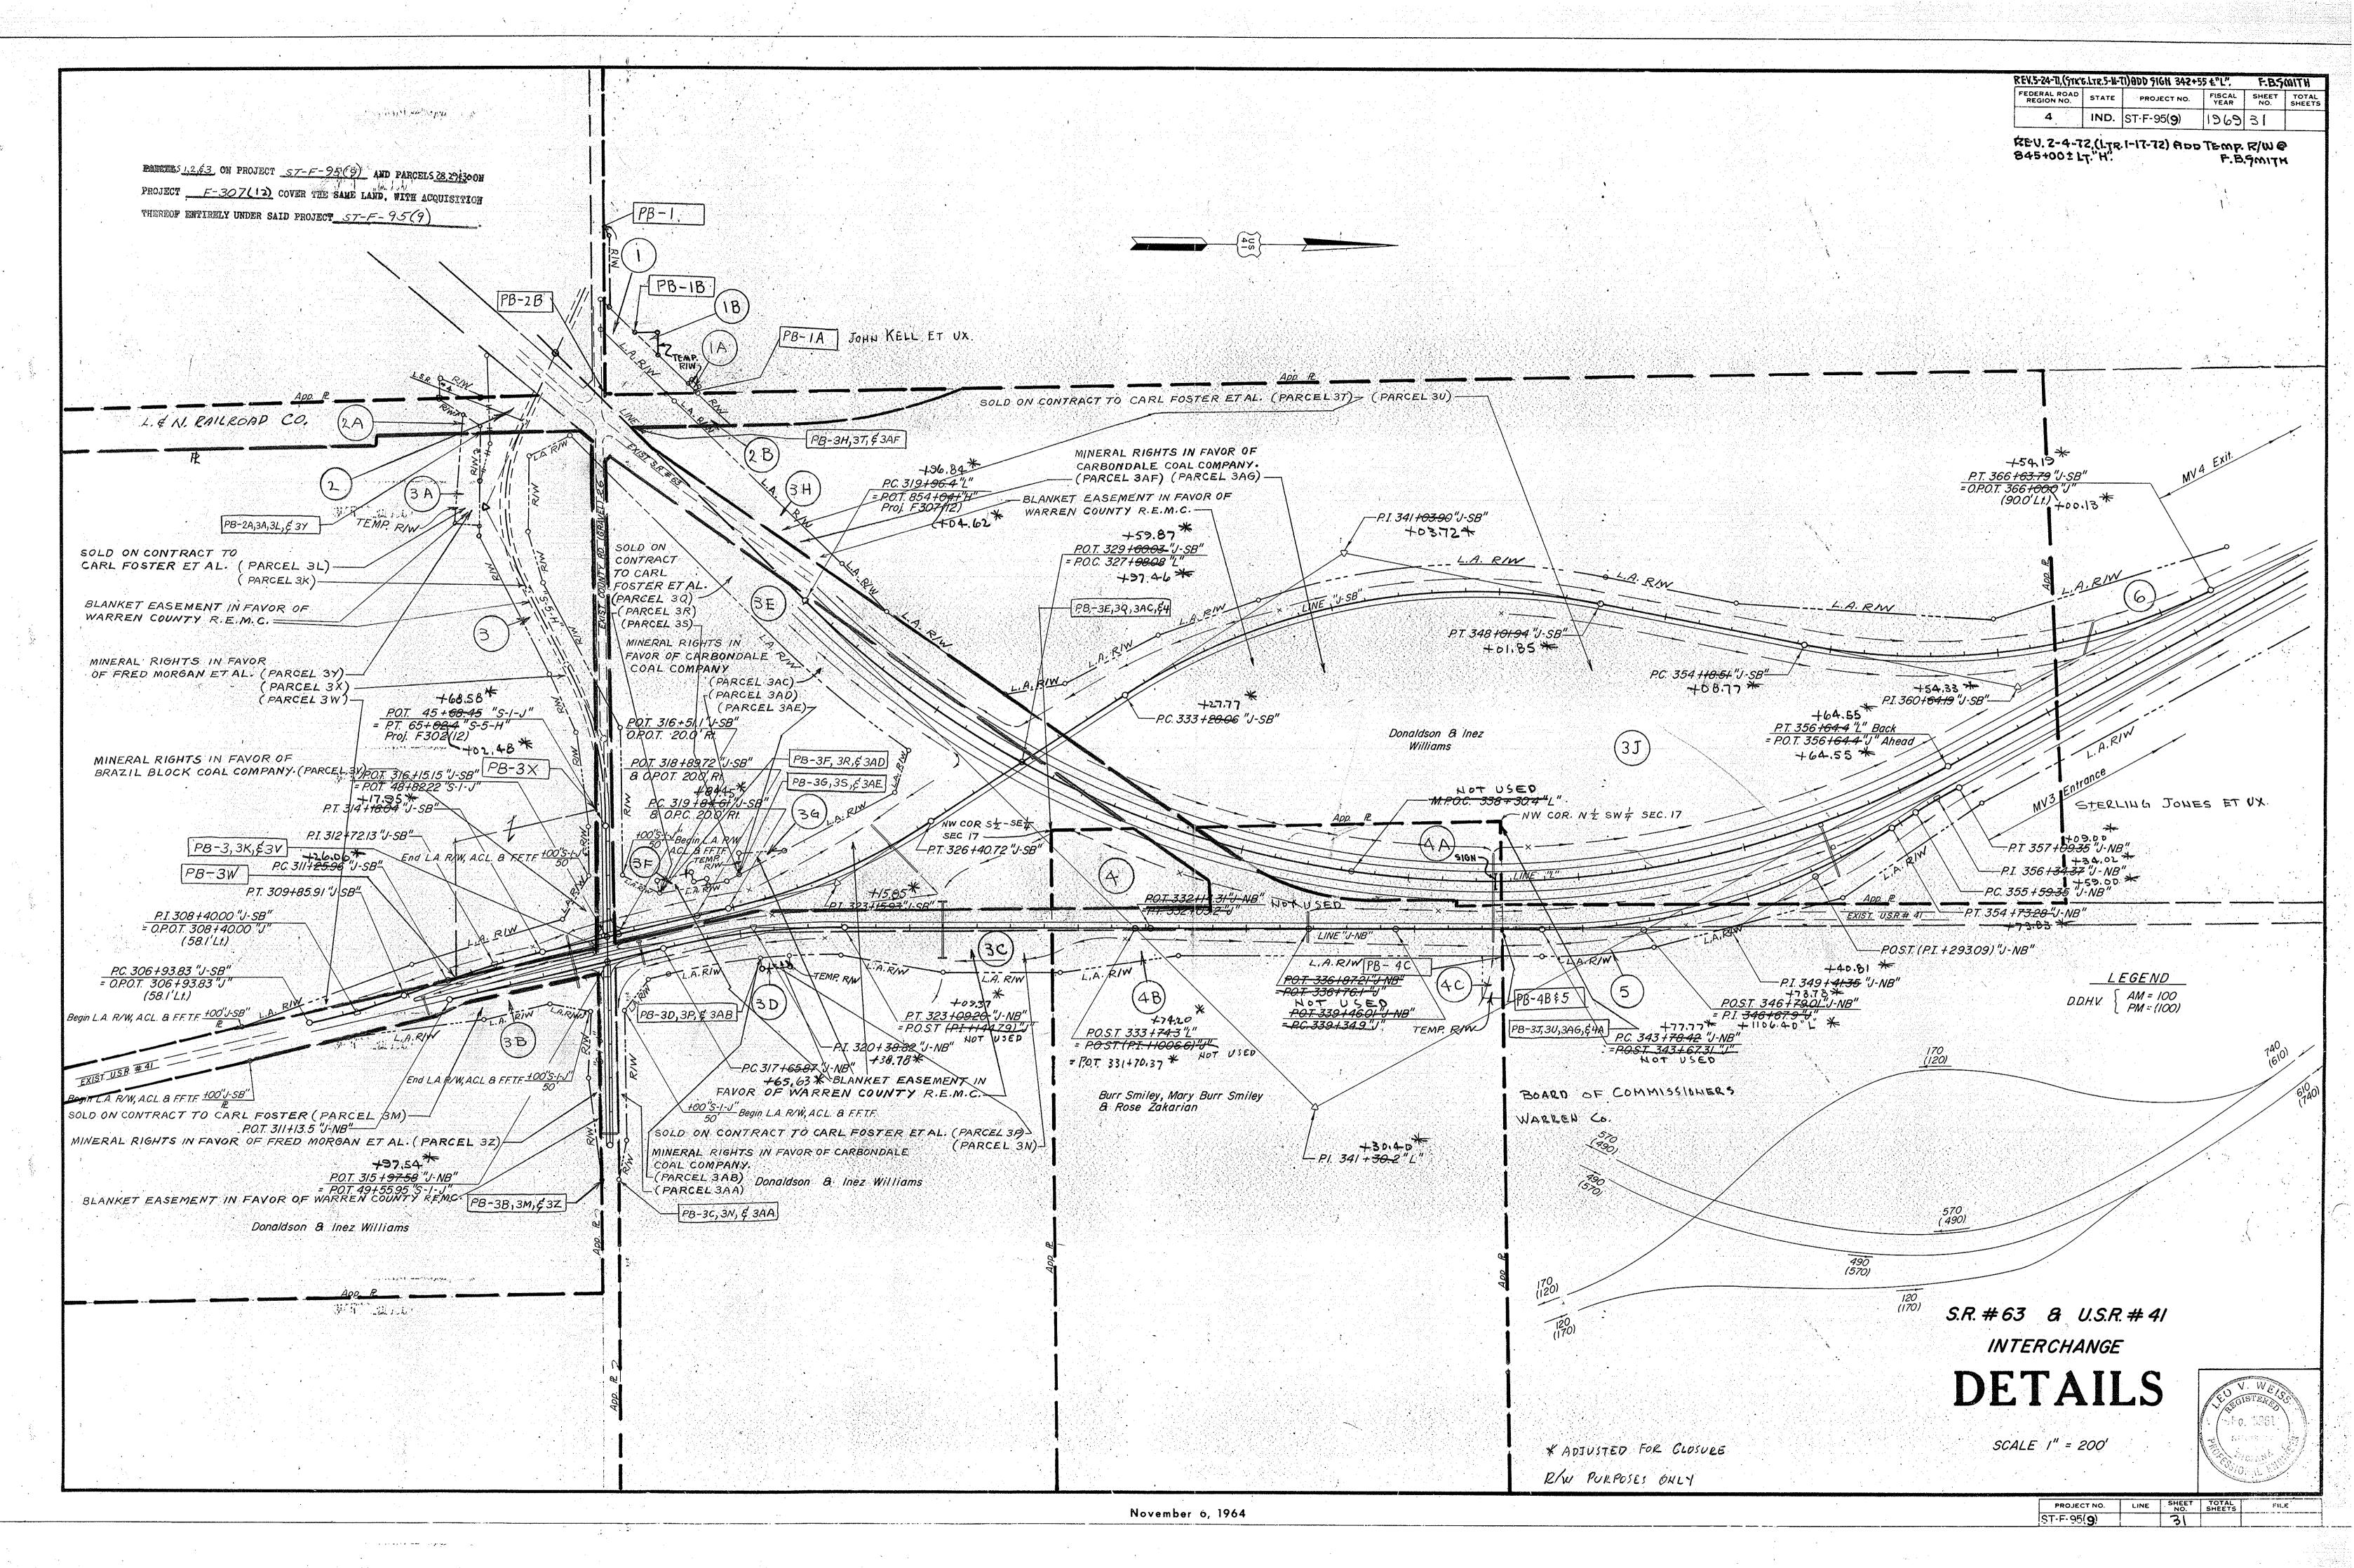


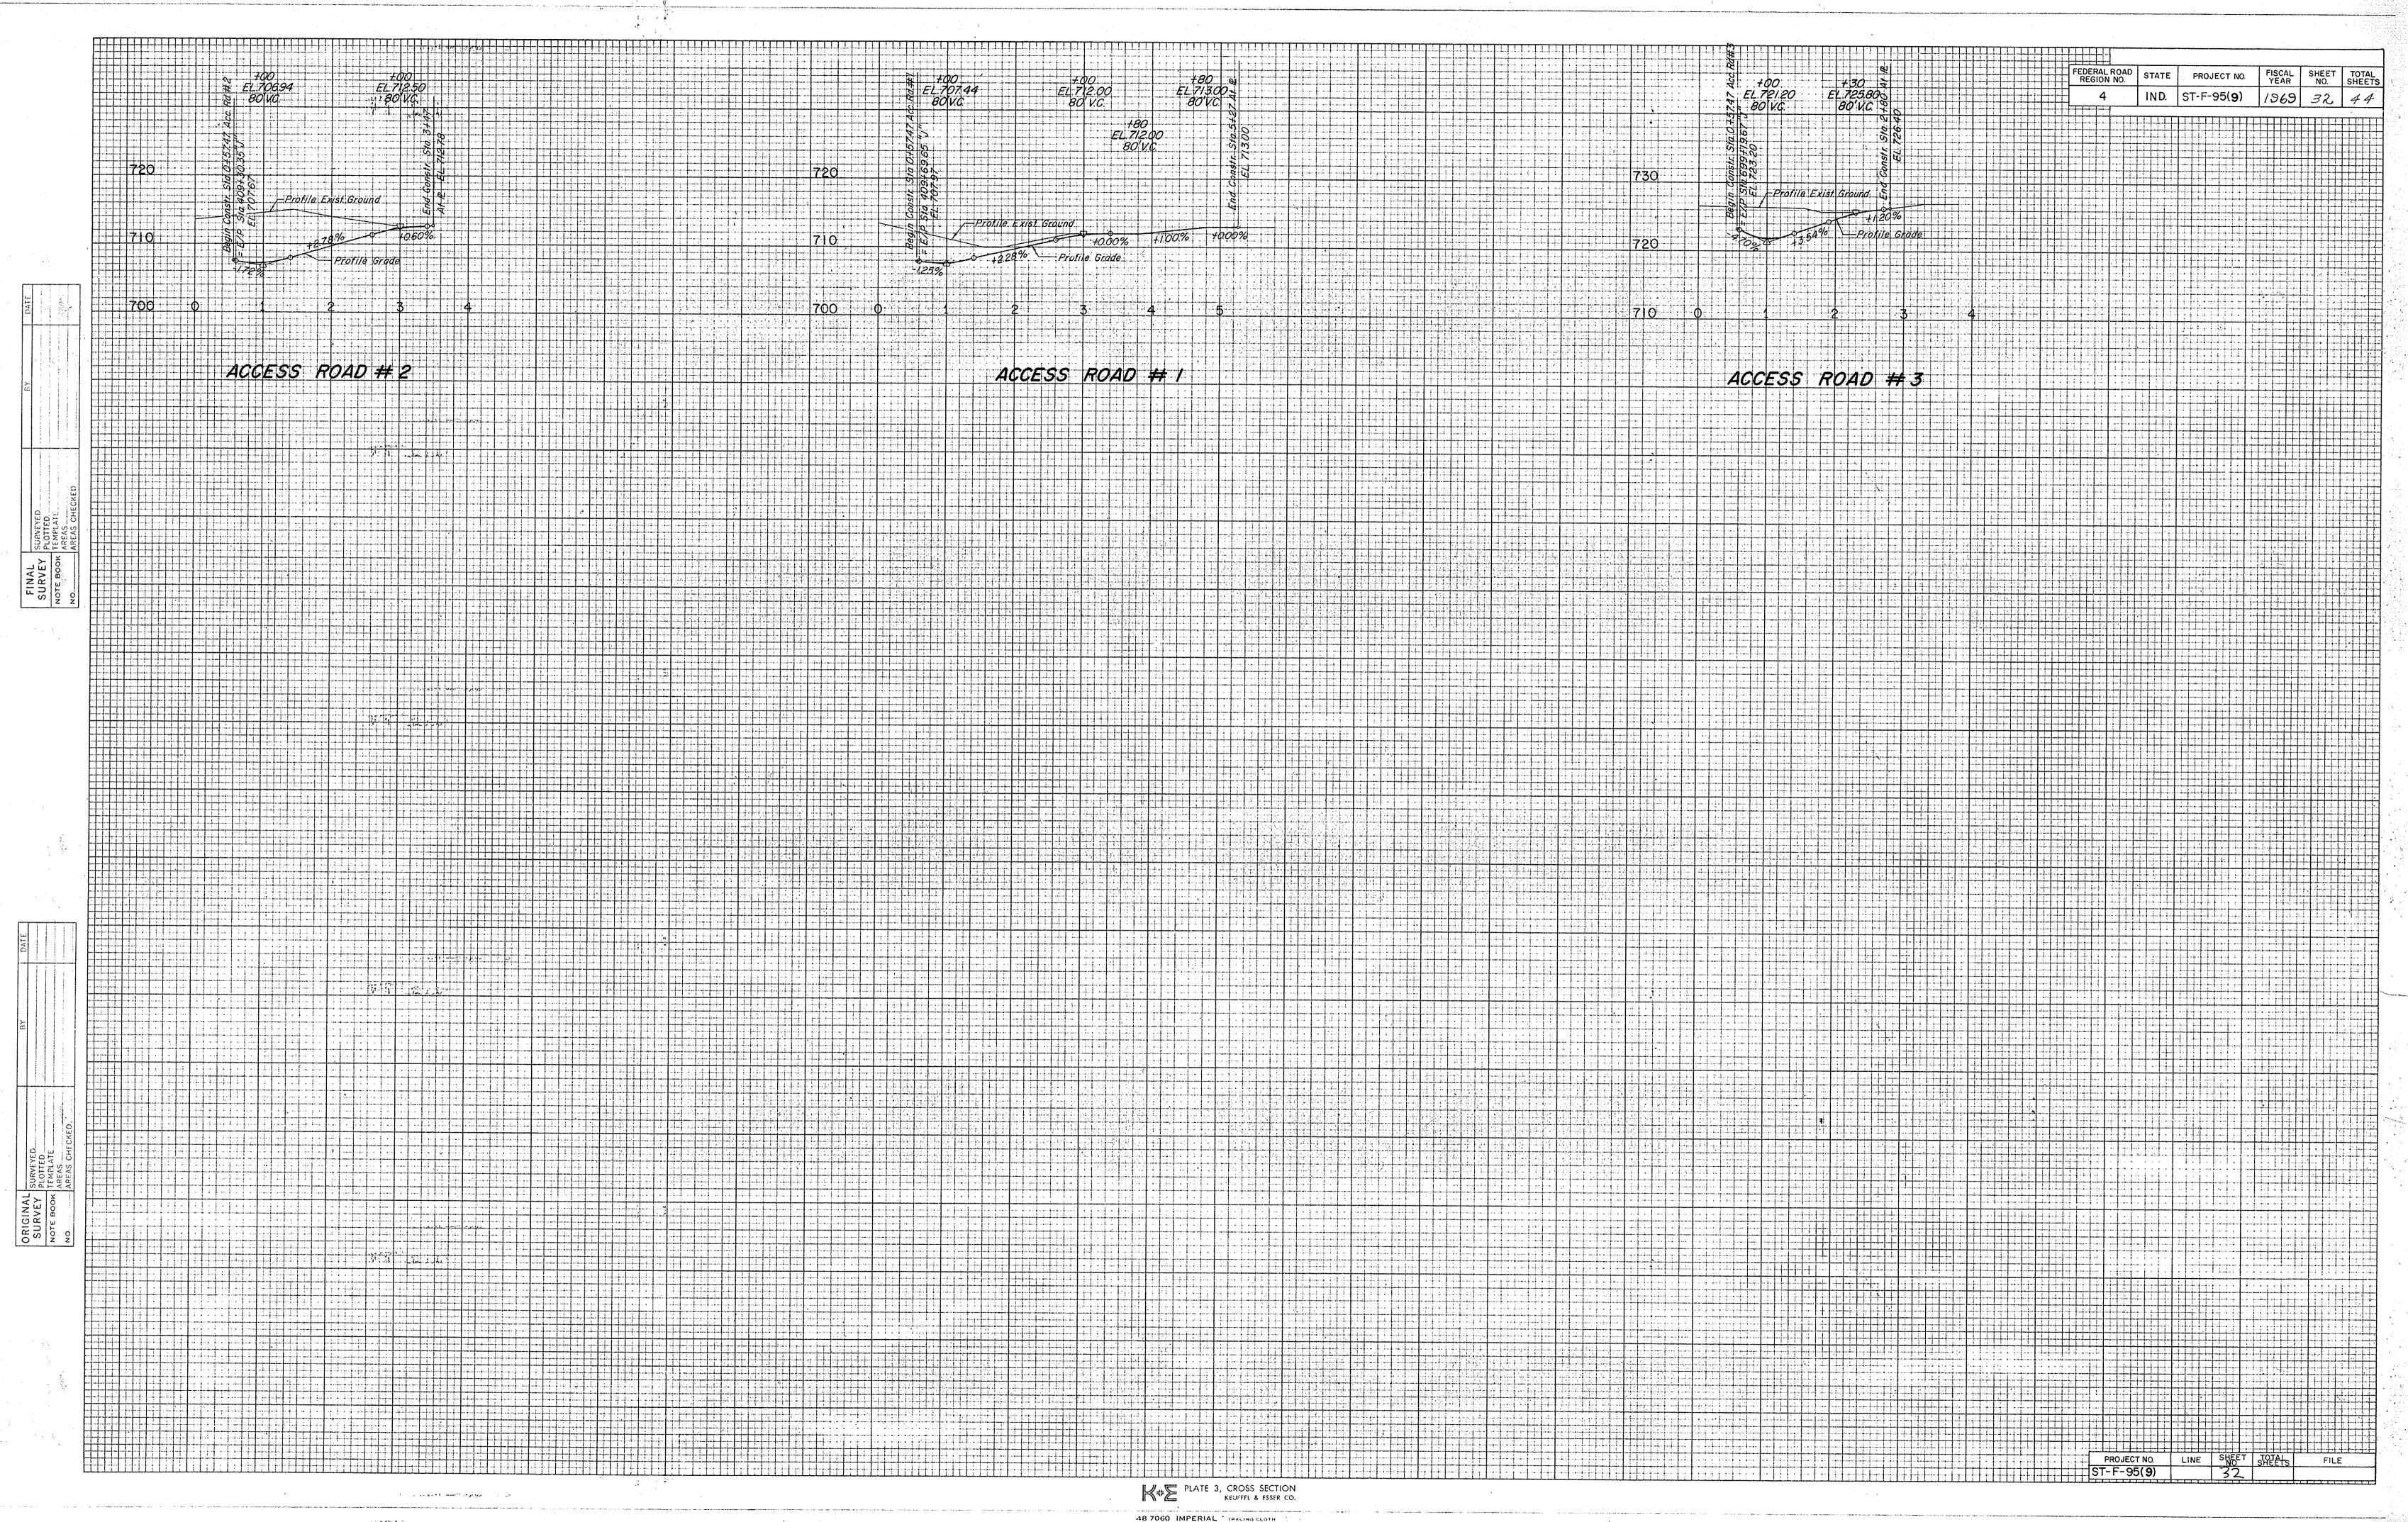


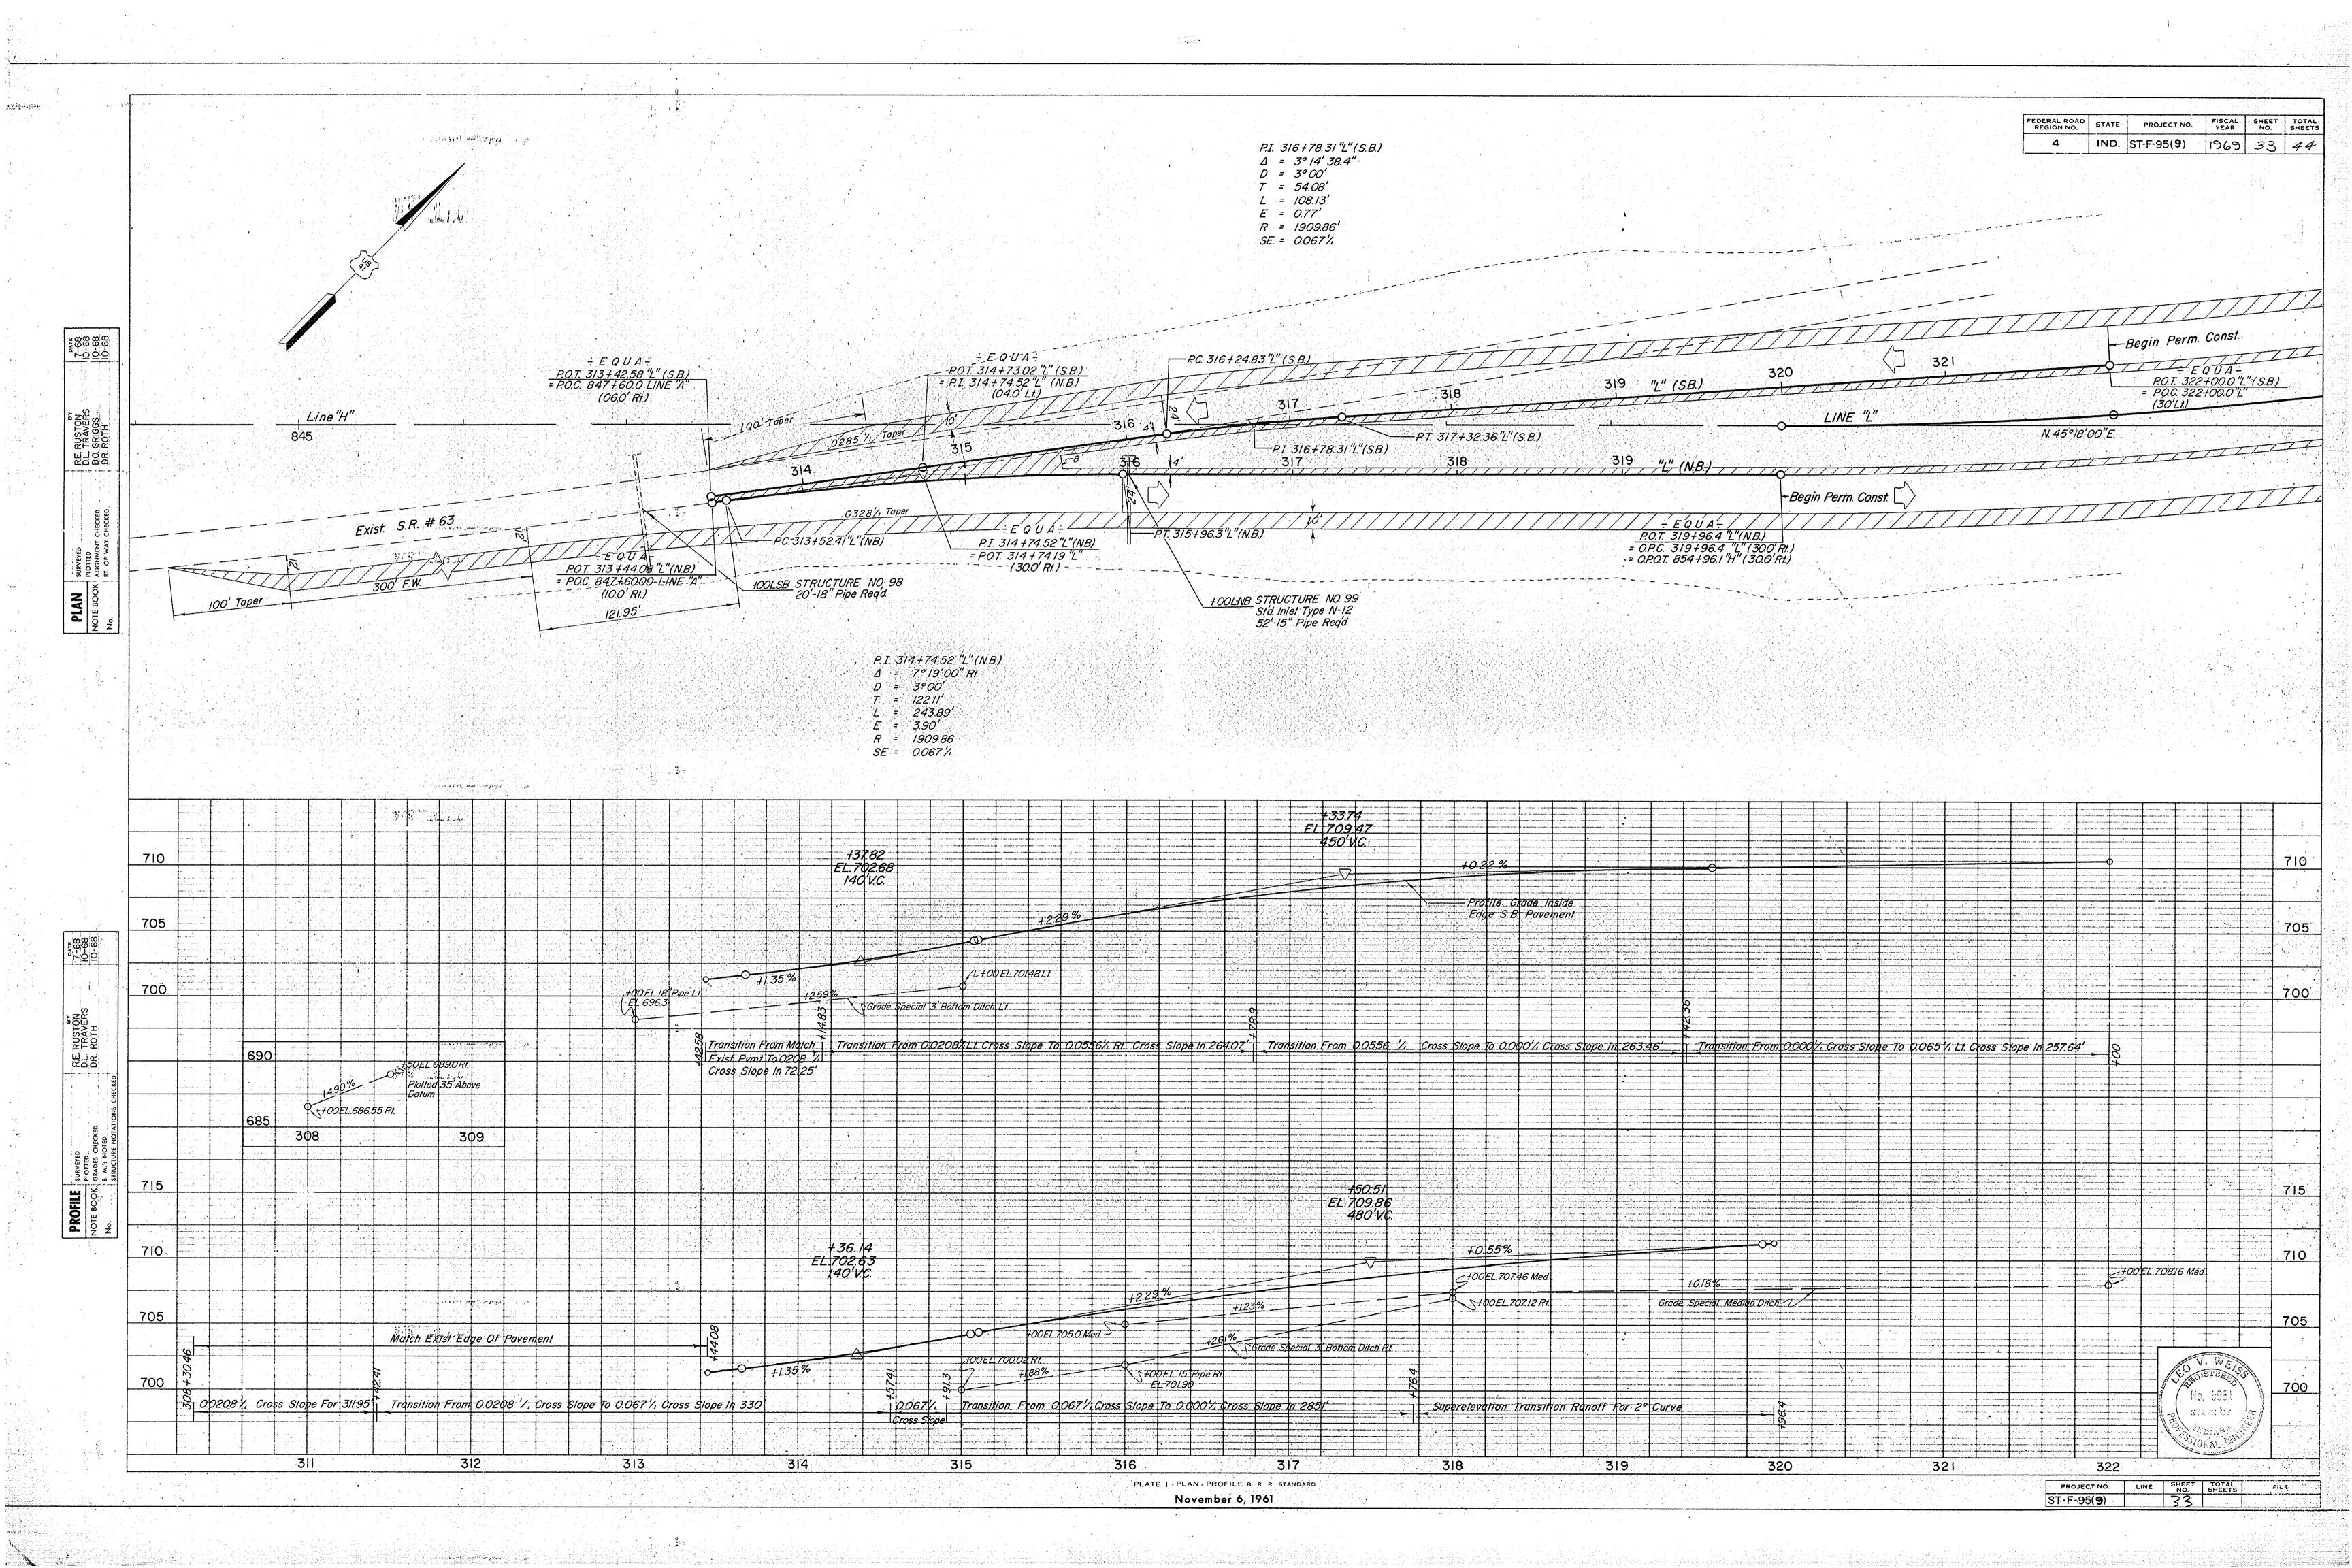


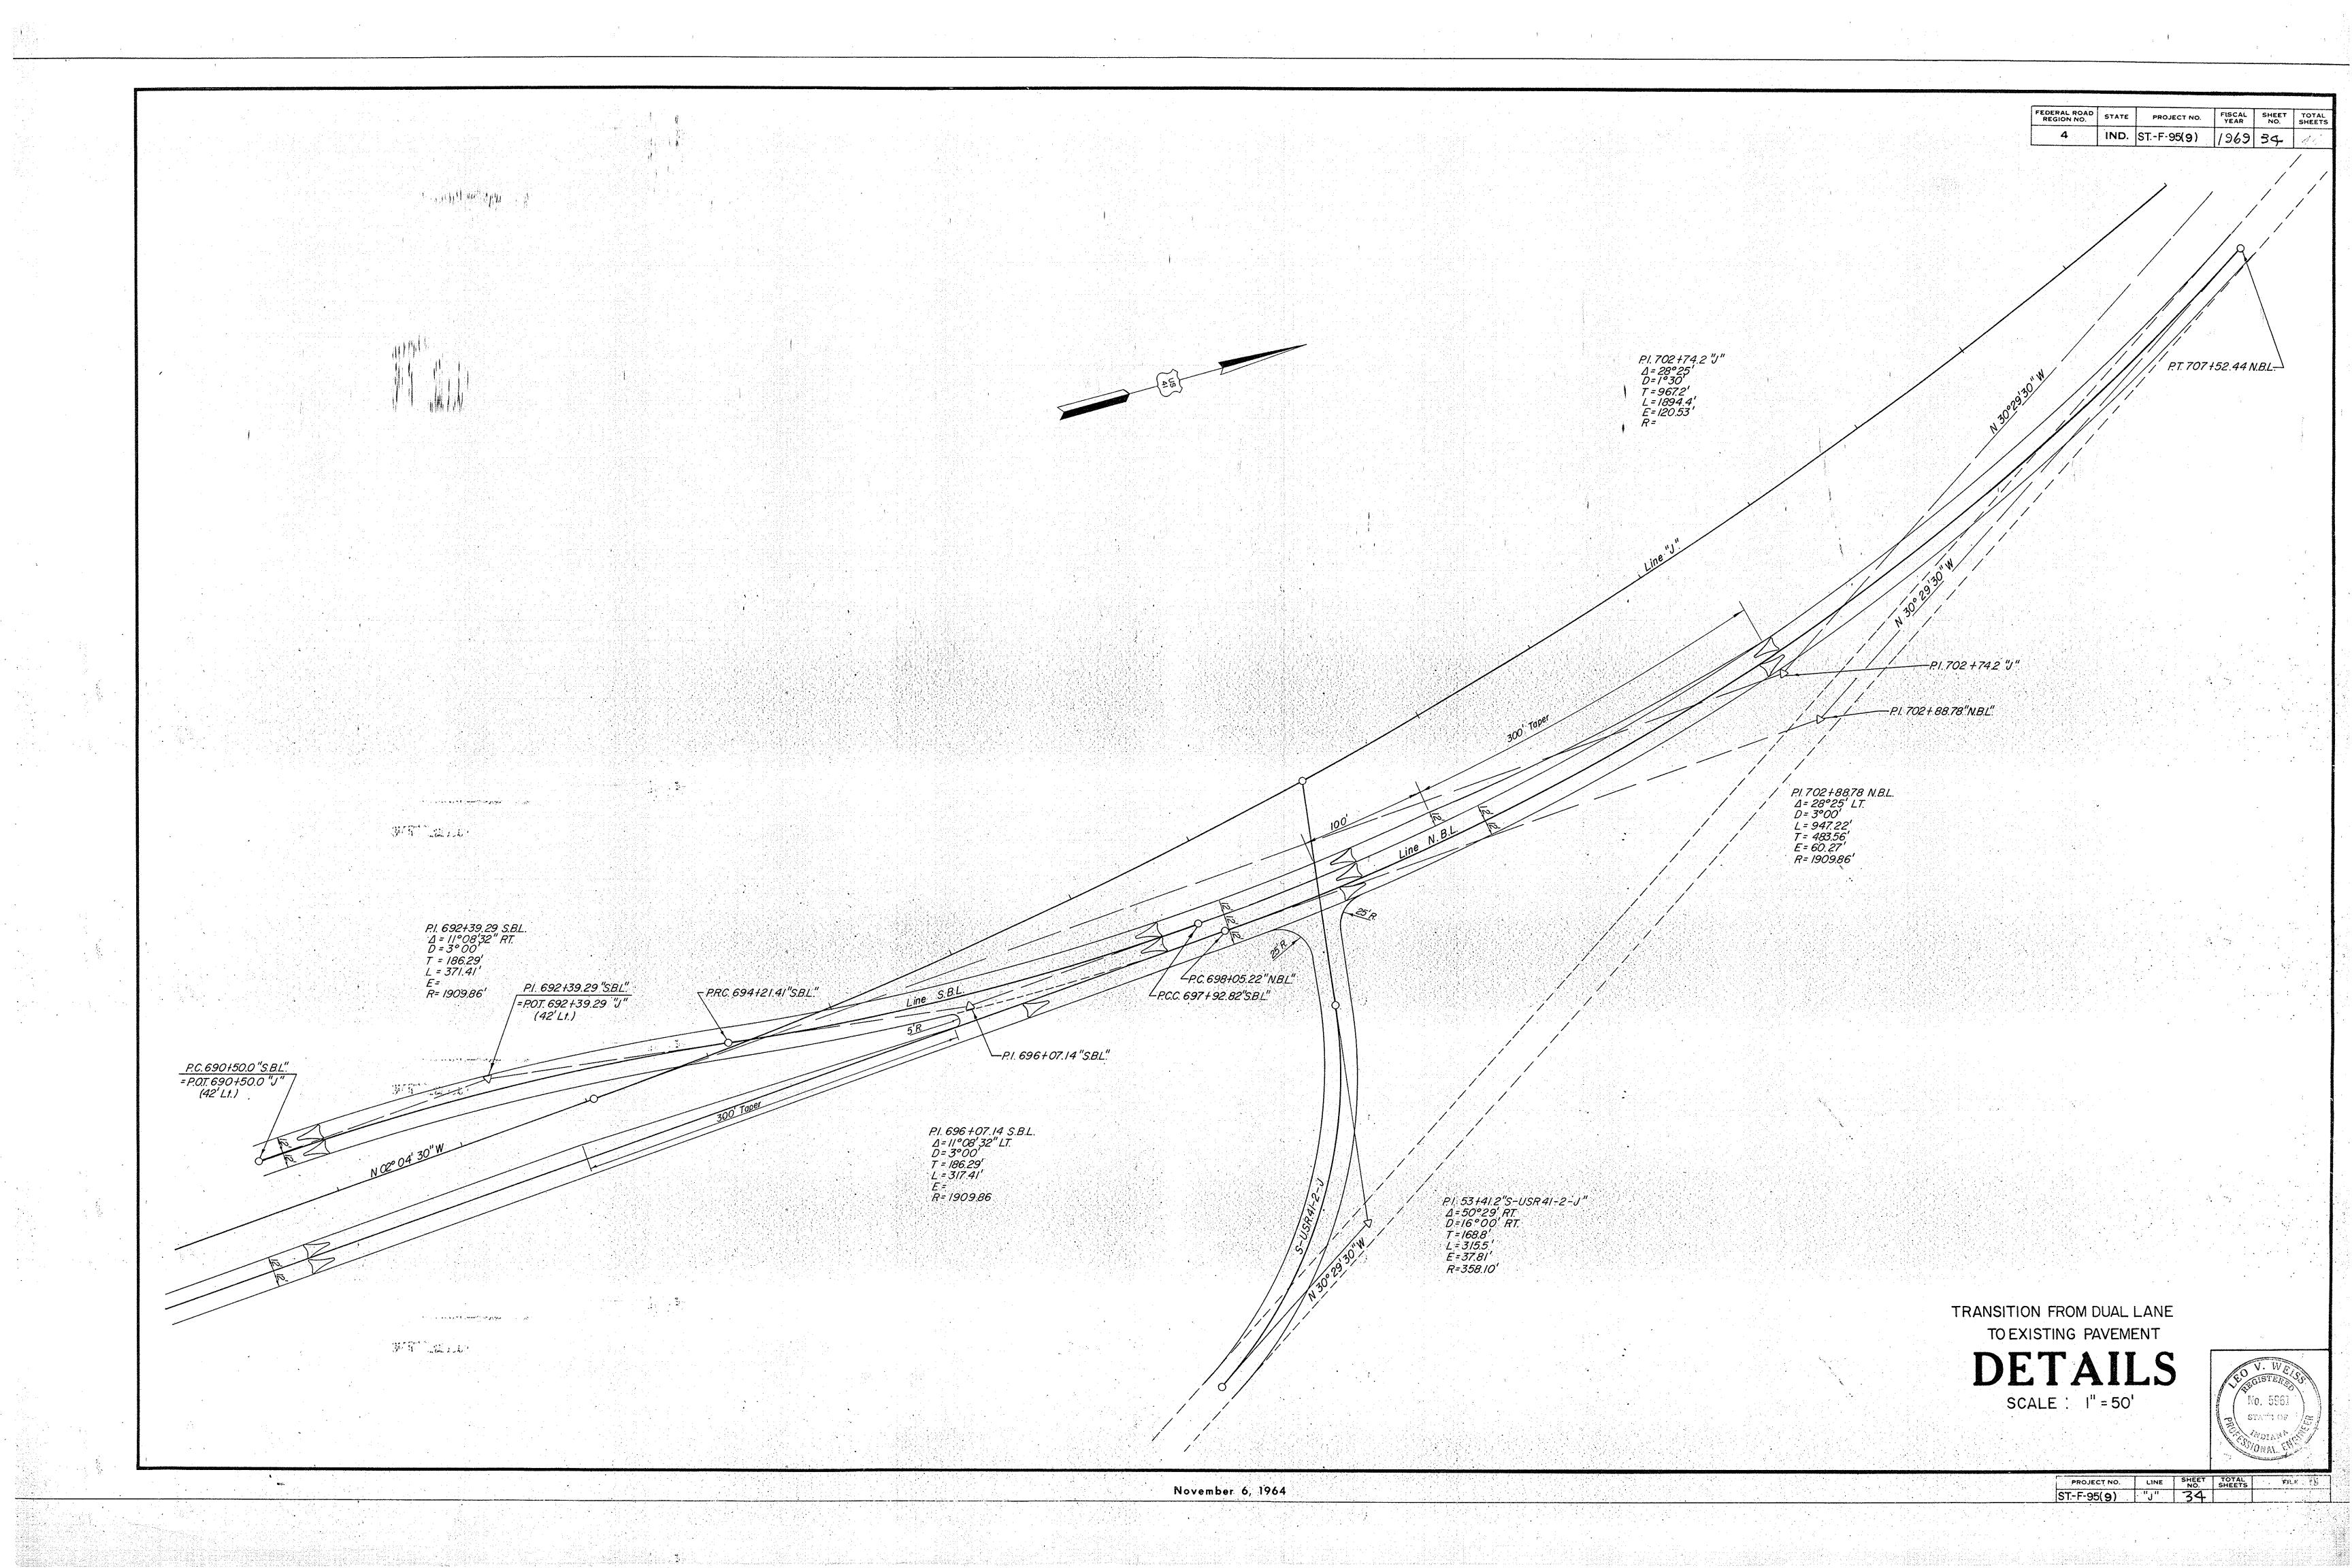

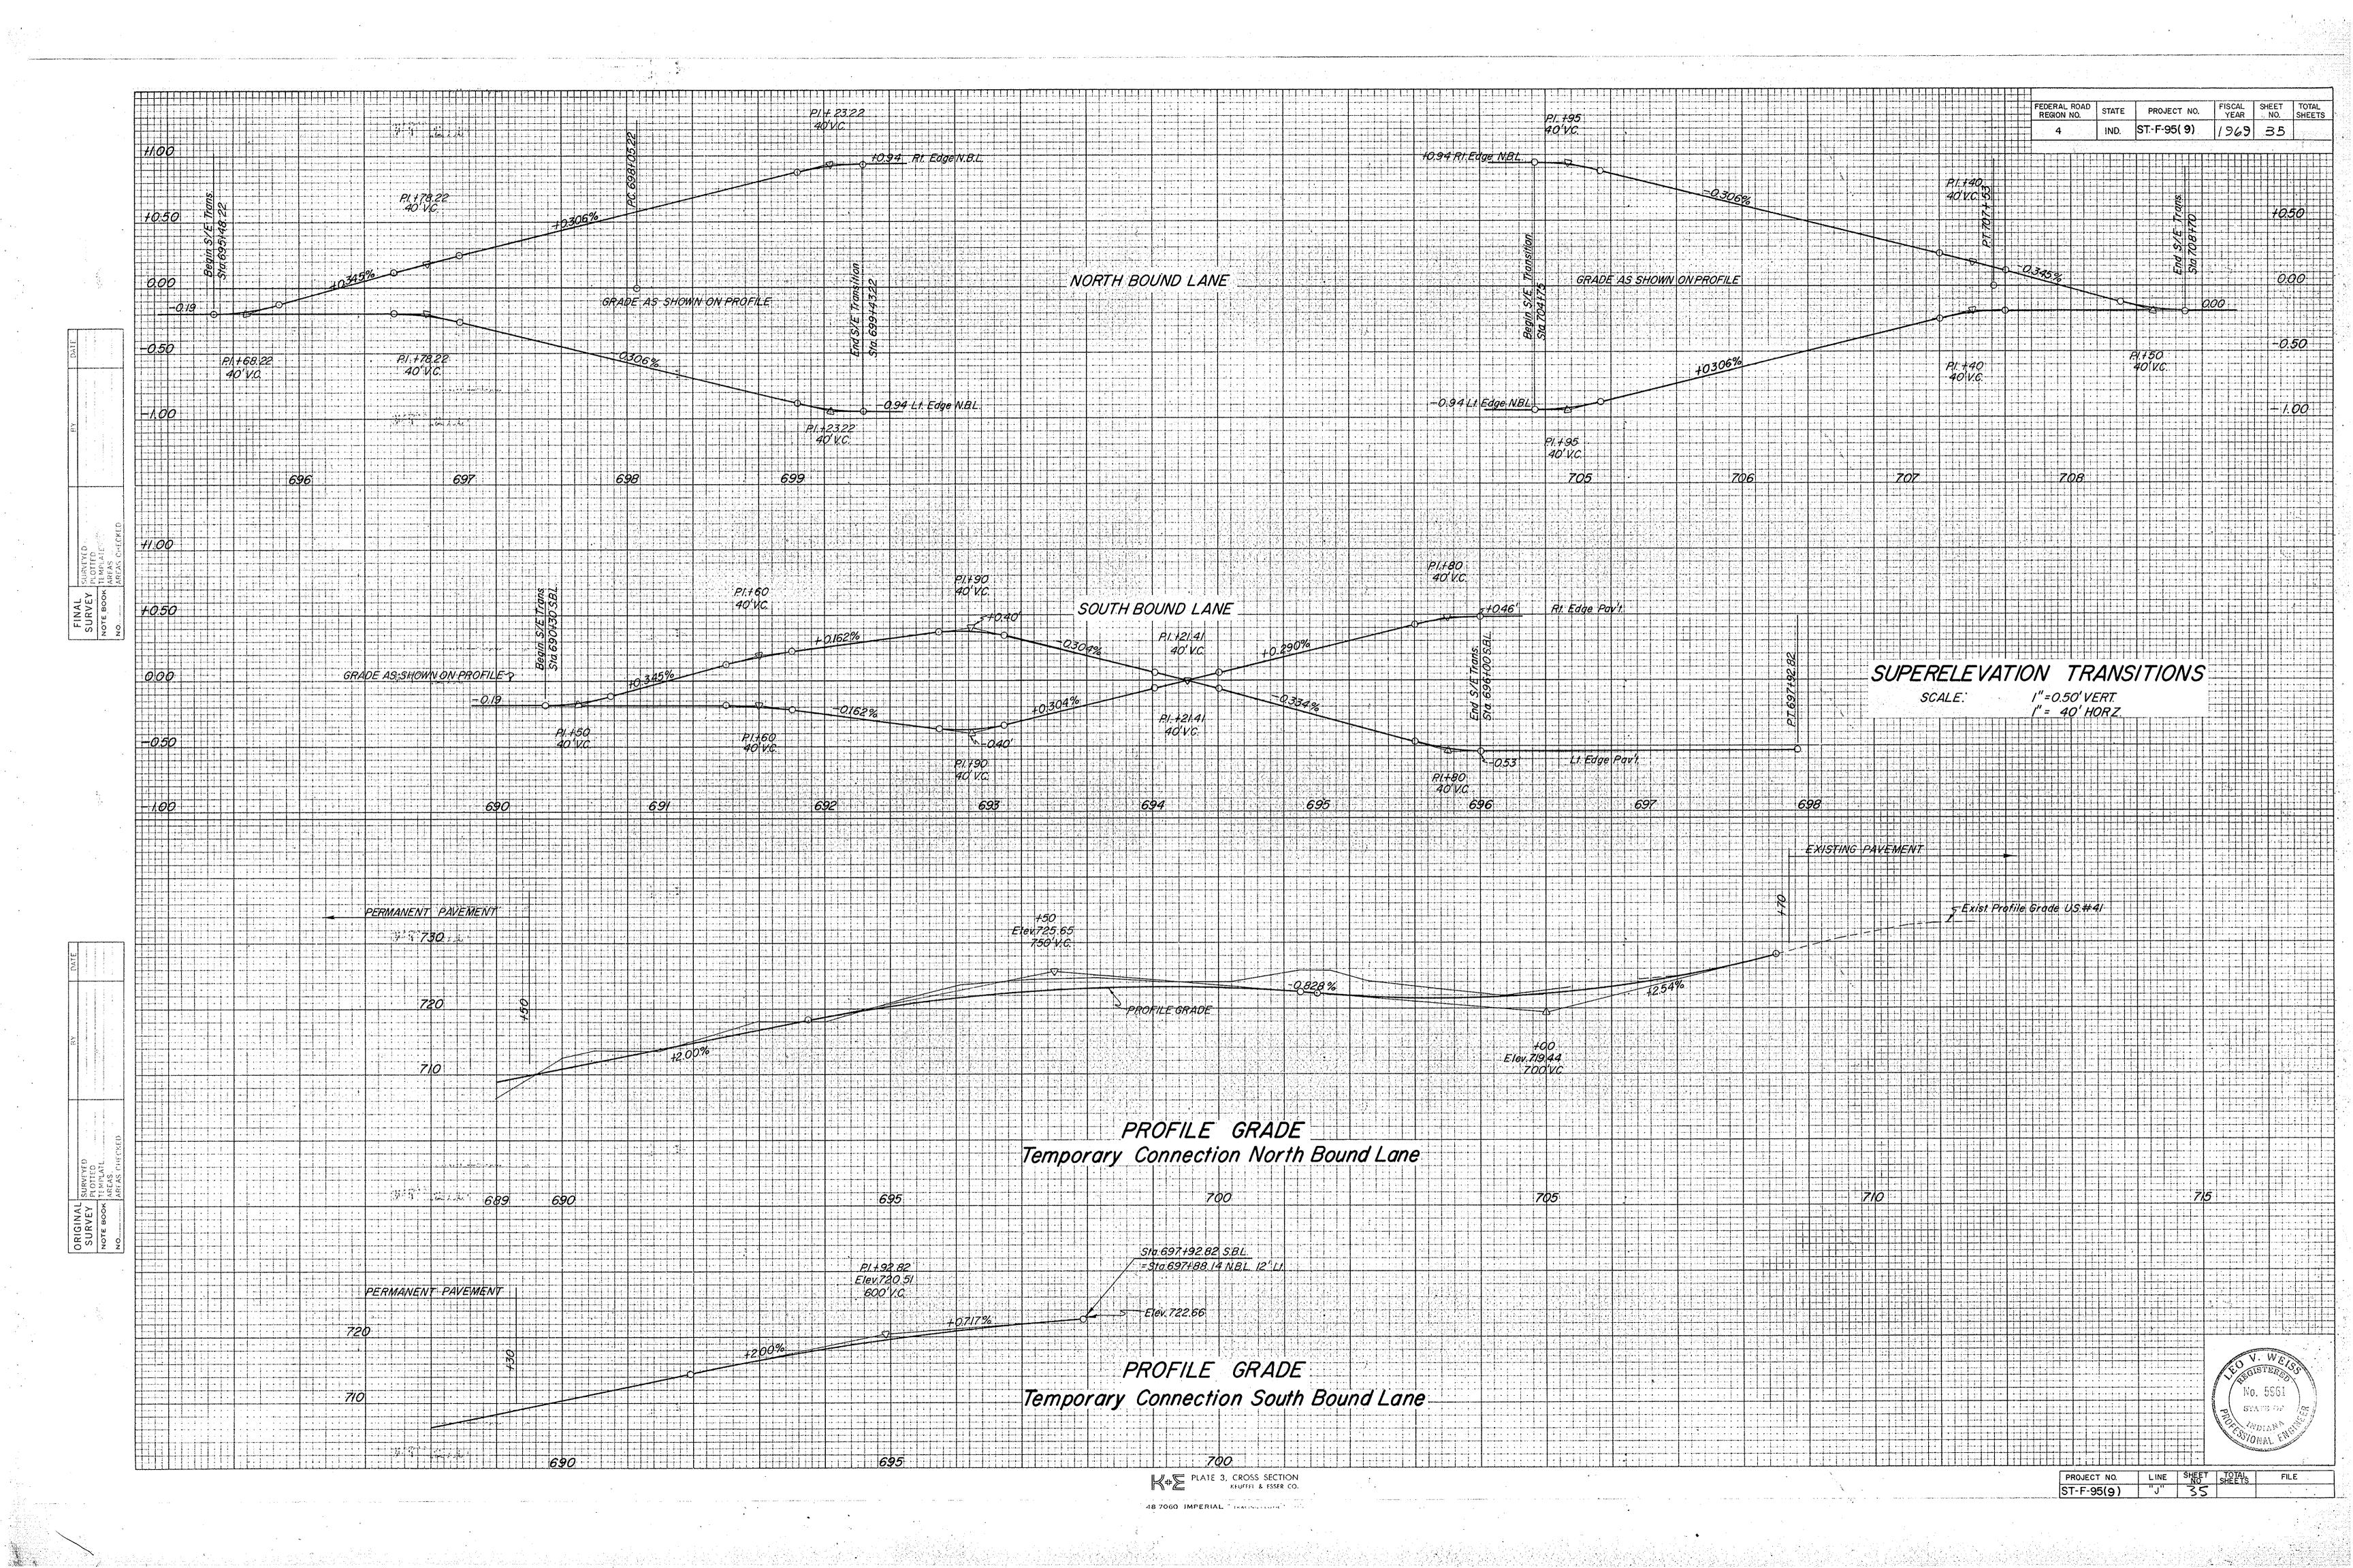


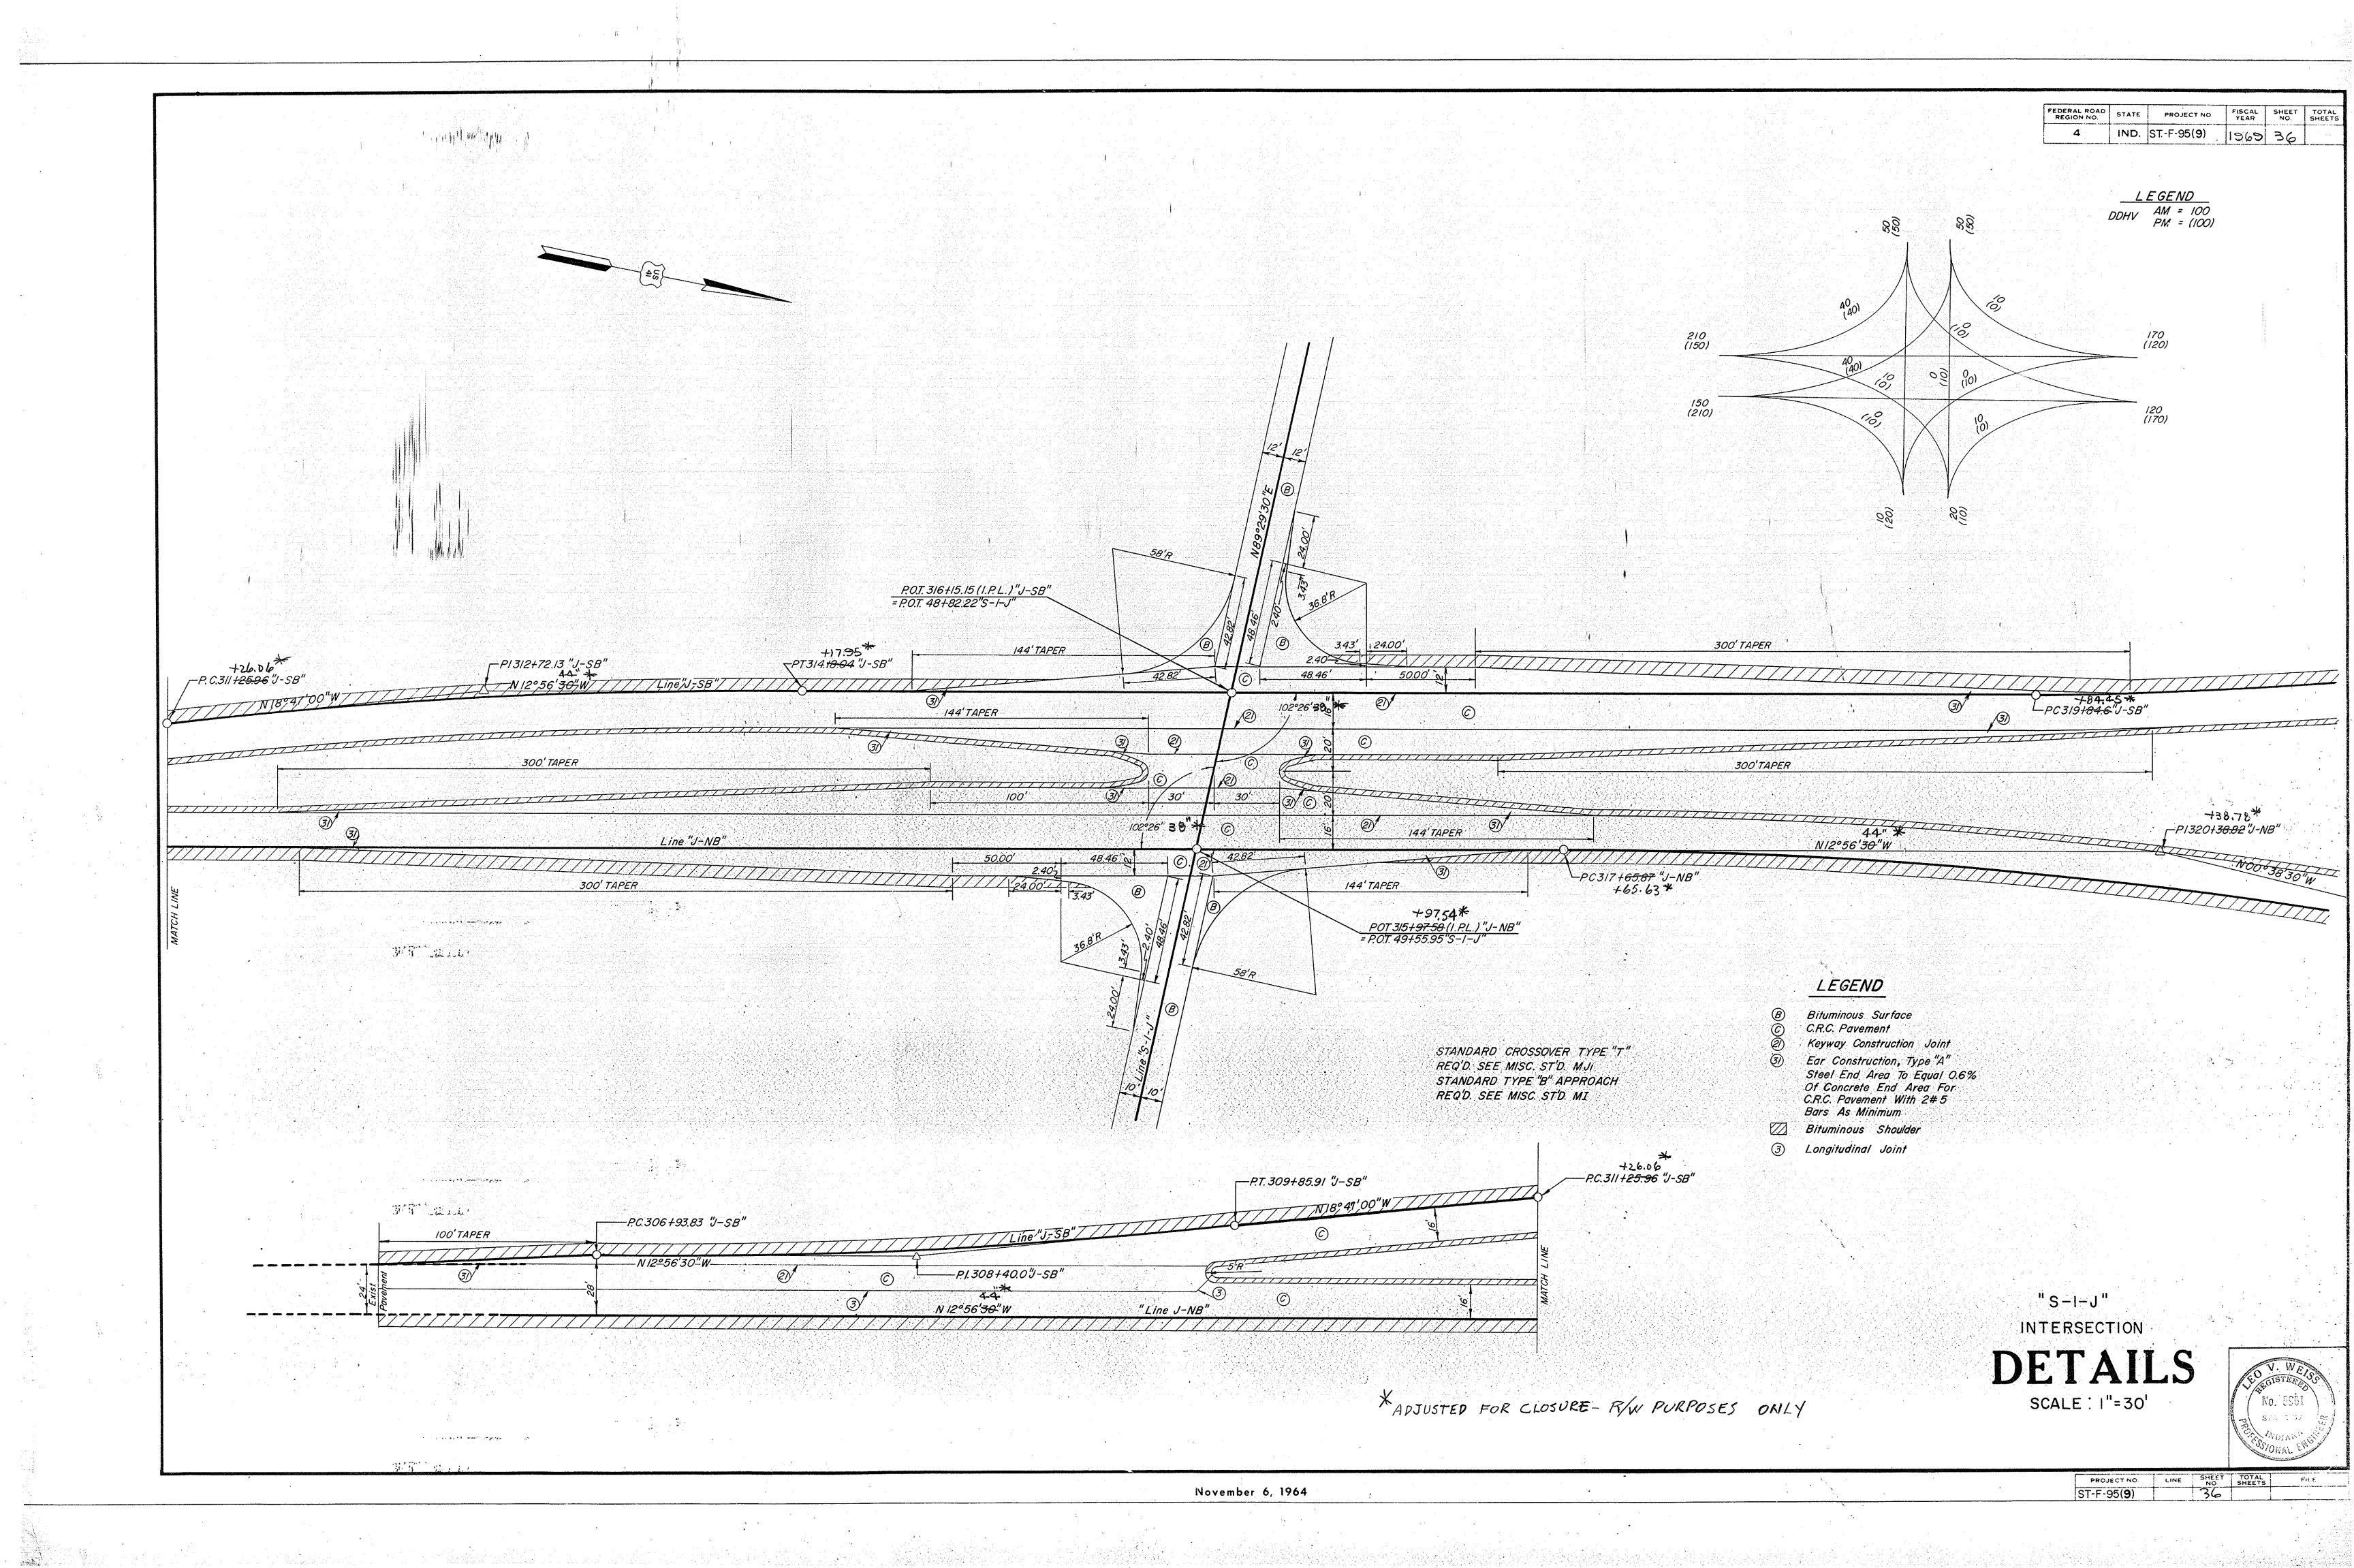

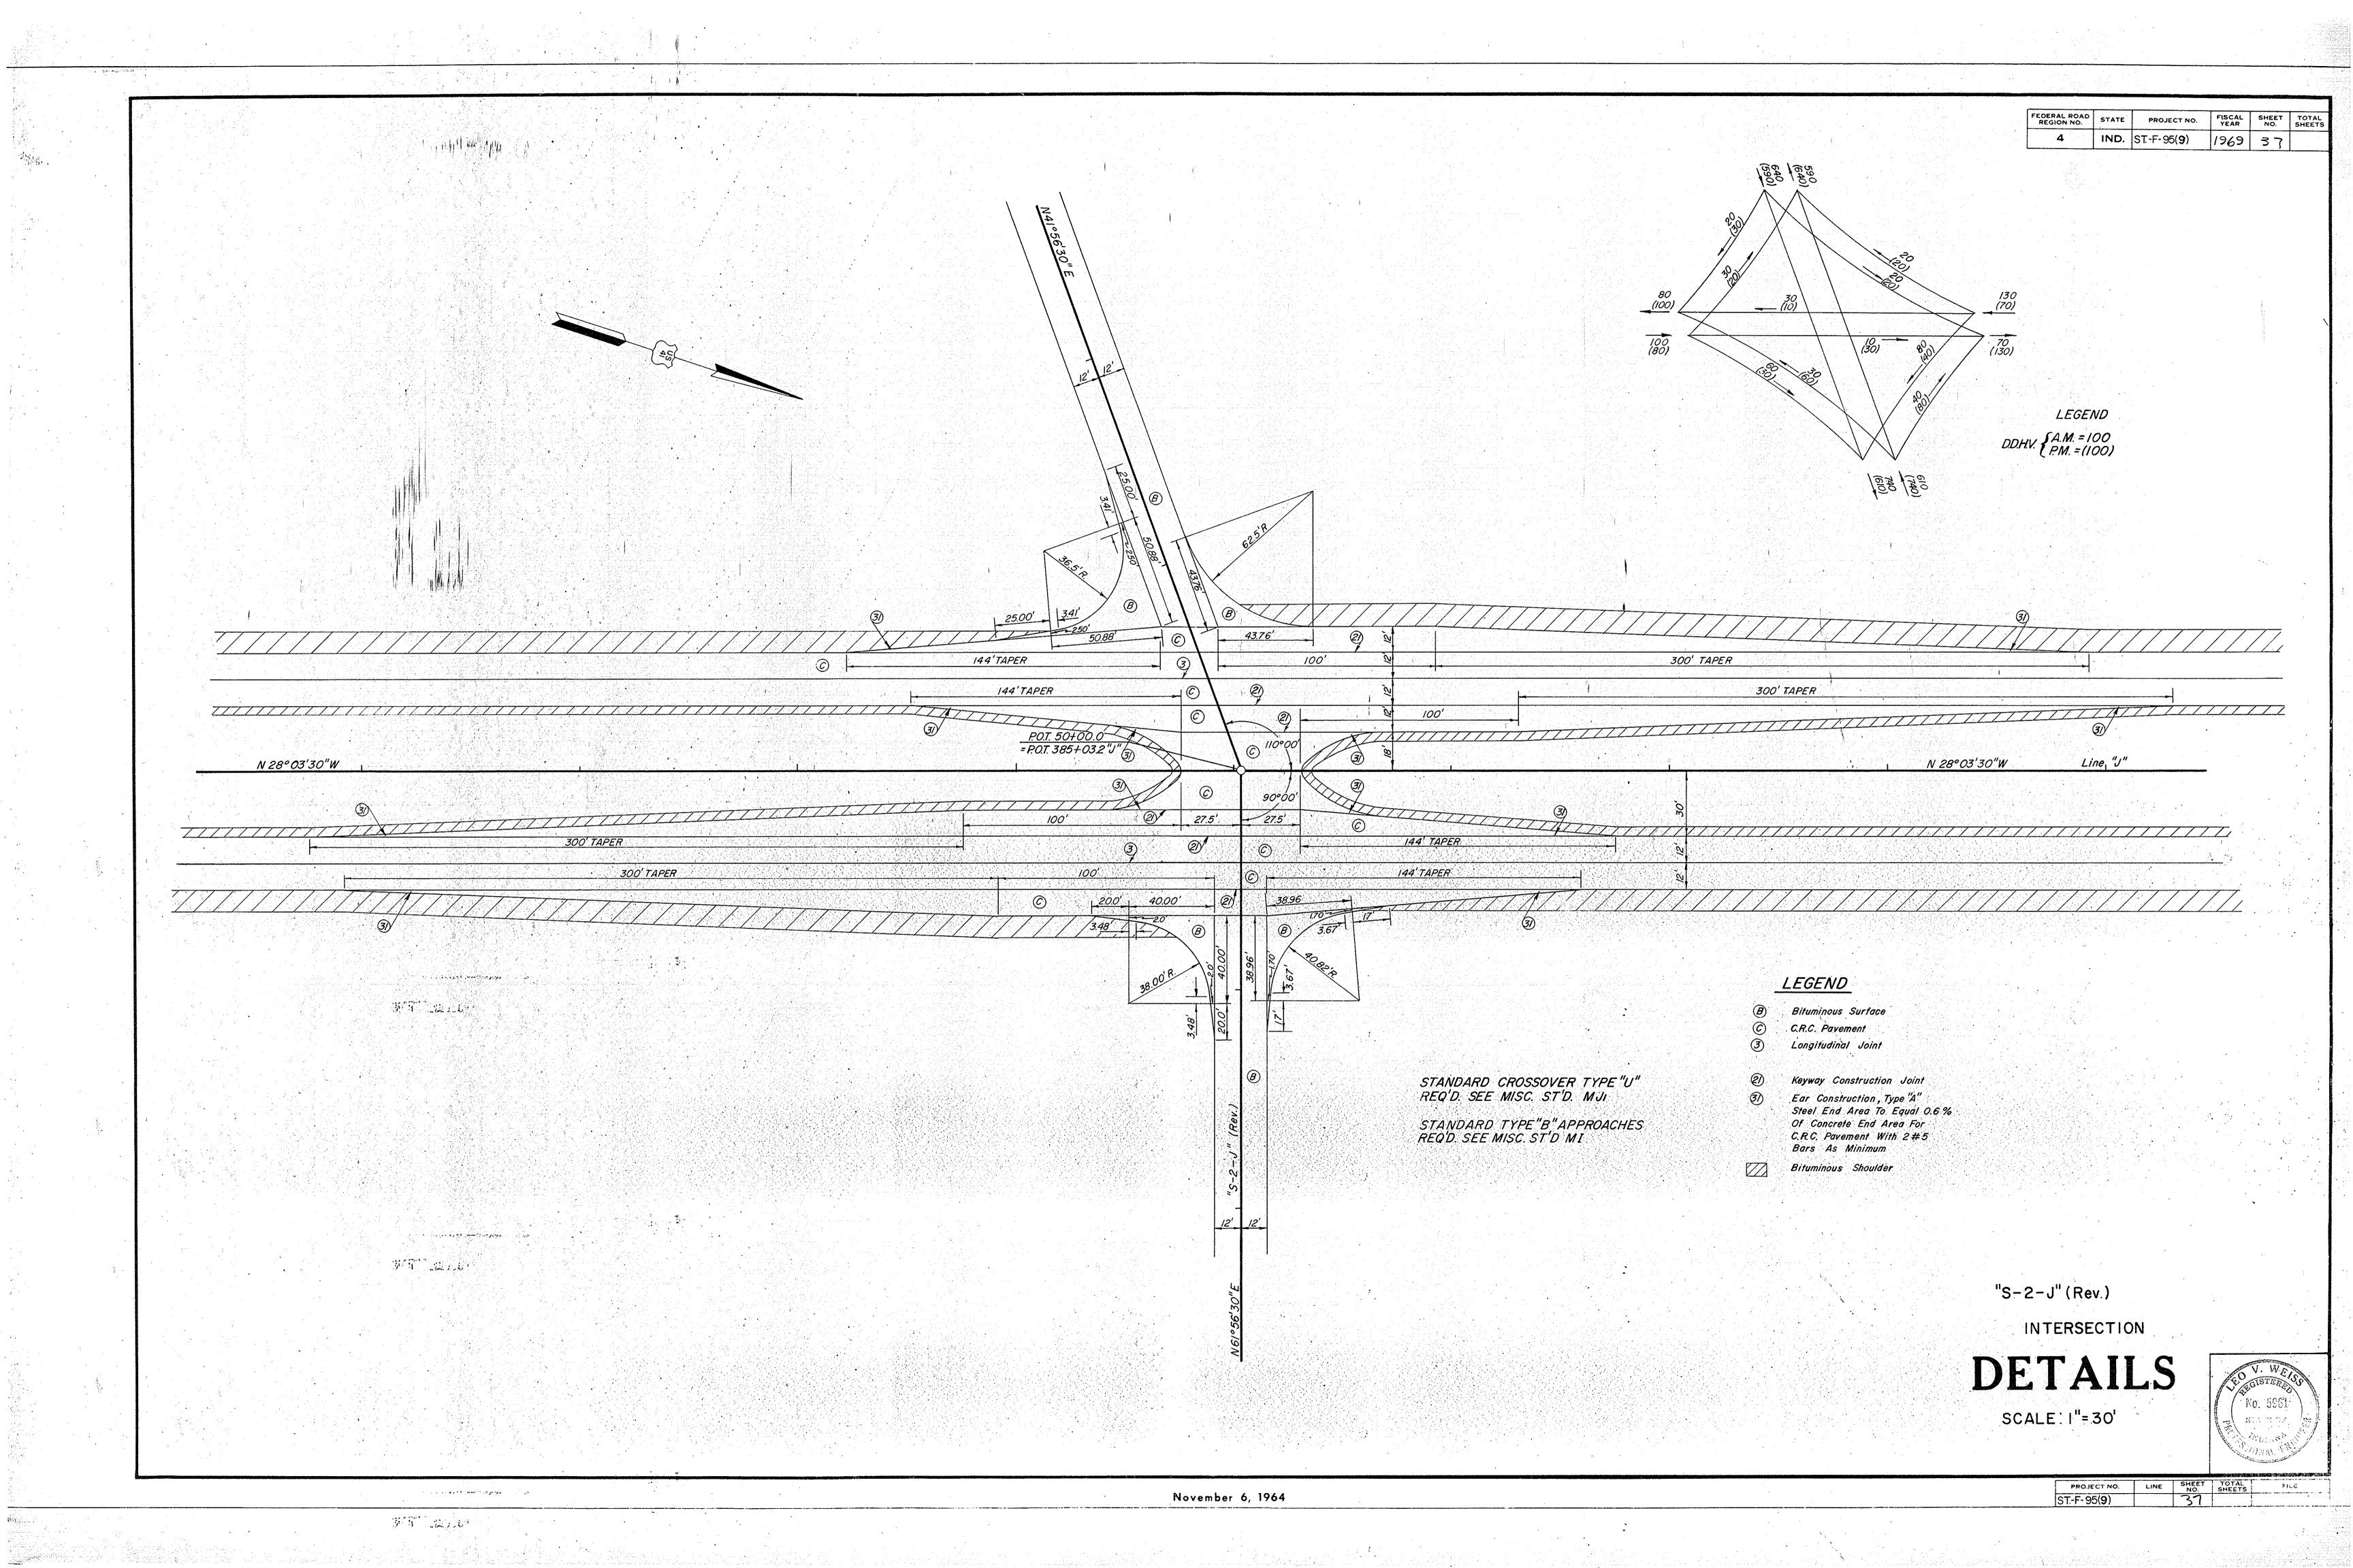

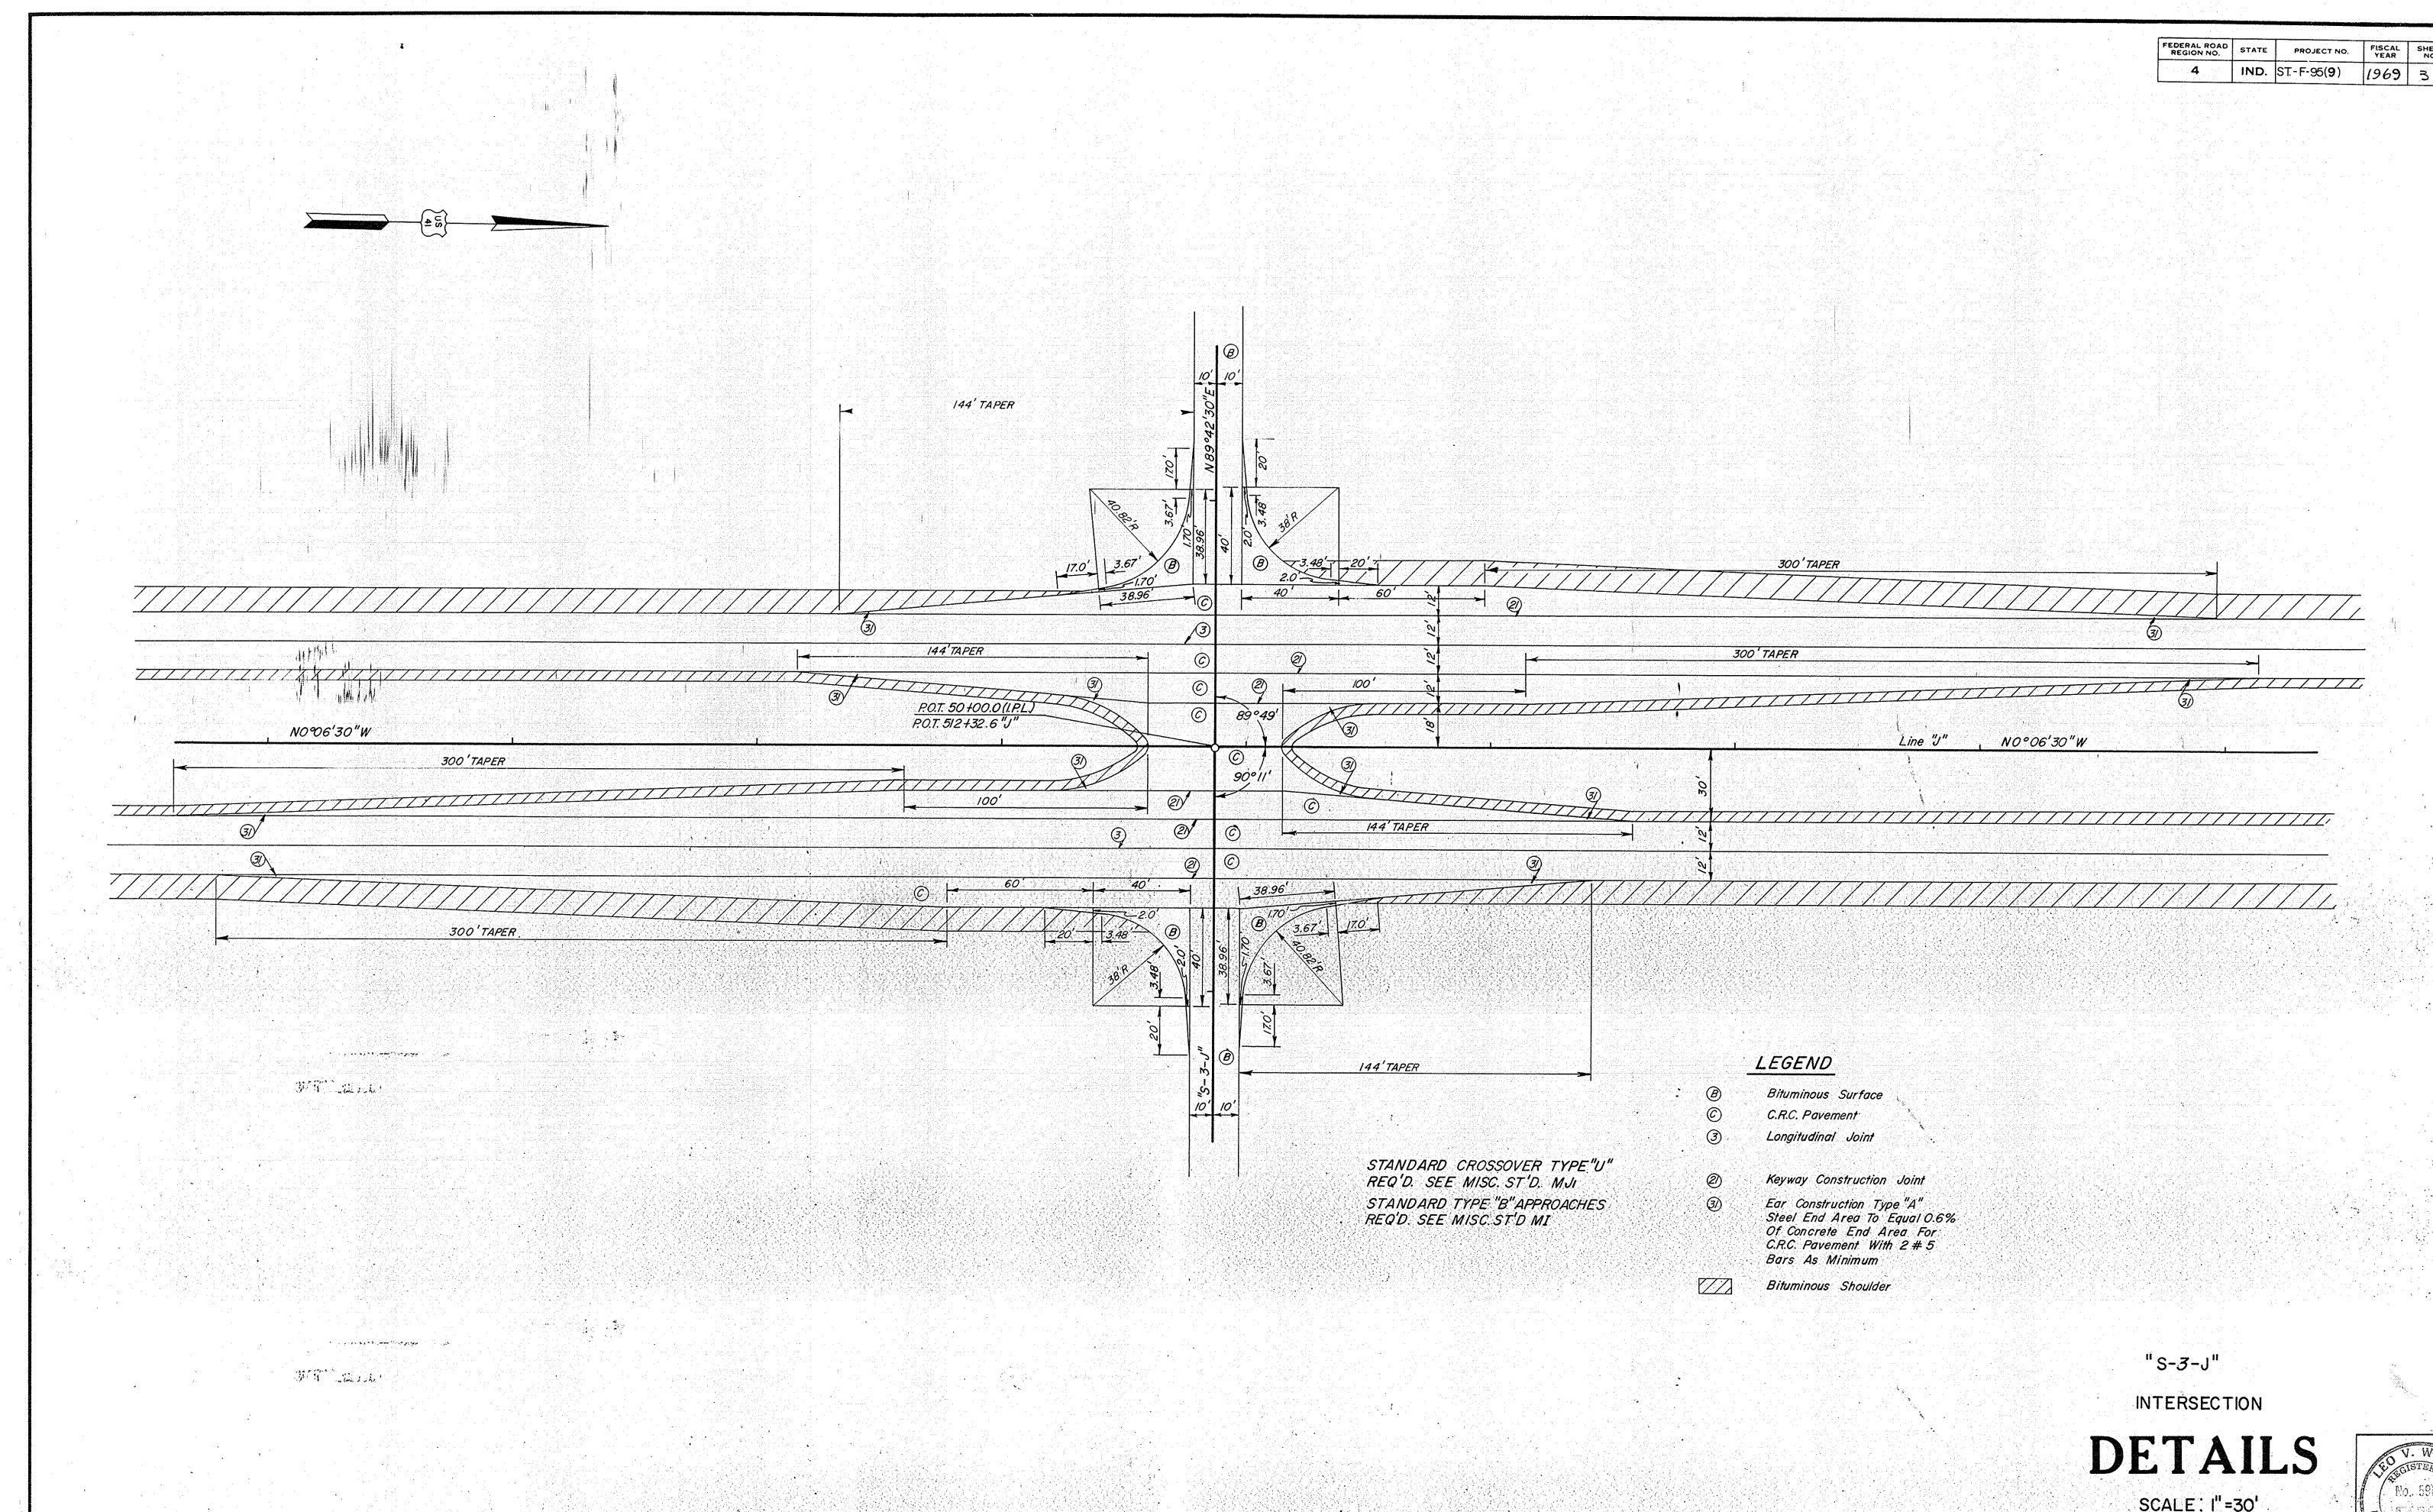


SCALE: 1"=30"

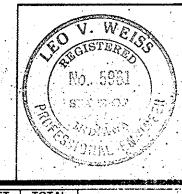

November 6, 1964


PROJECT NO. LINE SHEET TOTAL FILE
ST.-F-95(9) 38 ST-F-95(9)


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PROJECT NO. LINE SHEET TOTAL FILES
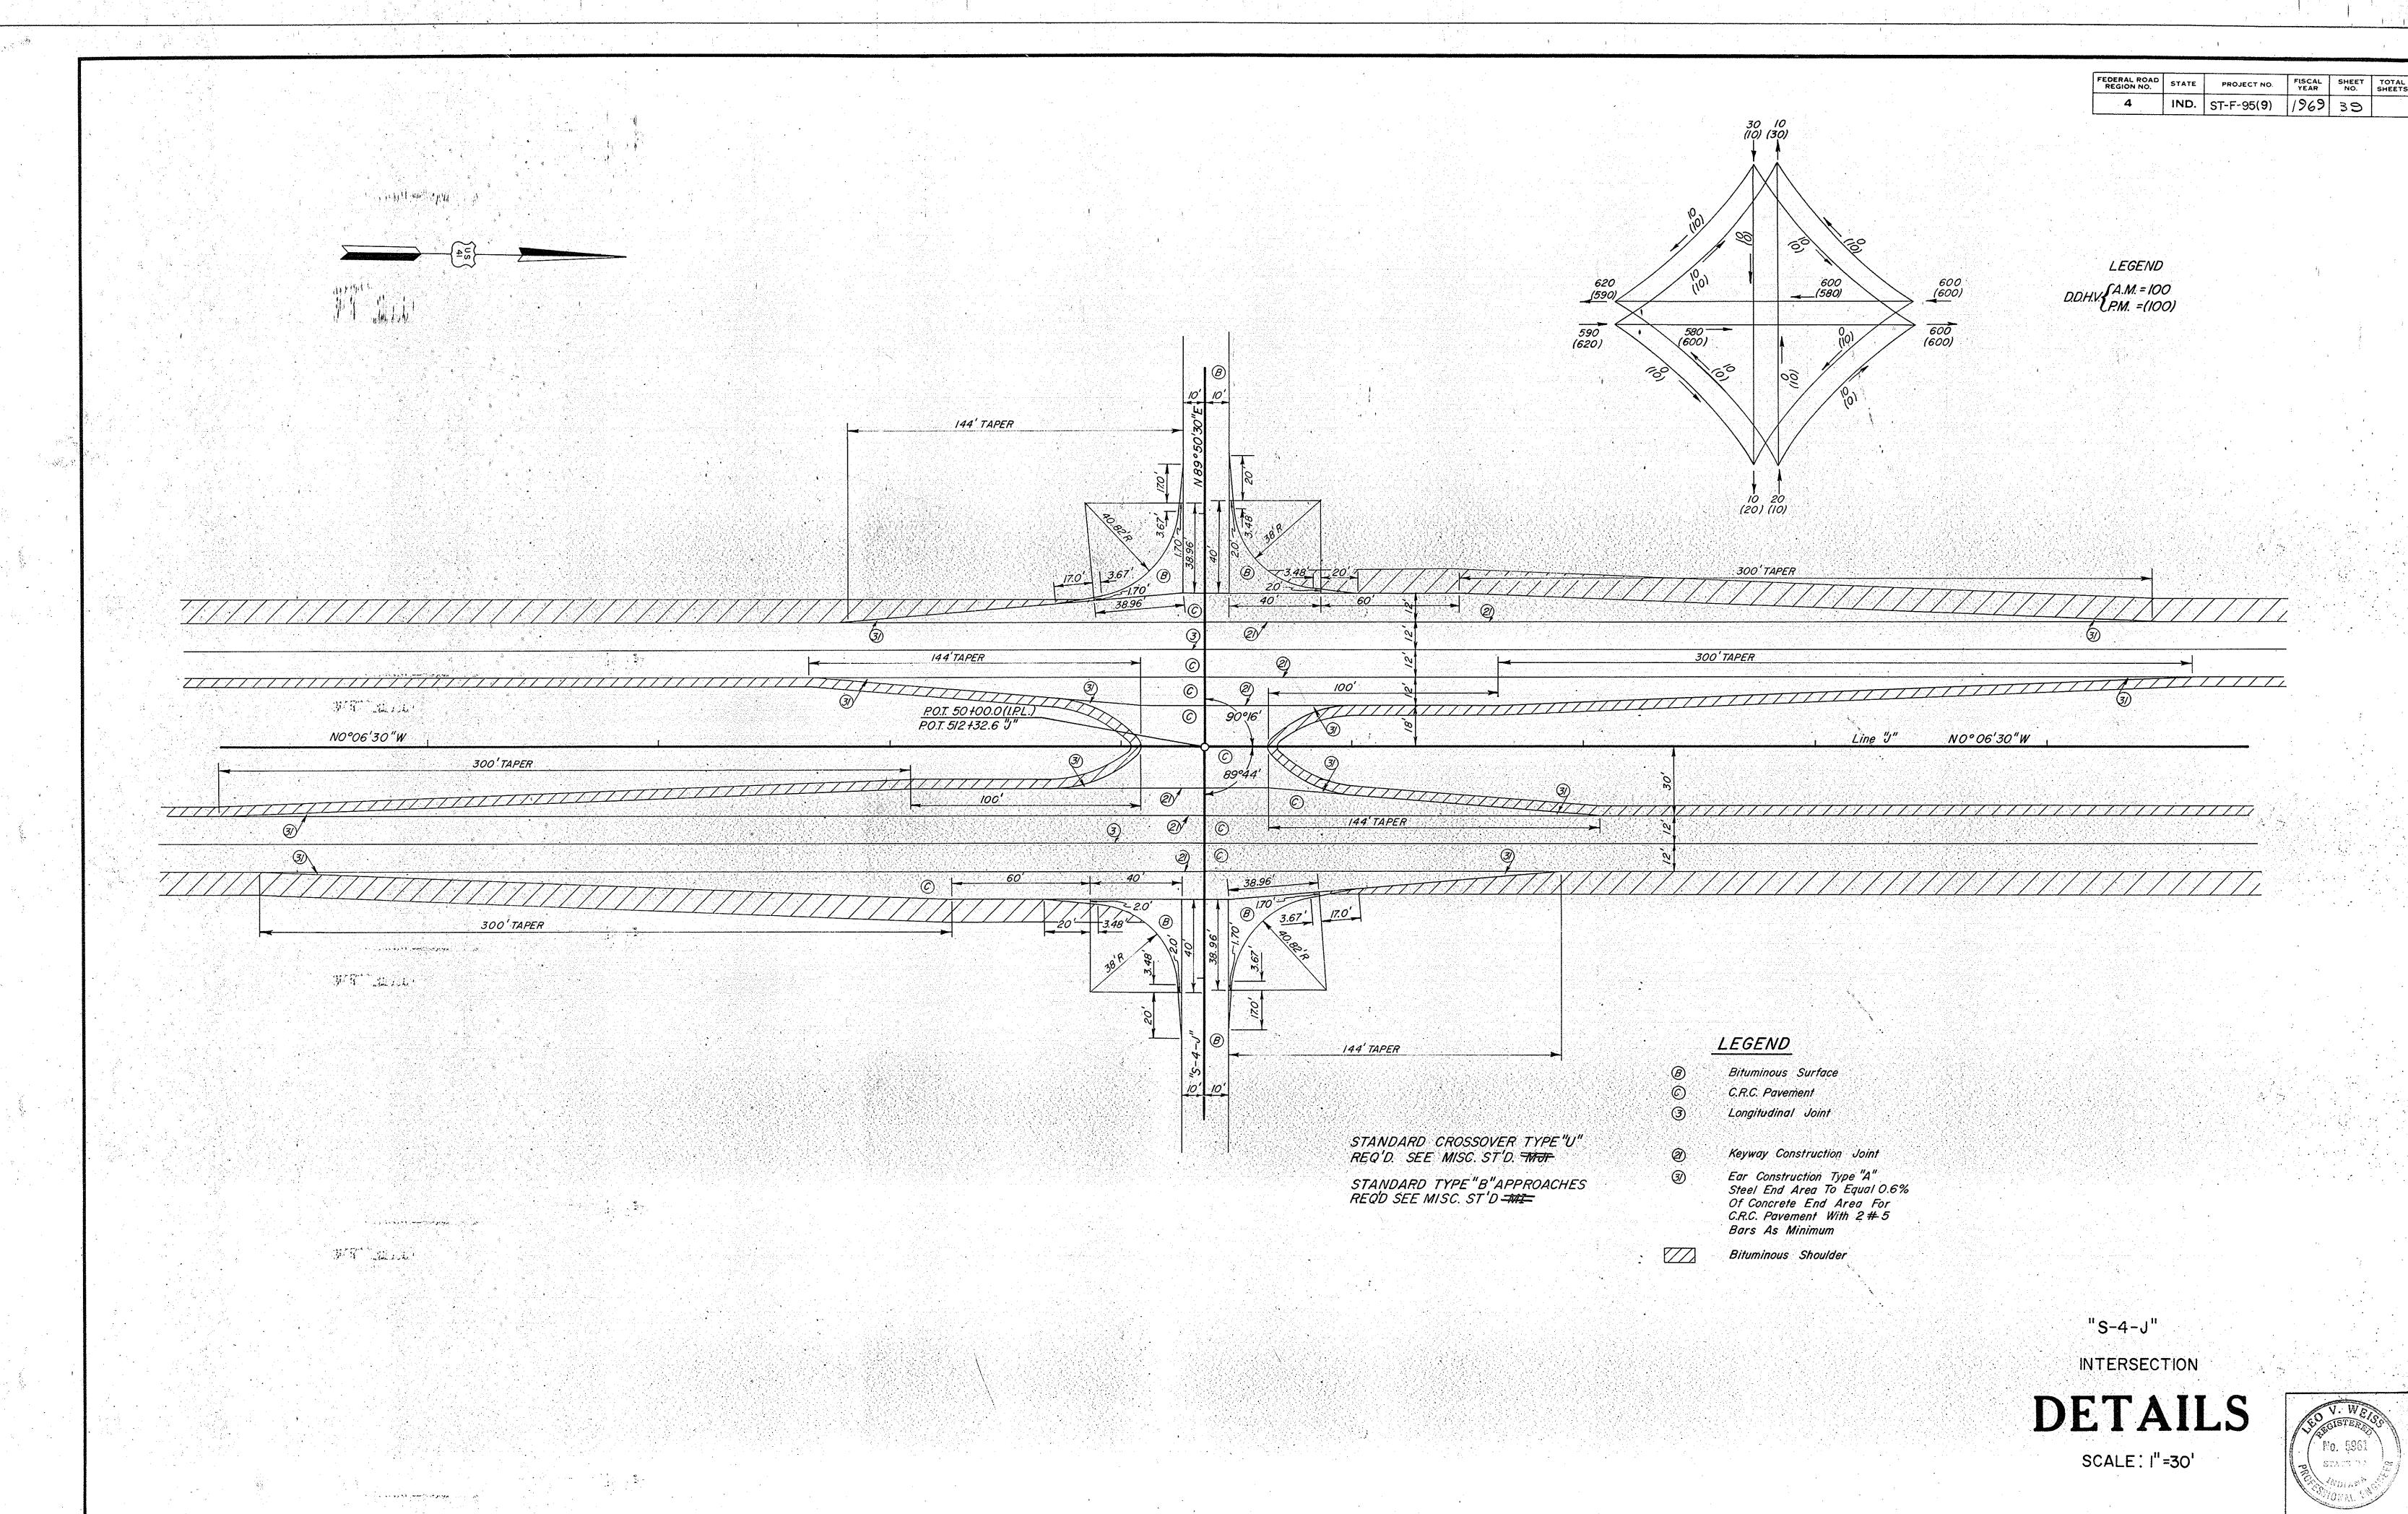
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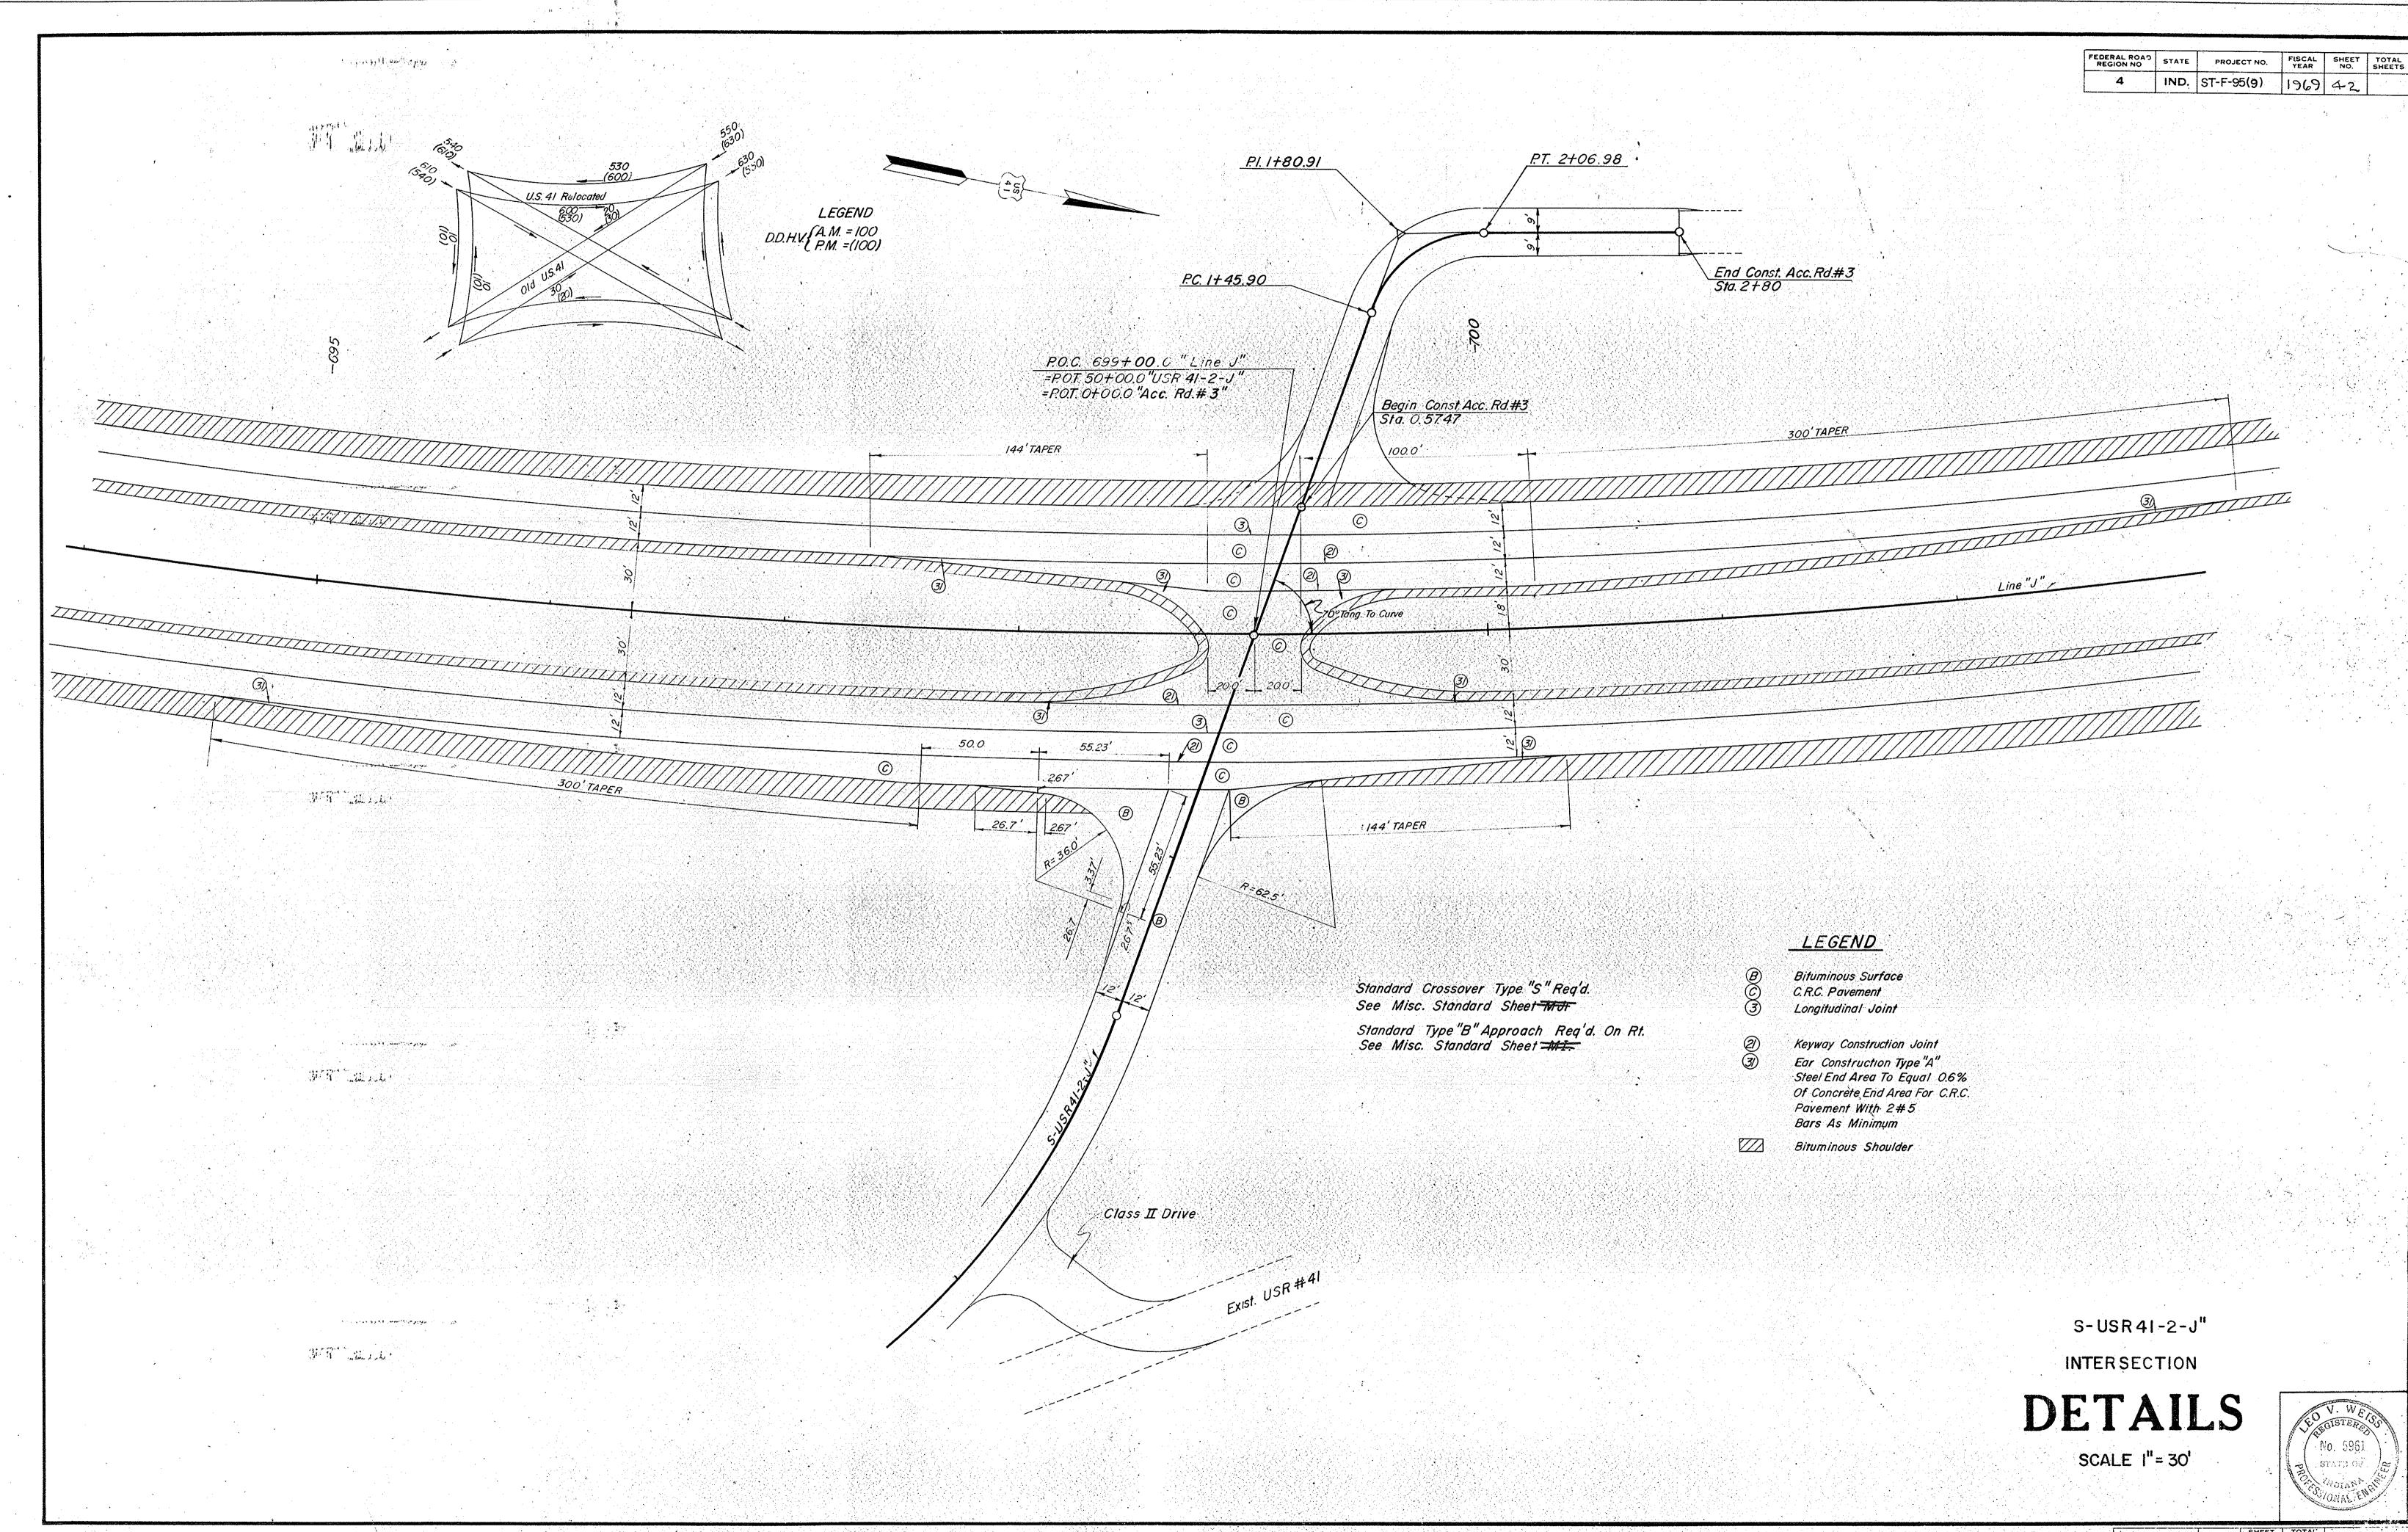




November 6, 1964

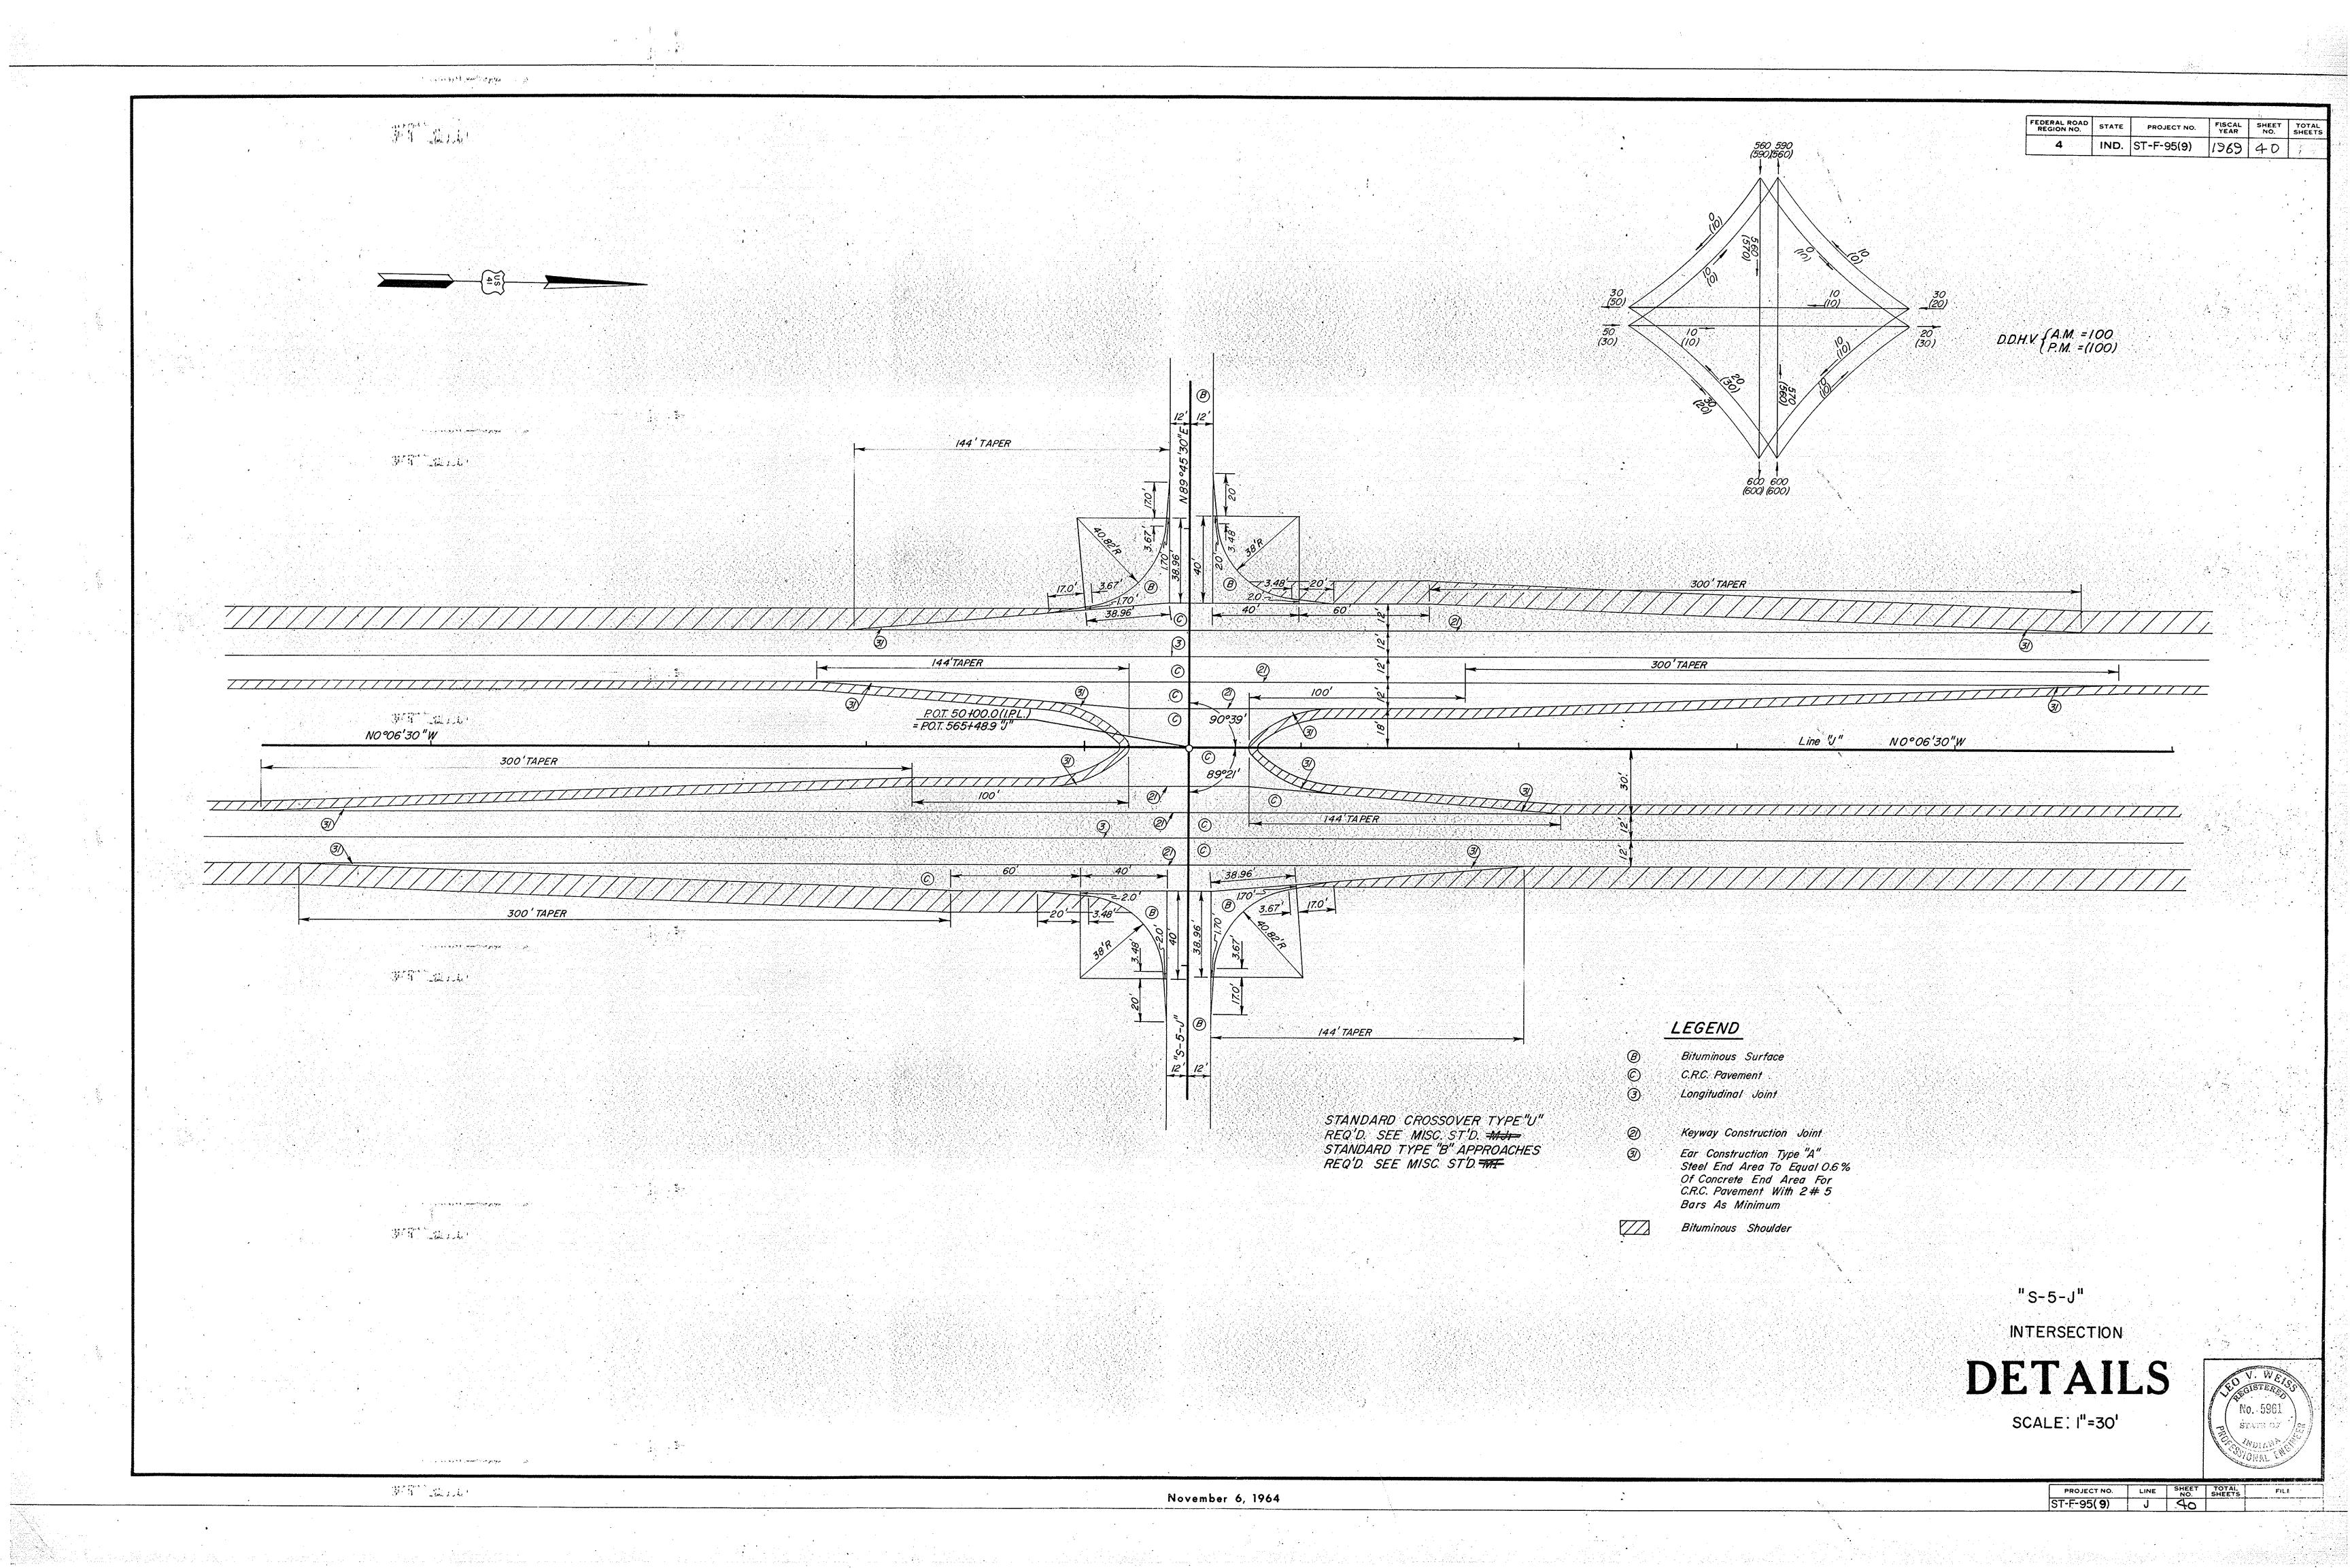PROJECT NO. LINE SHEET TOTAL FILE

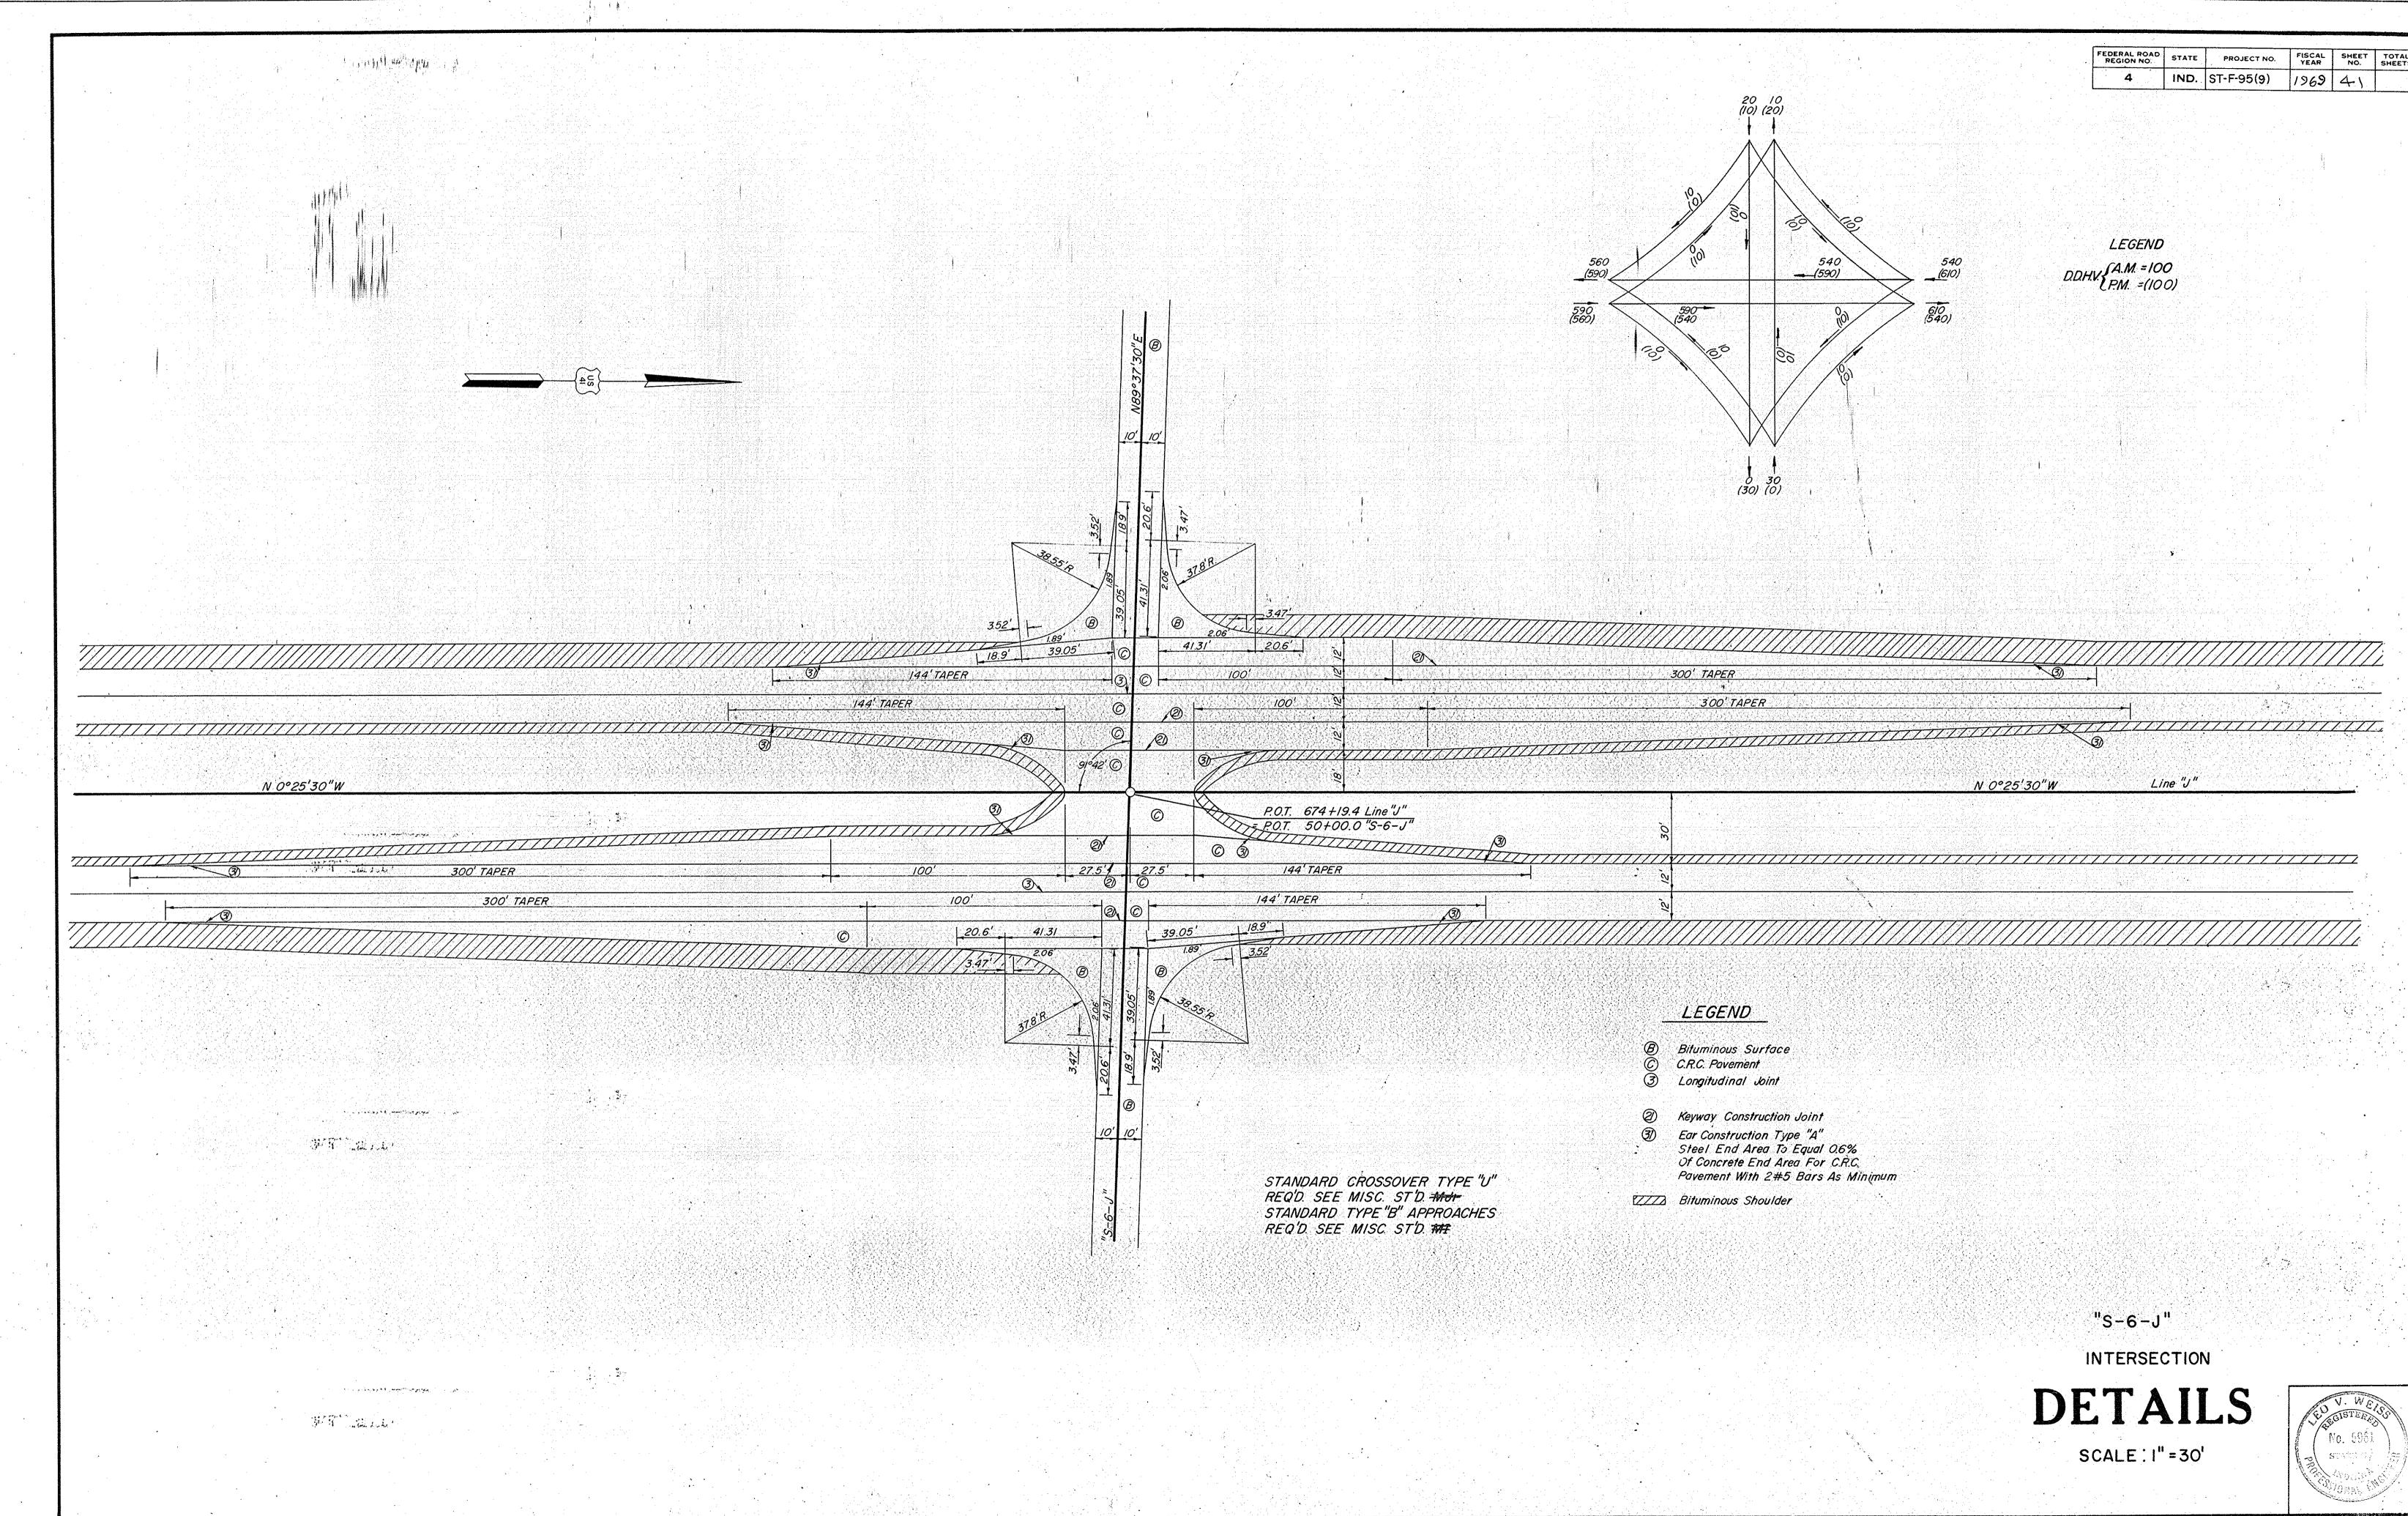ST-F-95(9) J 41



	DRIVES * Temp.R/W Reg'd.																
LOCATION		EXCAV	ATION			DESIGN DATA & QUANTITIES BASED ON MAX. 10% GRADE EXCEPT AS NOTED											
	DESCRIPTION	CU. YDS.		WIDTH	RADII	GRADE LESS THAN 10% NOT	LENGTH "L"	DISTANCE BEYOND R/W LINE	FOR /	NOUS MIX APPROAC SQ. YDS.	HES	CON	TYPE"P" IPACTED SE(SQ.Y	SEE PLAN SHEET NO.			
		CUT							SURFACE	B⊿	SE						
		CUT	FILL			SHOWN		*	110	220		3"	6"	43/4"			
STA 46+50"S-I-J" Lt.	CLASS II			12'	25'-15'		. 40'		74	74		74					
STA. 53+00"S-I-J" Rt.	CLASS V		•	12"	25'-15'		* 50'										
STA 53100 "S-I-J" Lt.	CLASS V	الغروة جيما والدارة		- 12'	25'-15'		40'										
STA. 33+50'S-2-J'Rev. Rt.	CLASS II			18'	25'-15'		100'		220	220		220					
STA. 36100 S-2-J Rev. Lt.	CLASS V ;			12'	25'-15'		80'						•				
STA 53+00"S-3-J" Rt. STA 47+00"S-4-J"Lt.	CLASS V			12'	25'-15'		40'				1.14						
	CLASS V			12'	25'-15'		40'										
STA. 53+00'S-4-J" Rt. STA. 47+00'S-5-J" Rt.	CLASS Y			12'	25'-15'		40'										
STA.52+75"S-USR4I-2-J"Lt.	CLASS V			12	25'-15'		37'					3, 2, 2, 4, 1, 2, 2, 3					
STA 592+93 "J" Lt.	CLASS II		APM COLUMN	24	25'-15'		100,		287	287		287					
STA 592+93"J" Rt.	CLASS V		The same of the sa	12'	20'-5' 20'-5'		91'				44.000			PERMIT			
STA 593+13"J" Lt.	CLASS V			2'	20-5		81 ' 91'										
STA 593+13 "J" Rt.	CLASS V			12'	20-5		81										
STA.4100 Acc. Rd.# Rt.	CLASS V			12'	25-15'		16					(2,40), 2,40,7 (4,5), 3,5 (4,5), 7					
STA 3+00 Acc. Rd#2 Rt.	CLASS ▼			12'	25-15	A SAN AND AND AND AND AND AND AND AND AND A	36	20'									
STA. 2+10 Acc. Rd.#3 Lt.	CLASS V			12'	25'-15'		36'	20'	ta igi arike terbibik Marak gabakan		7 - 6 - 2 - 5 - 5 - 5 - 5 - 5 - 5 - 5 - 5 - 5						
STA. 2+80 Acc.Rd.#3	CLASS V		4,100,100,100	12'			30'	30'		10 April (14-1153)							

						•											4		IND. S	T-F-95	(9)	369 4	4-3
							PU	BLIC	RO	AD	AP	PRC	ACH	IES								***************************************	
LOCATION	TYPE	EXCAV	/ATION	1/2" REFORMED JOINT FILLER	INTERGRAL CONC. CURB TYPE"B"	I" PREFORMED JOINT FILLER	RACTION S TYPE D-I	I"PREFORMED EXP. JOINT WITH LOAD TRANSFER		9" REINFORCED CONC. PAVEMENT		CONCRETE SIDEWALK	US FOR SHES		HAC. SURFACE TYPE "B"	TYPE"P" COMPACTED AGG. BASE	COMPACTED AGG. FOR SHOULDER	REINFORCING	SUBBASE TYPE II		COVERING AGGREGATE	6" PLAIN CONCRETE	BIT. MATERIAL FOR PRIME
		cu	. YDS.			LIN.FT				SQ	YDS.				TONS			LBS.	CU.YDS	TONS	TONS	SQ.YDS	TONS
STA: 315+97.58"J-NB" Rt.	В				1					1													
STA: 316+15.15"J-SB" Lt.	В								,									<u> </u>		 			<u> </u>
STA.385+03.2"J" Rt.	В															:		1		 		ļ <u>.</u>	
STA. 385+03.2 "J" Li.	В				the Addition															<u> </u>	<u> </u>	<u> </u>	-
STA. 458+88.0 "J" Rt.	В											•			1 1		1.5	<u> </u>					
STA. 458+88.0"J" Lt.	в							1										<u> </u>					
STA. 5l2+32.6 "J" Rt.	В			- A A A A A A A	1 1 1 1 1 1 1 1 1												14 17 350			-	<u> </u>	<u> </u>	
STA 512+32.6 "J" Lt.	В					(3)-63-43			34 (5.24	14.50		1,41,31,51			-> -> -> ->					<u> </u>			
STA.565+48.9 "J"	. B	1.换.按注									5 18 0 3 2 2 3 C							. TA 2 4 5 5 1 1	<u> </u>		 		
STA:565+489 "J" Lt.	В		33333	102544			31358												-		3 2	3 2 2	<u> </u>
STA 674+19:4 "J" Rt.	В	2499	14.000			300003	189187	7.00													<u> </u>		
STA,674+19.4 "J" Lt.	. В		14445	19813				1 4 4 3 3														<u> </u>	
STA 699+00.0"J" Rt.	В				2.48.33%	13 W.		17.00									in in the Argentials. The Spin Alleria						
STA 10+00.0"T-1-J" Rt	В	13.34.5	1 1 1 1 1 X		Control Control		3.10.00			K							- A. S. S. S. S. S.						<u> </u>

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APPROACH TABLE

POJECT NO. SHEET TOTAL

November 6, 1964

PROJECT NO. LINE







