
INDEX

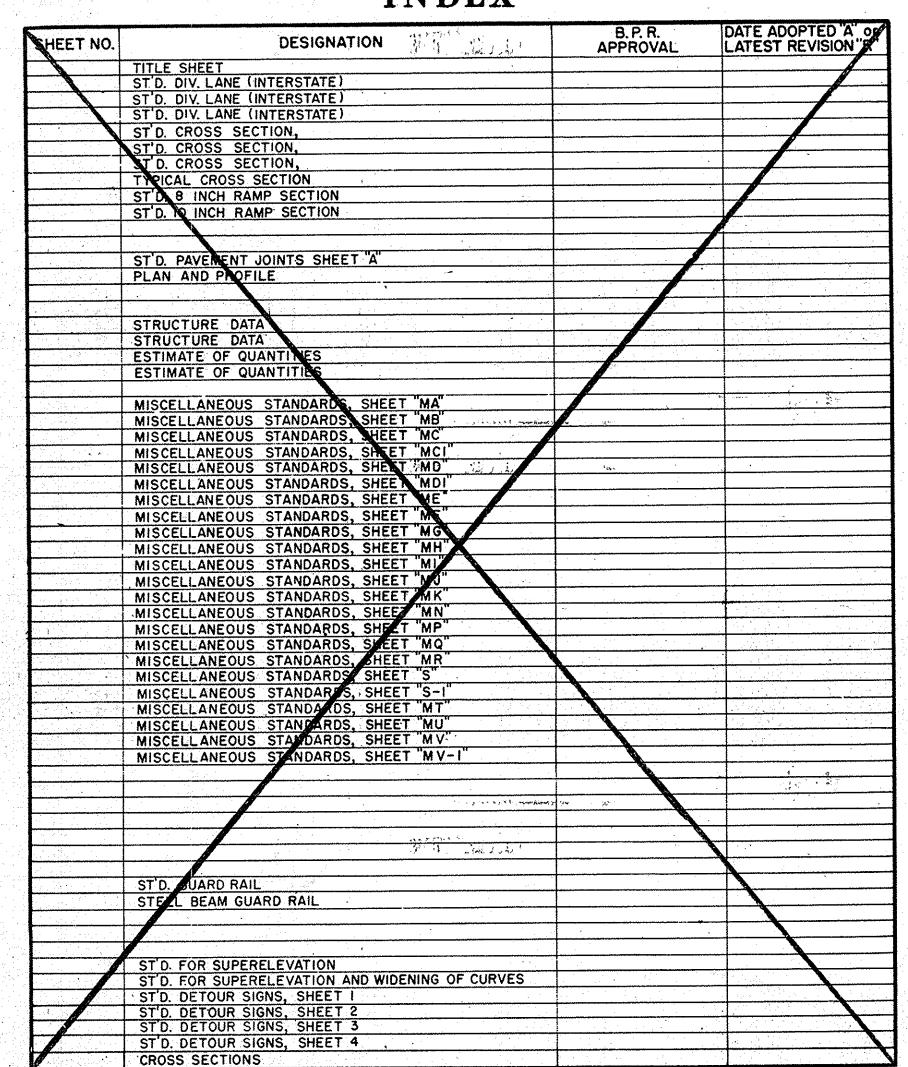

REVISIONS						
SHEET NO.	DATE	REVISED				
17,18,20,37,38439		L.A.以《柱字.				
AS ABOVE	3-27-73	Rd. Defign Approval/C.O. 3-16-73				
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16,34	1-21-81	REV. R 5TA. 140+14				
2,17,18,20,37,38	3-14-83	ELIM. PARCELS 1,2 €3				

	•	R/W INDE	Χ,		
Sheet No.	1	Title Sheet			
Sheet No.	Z	PARCEL LIGTING			
Sheet No.	3-5	Strip Map - Plat No. 1			
Sheet No.	6-7	Typical Cross-Sections	·	4	
Sheet No.	8-20	Plan and Profile			·
Sheet No.	21-39 -	Construction Details	Ŋ.	÷\$;	alpha I in
Sheet No.	40-41	Additional Profiles			
Sheet No.	42	Approach Table			

STATE HIGHWAY DEPARTMENT OF INDIANA. STANDARD SPECIFICATIONS DATED 1963 TO BE USED WITH THESE PLANS.

W. W. Williams

RECOMMENDED FOR APPROVAL Thank 18, 1966

REGISTERED PROFESSIONAL ENGINEER, STATE OF INDIANA - REG. NO. 3326 MICHAEL BAKER, JR., INC.



STATE OF INDIANA INDIANA STATE HIGHWAY COMMISSION


PLAN AND PROFILE OF PROPOSED STATE HIGHWAY U-PROJECT NO. 845 ISPE

Beginning at a point approximately 3,400 ft. West of East Boundary of Section 28-T·6·S, R·10·W and running in an Easterly direction a distance of 15,132.80 ft. to a point approximately 1,126 ft. East of East Boundary of Section 23-T·6·S, R·10·W, all in Vanderburgh County.

GROSS LENGTH:- 2.866 MI. NET LENGTH:- 2.866 MI. SCALES:-PLAN {LONG:- 1"= 50' TRANS:-1"= 50' PROFILE {HORIZ:-1"= 50' VERT:- 1"= 5' CONST. DETAILS | HORIZ:-1"=30' TRANS:-1"=30'

MAX. GRADE 1.90% MAX. CURVATURE, 4°-00' MIN. R/W WIDTH, 119'

VANDERBURGH COUNTY

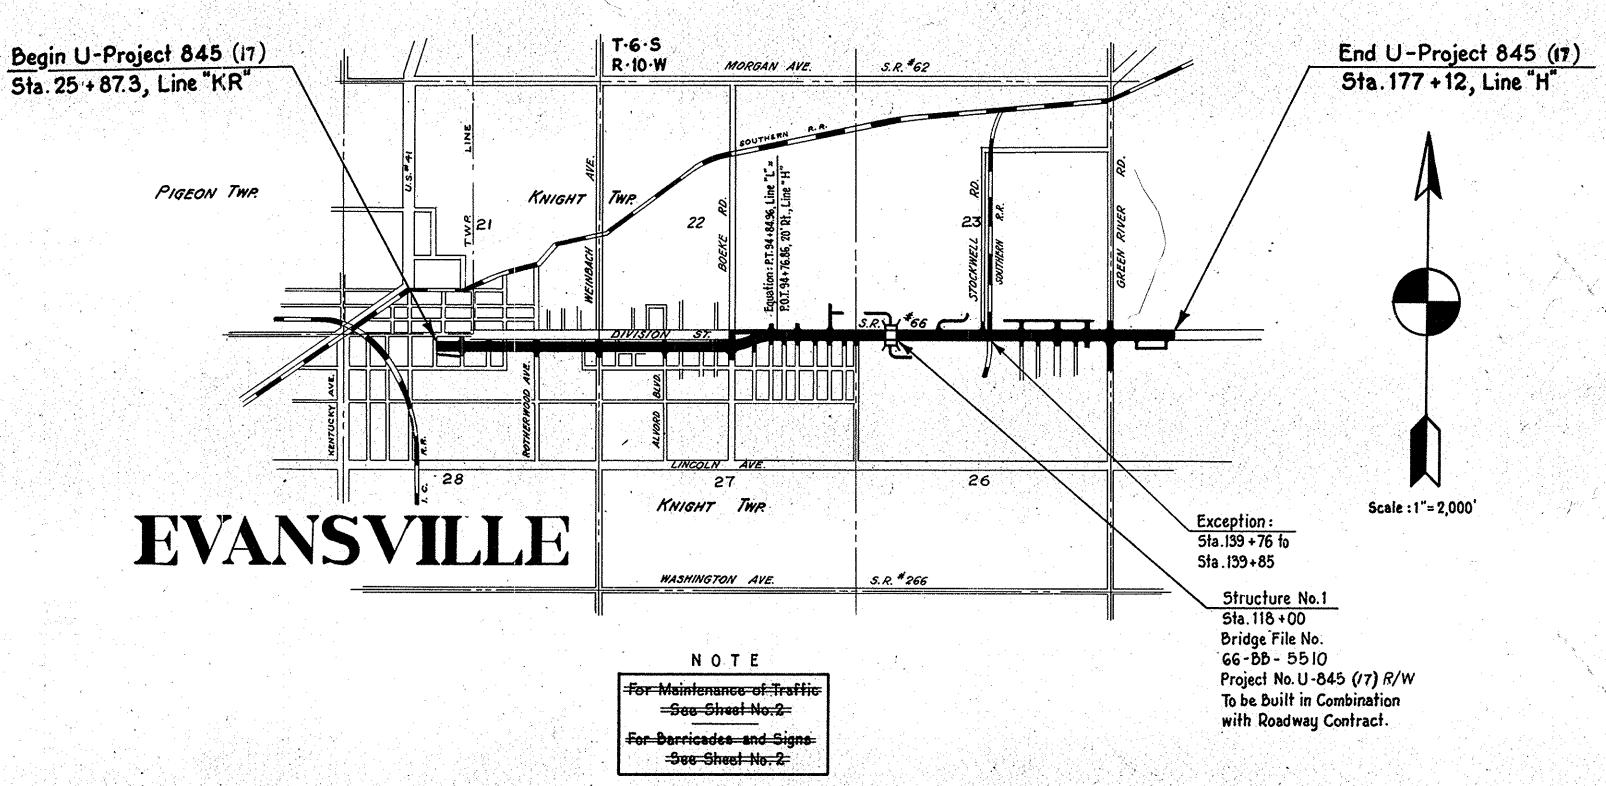

STATE PROJ. NO. YEAR 42 IND. U-845(11)

DESIGN DATA 12,000 V. P.D. 19,000 V. P.D. A.D.T. (1985) PROJECTED 2304 V.P.H. DIRECTIONAL DISTRIBUTION TRUCKS - D.H. V.=8% TRUCKS-A.D.T. =17 % DESIGN SPEED
ACCESS CONTROL — PARTIAL

> PLANS PREPARED AND SUBMITTED MICHAEL BAKER, JR., INC. HARRISBURG, PENNA.

DATE

BUREAU OF PUBLIC ROADS

DIVISION ENGINEER

ROAD FILE :-

WR. William

WH. LLIAM

W. W. Lillack

CENTER LINE

RESIDUE AREA

1 4 4 4 4 4 4 4

3A CHRYSLER REALTY C.

* (ASTERISK) IN THE BRIDG.

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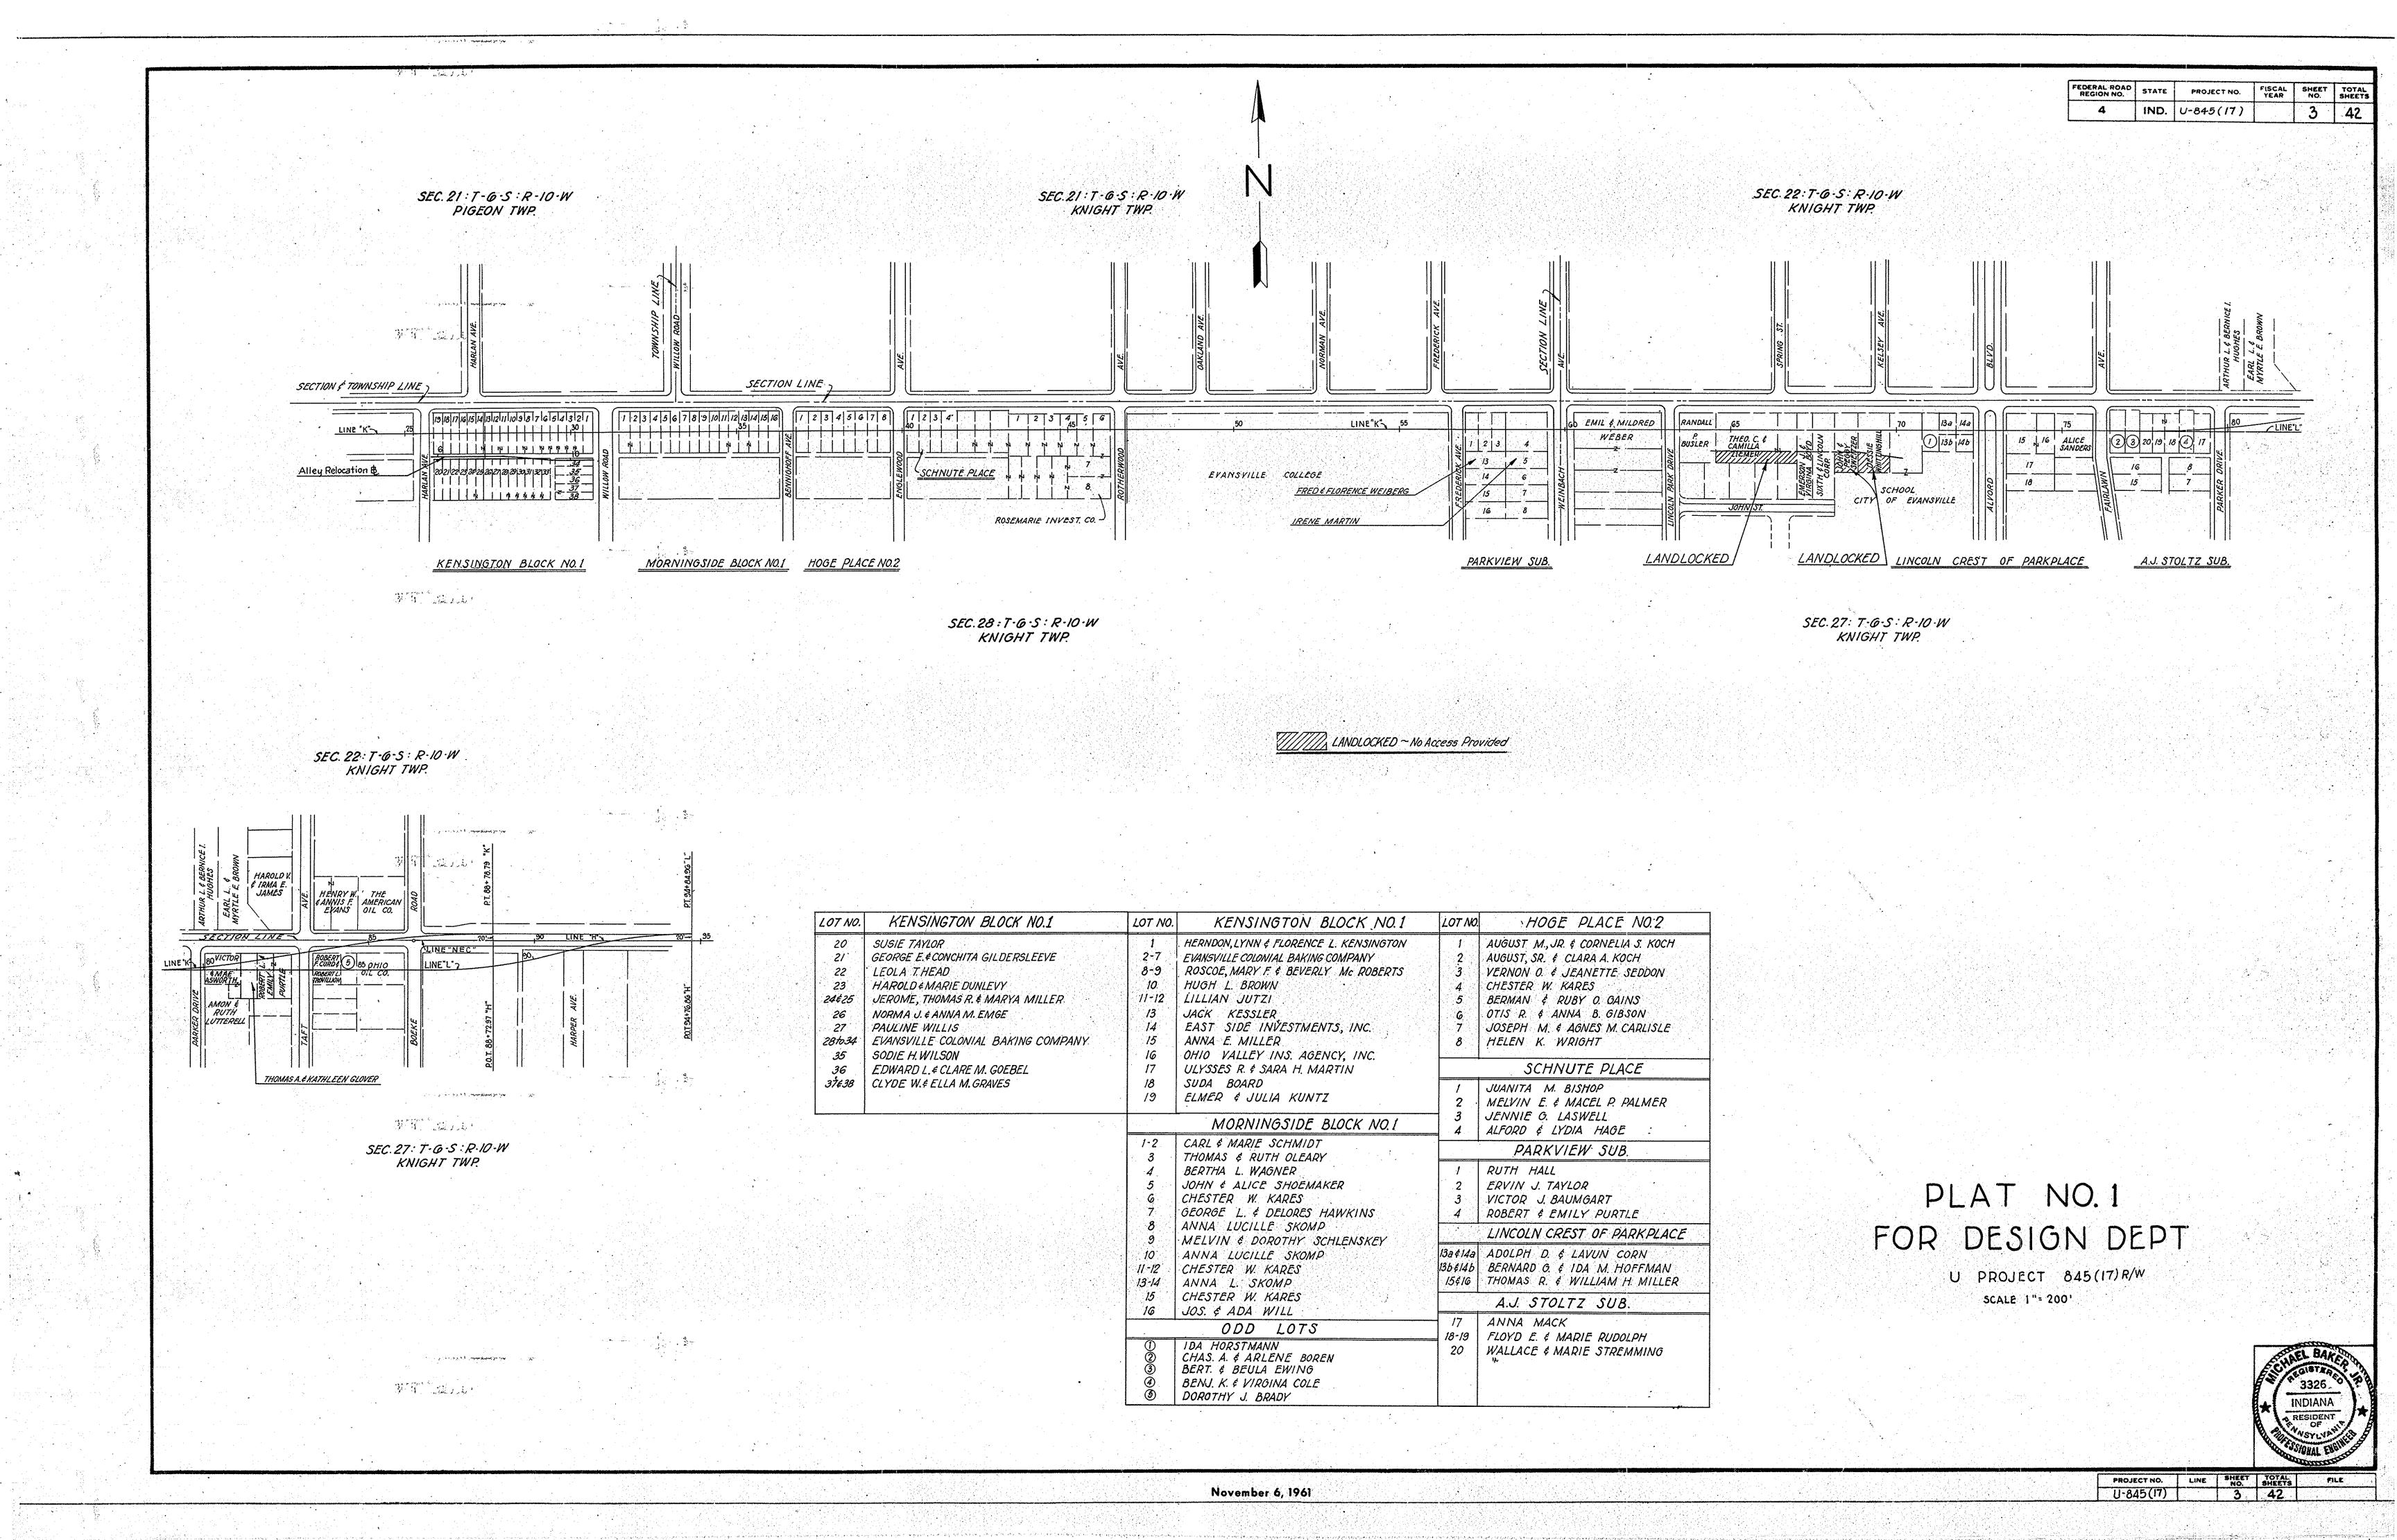
SP = SPECIAL INSTRUMENT F.


SS = FEE SIMPLE TITLE.


TE = TEMPORARY R/W.


FED. RO. DIST. No. STATE PROJECT No. YEAR No. SHEETS:

5 IND. M-845(17)



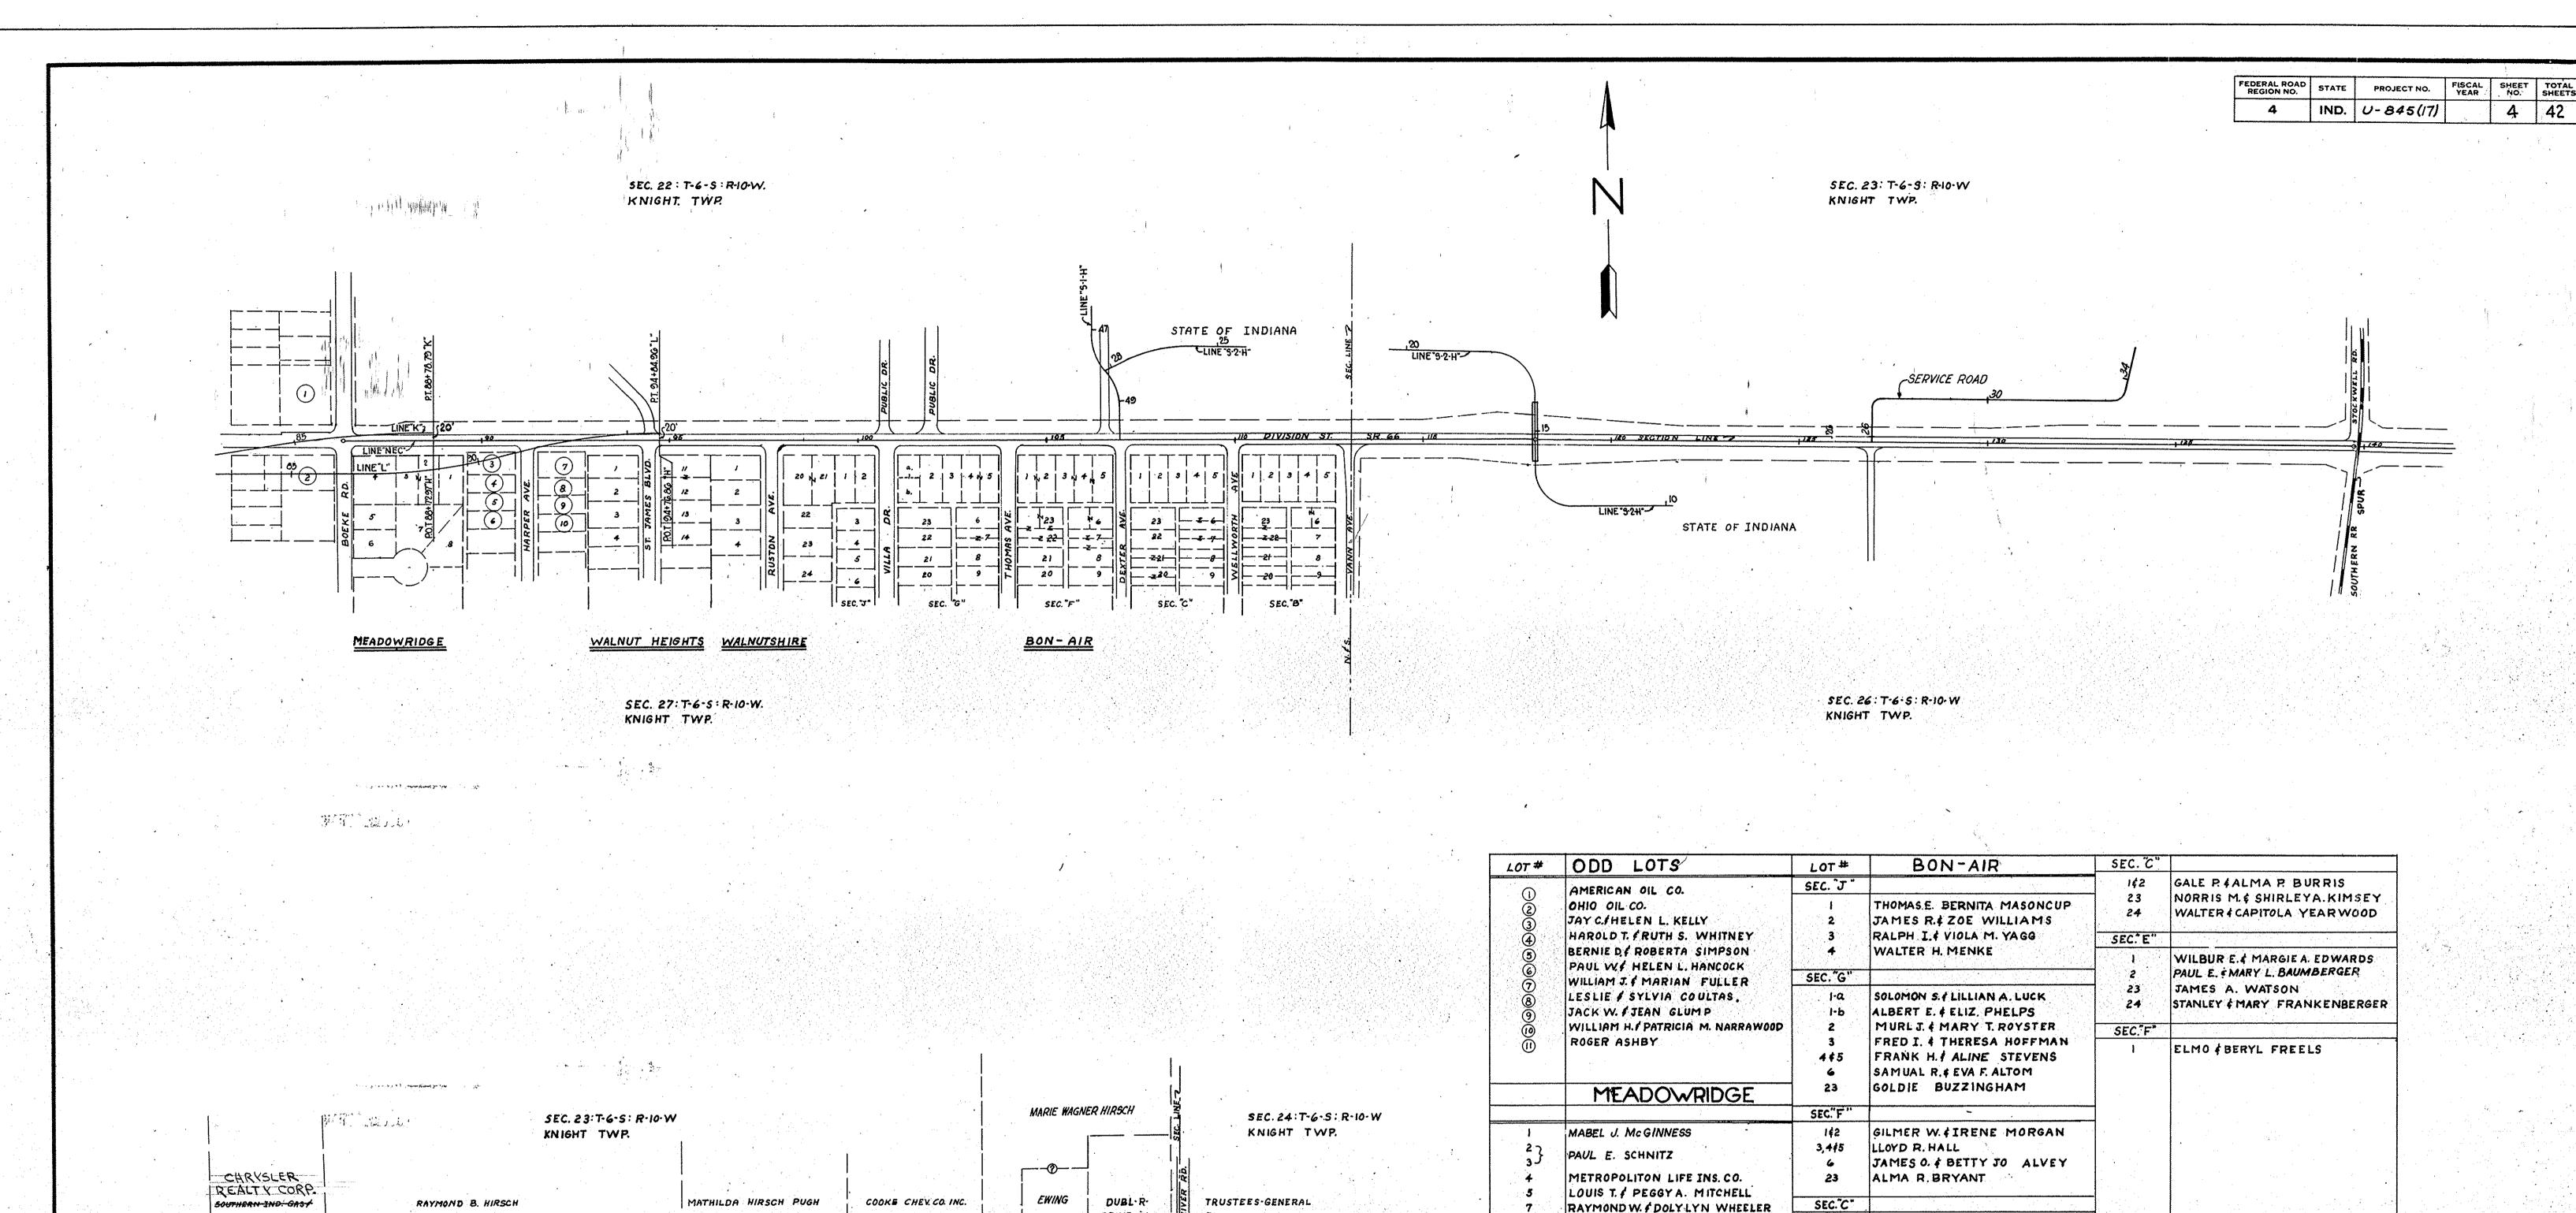

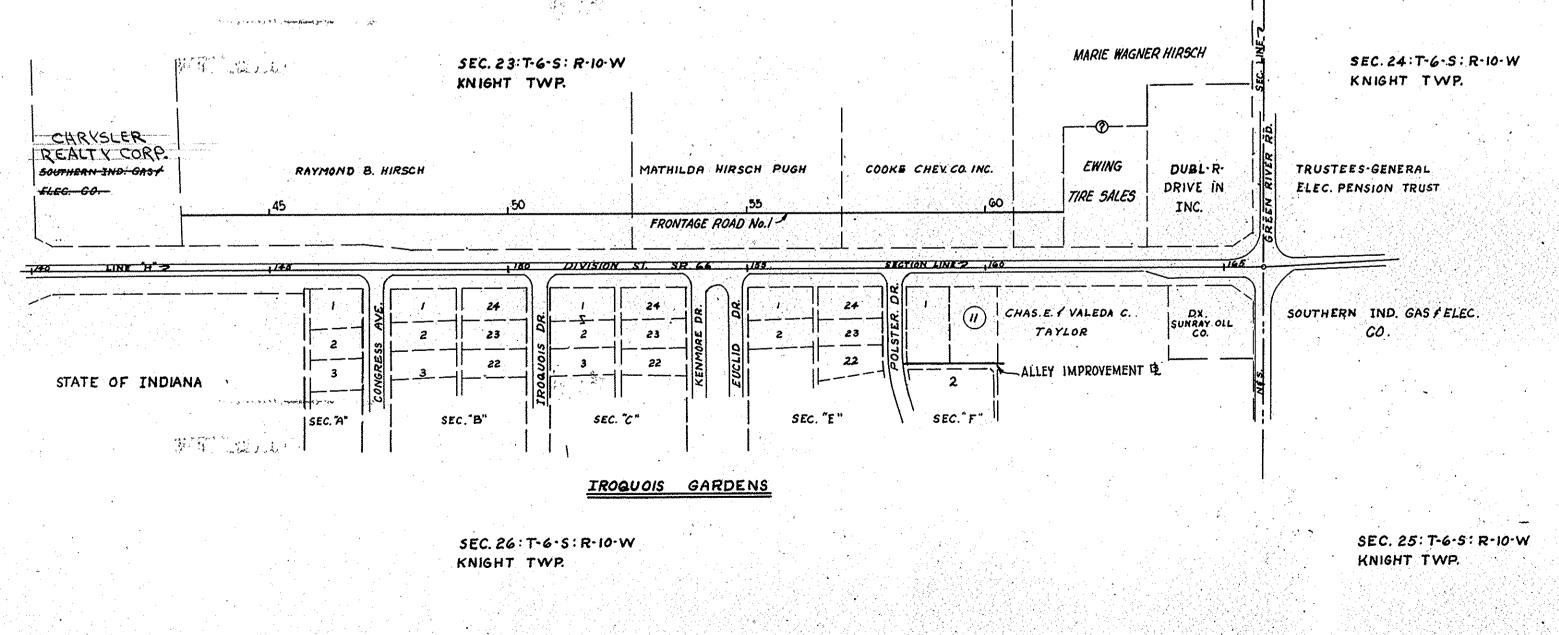

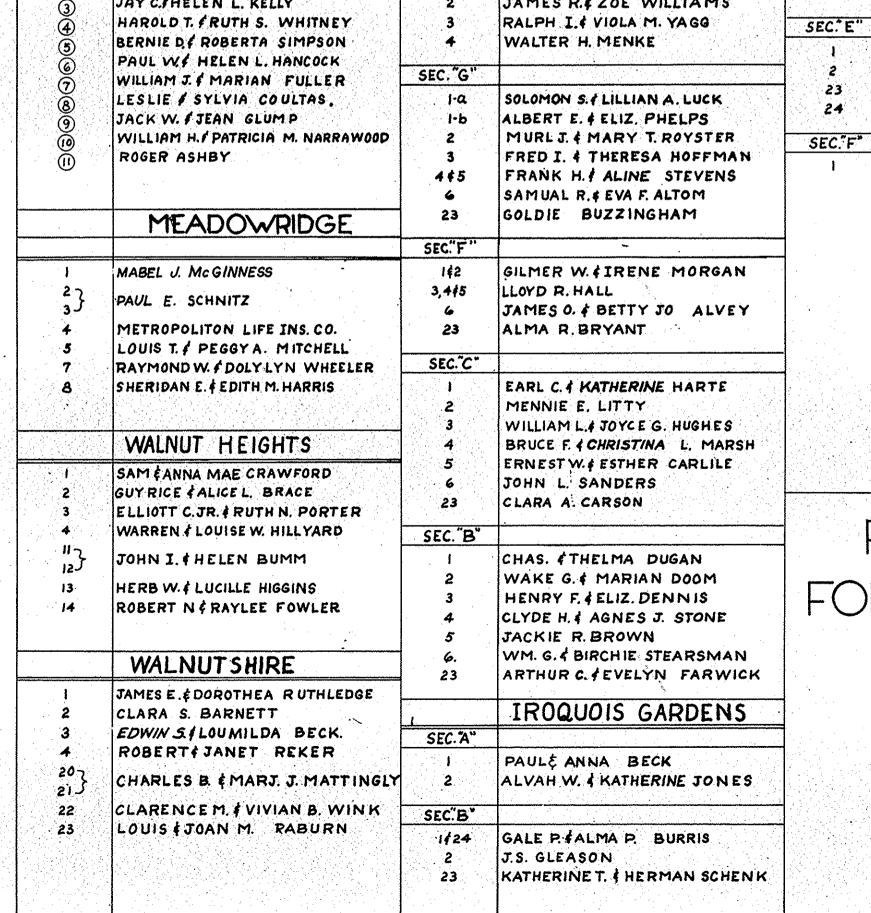


PLAT NO.1 FOR DESIGNDEPT U PROJECT 845(17) R/W


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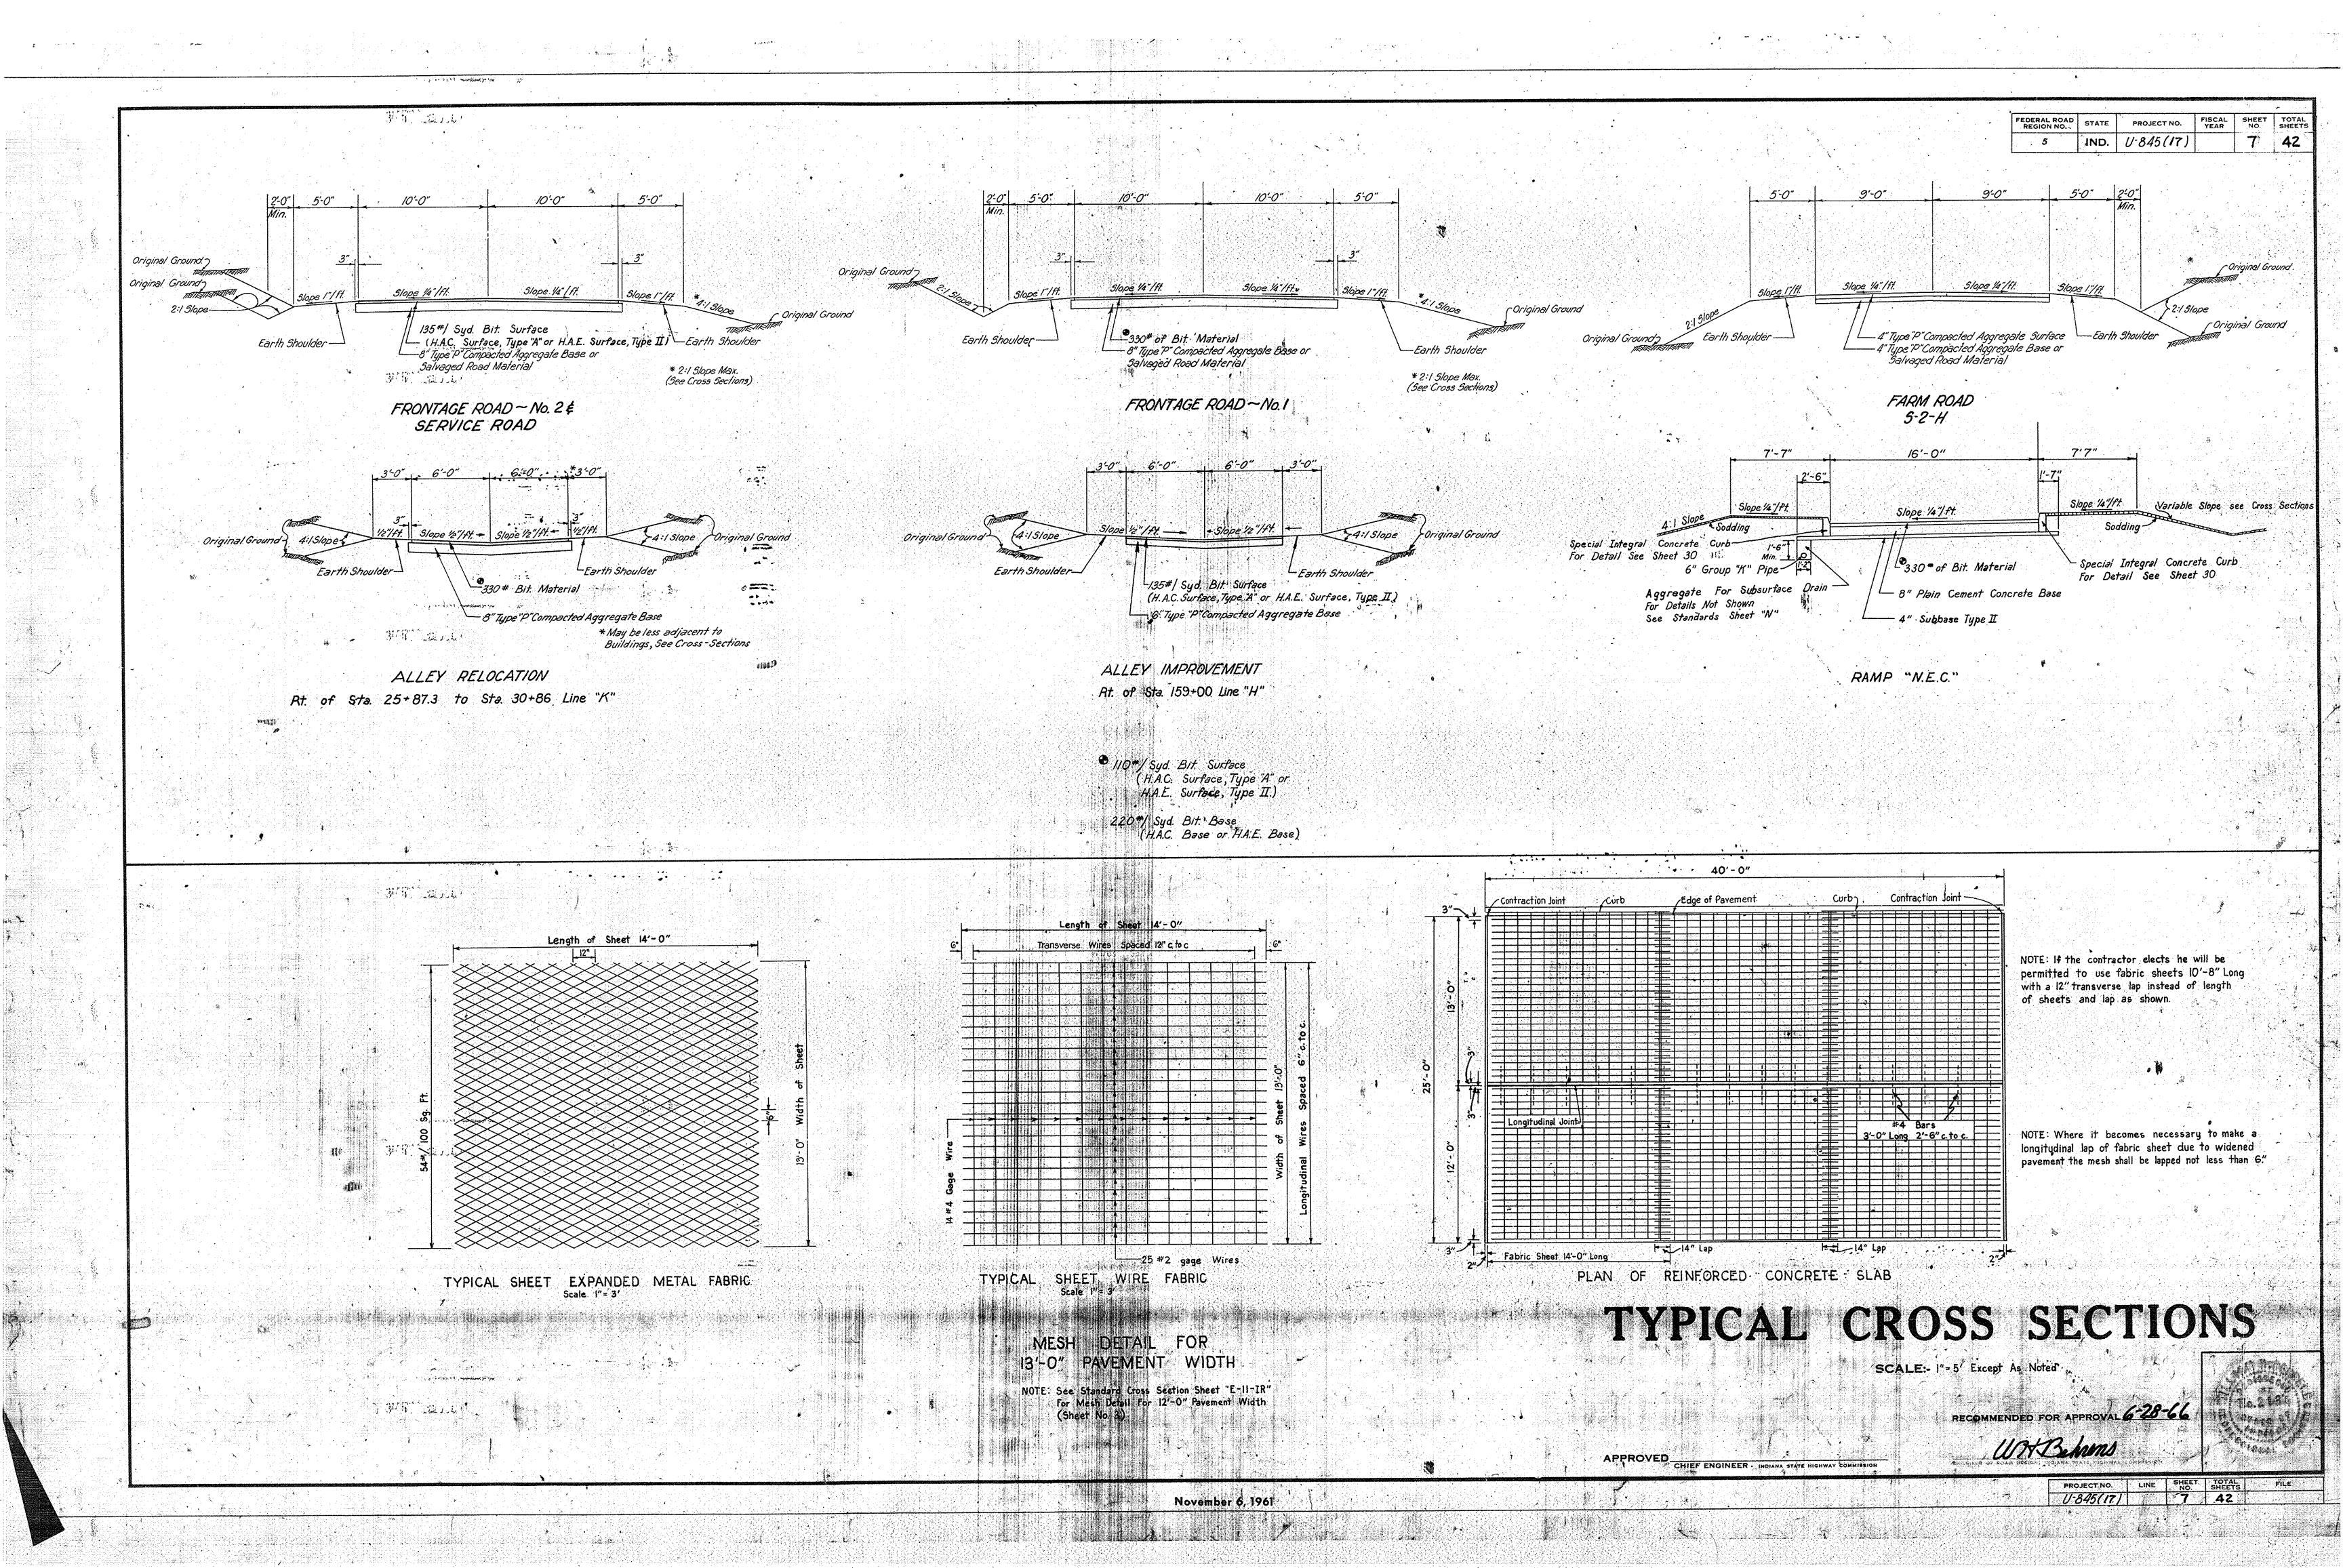



PROJECT NO. LINE SHEET TOTAL SHEETS FILL U-845(17) 4 42


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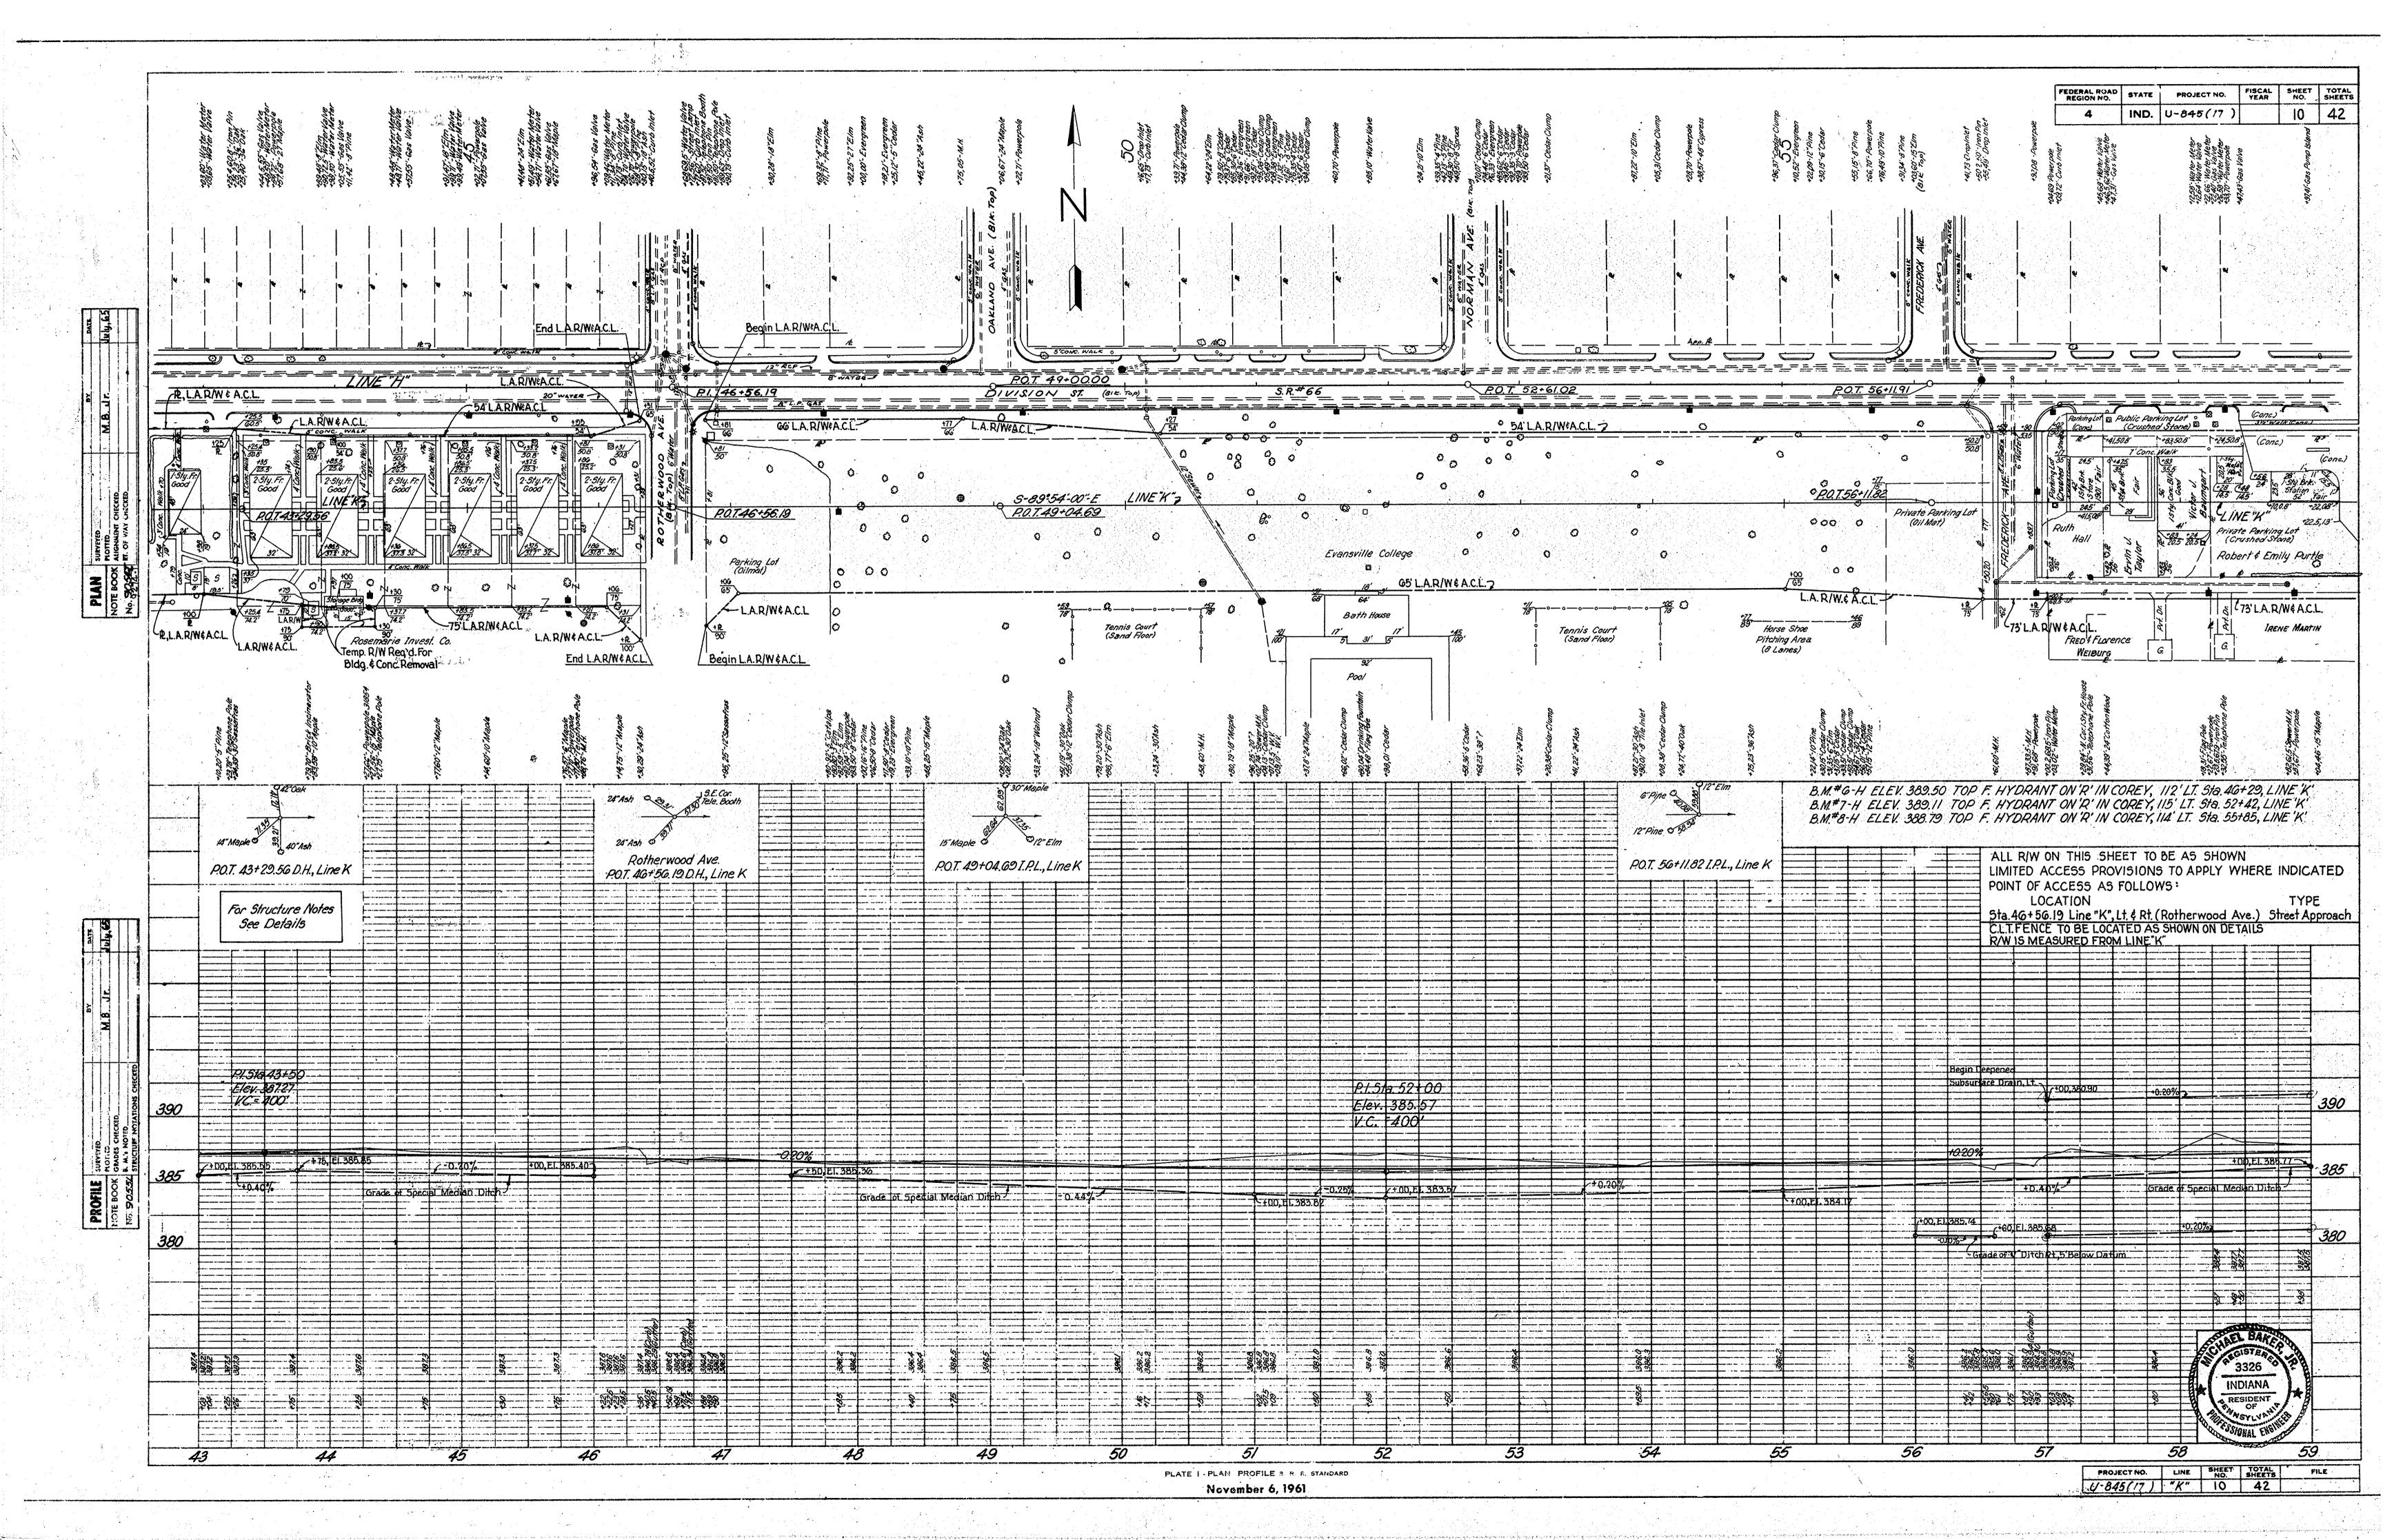





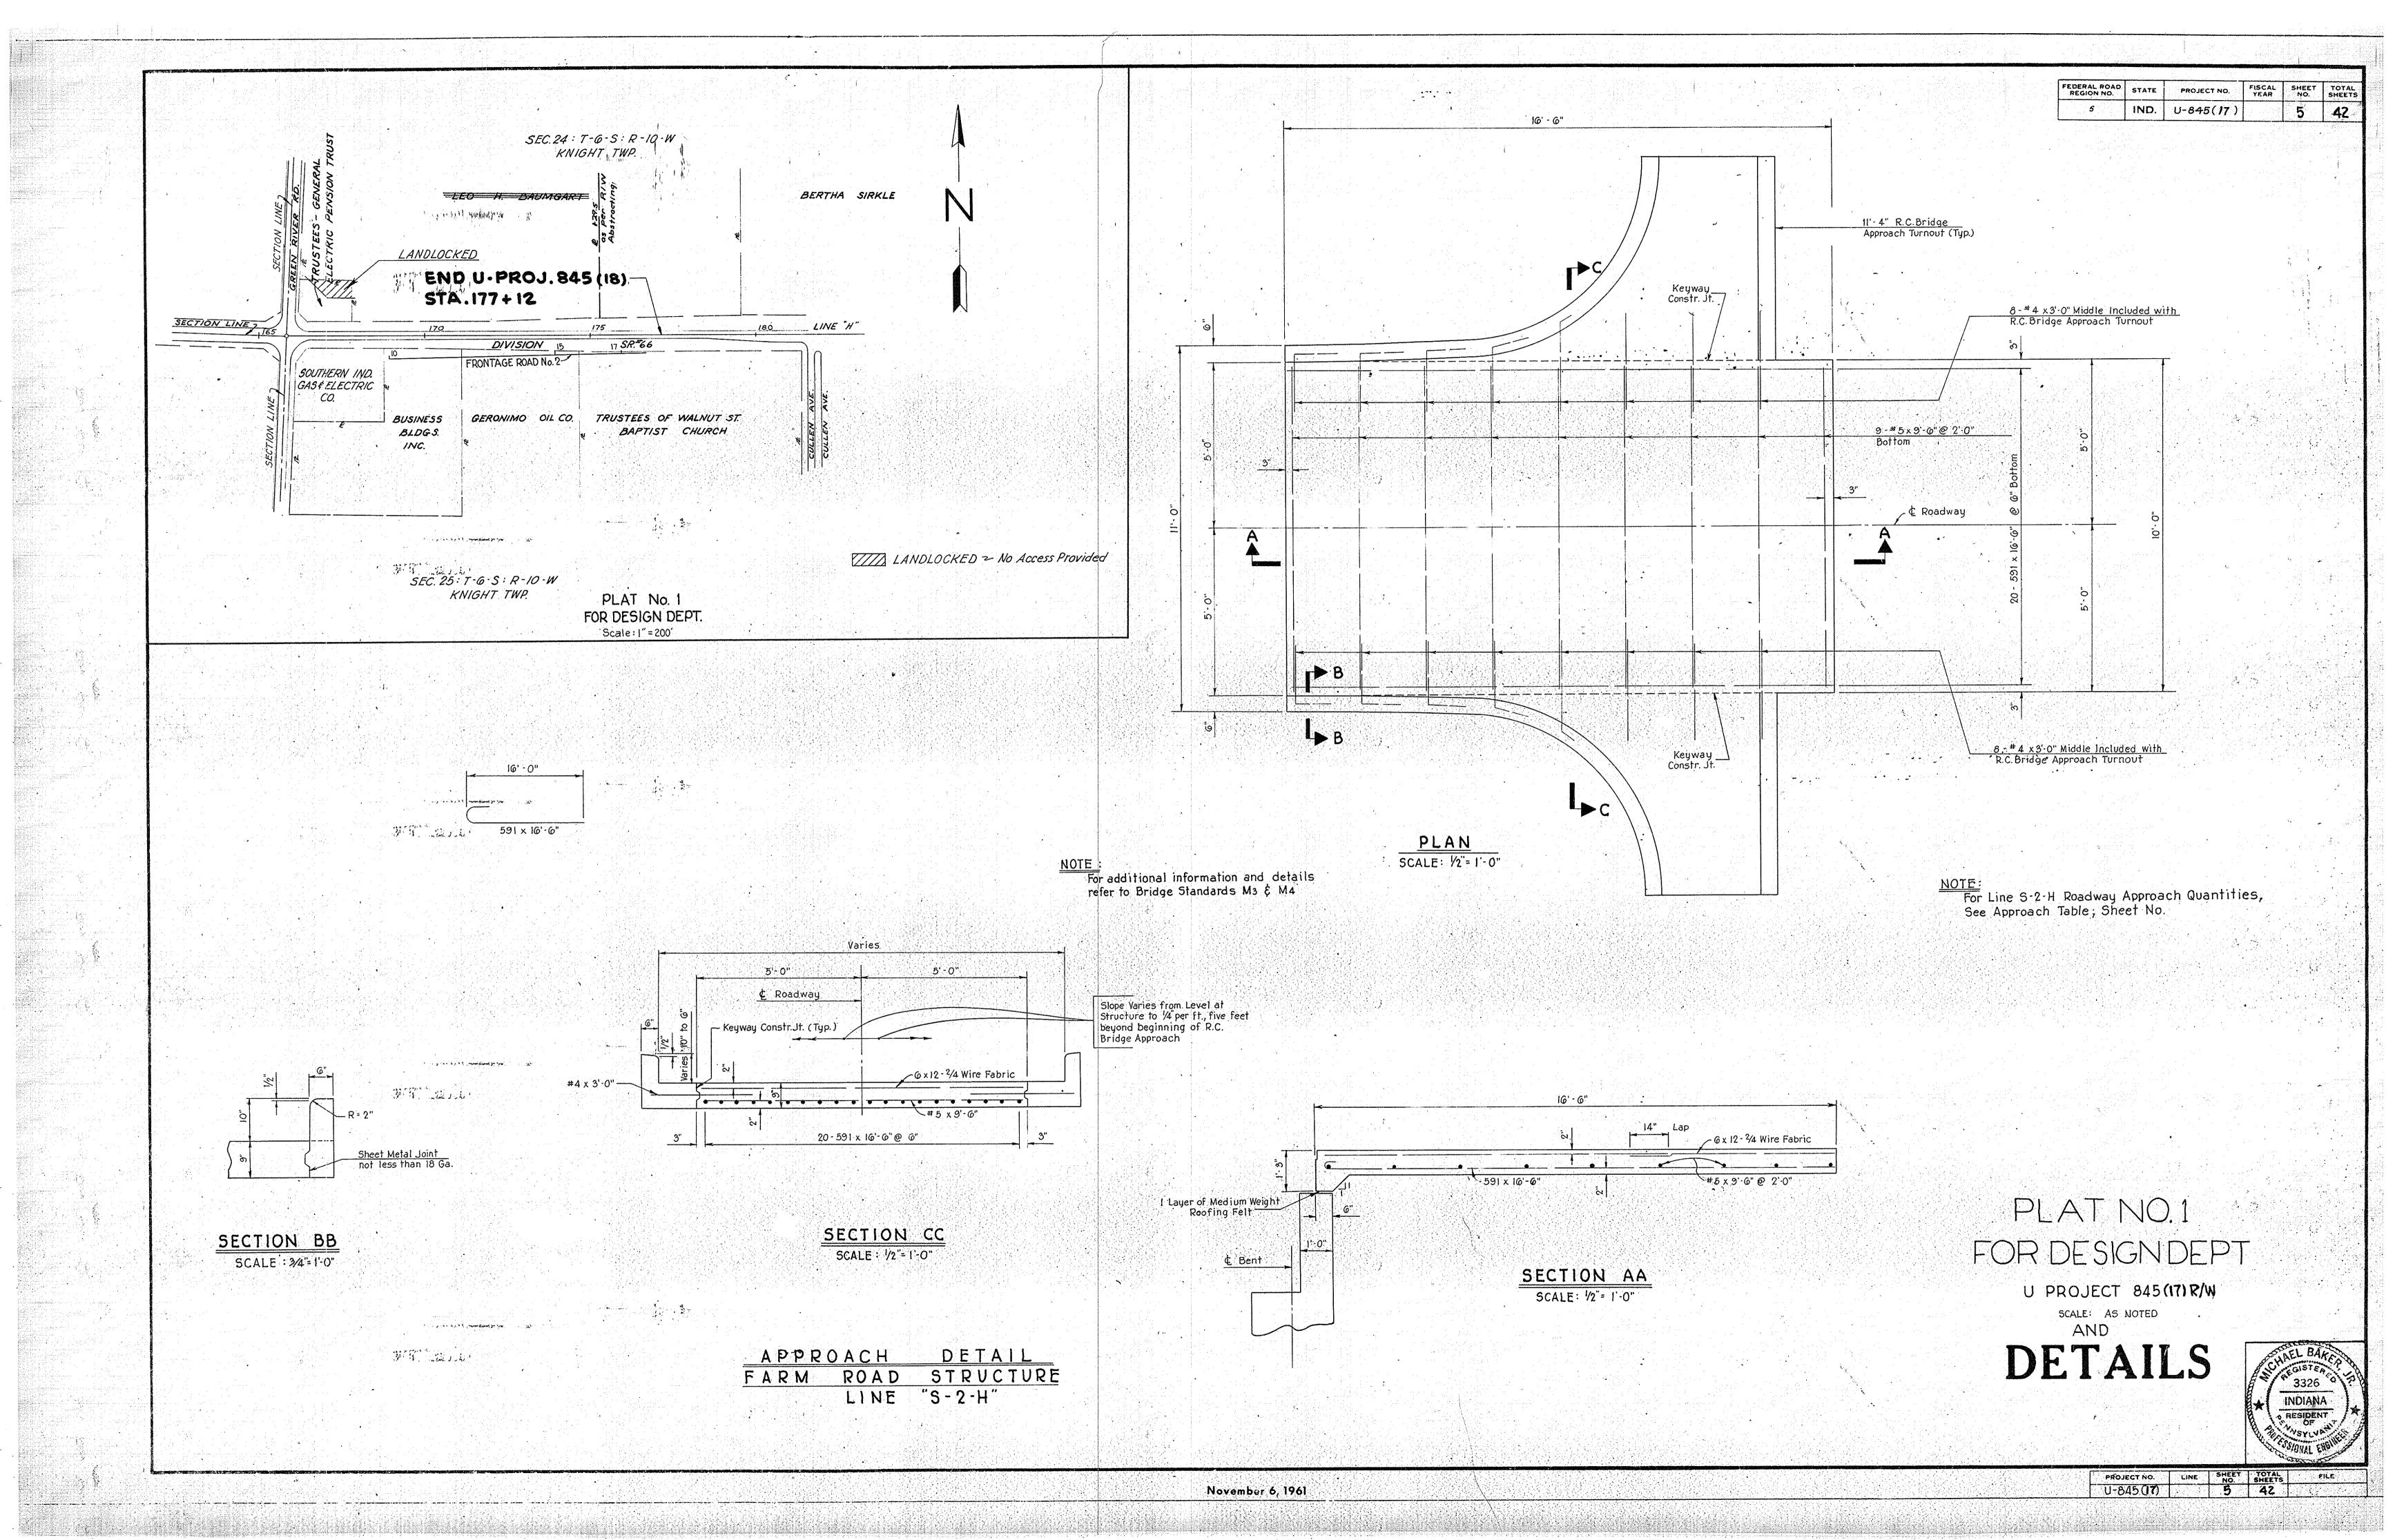


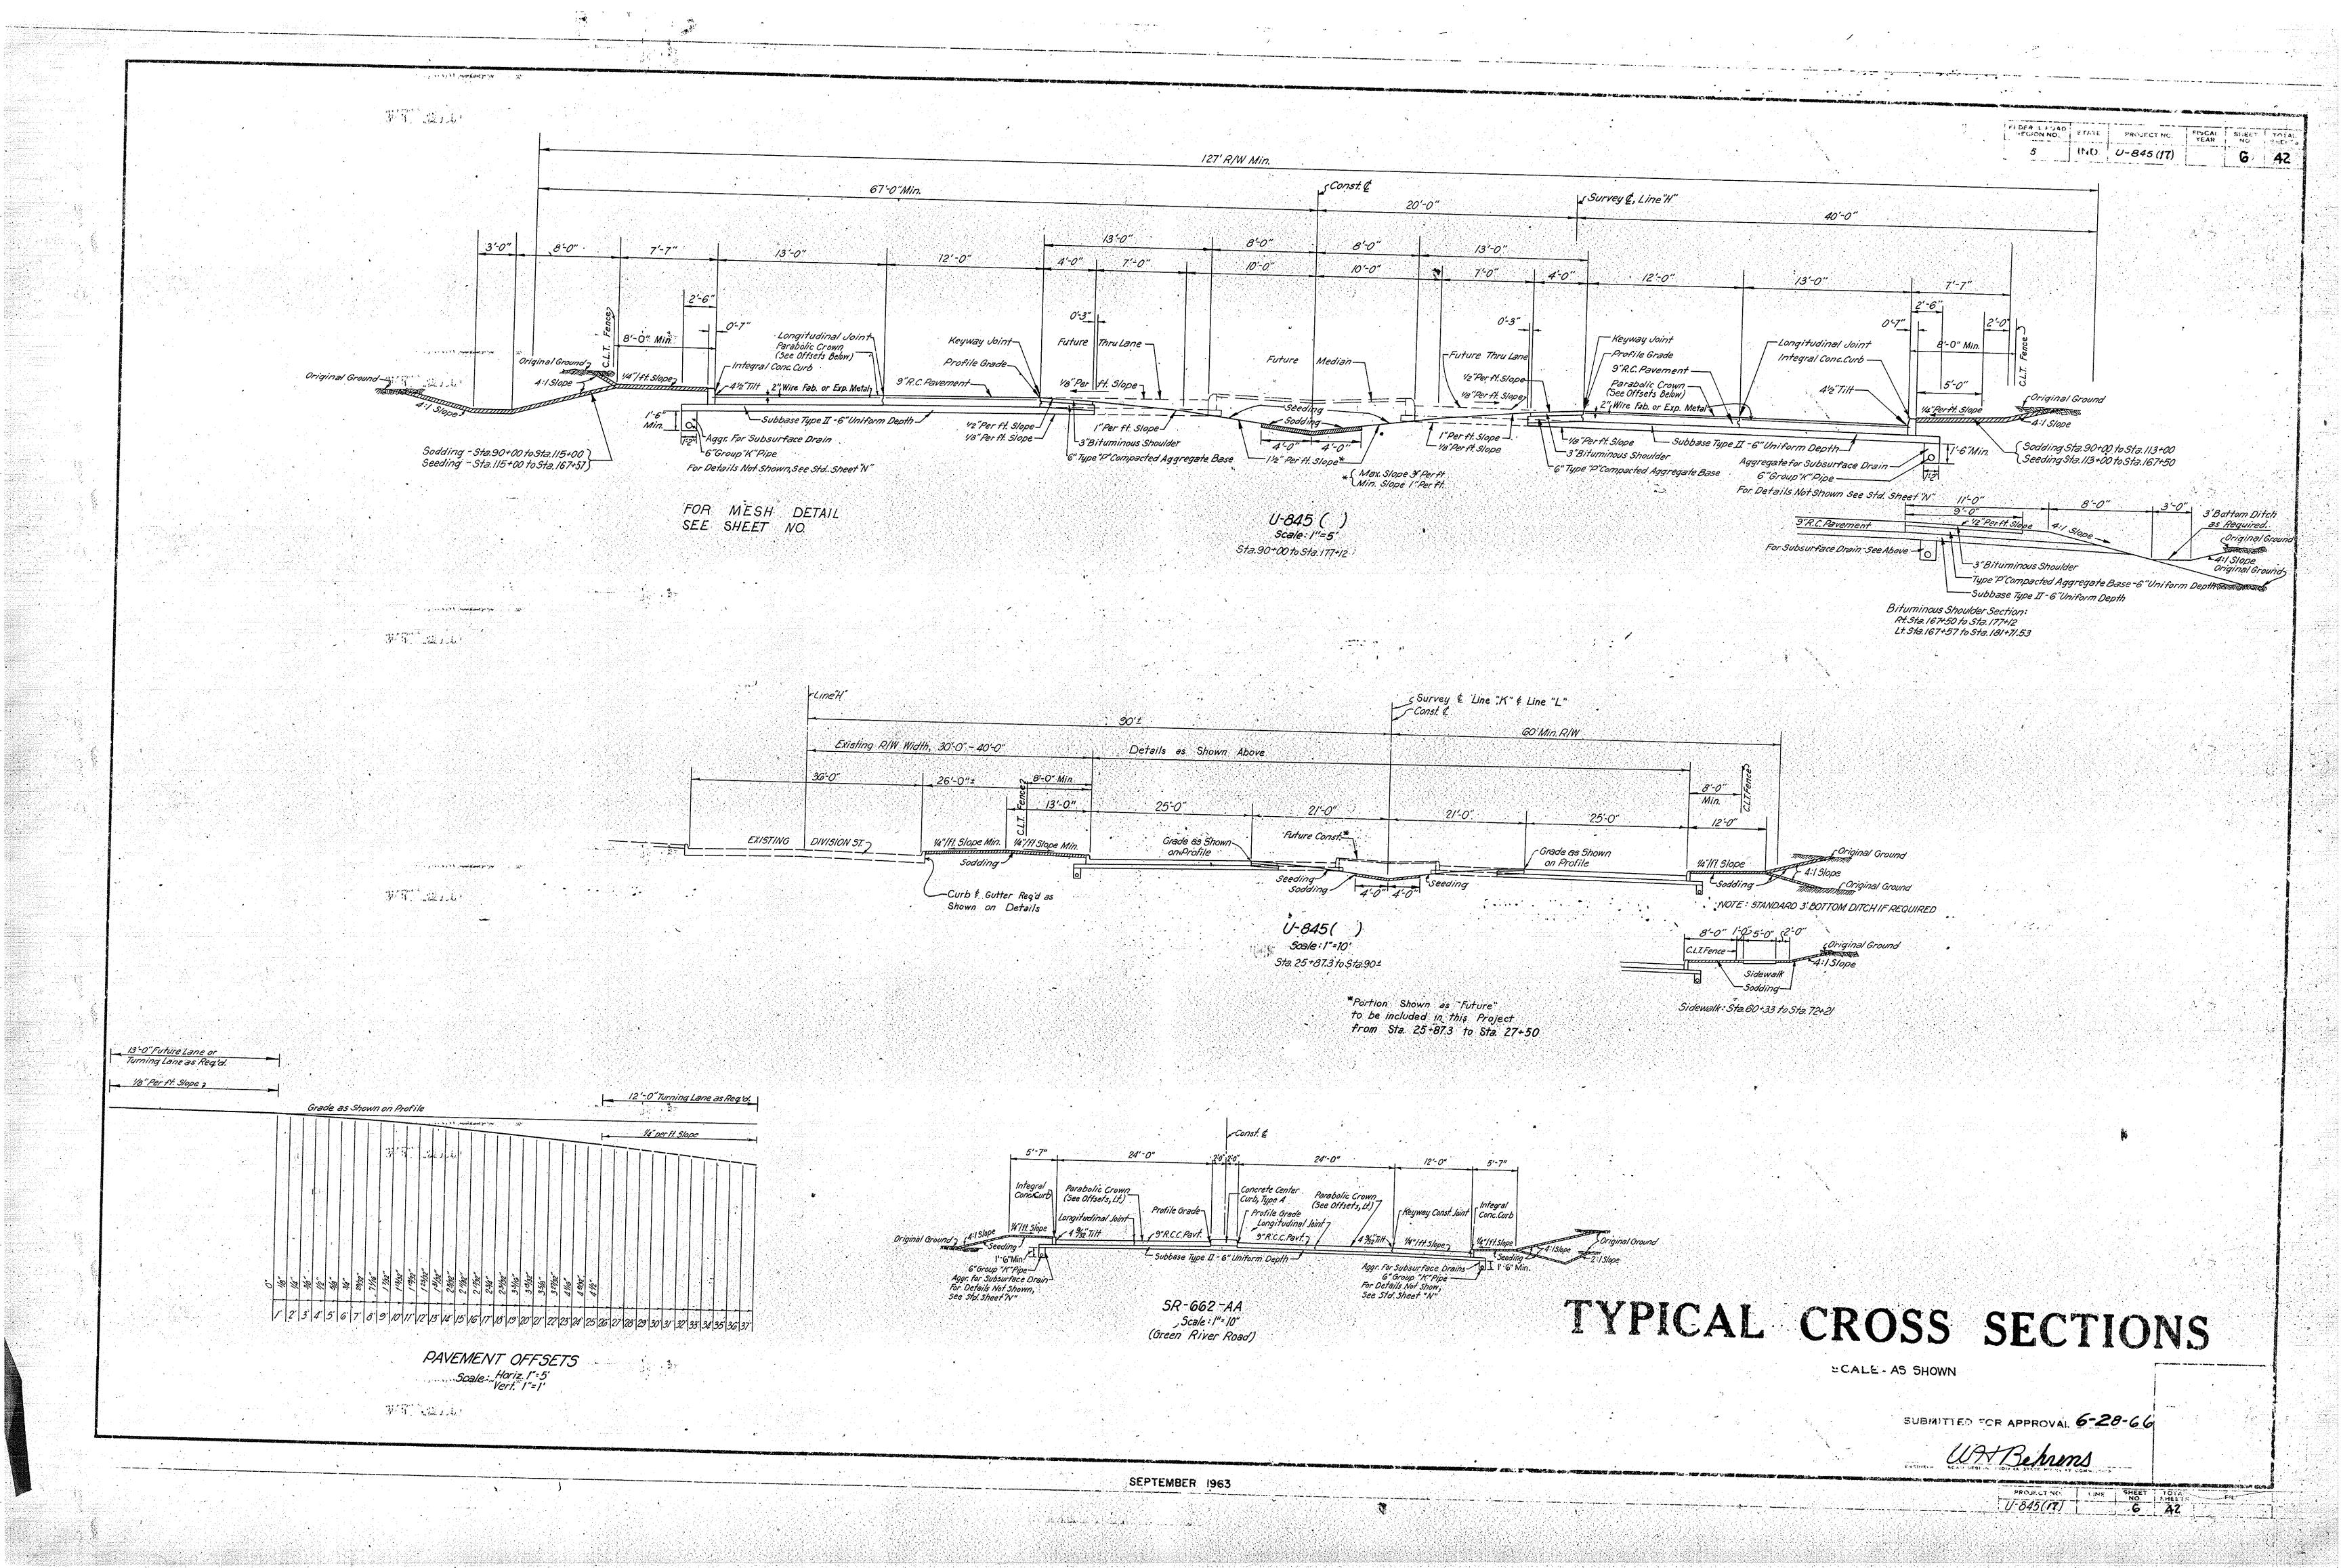


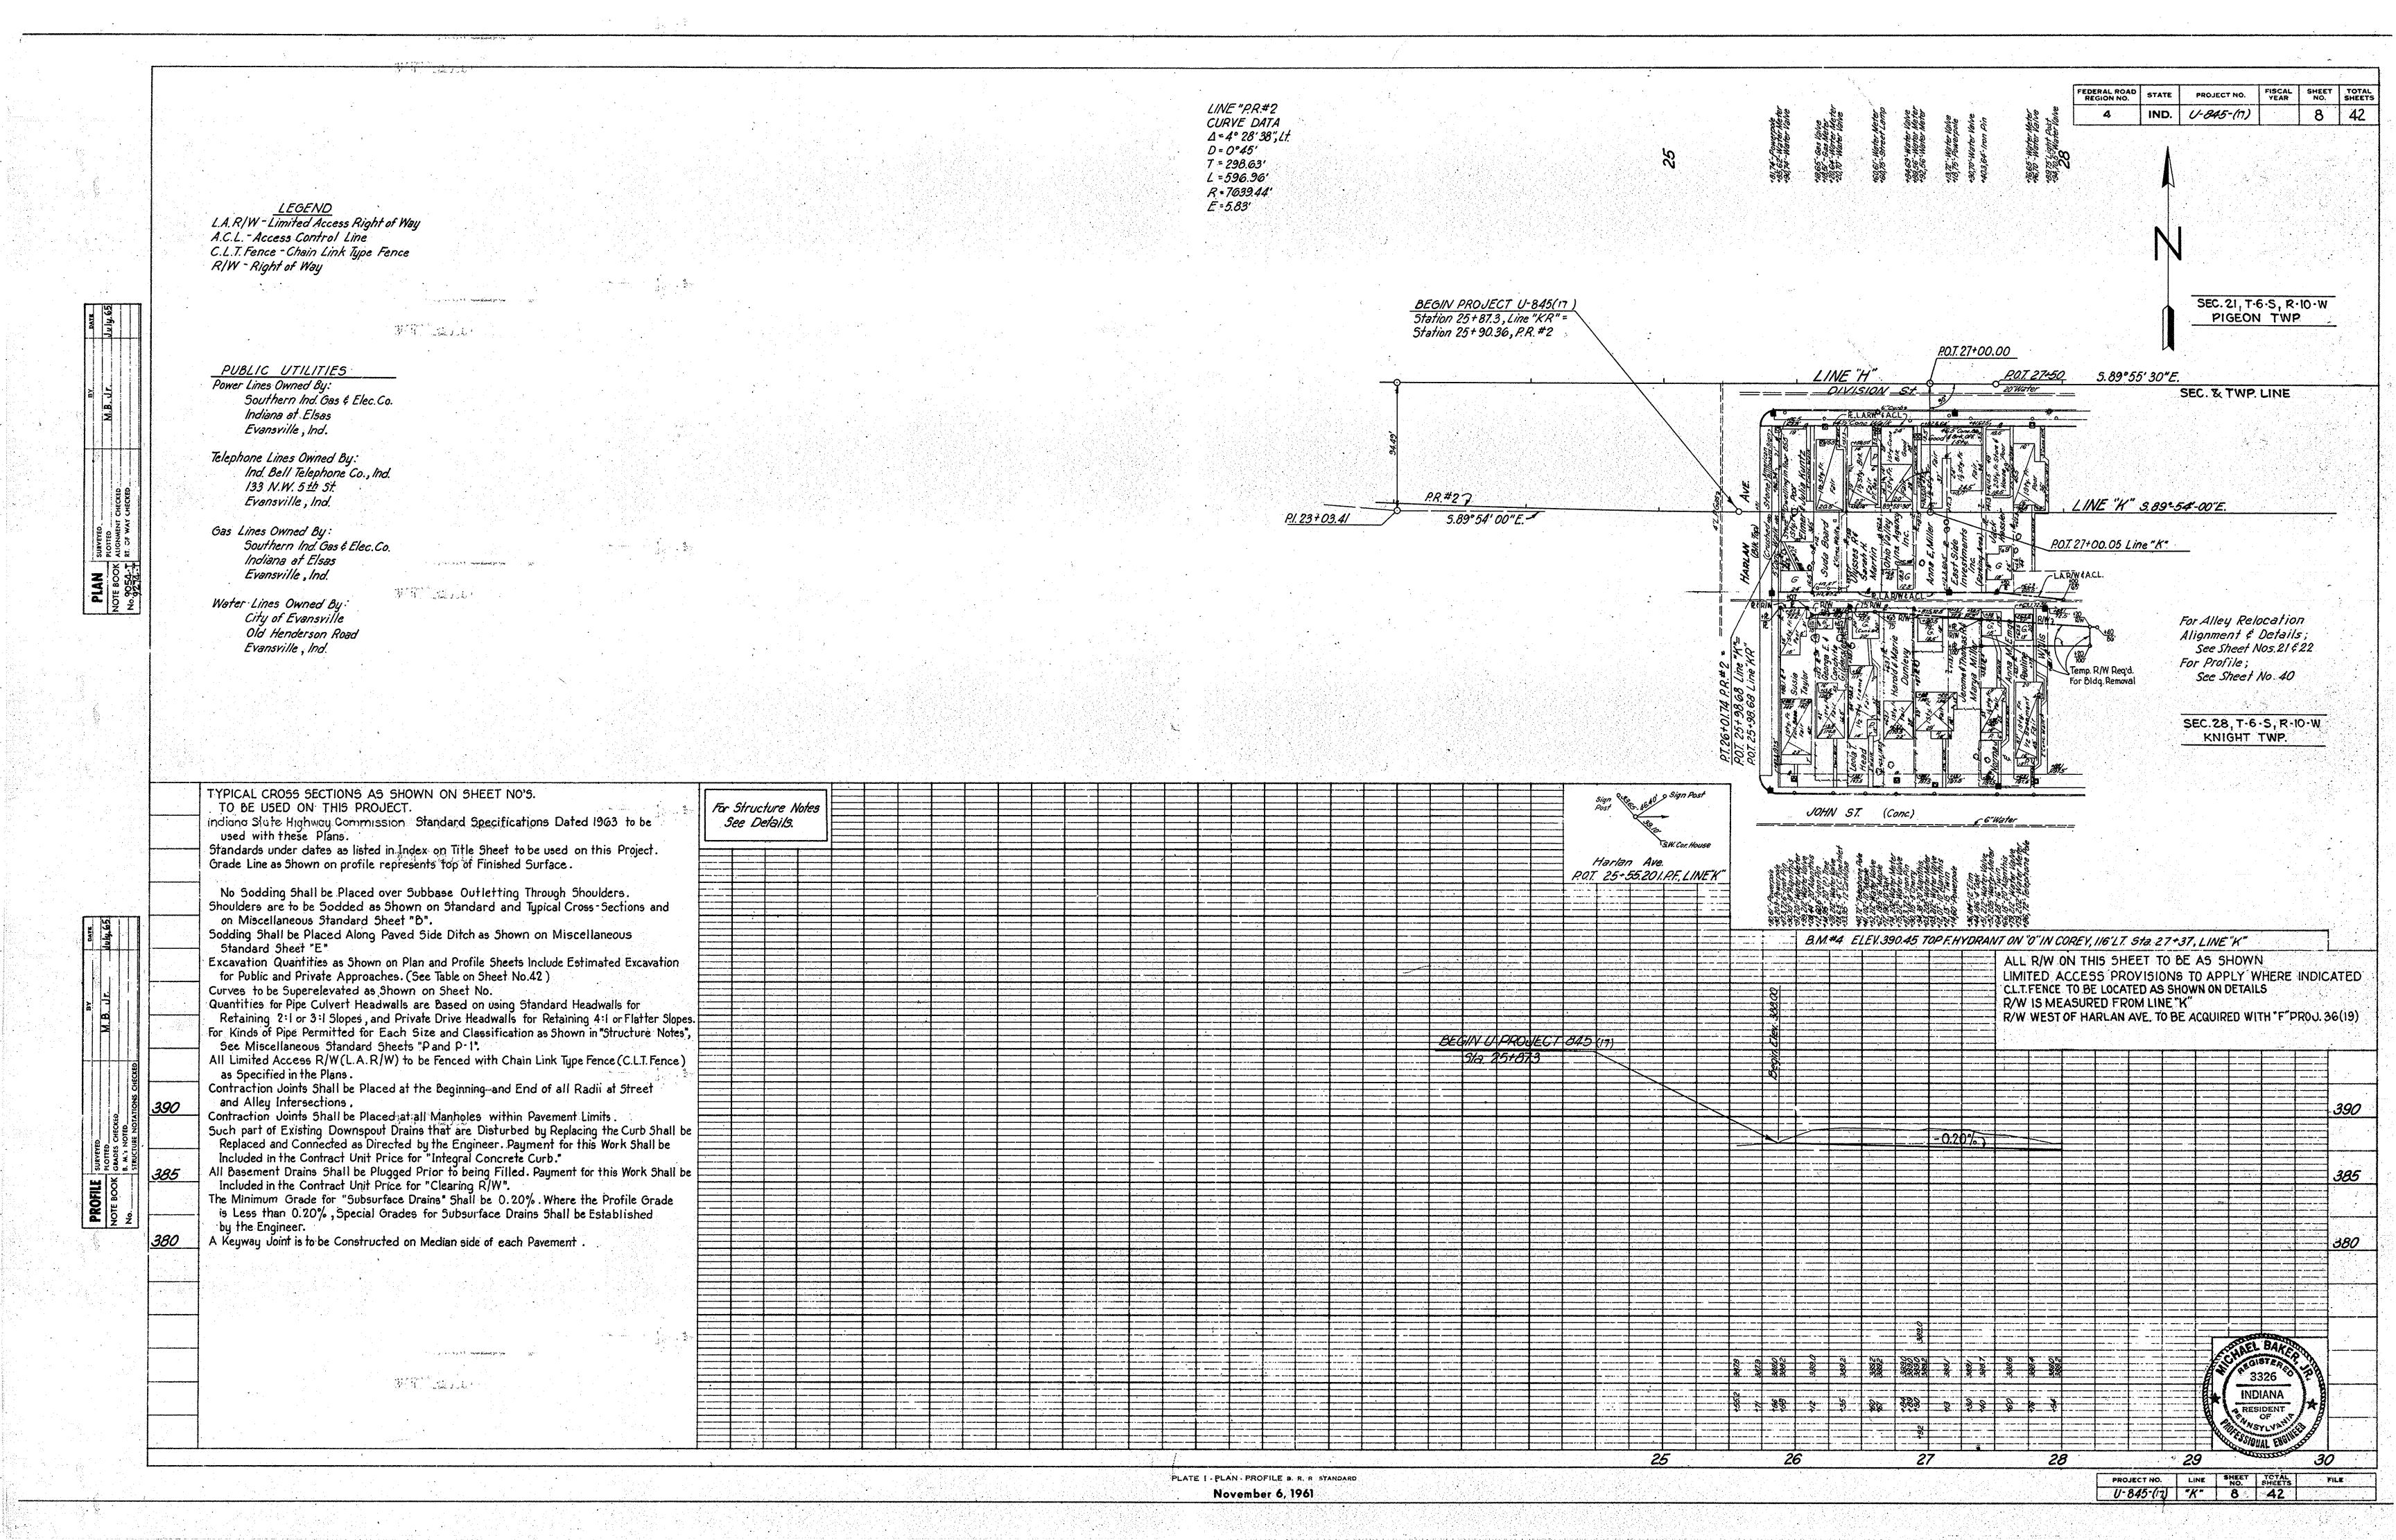


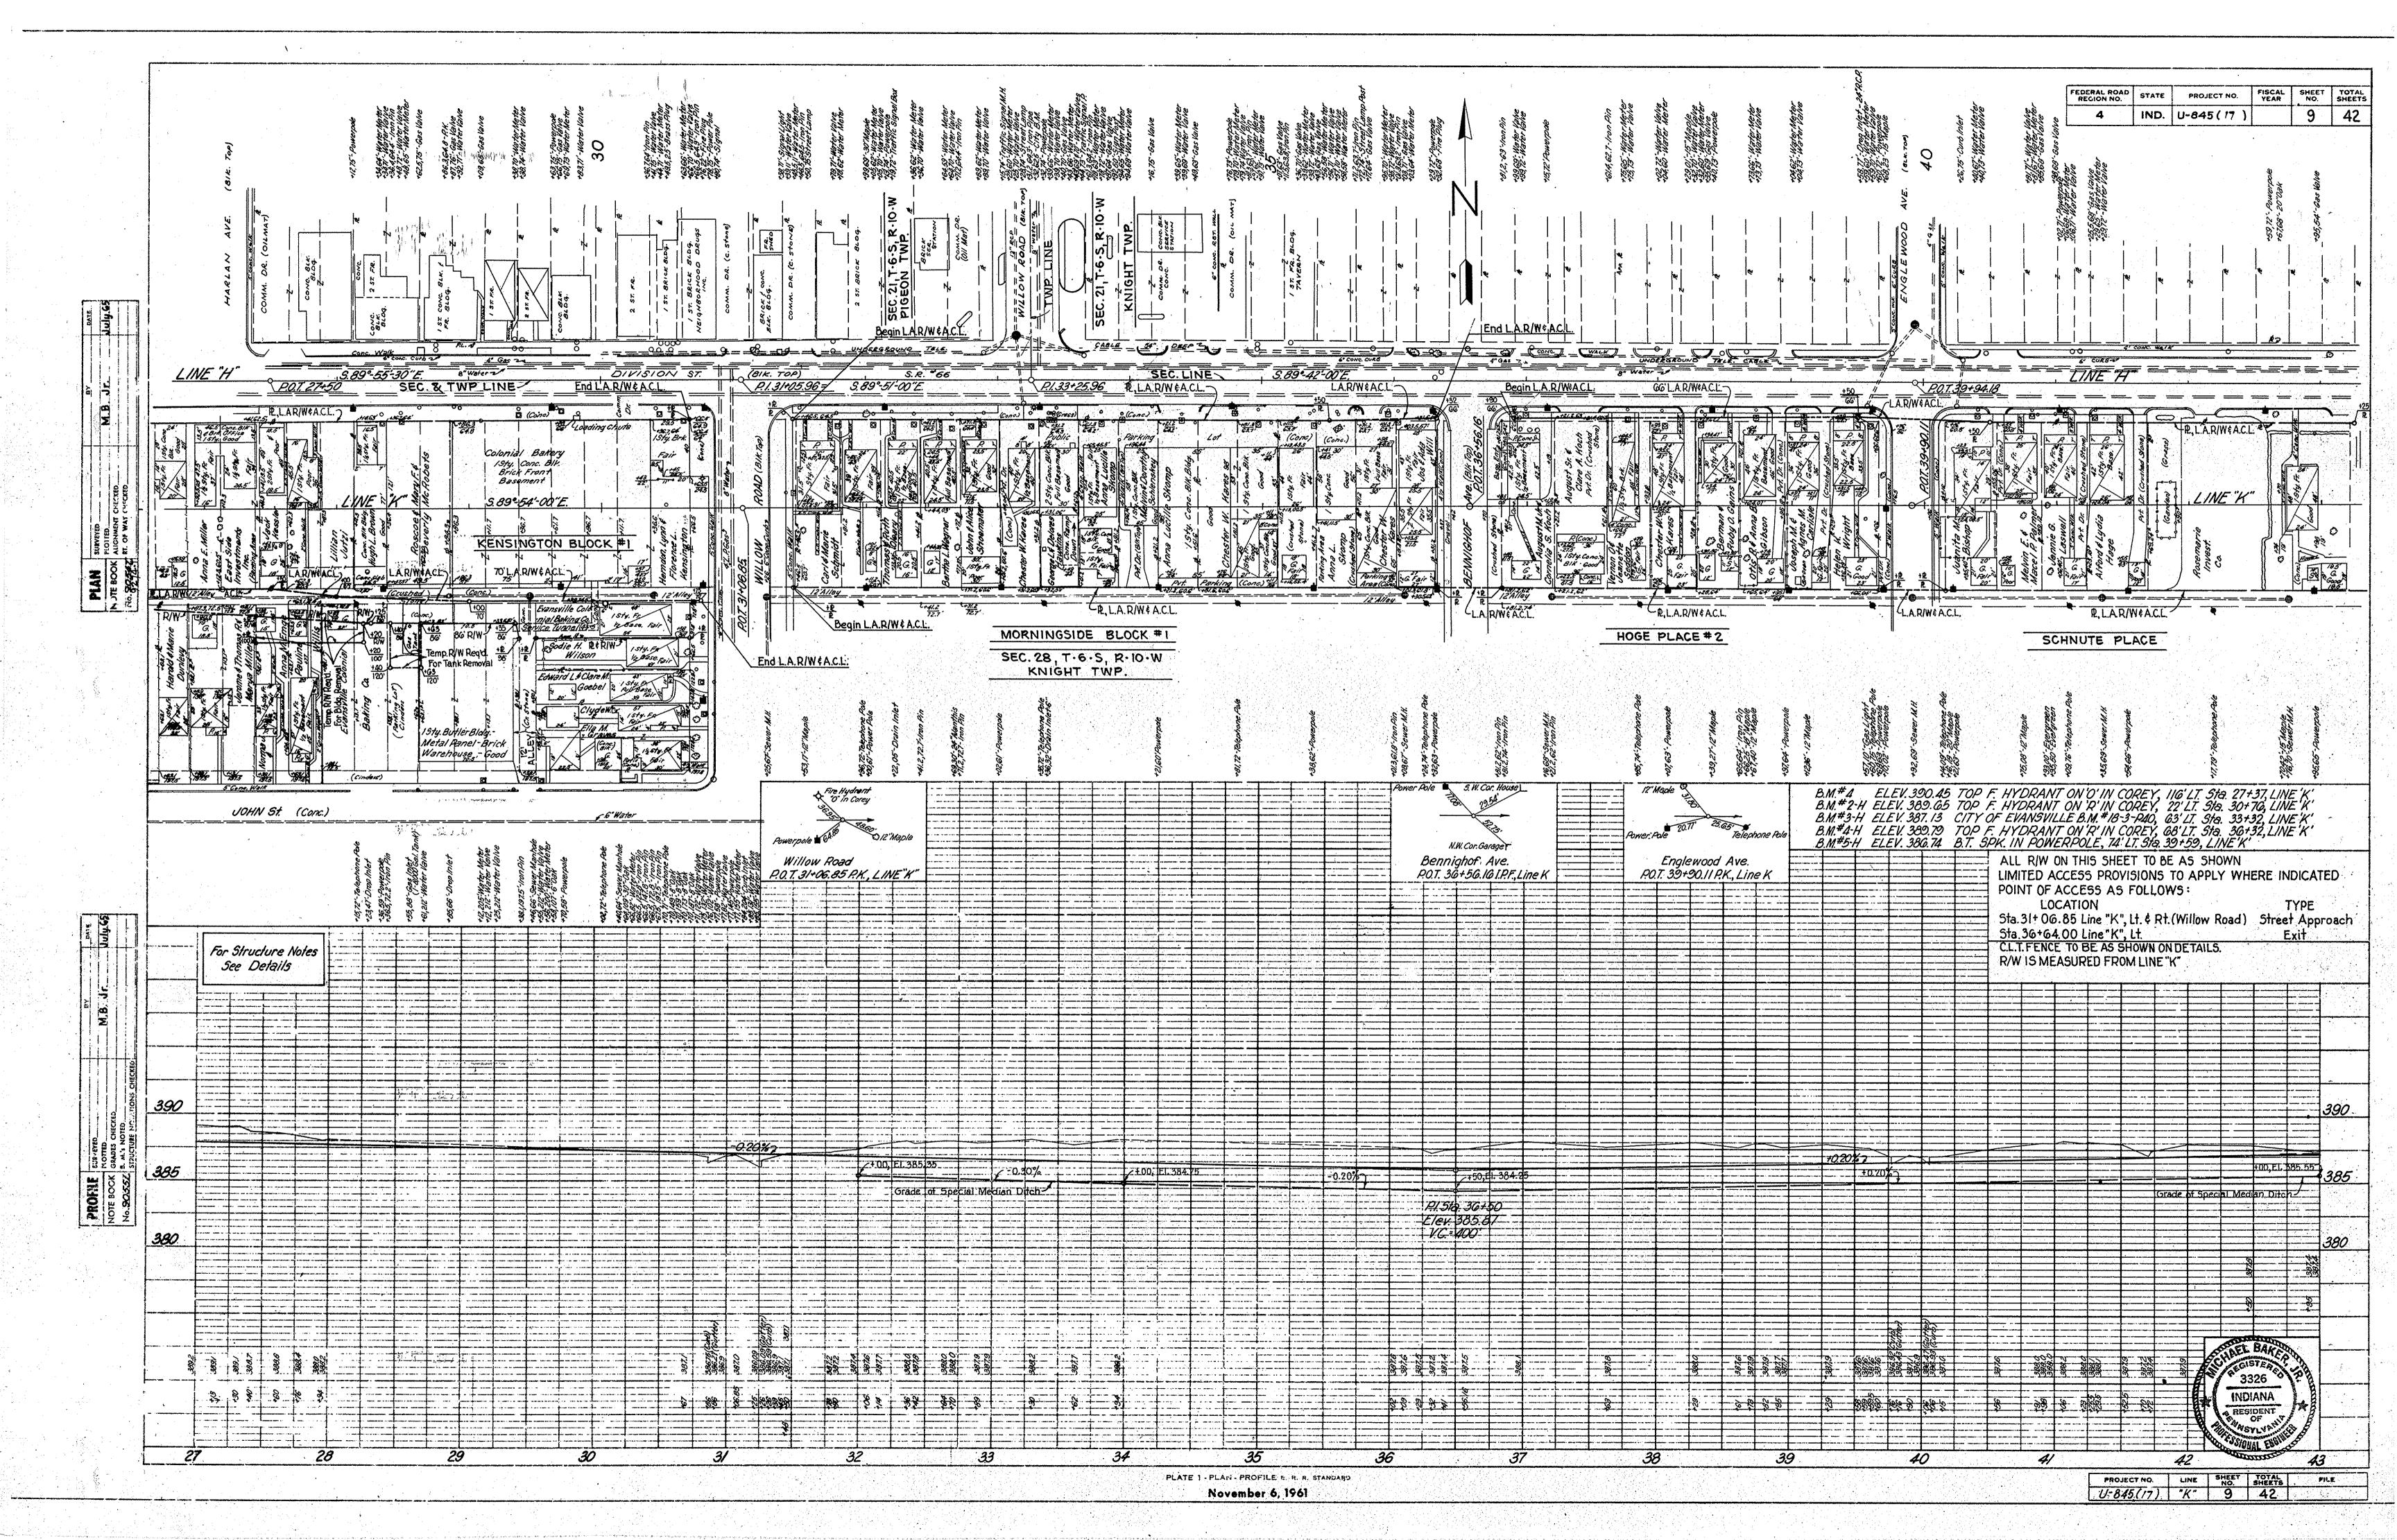


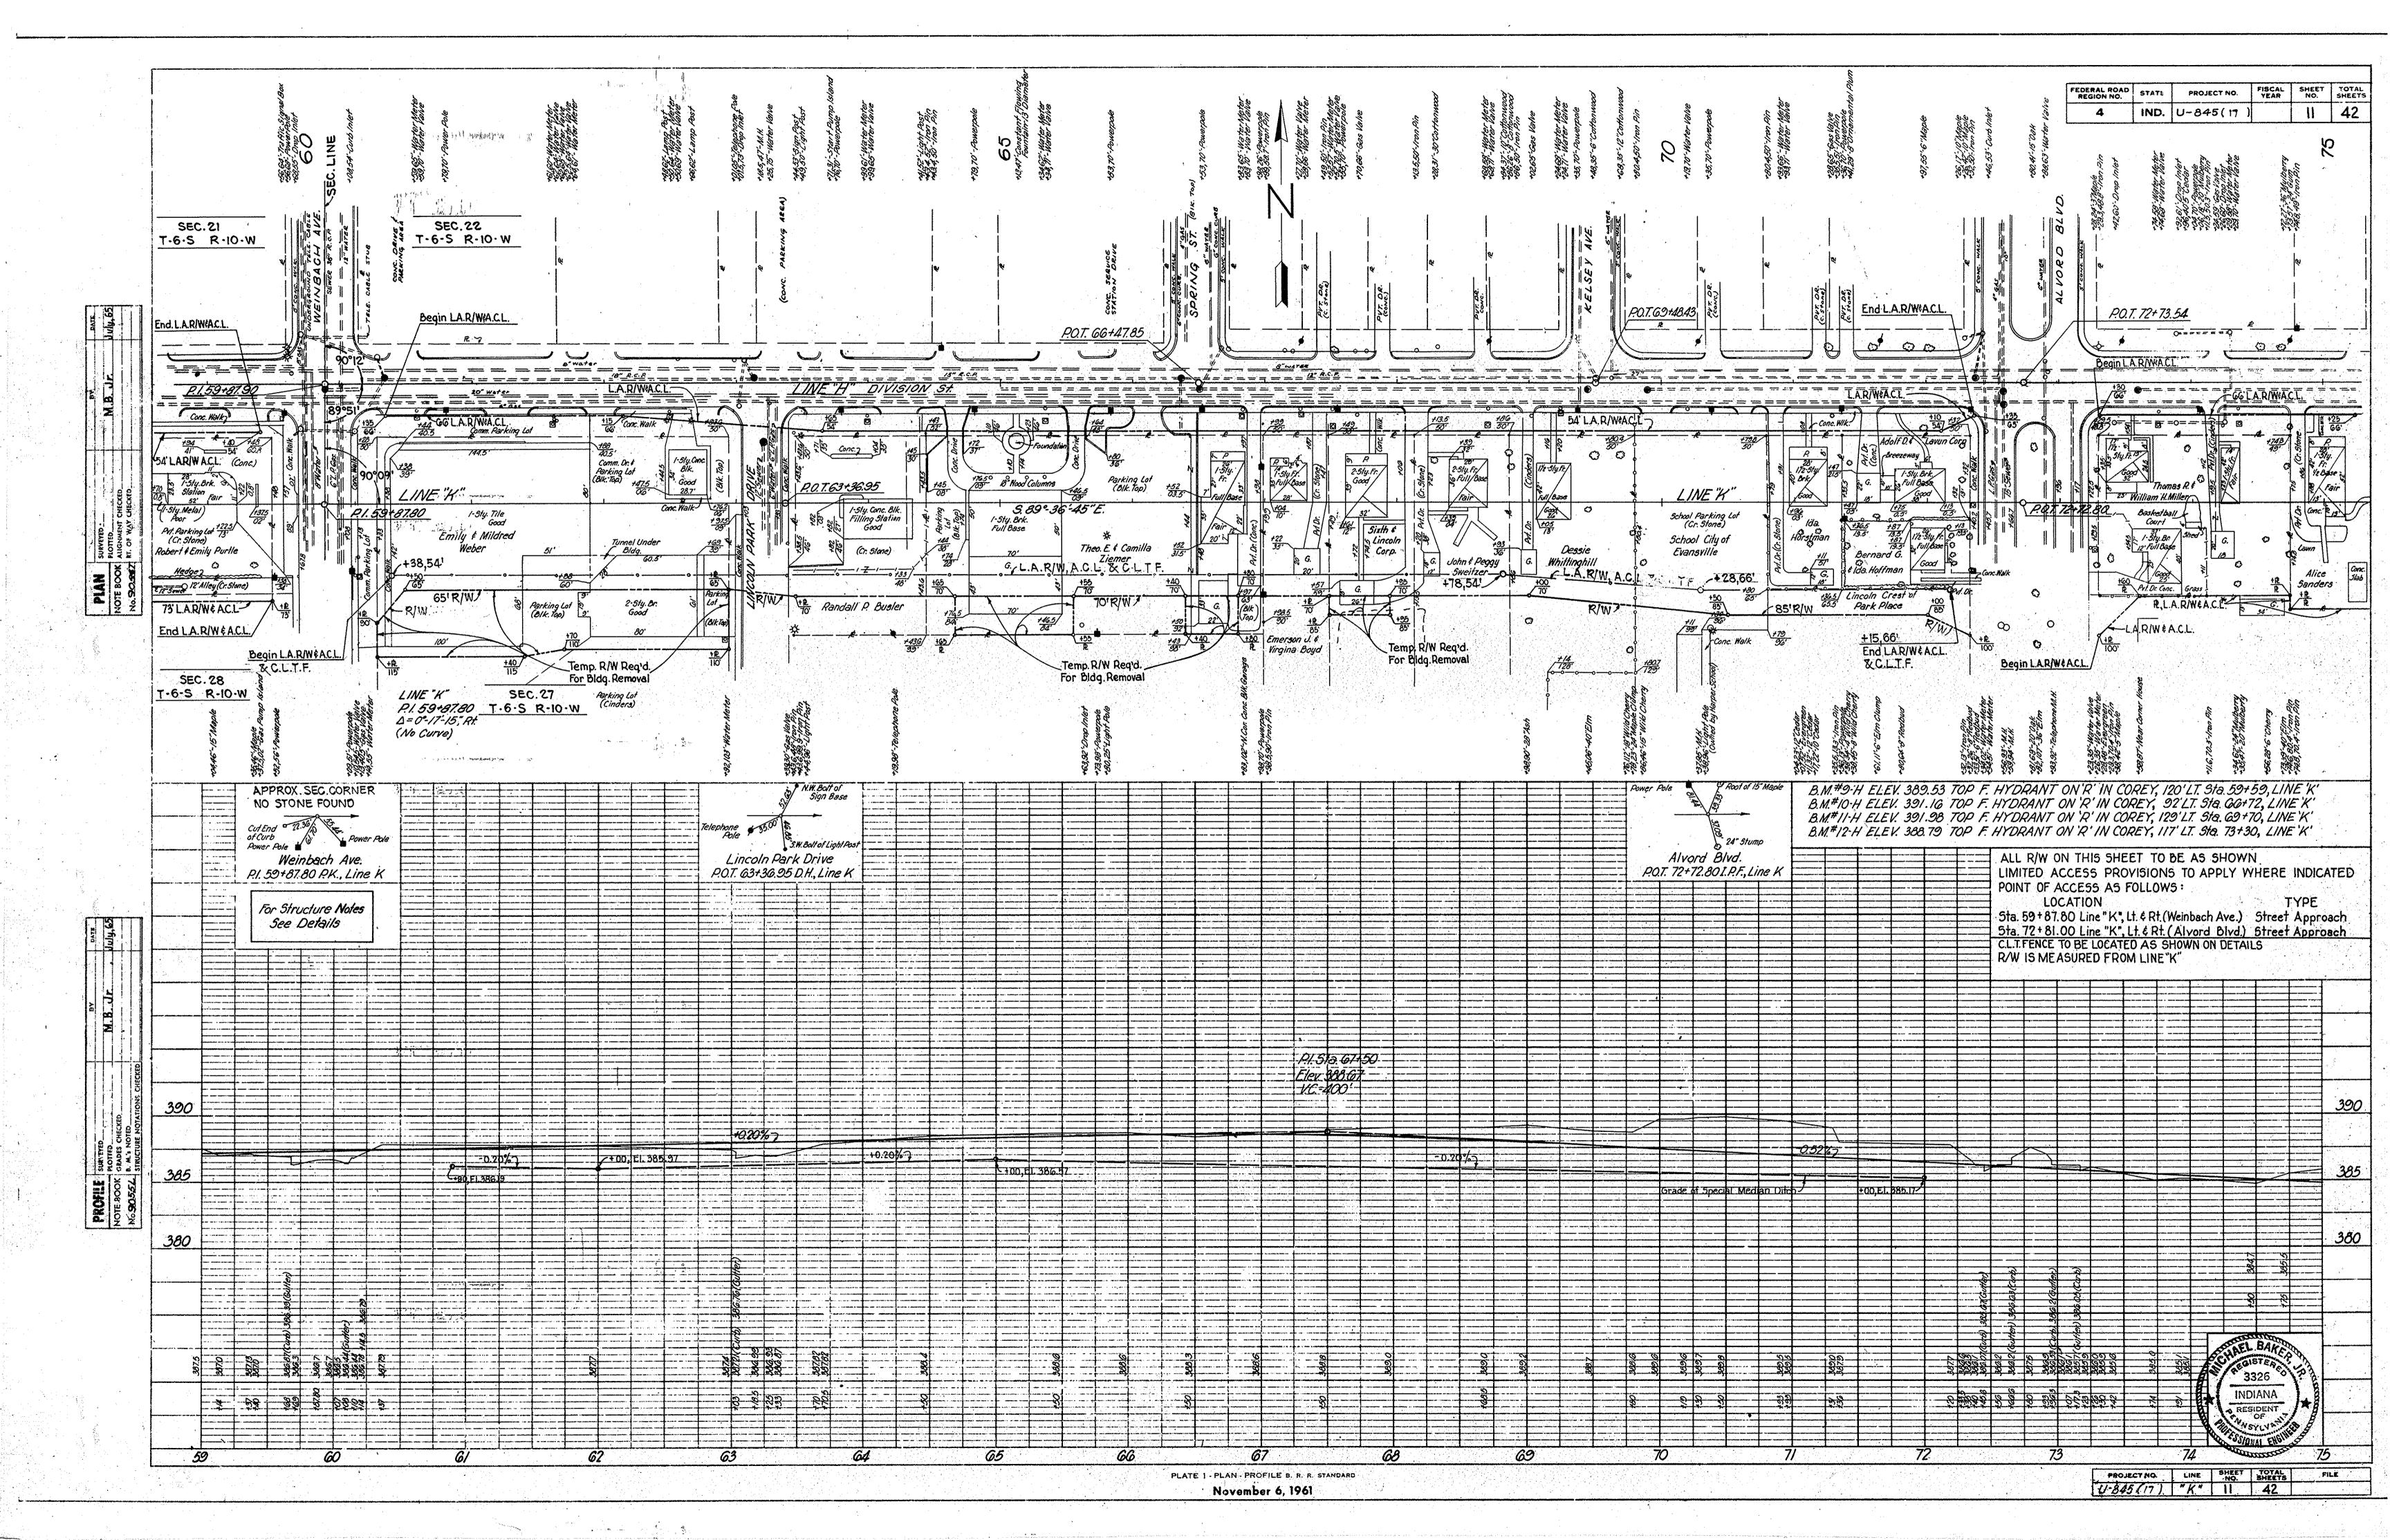


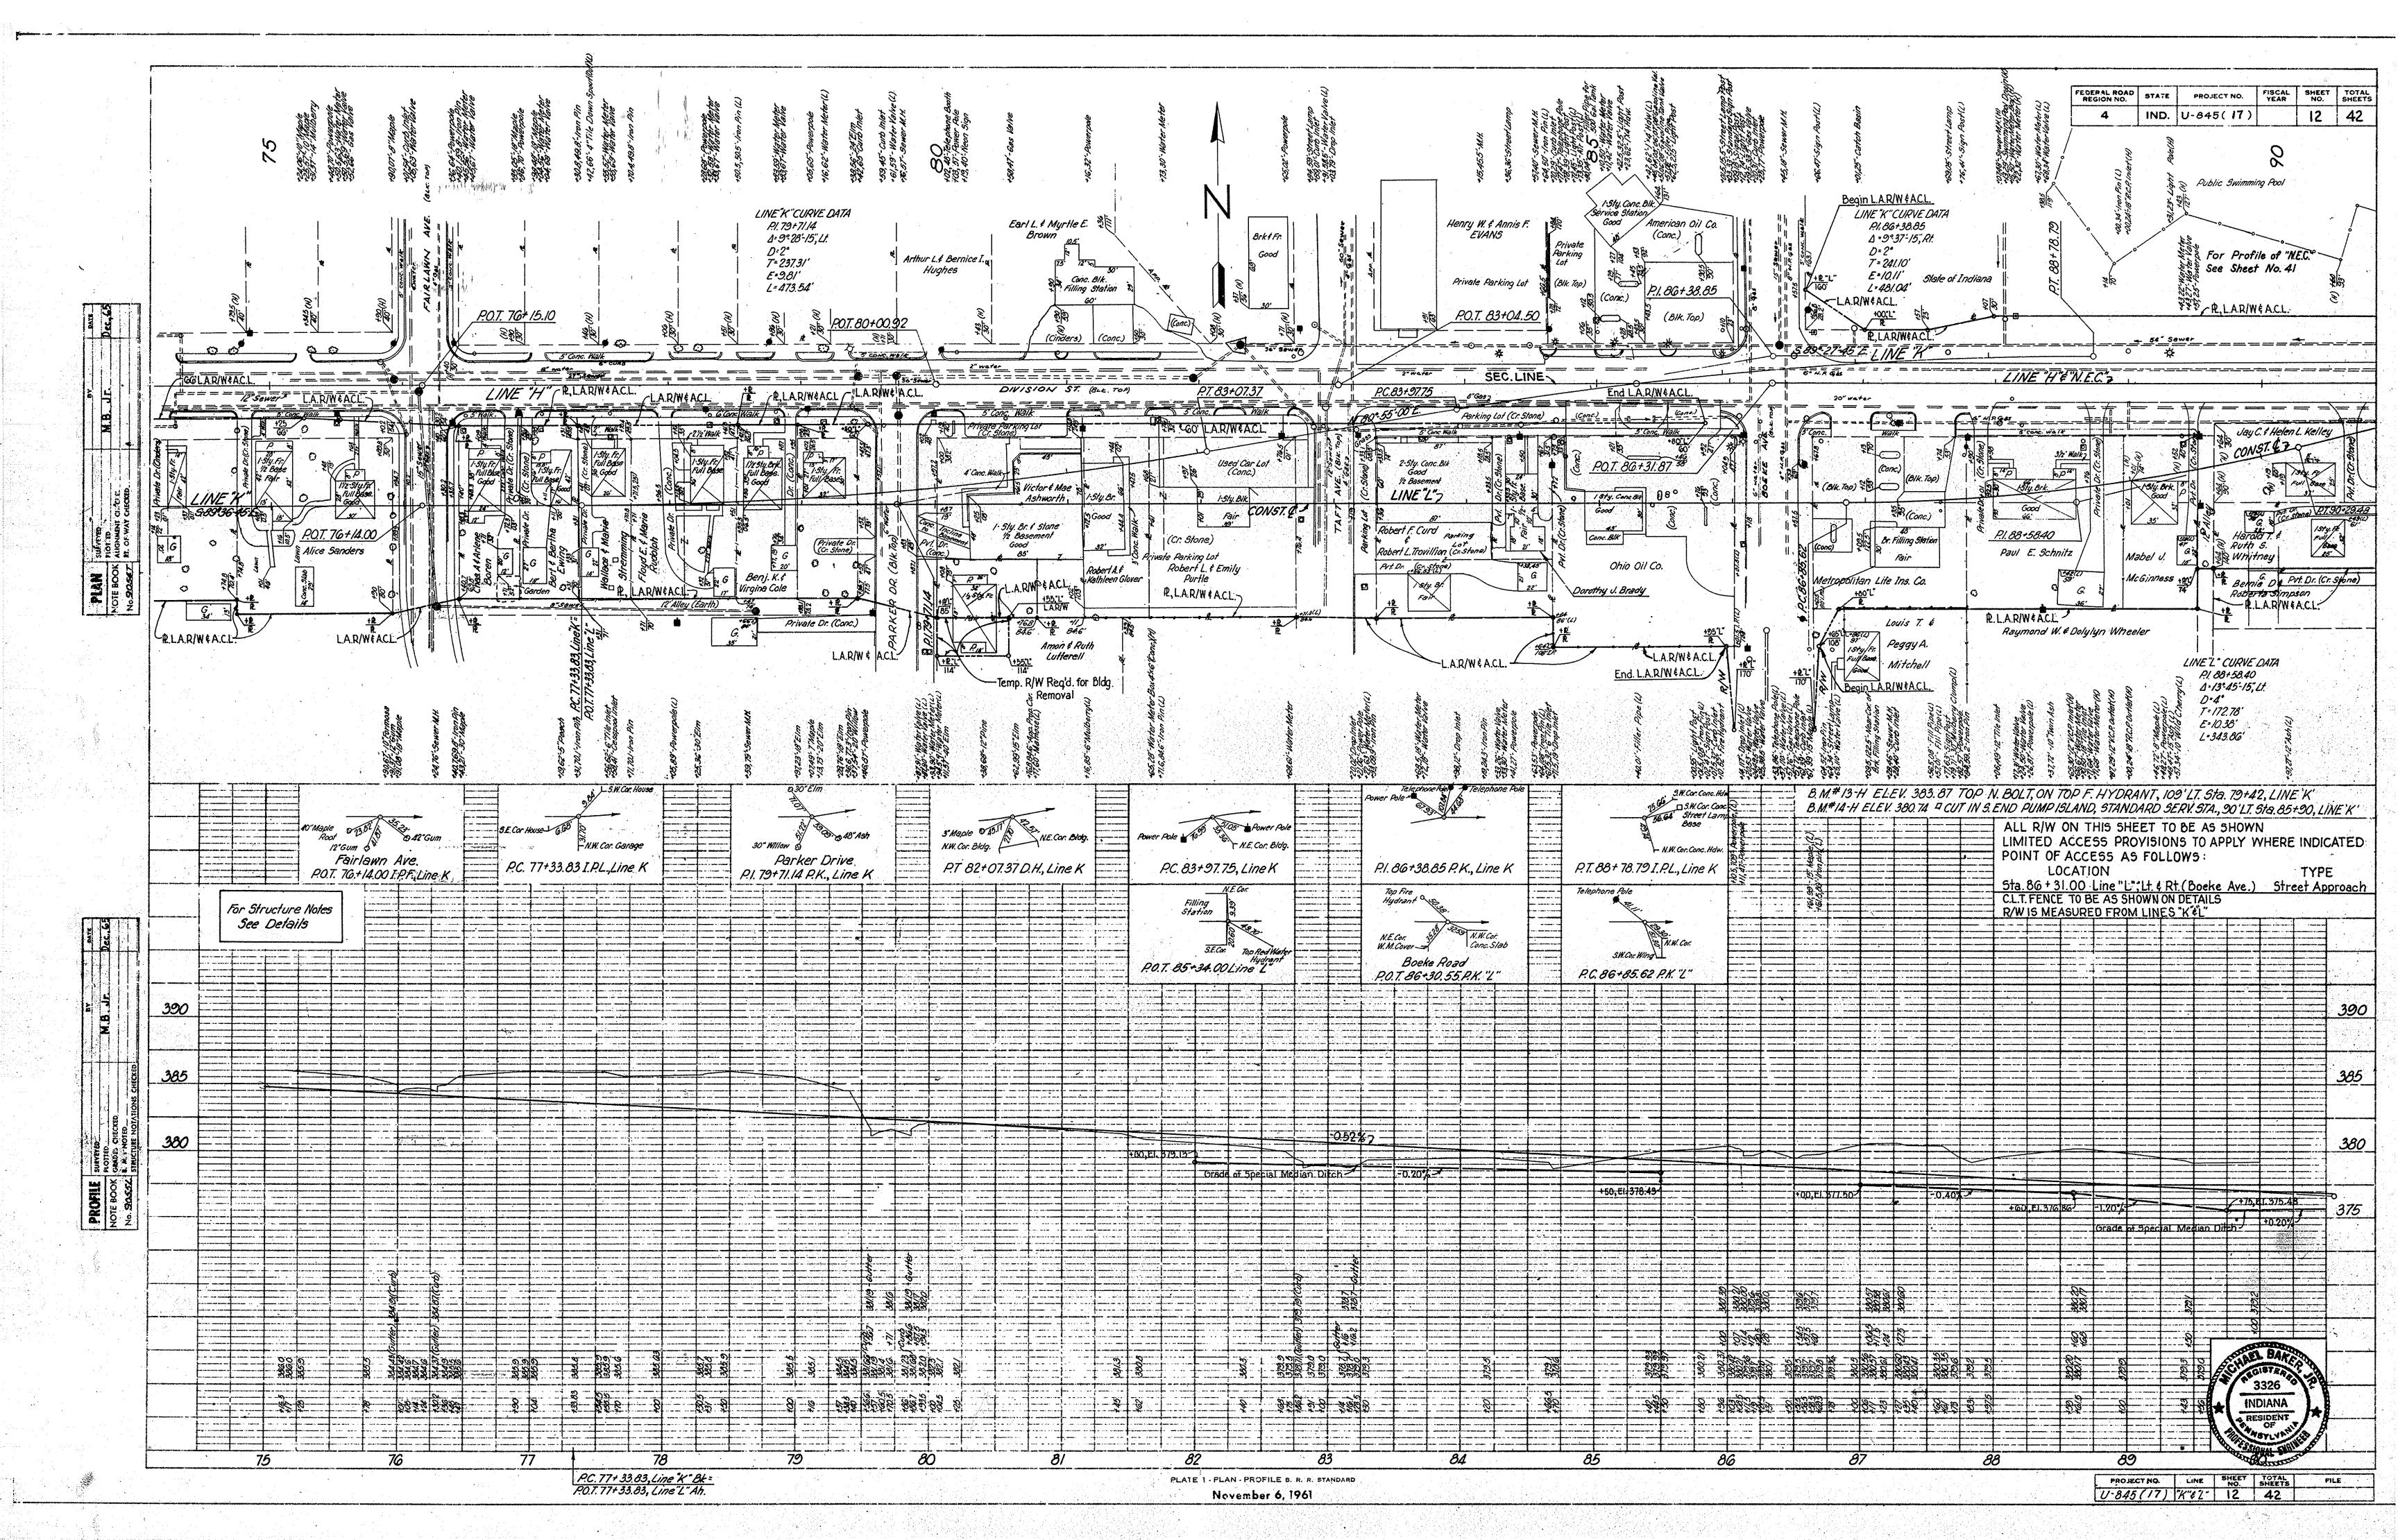


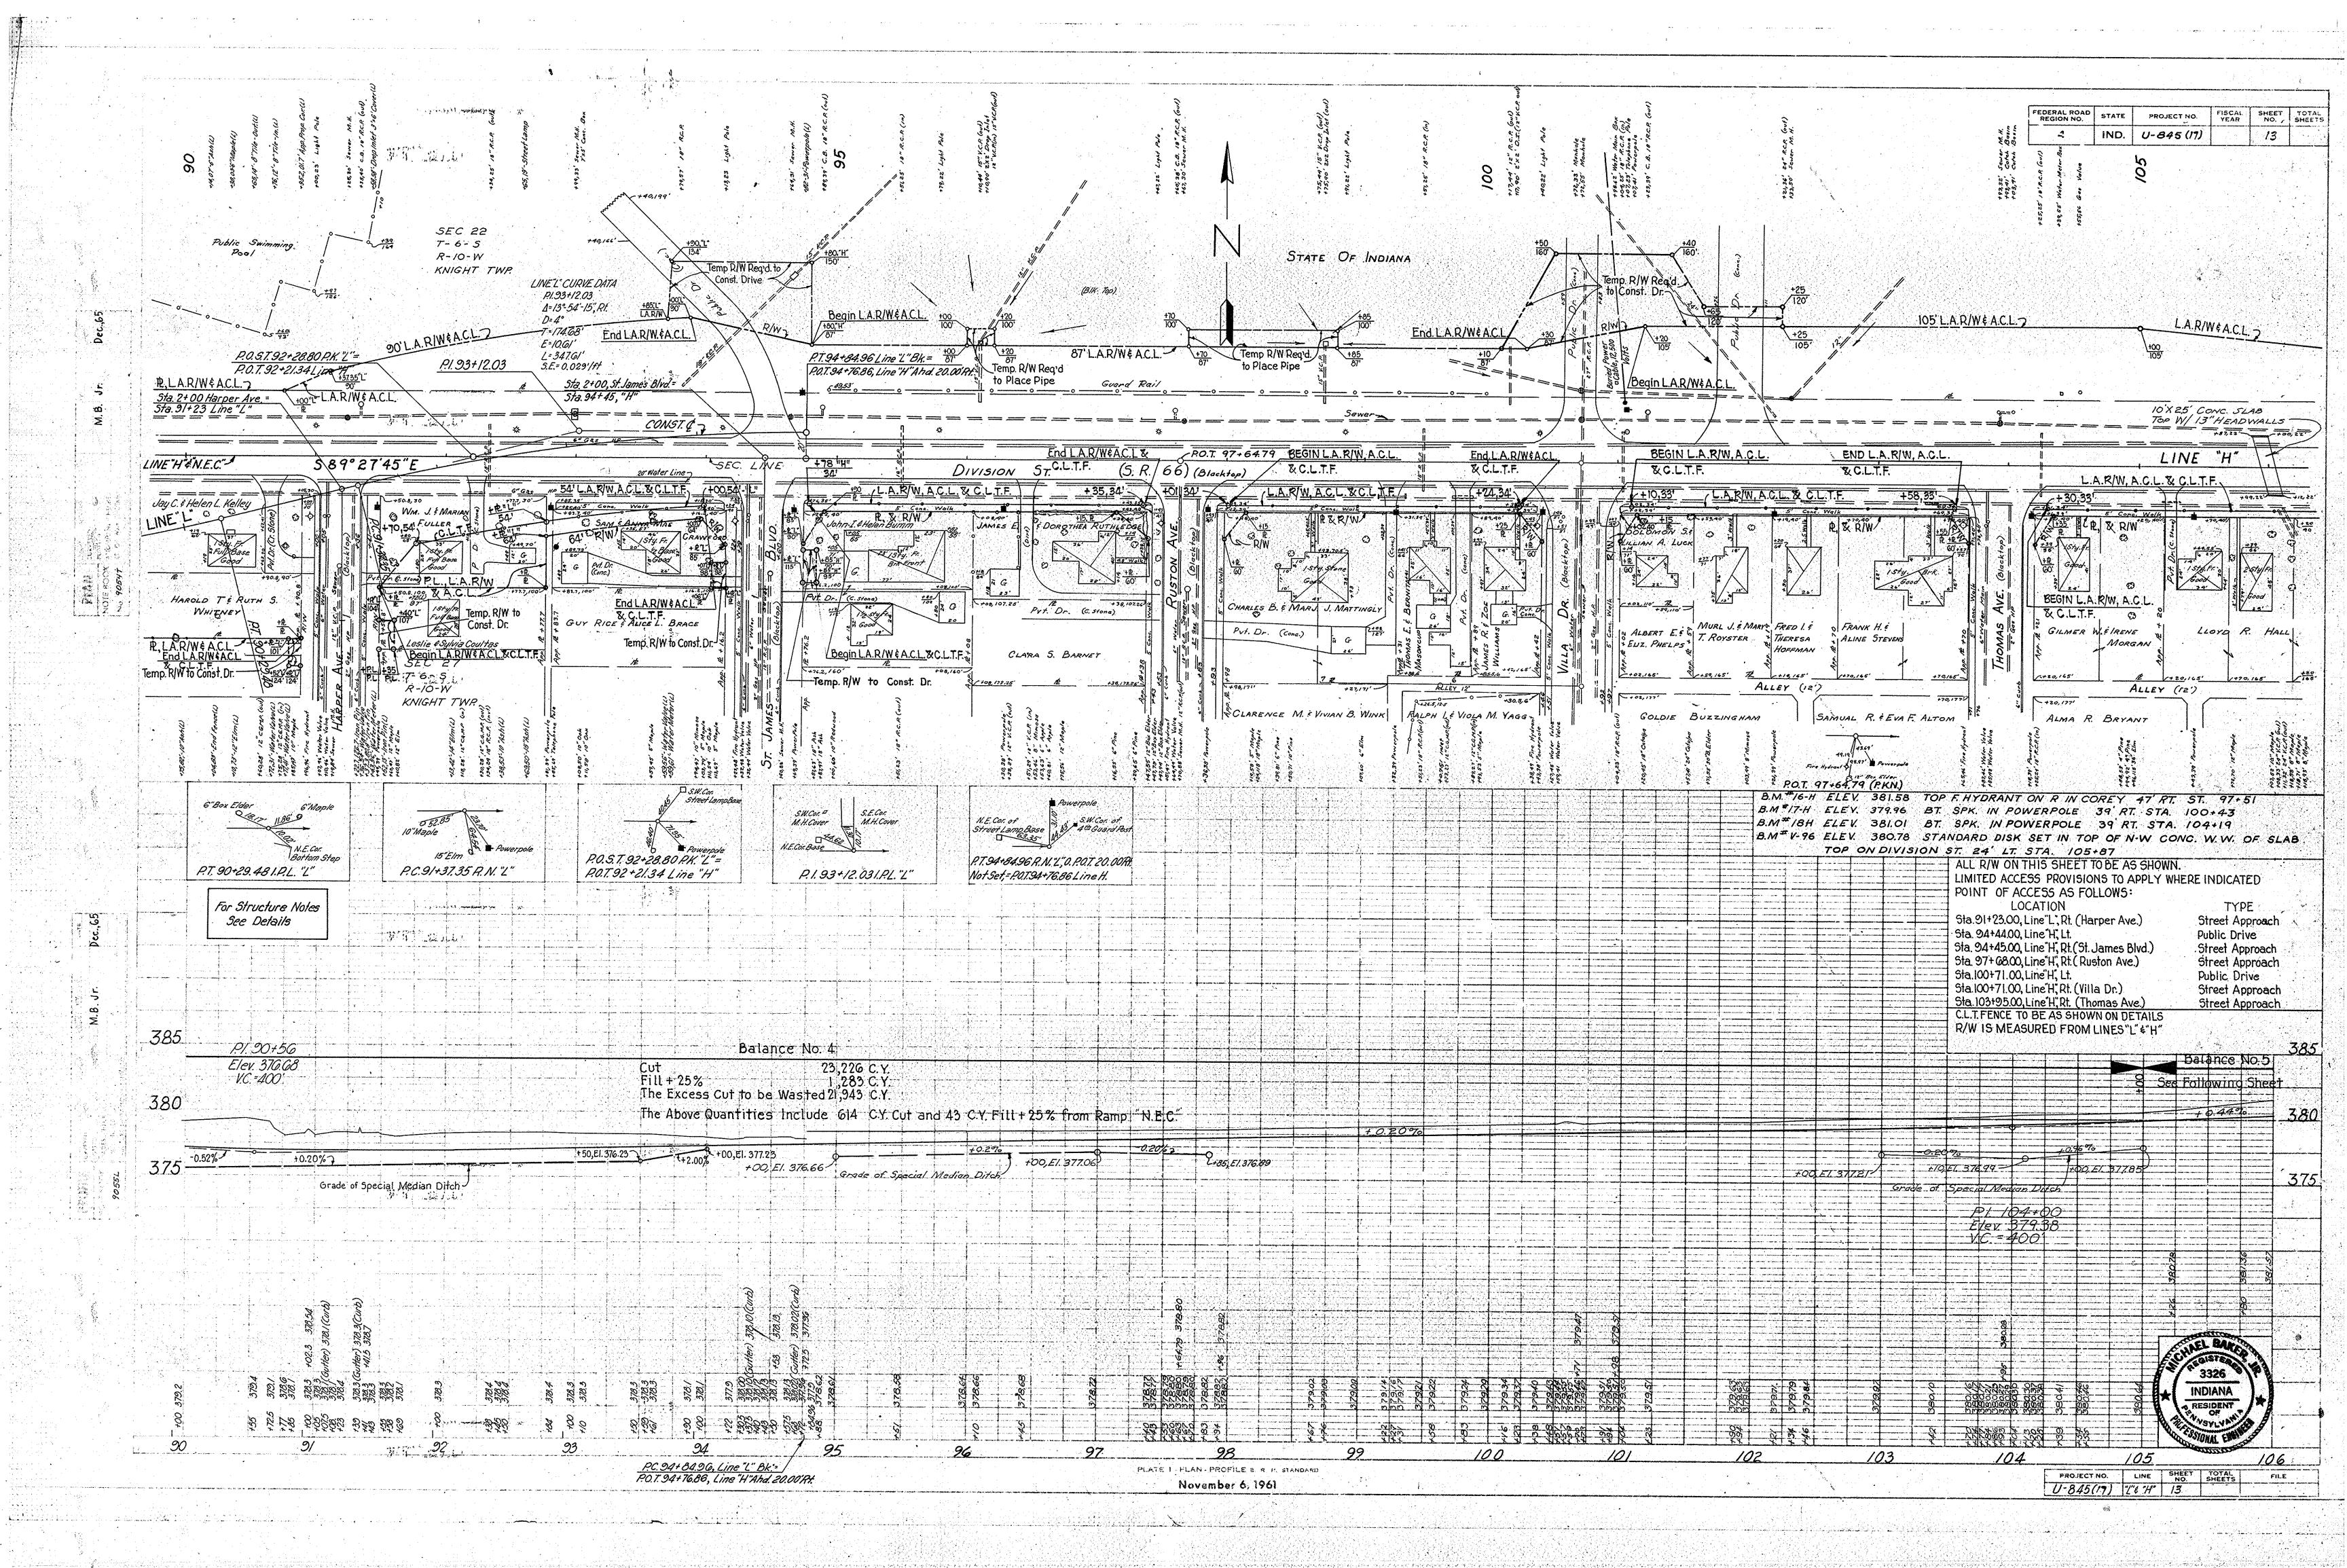


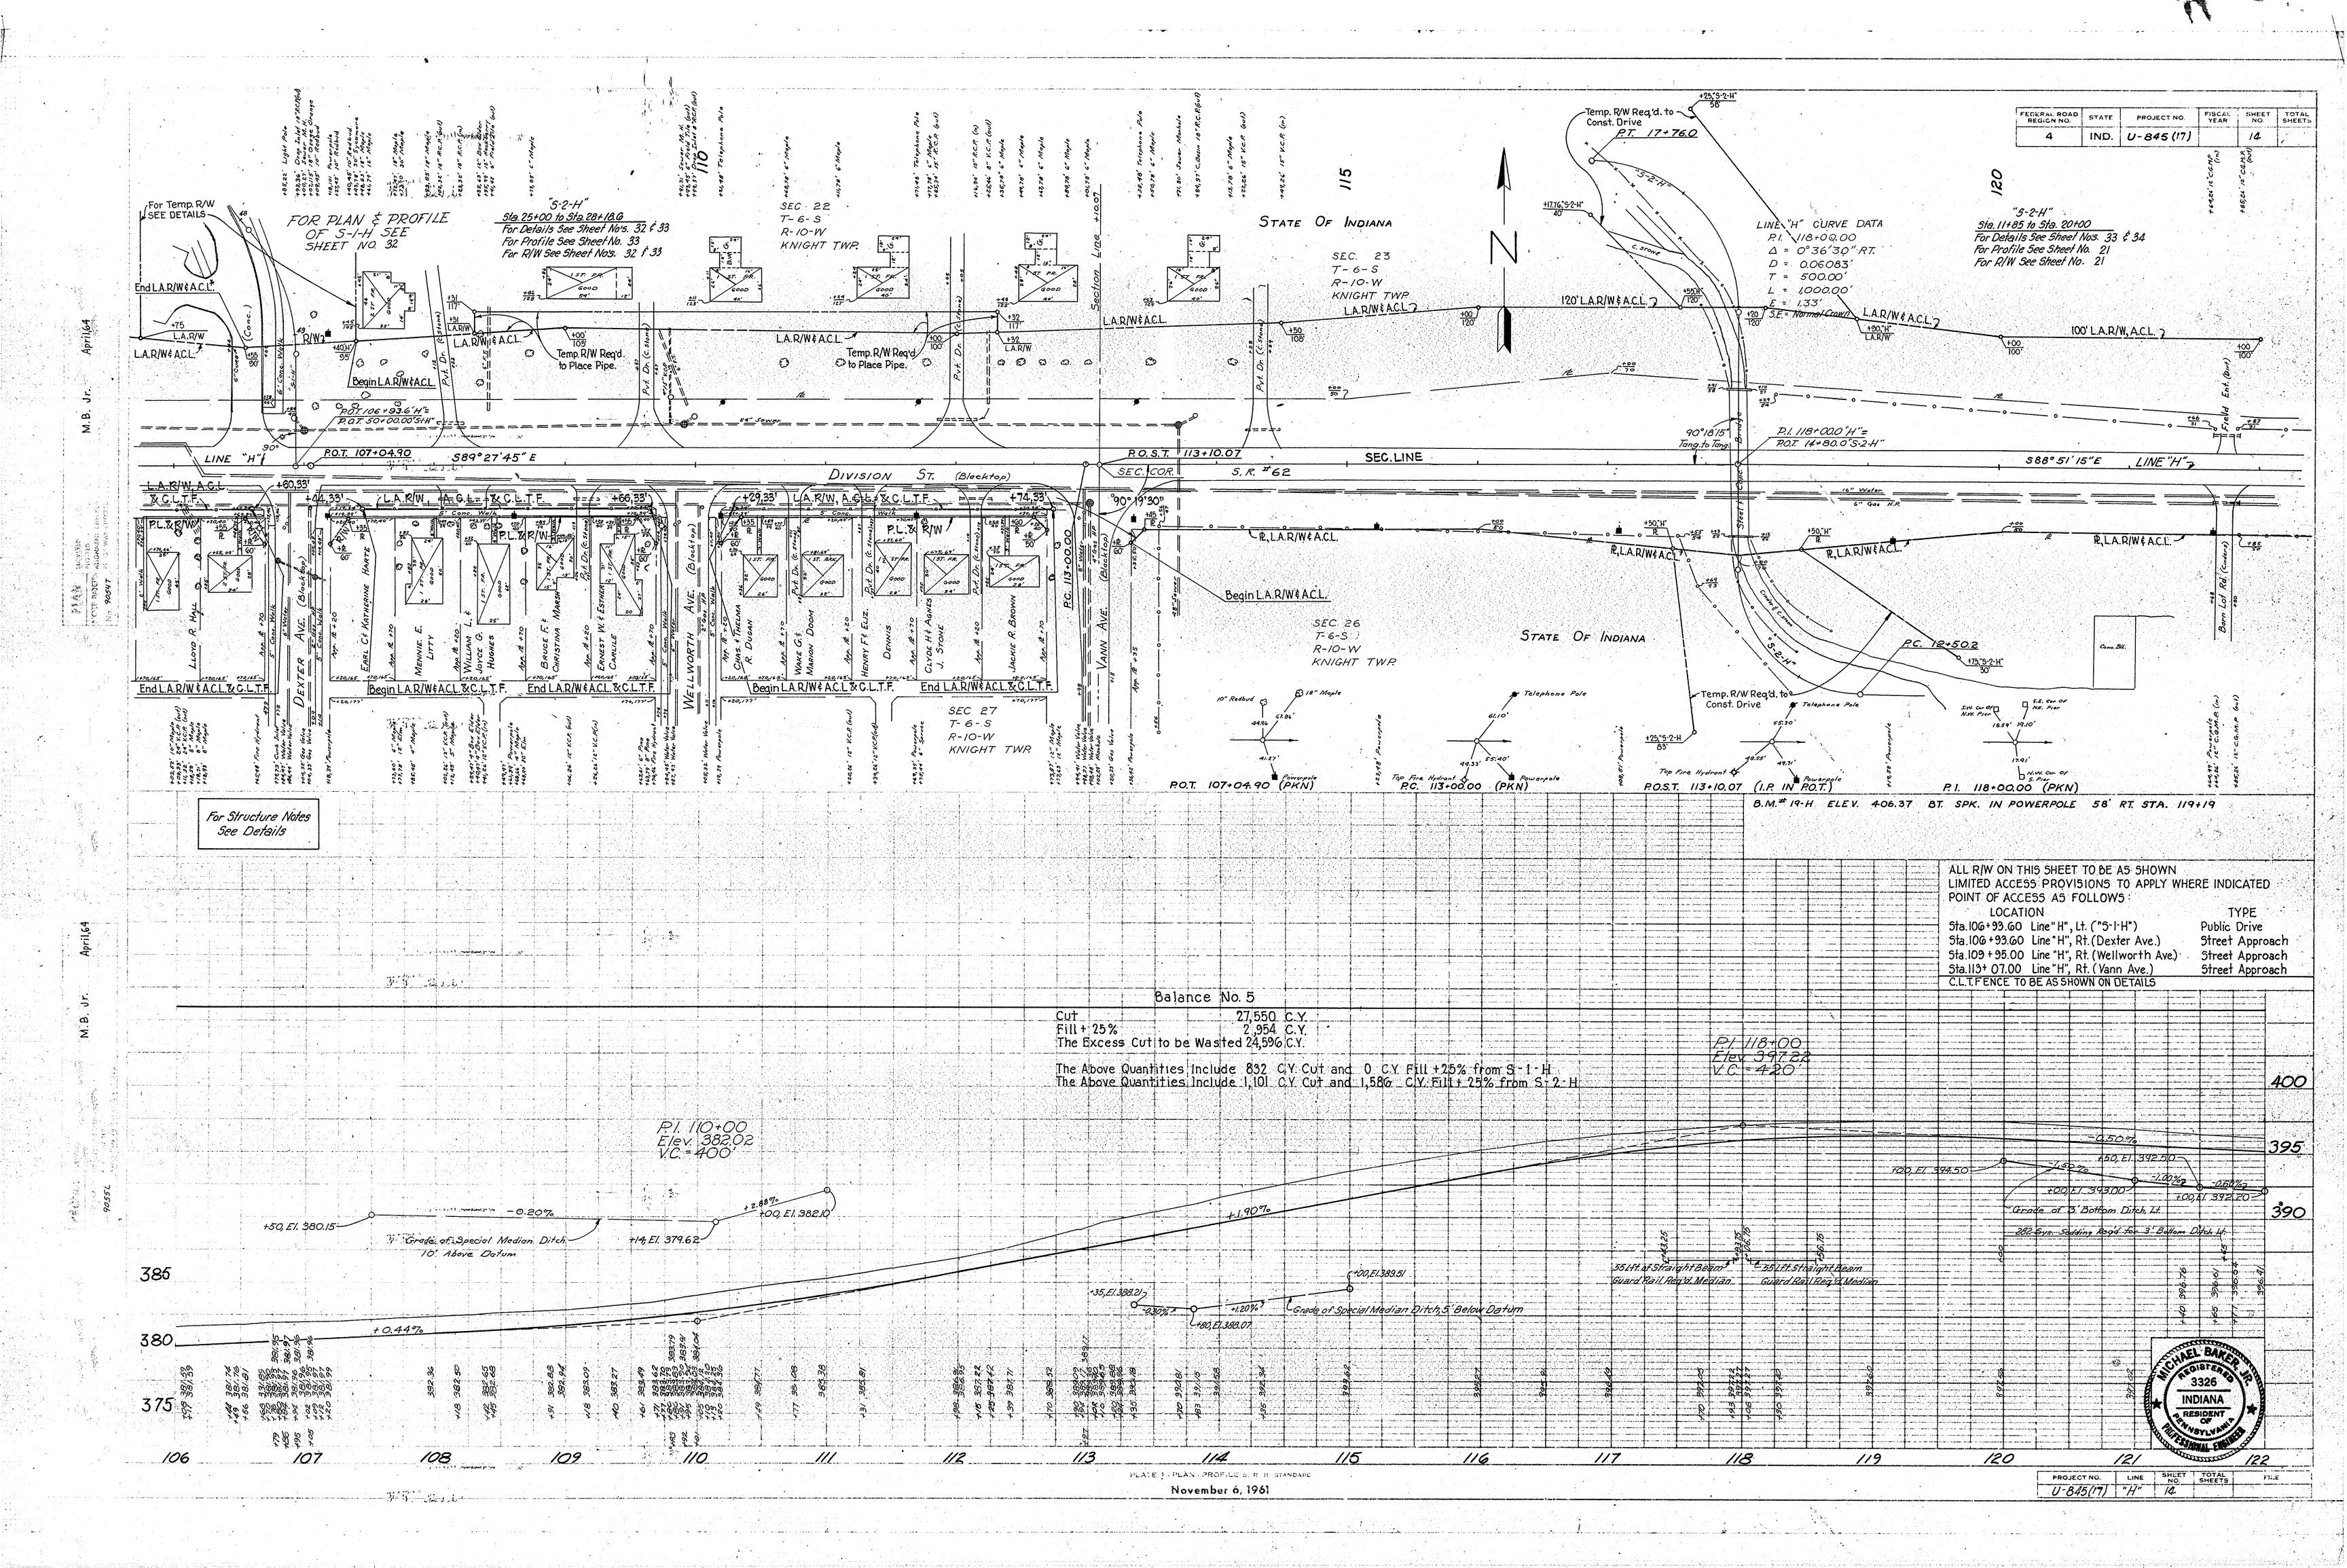


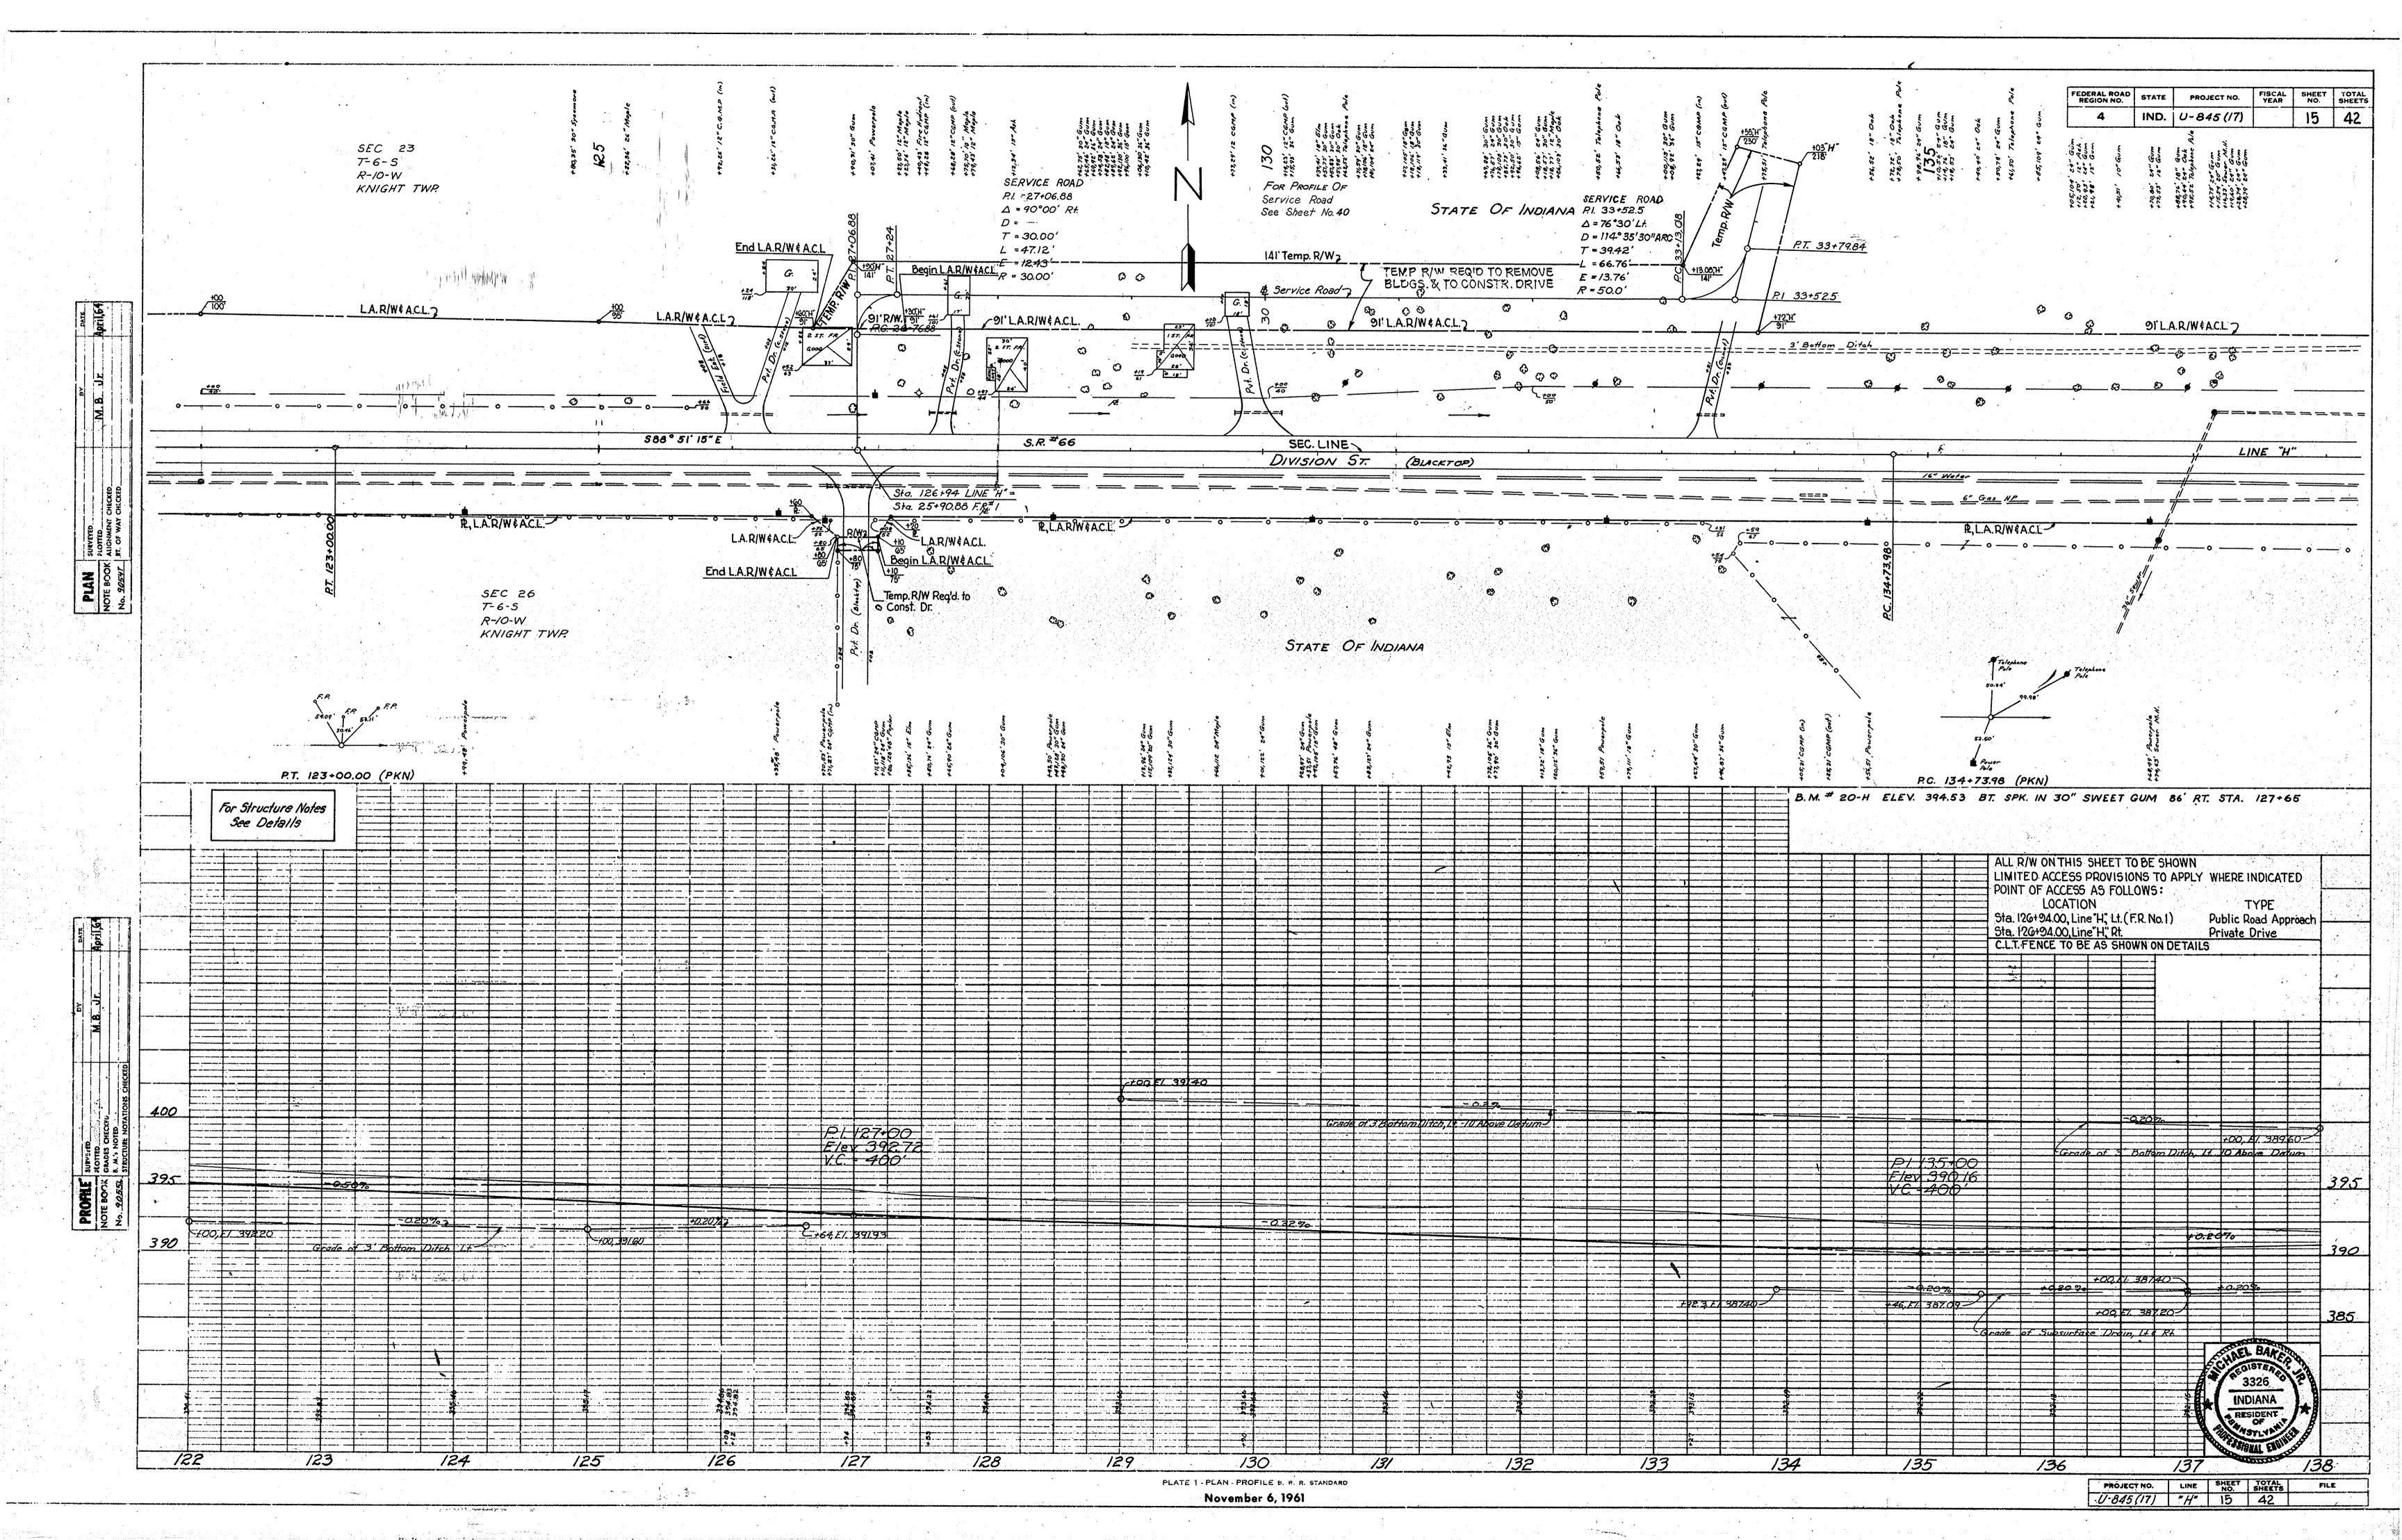


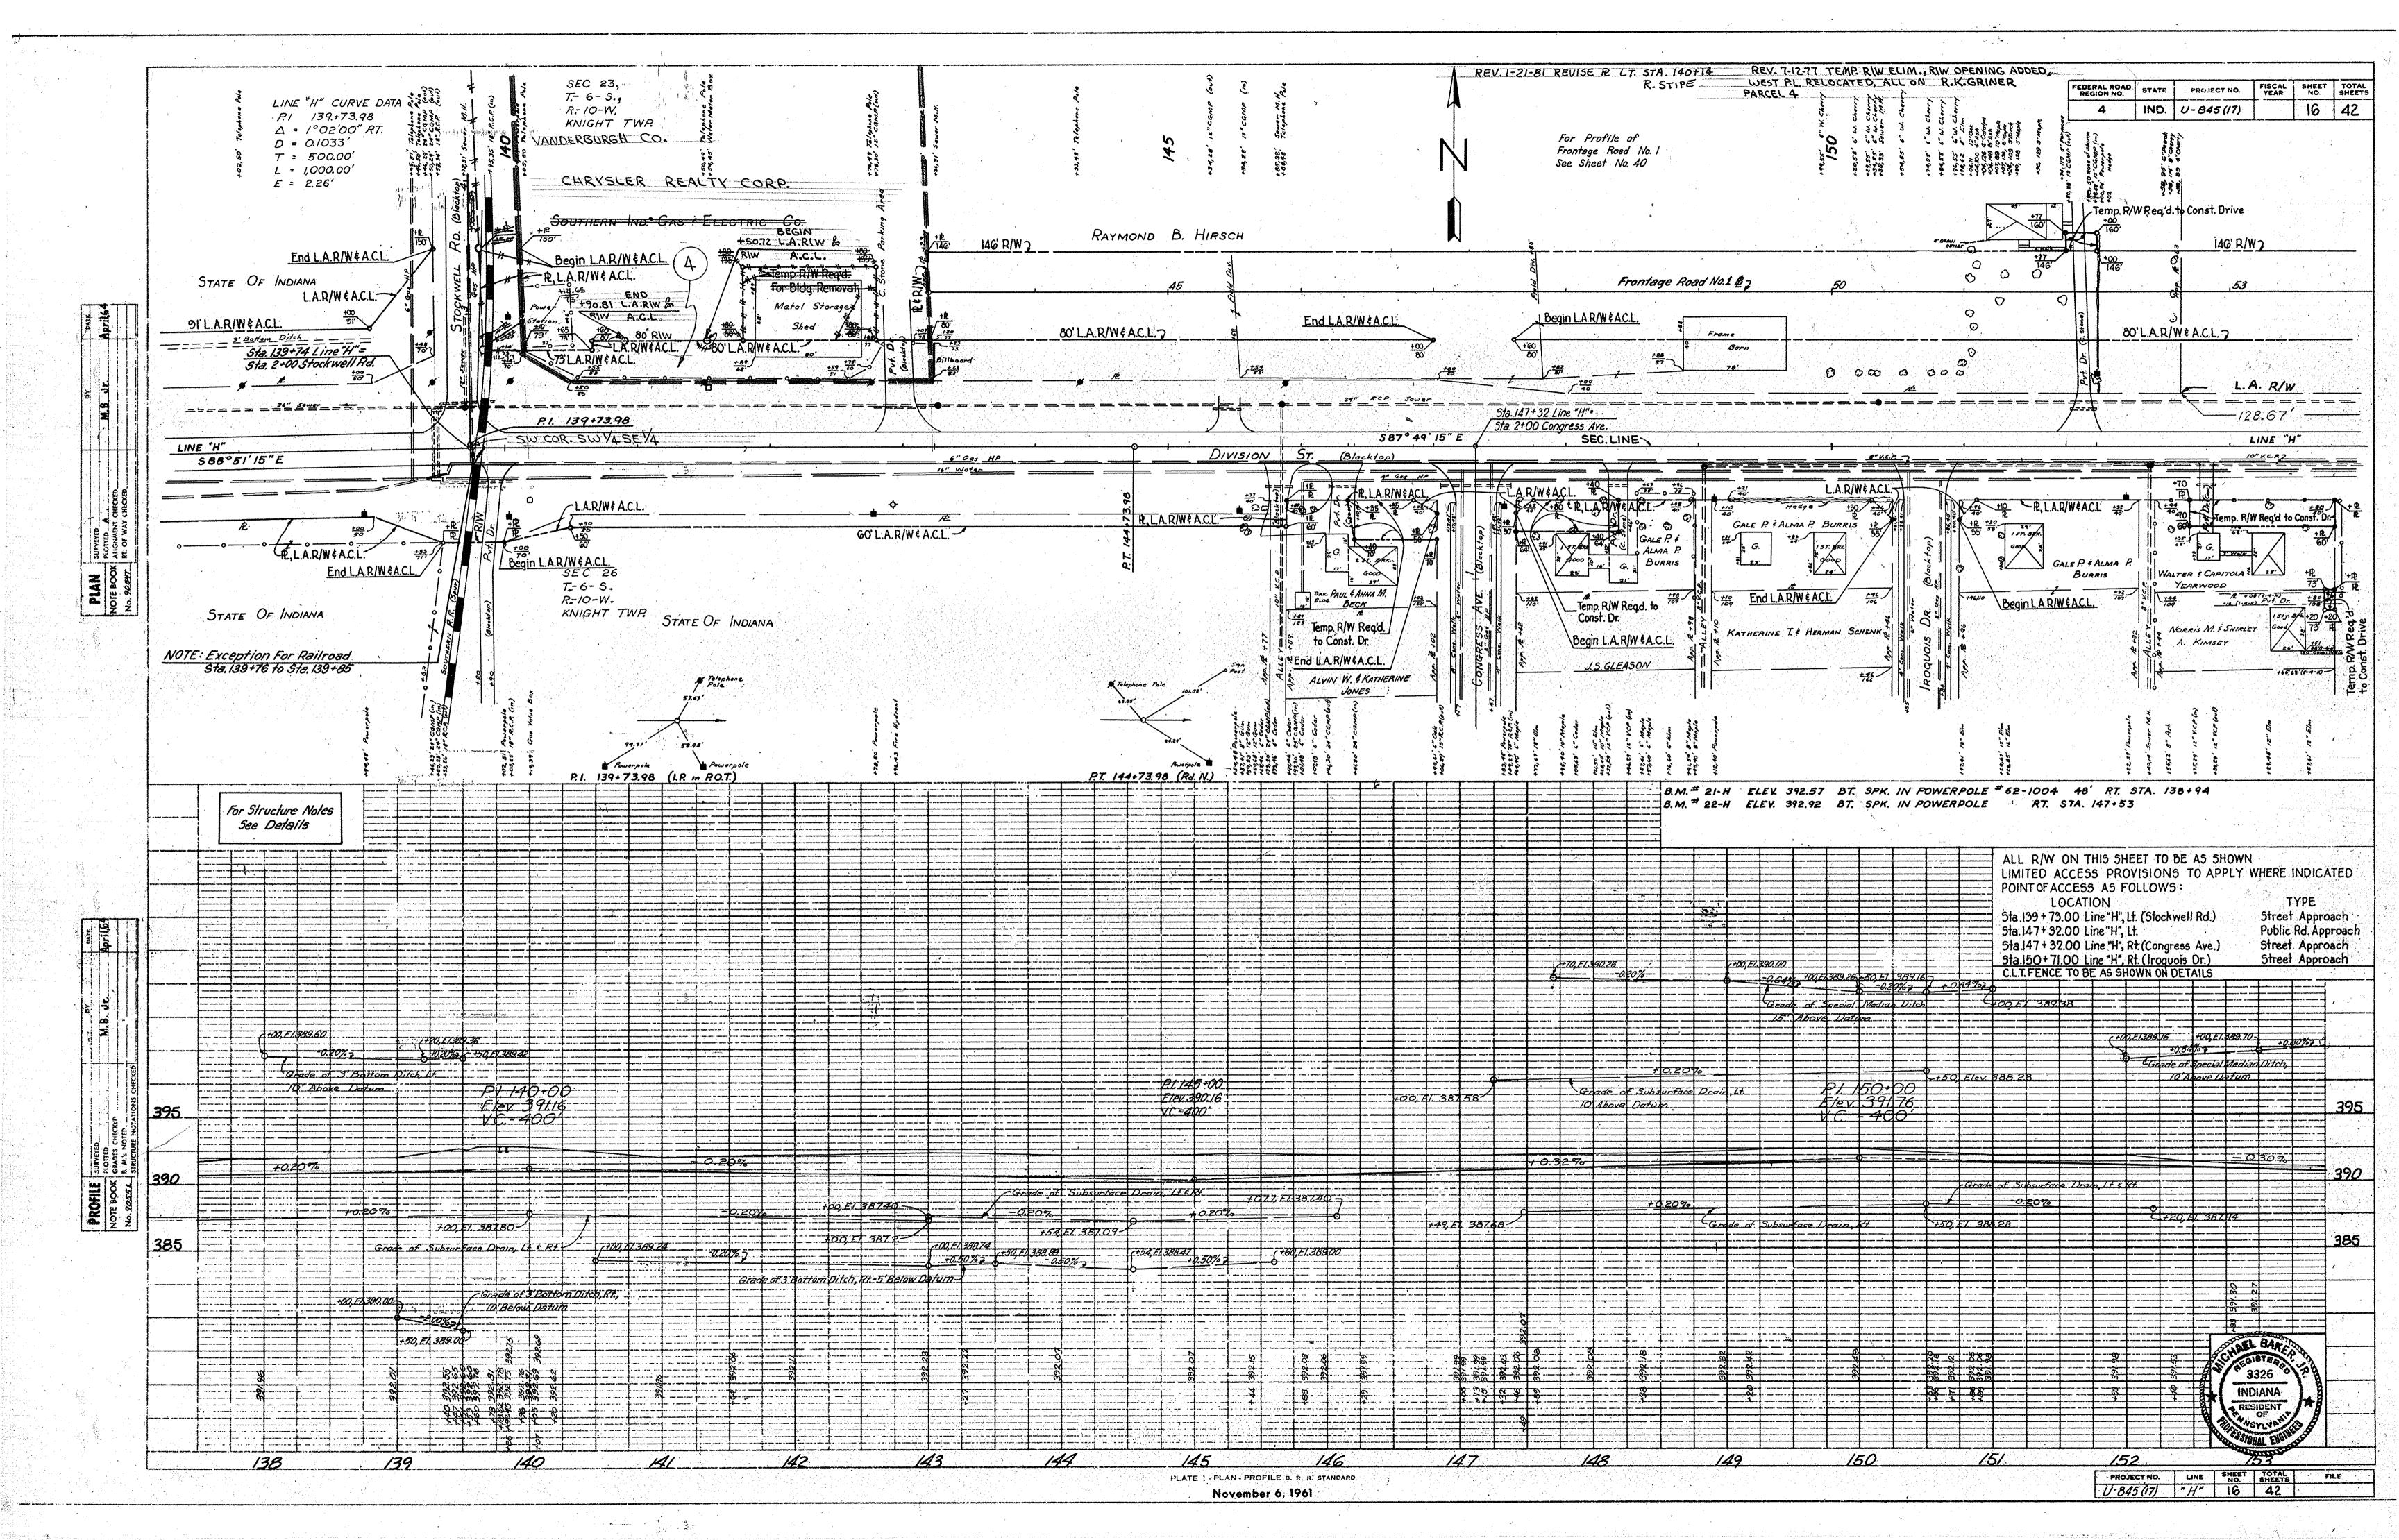


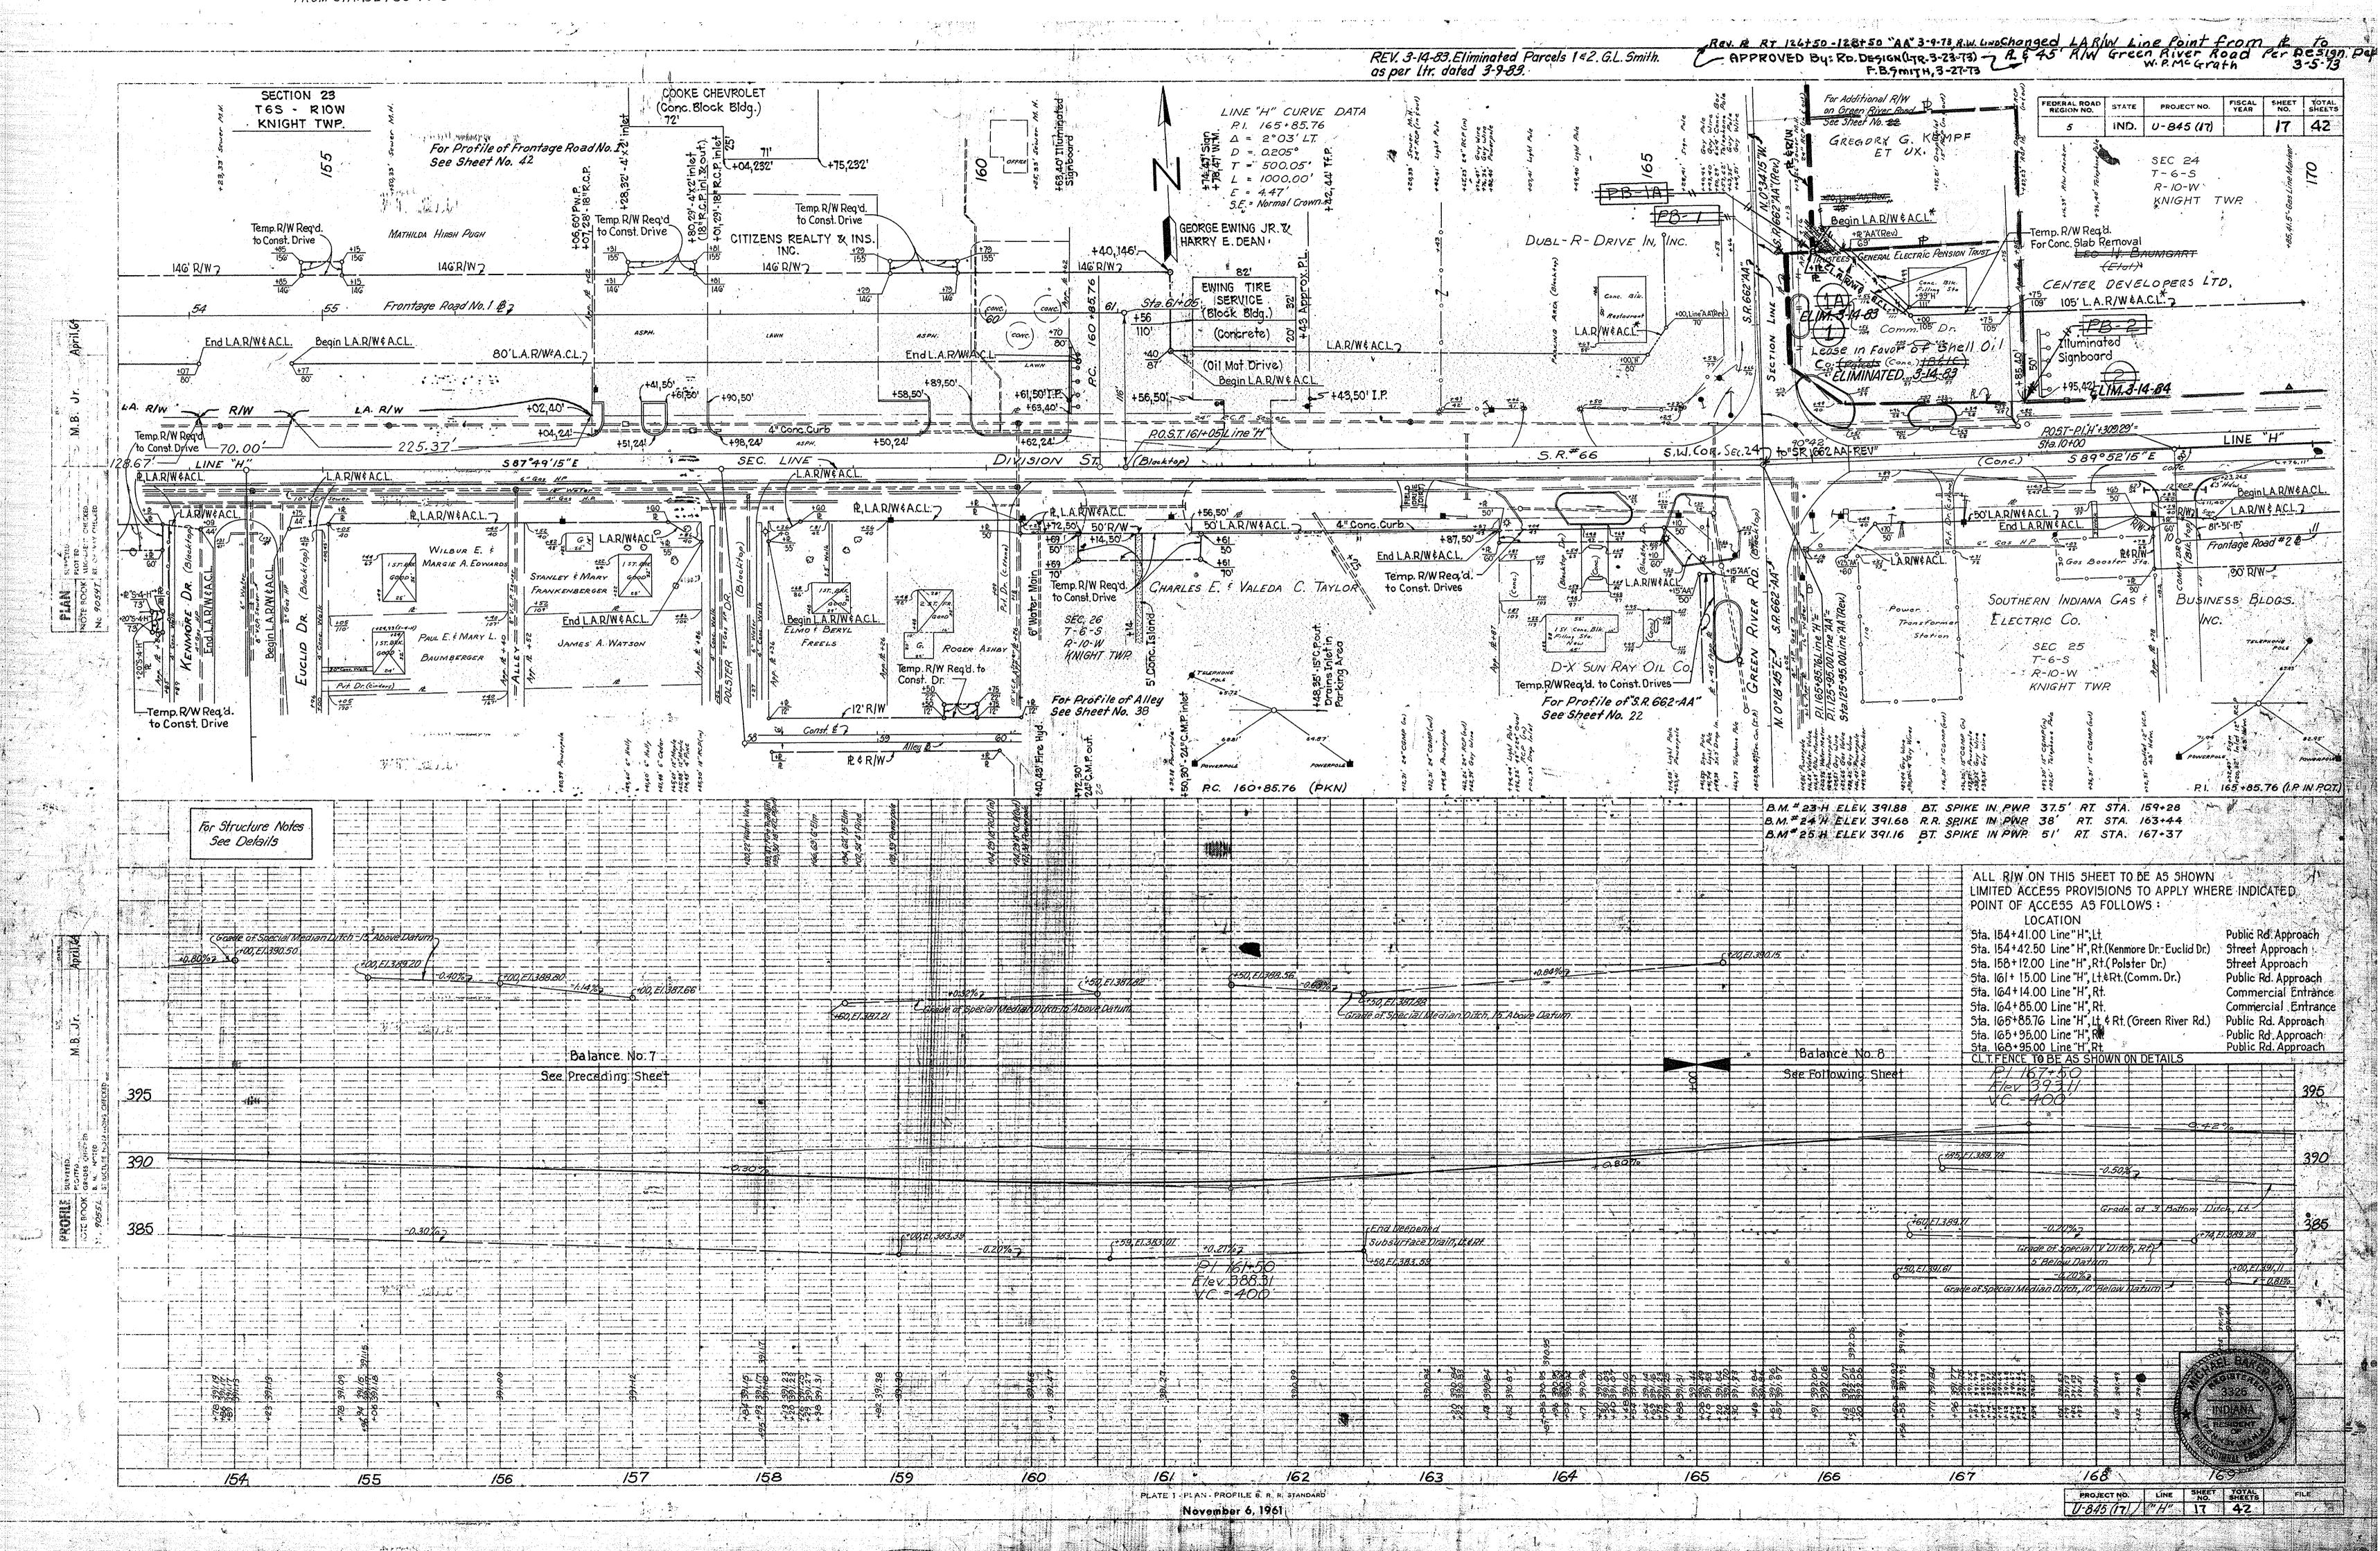


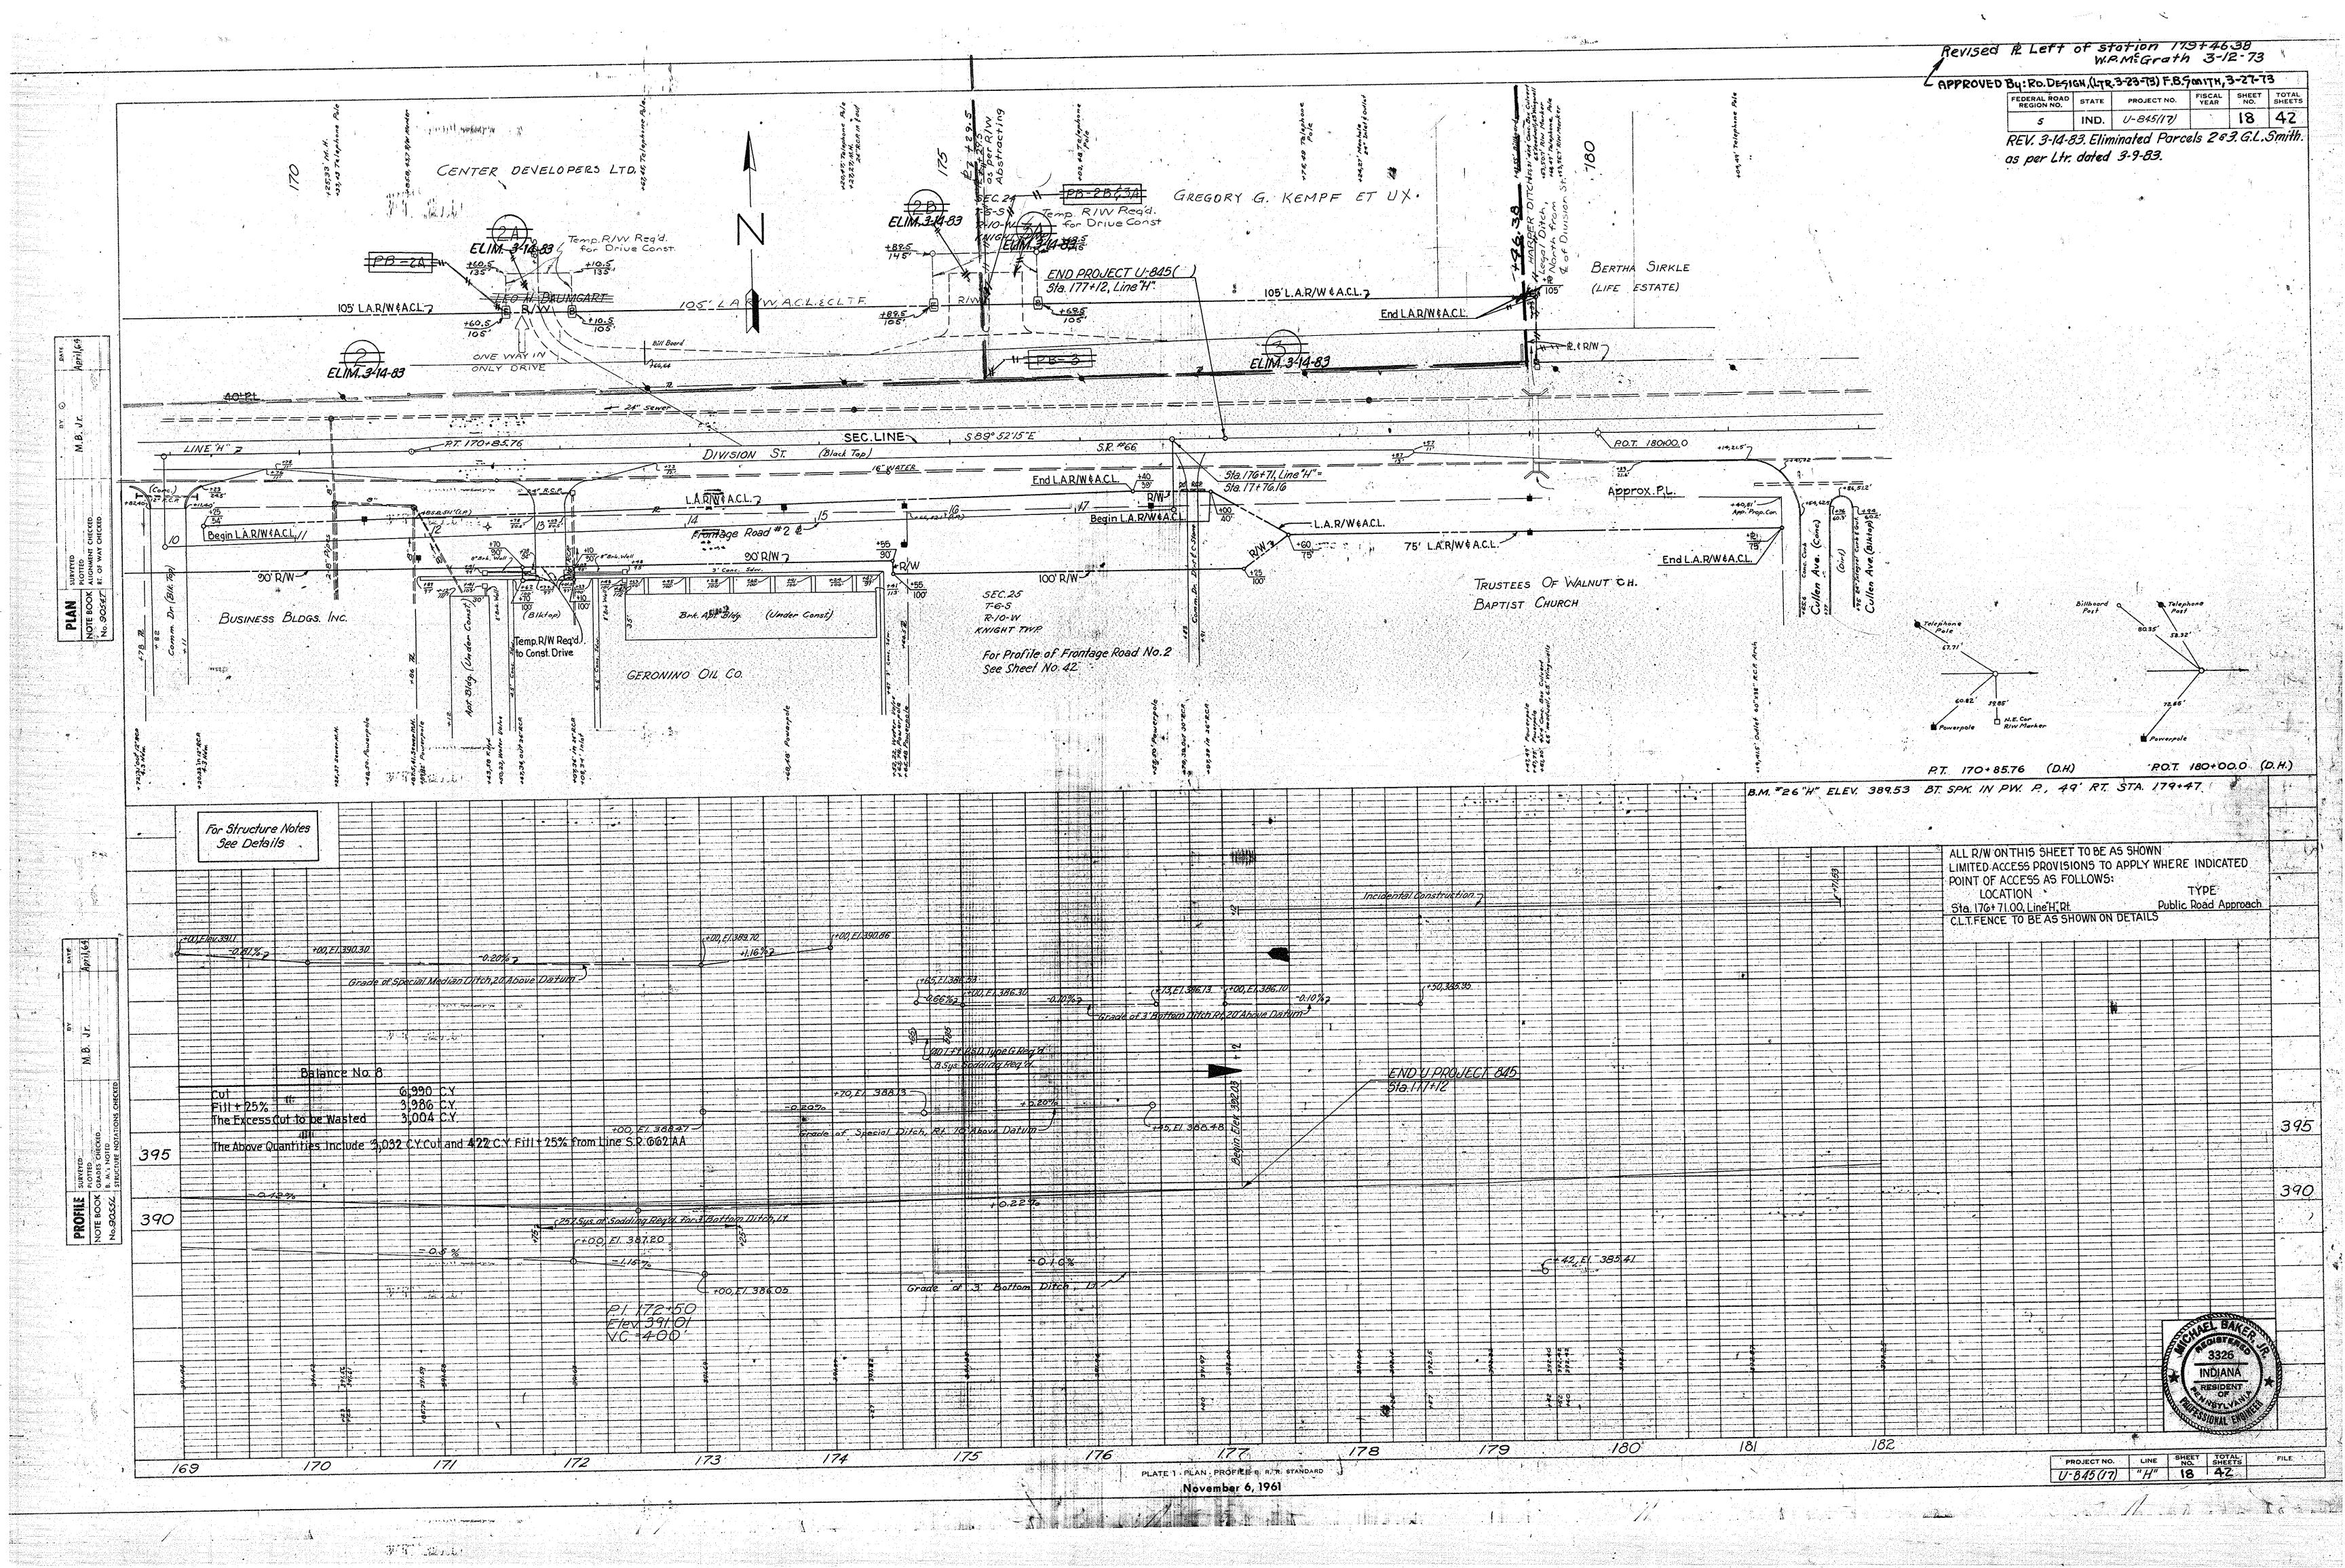


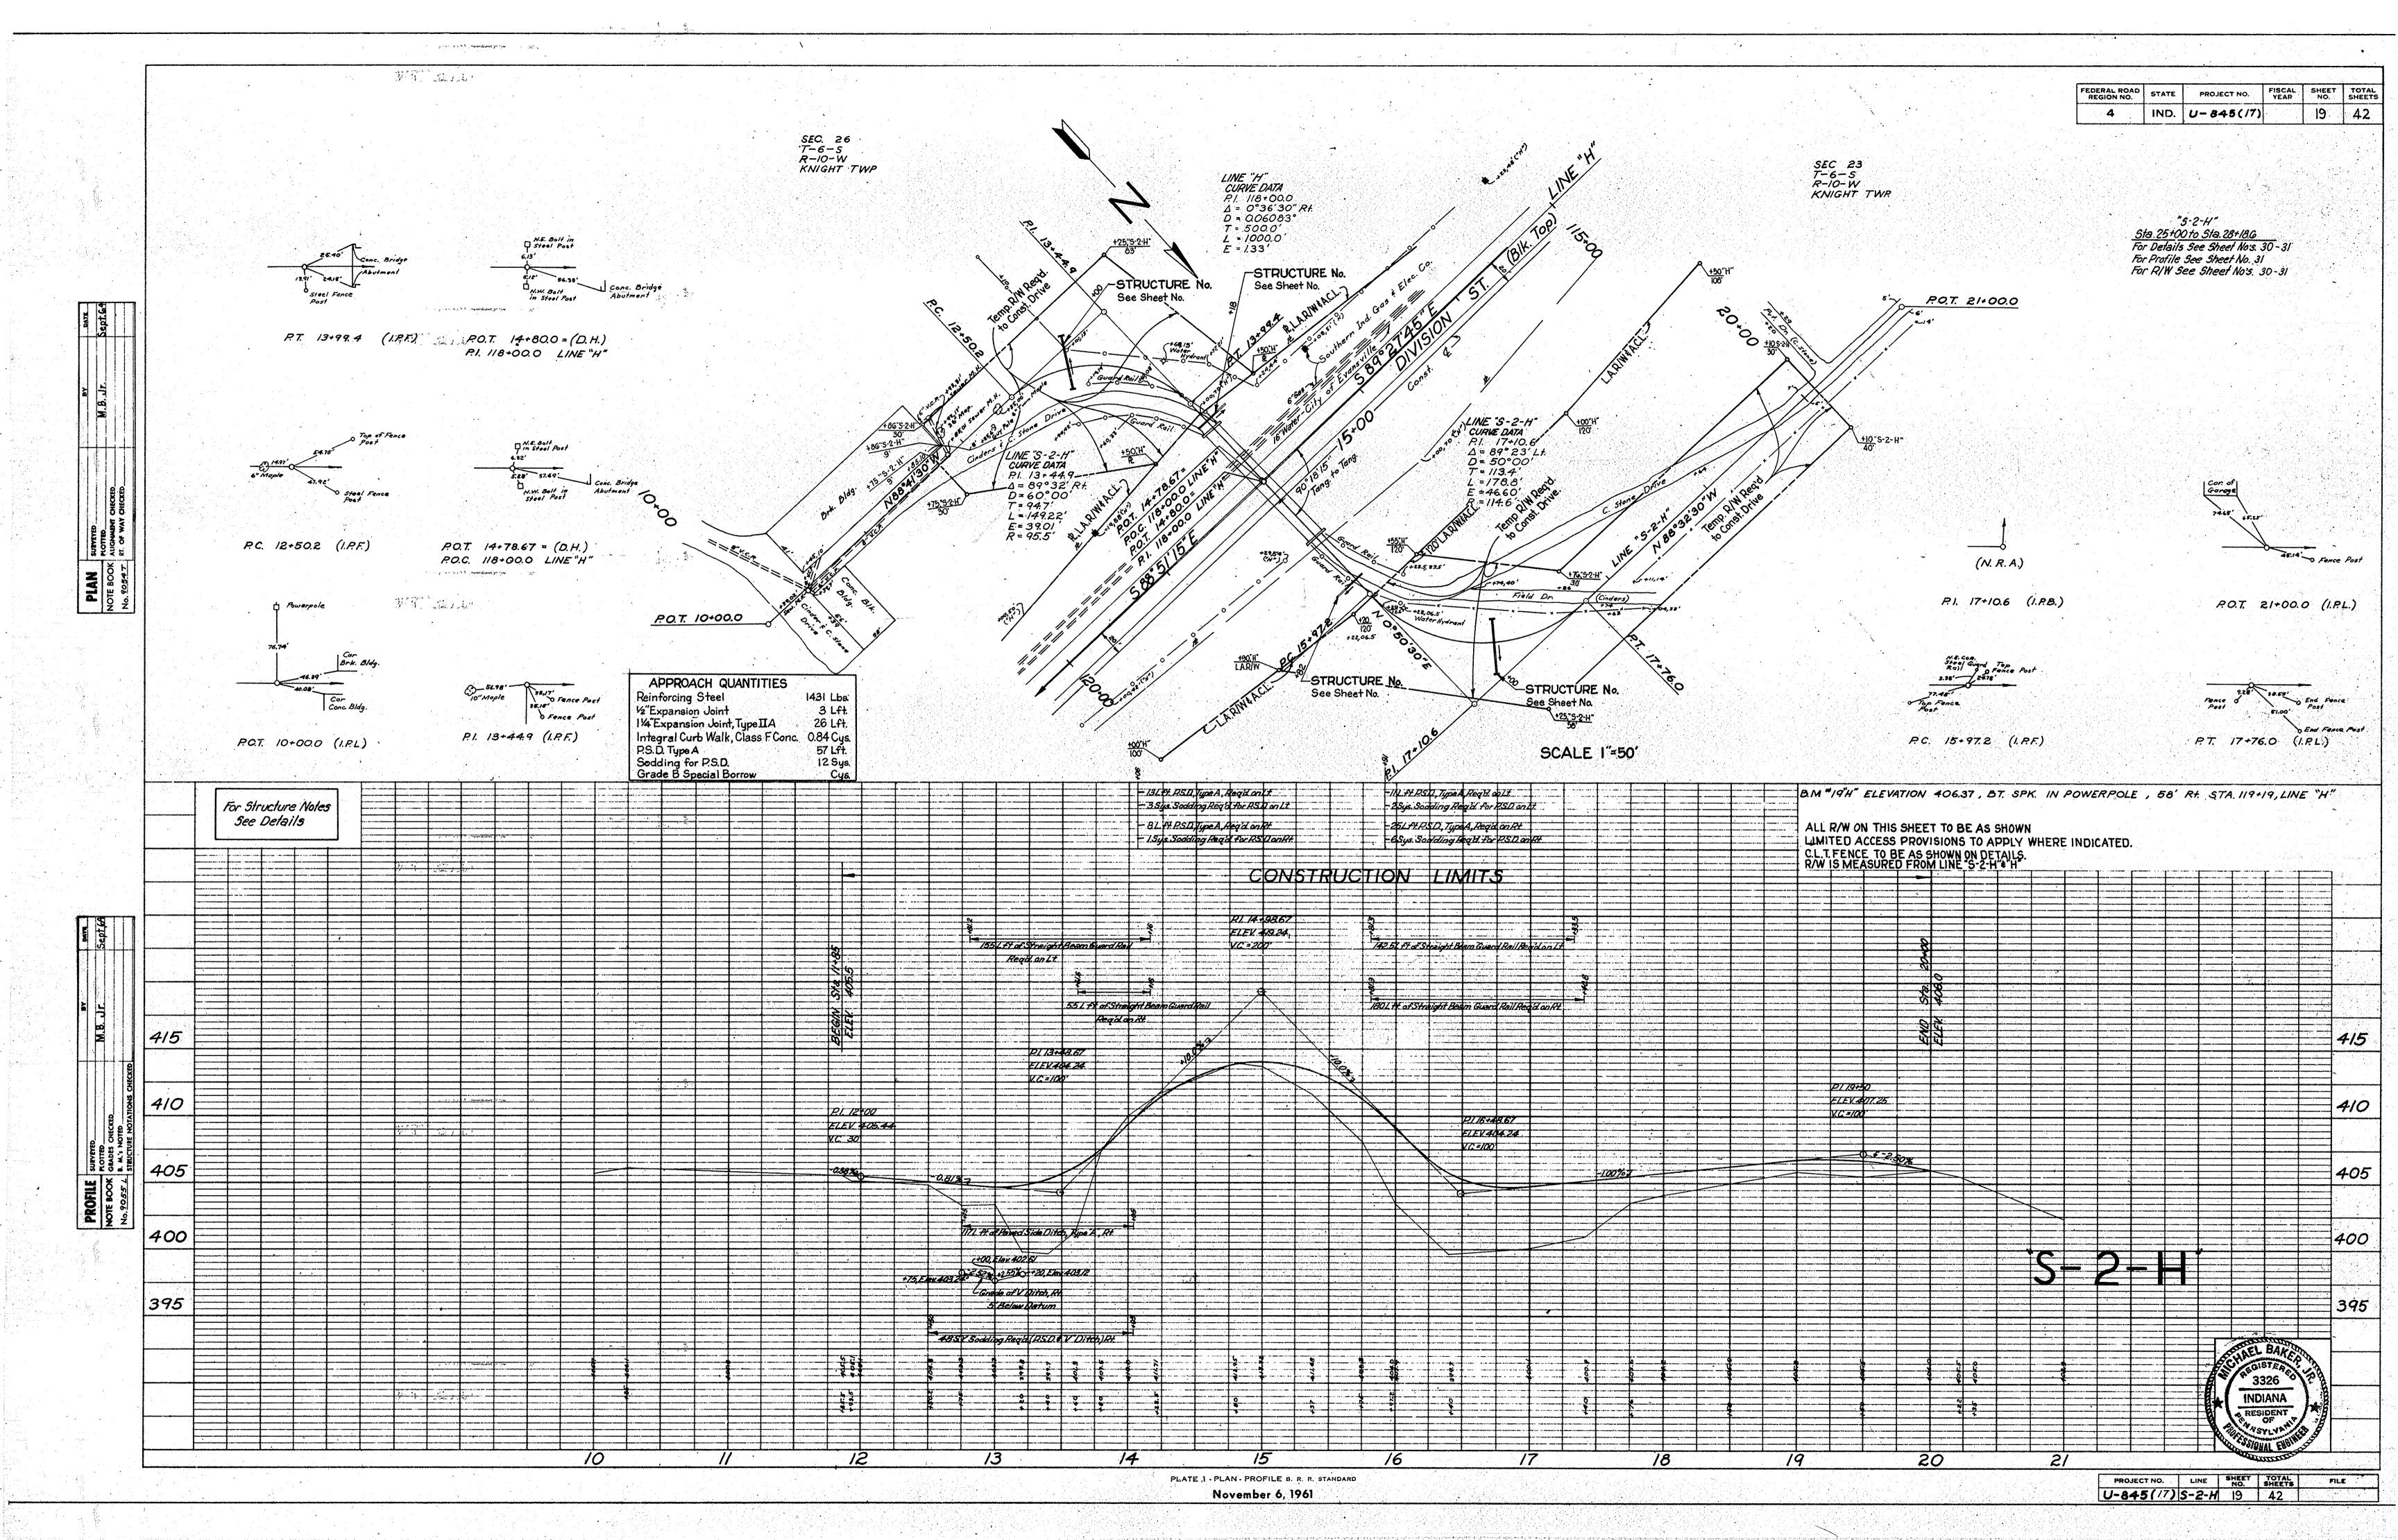


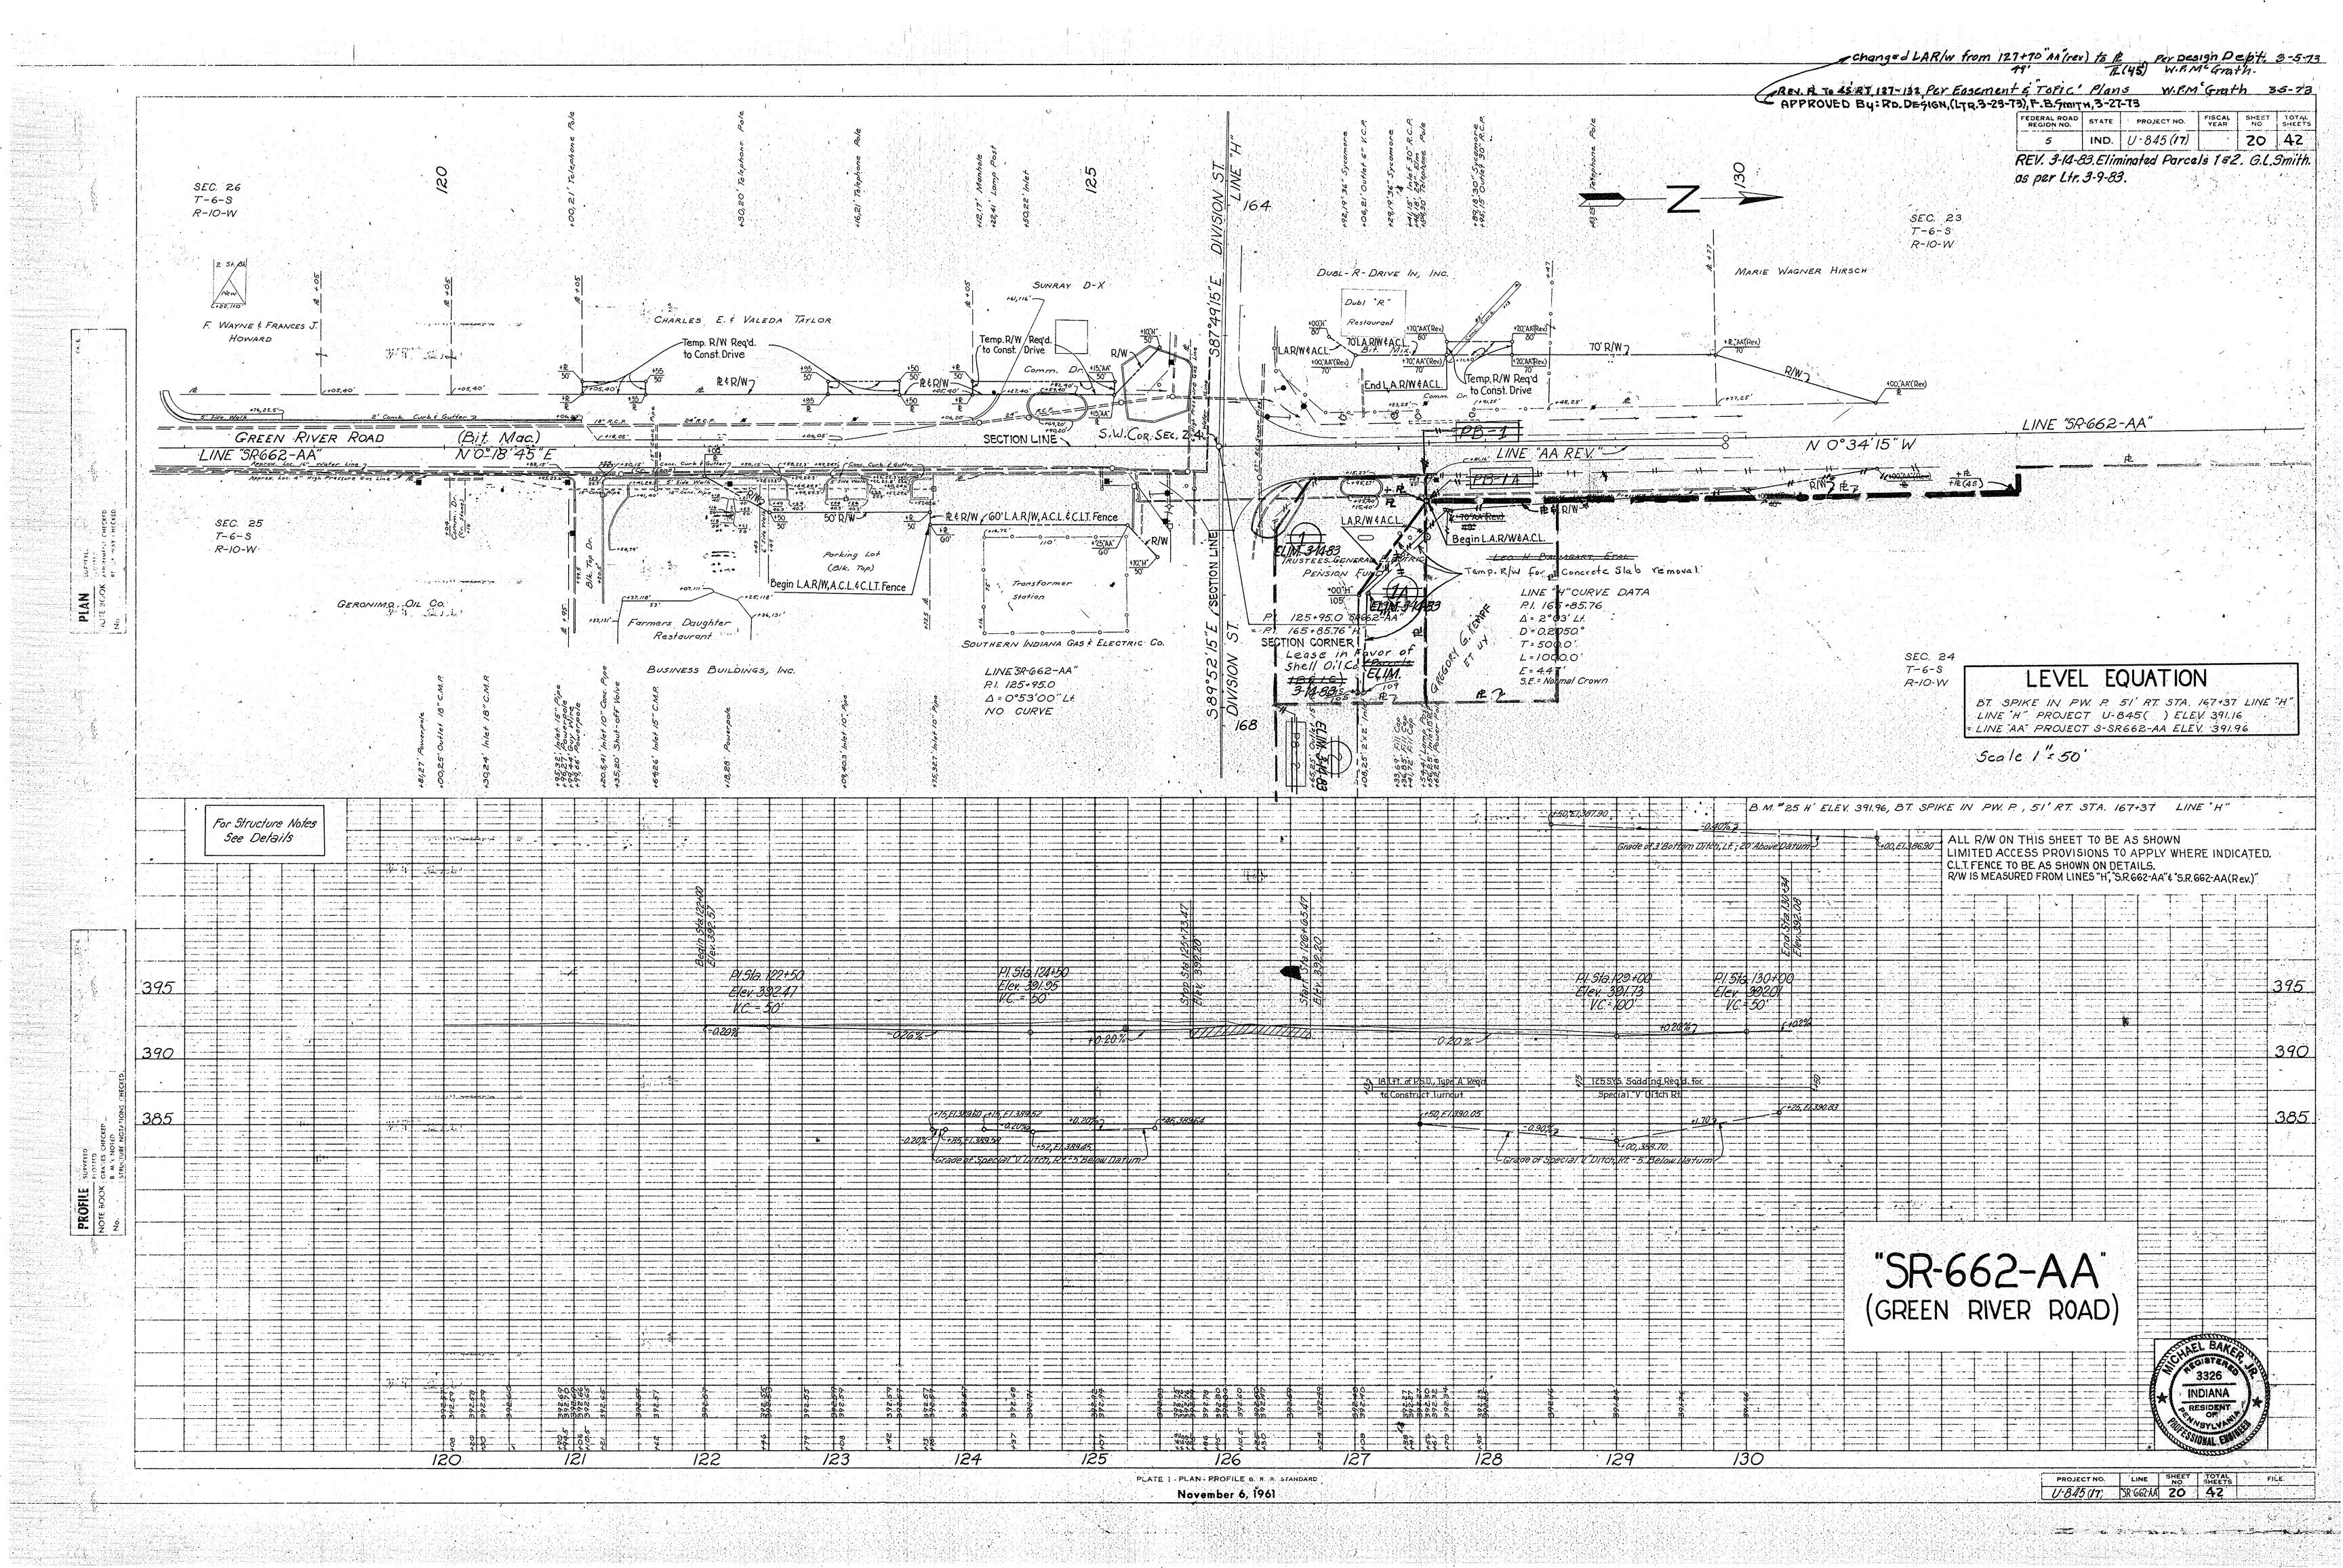


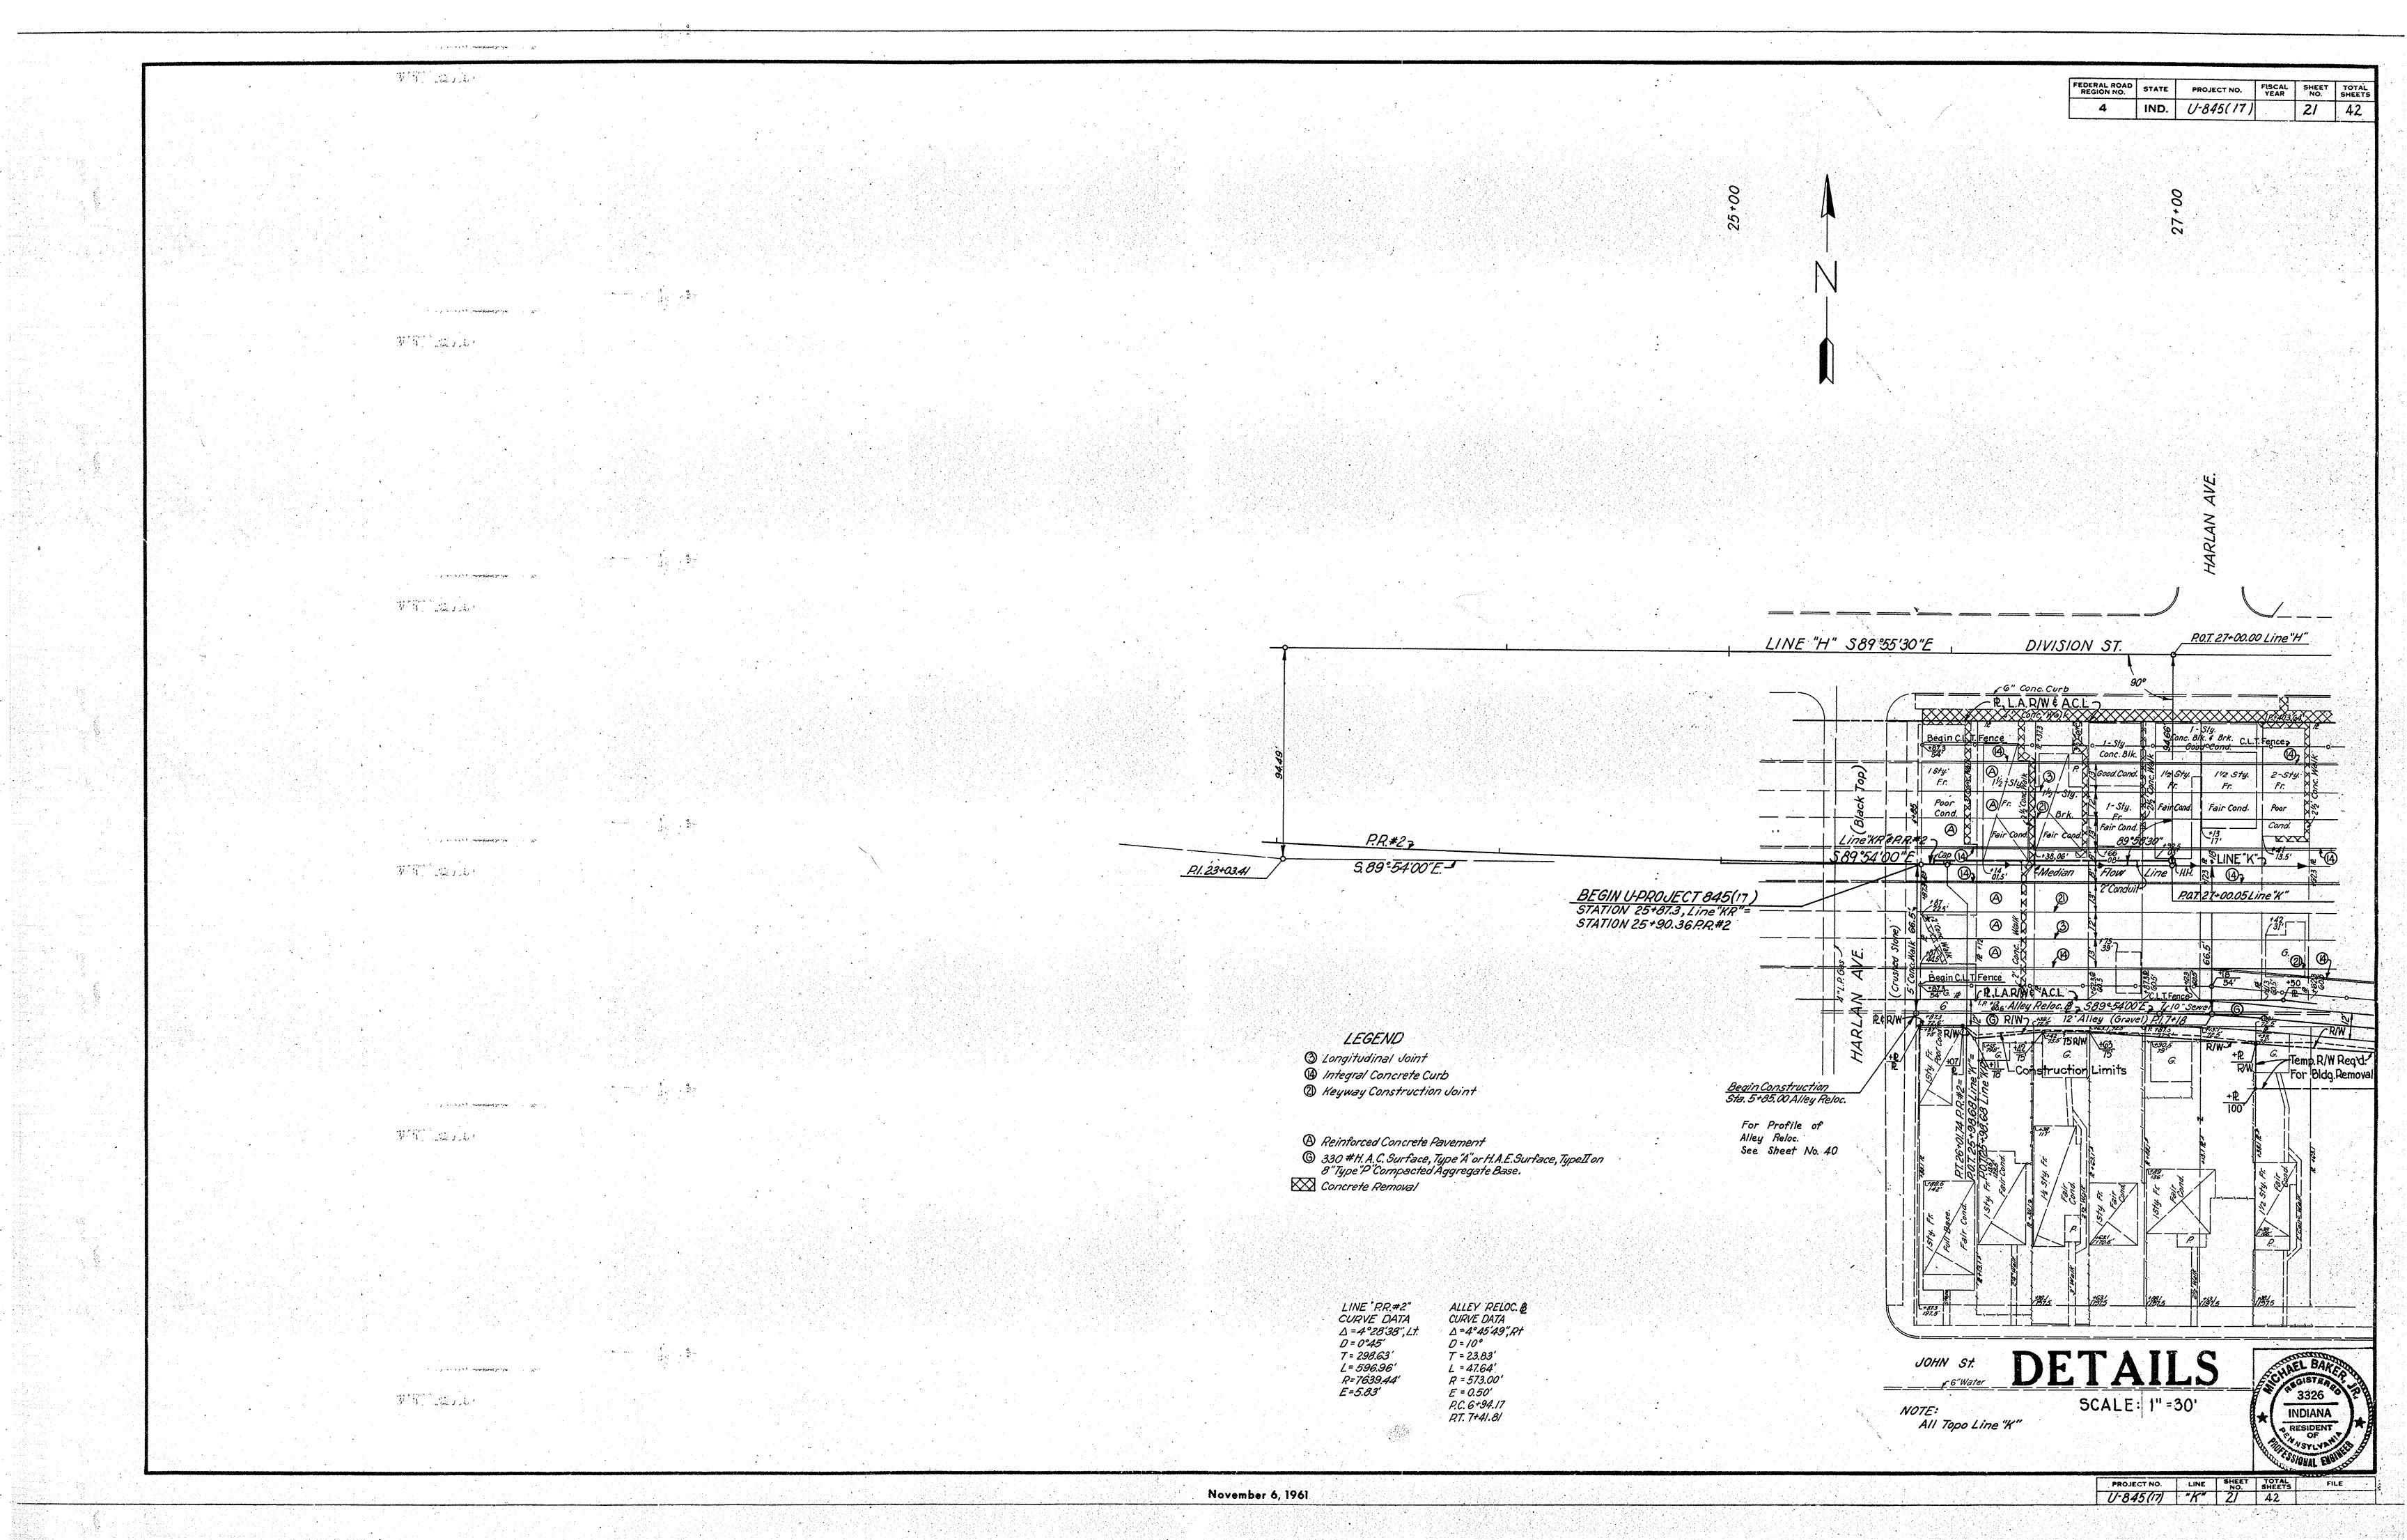


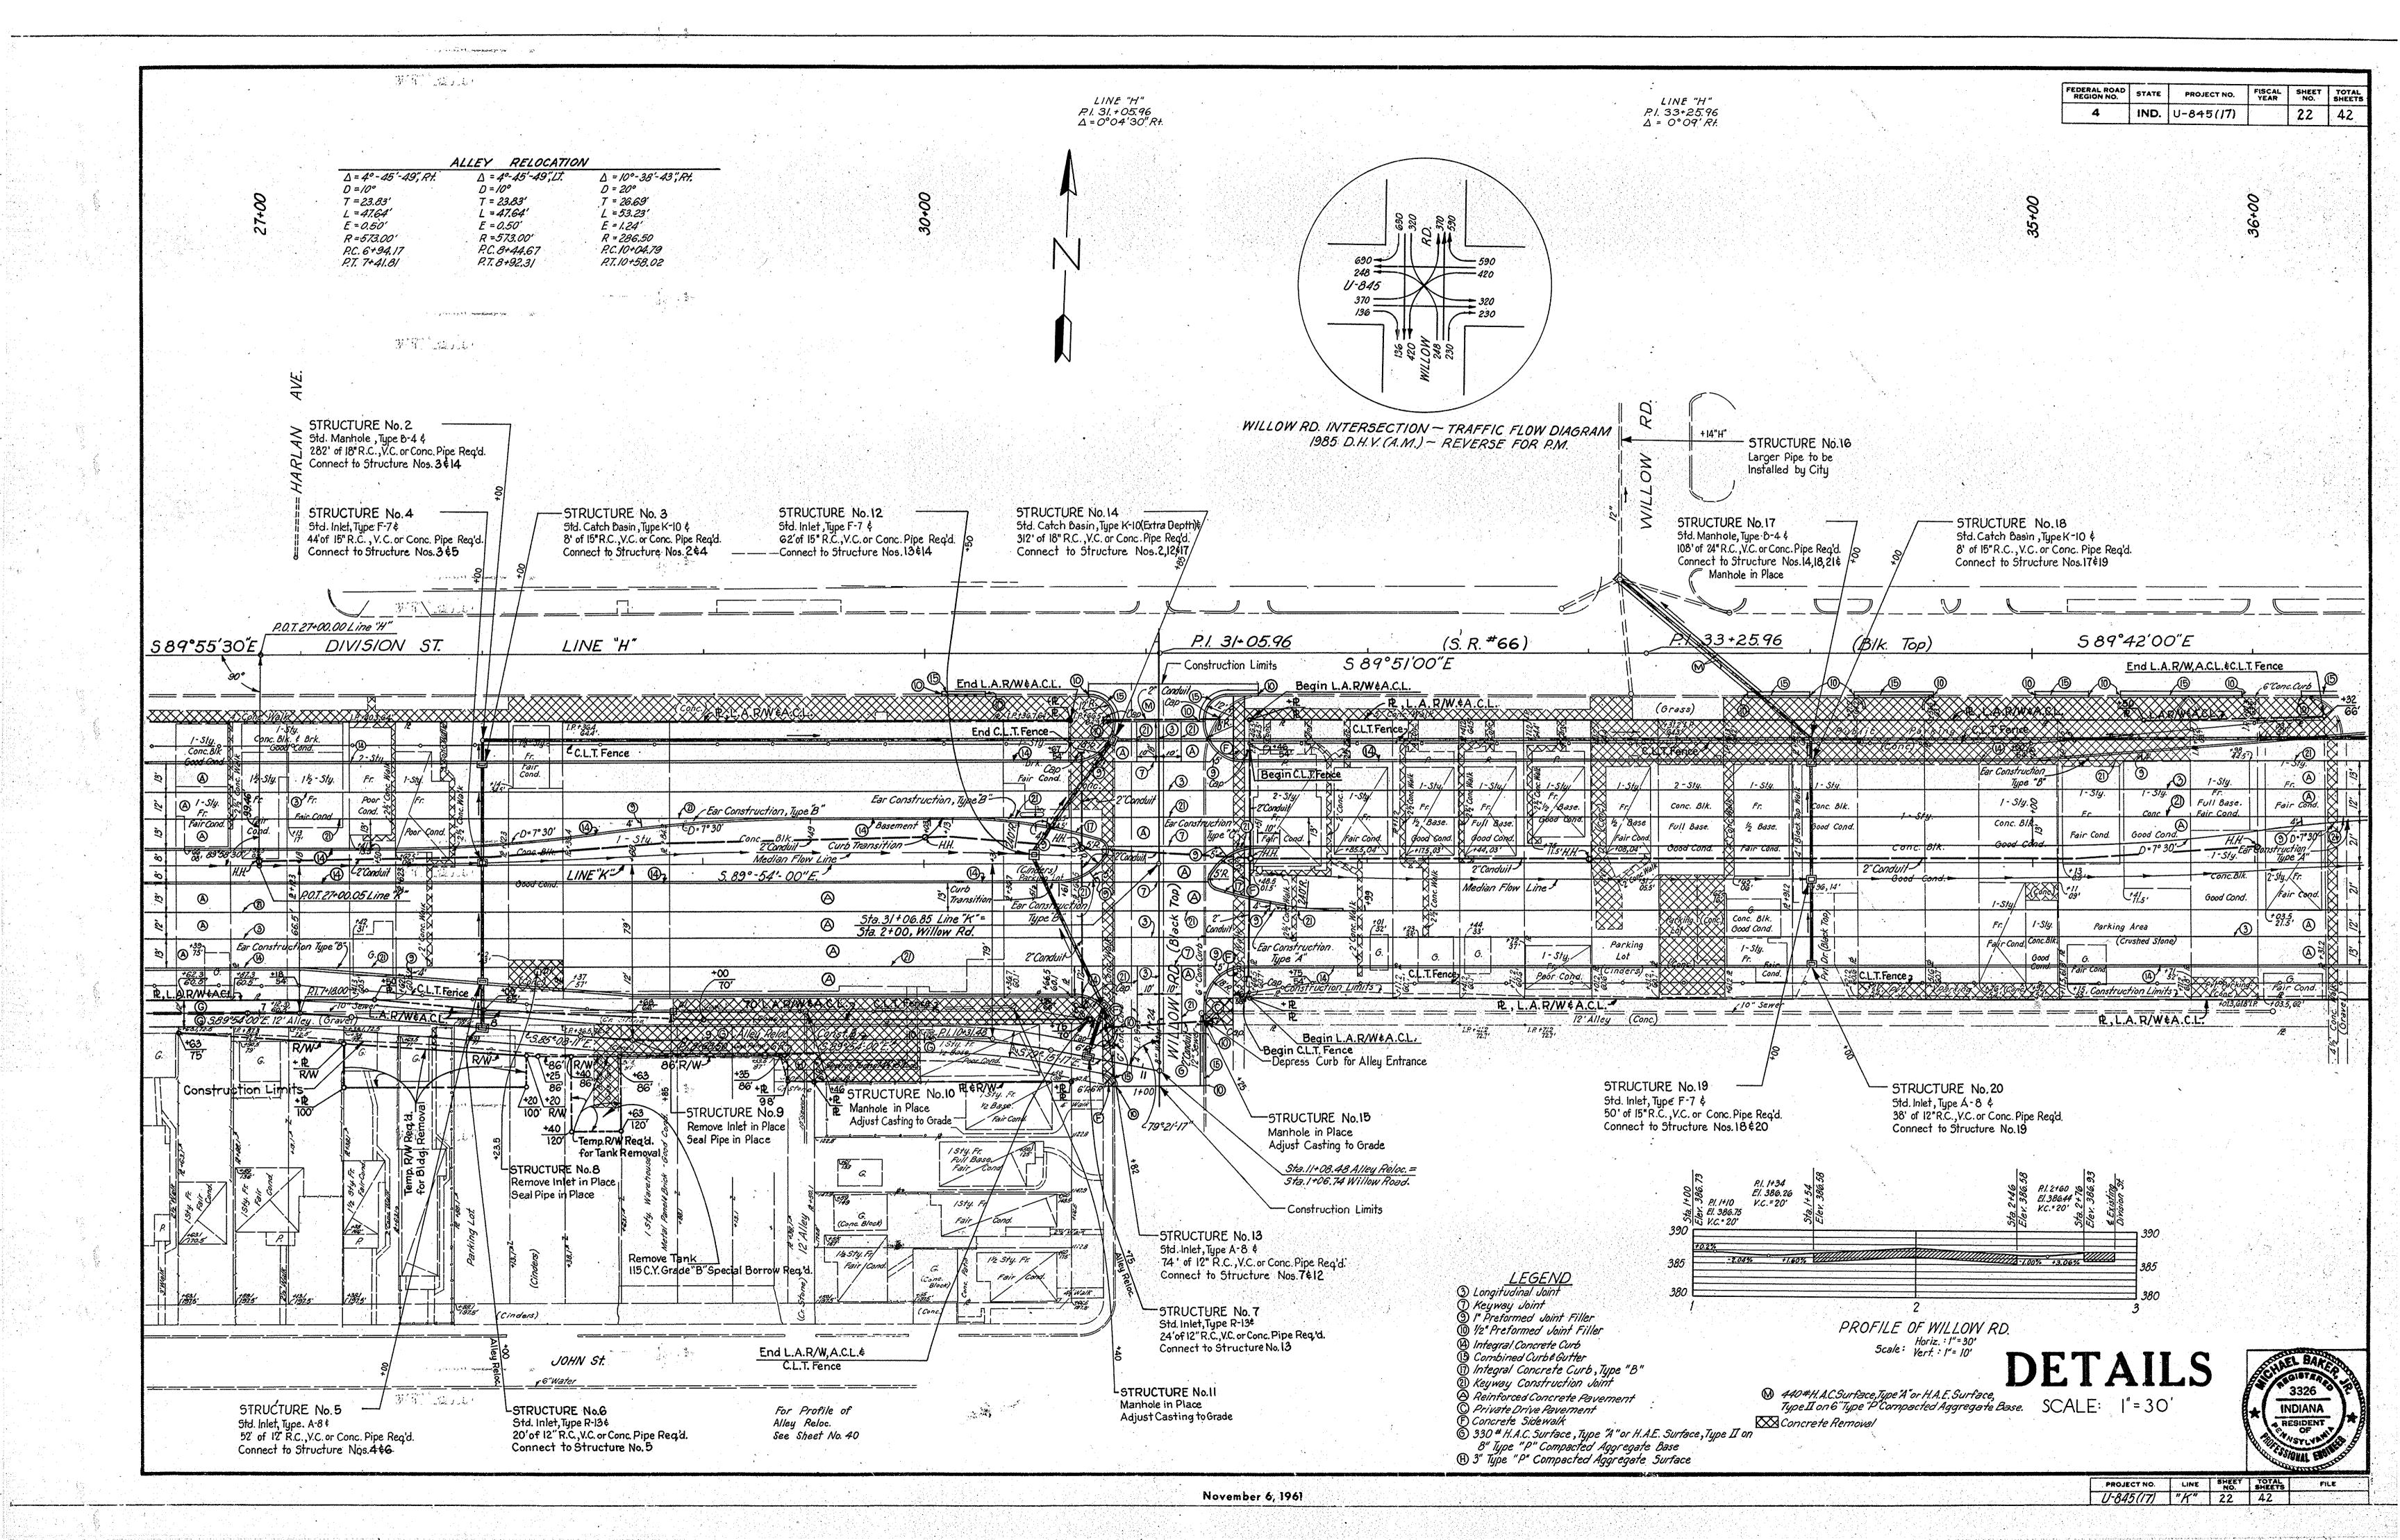


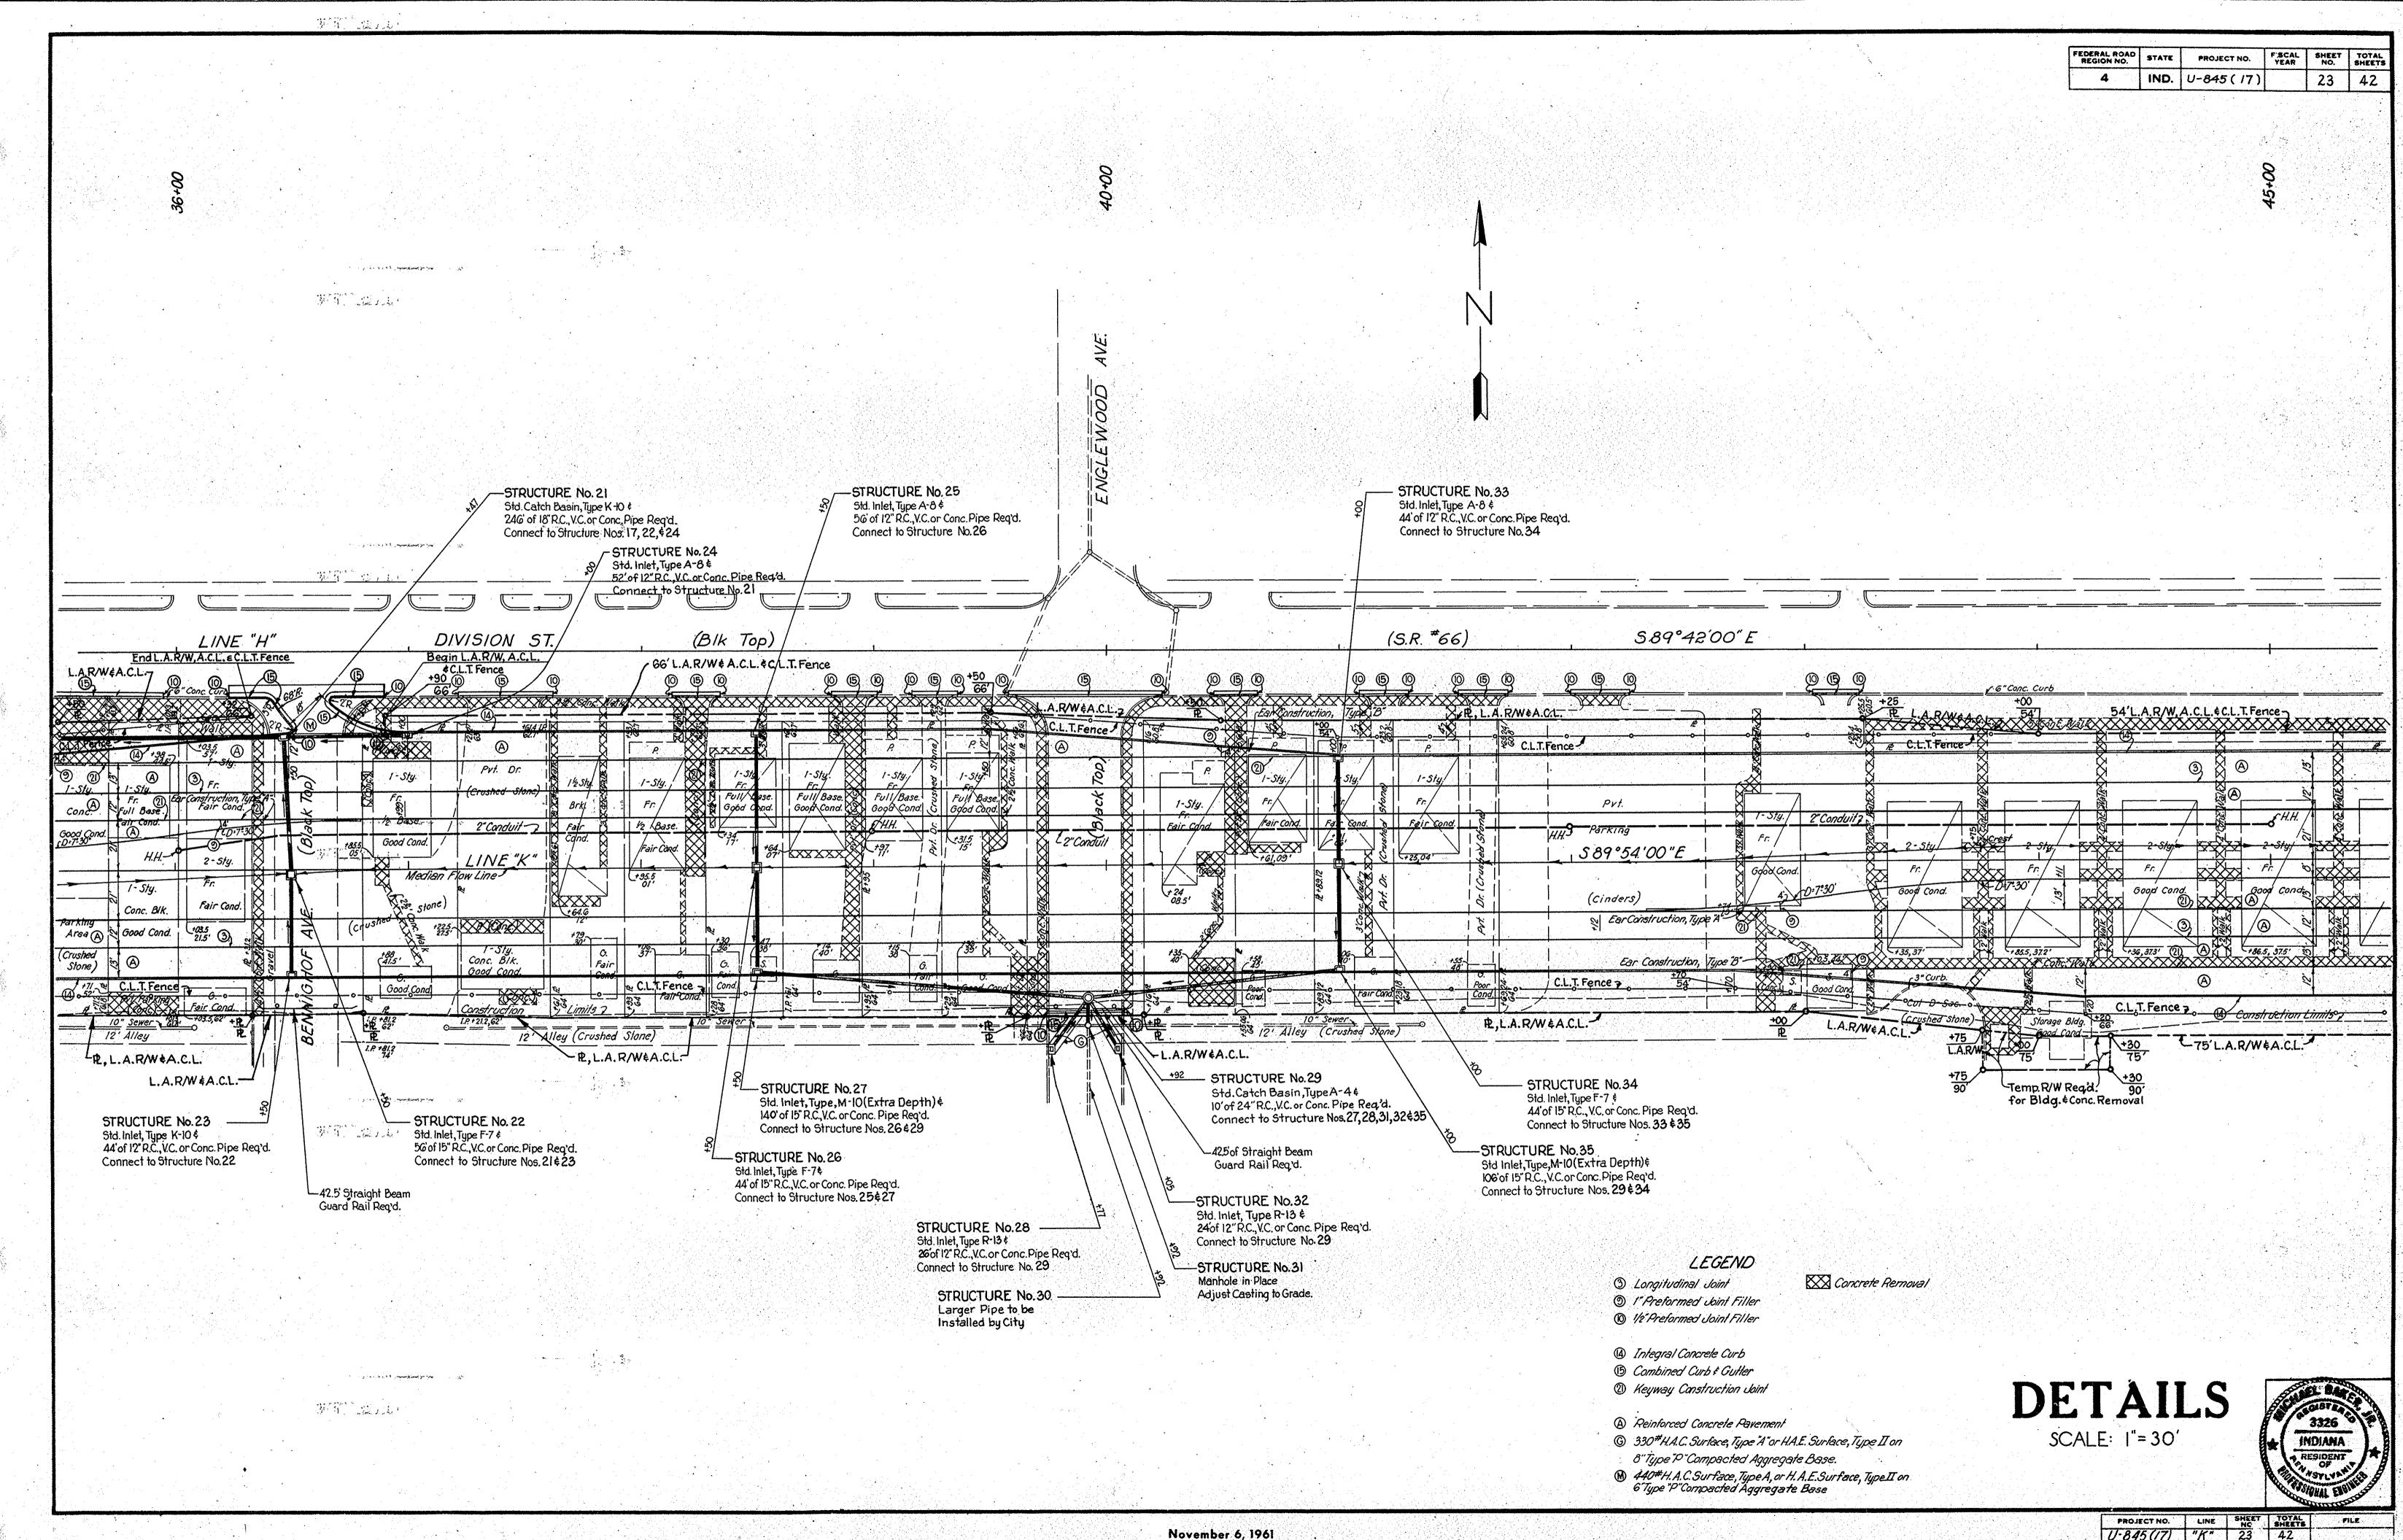


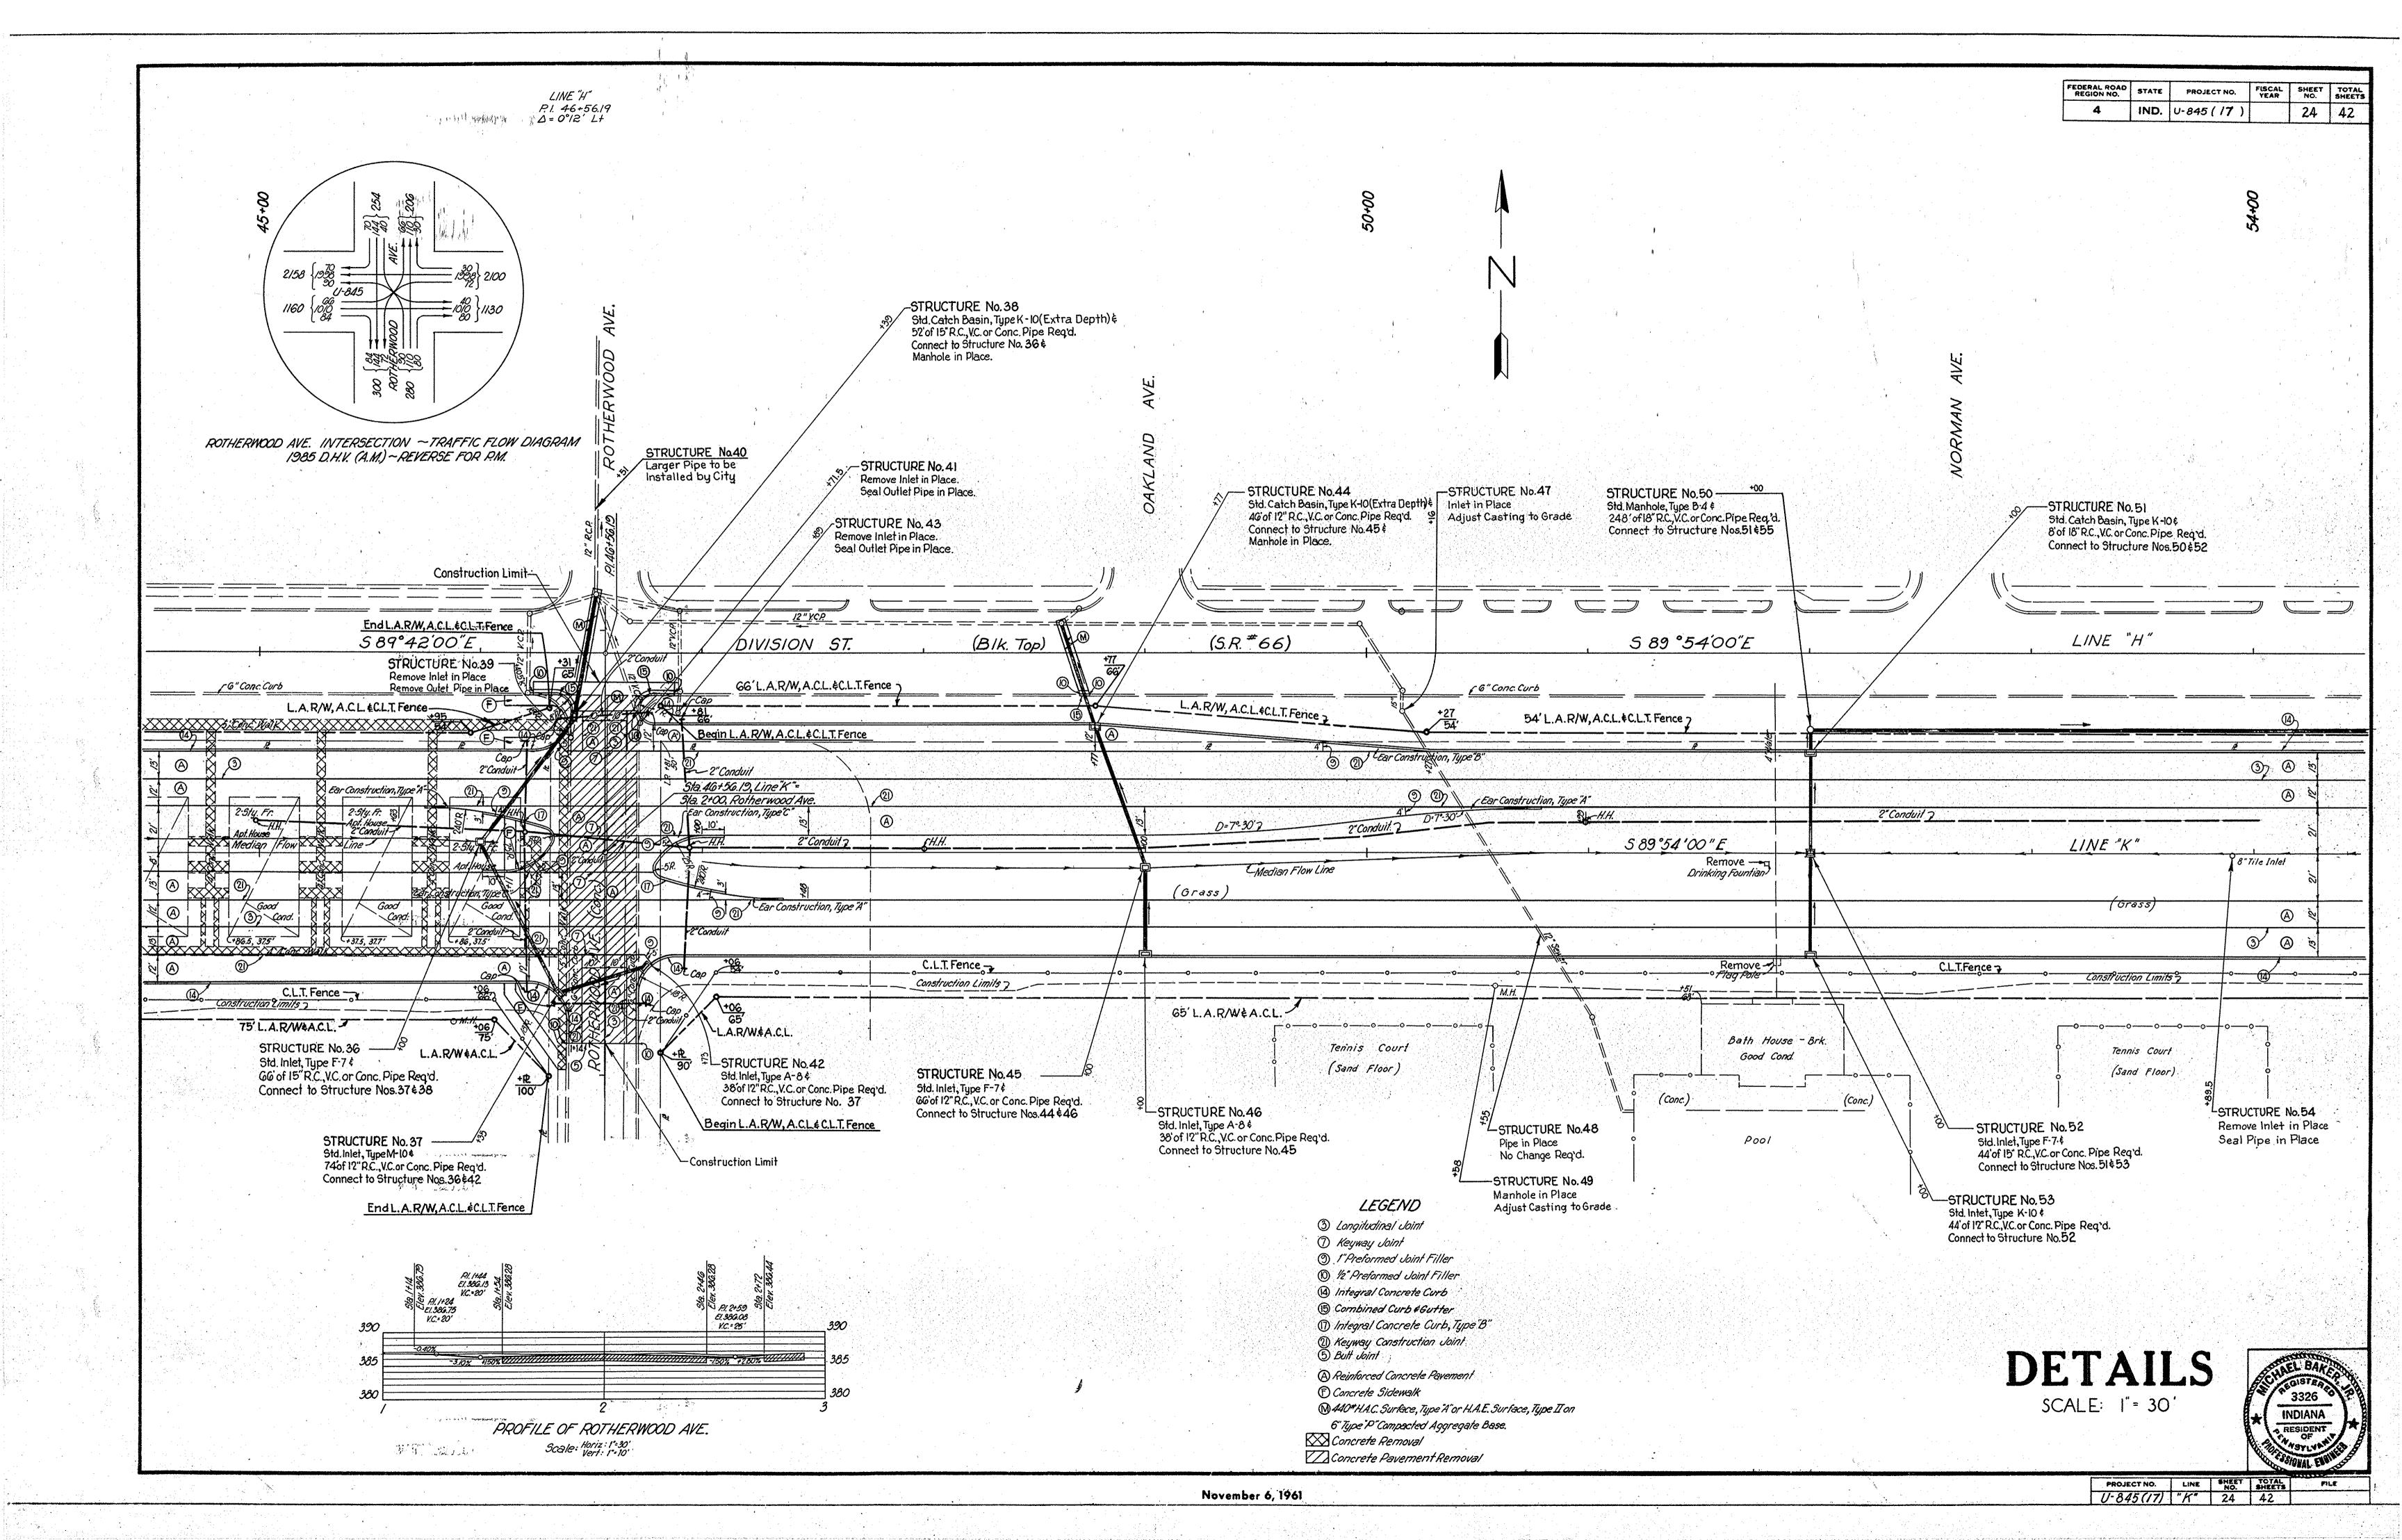


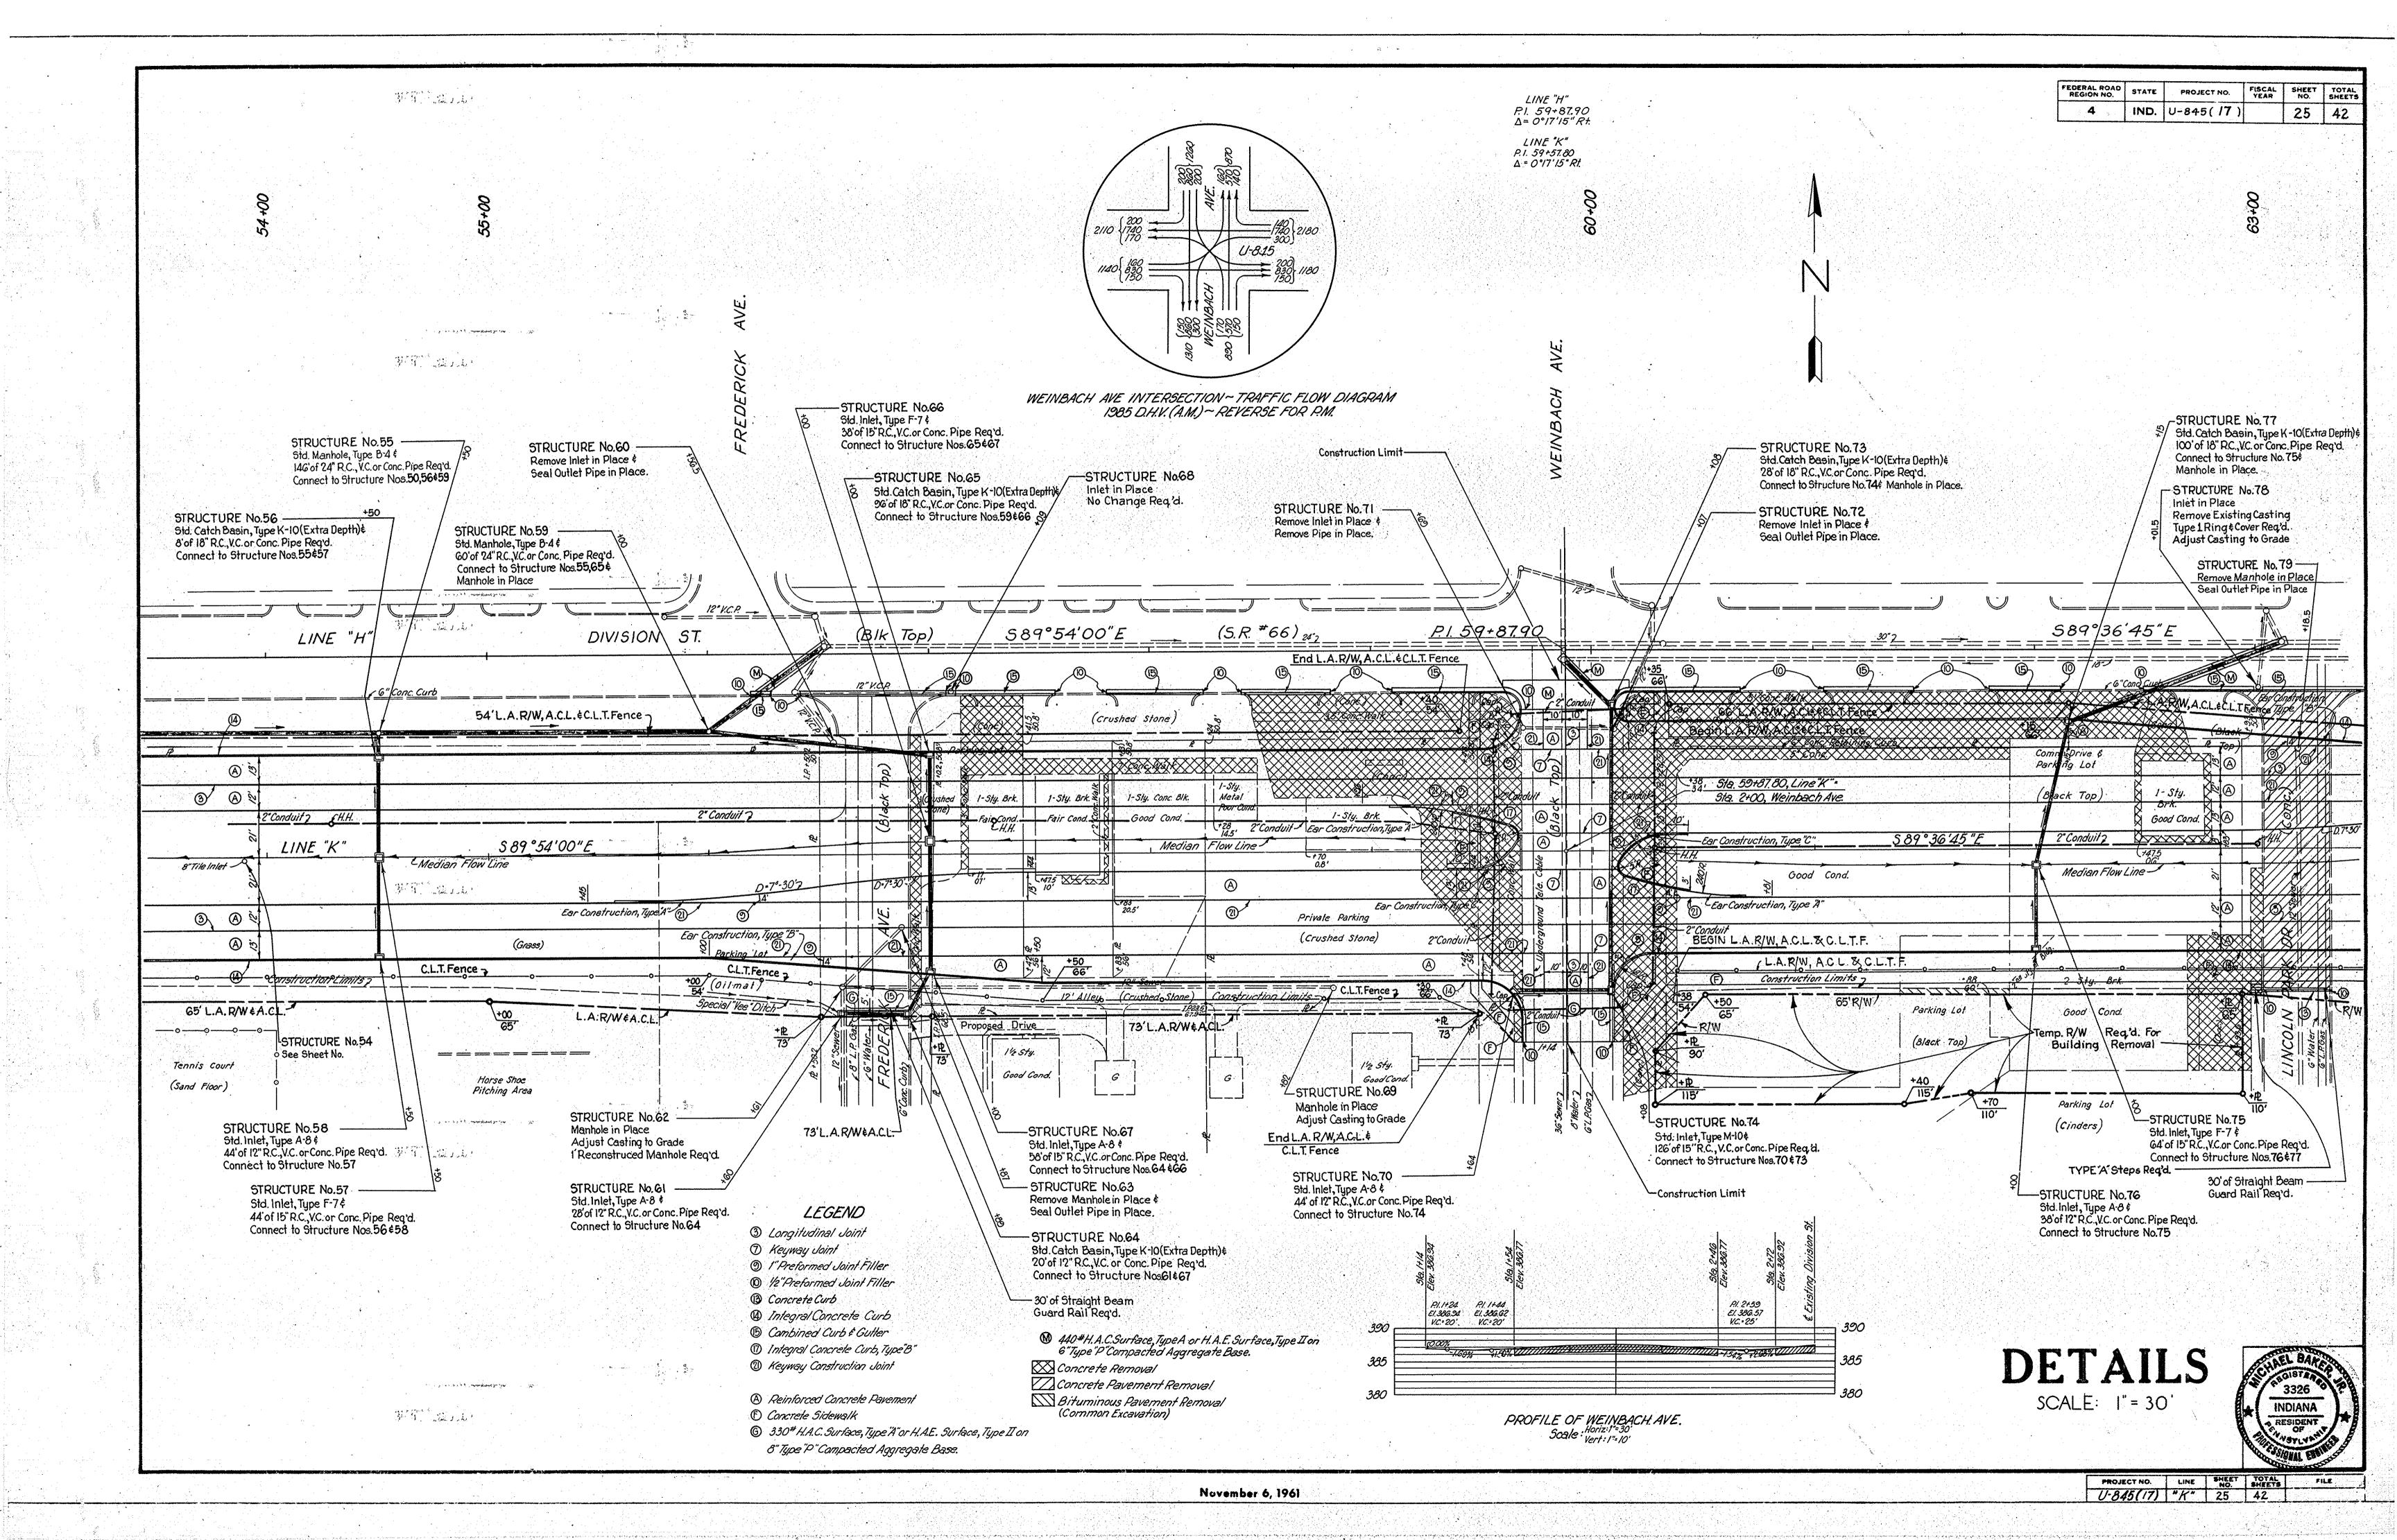


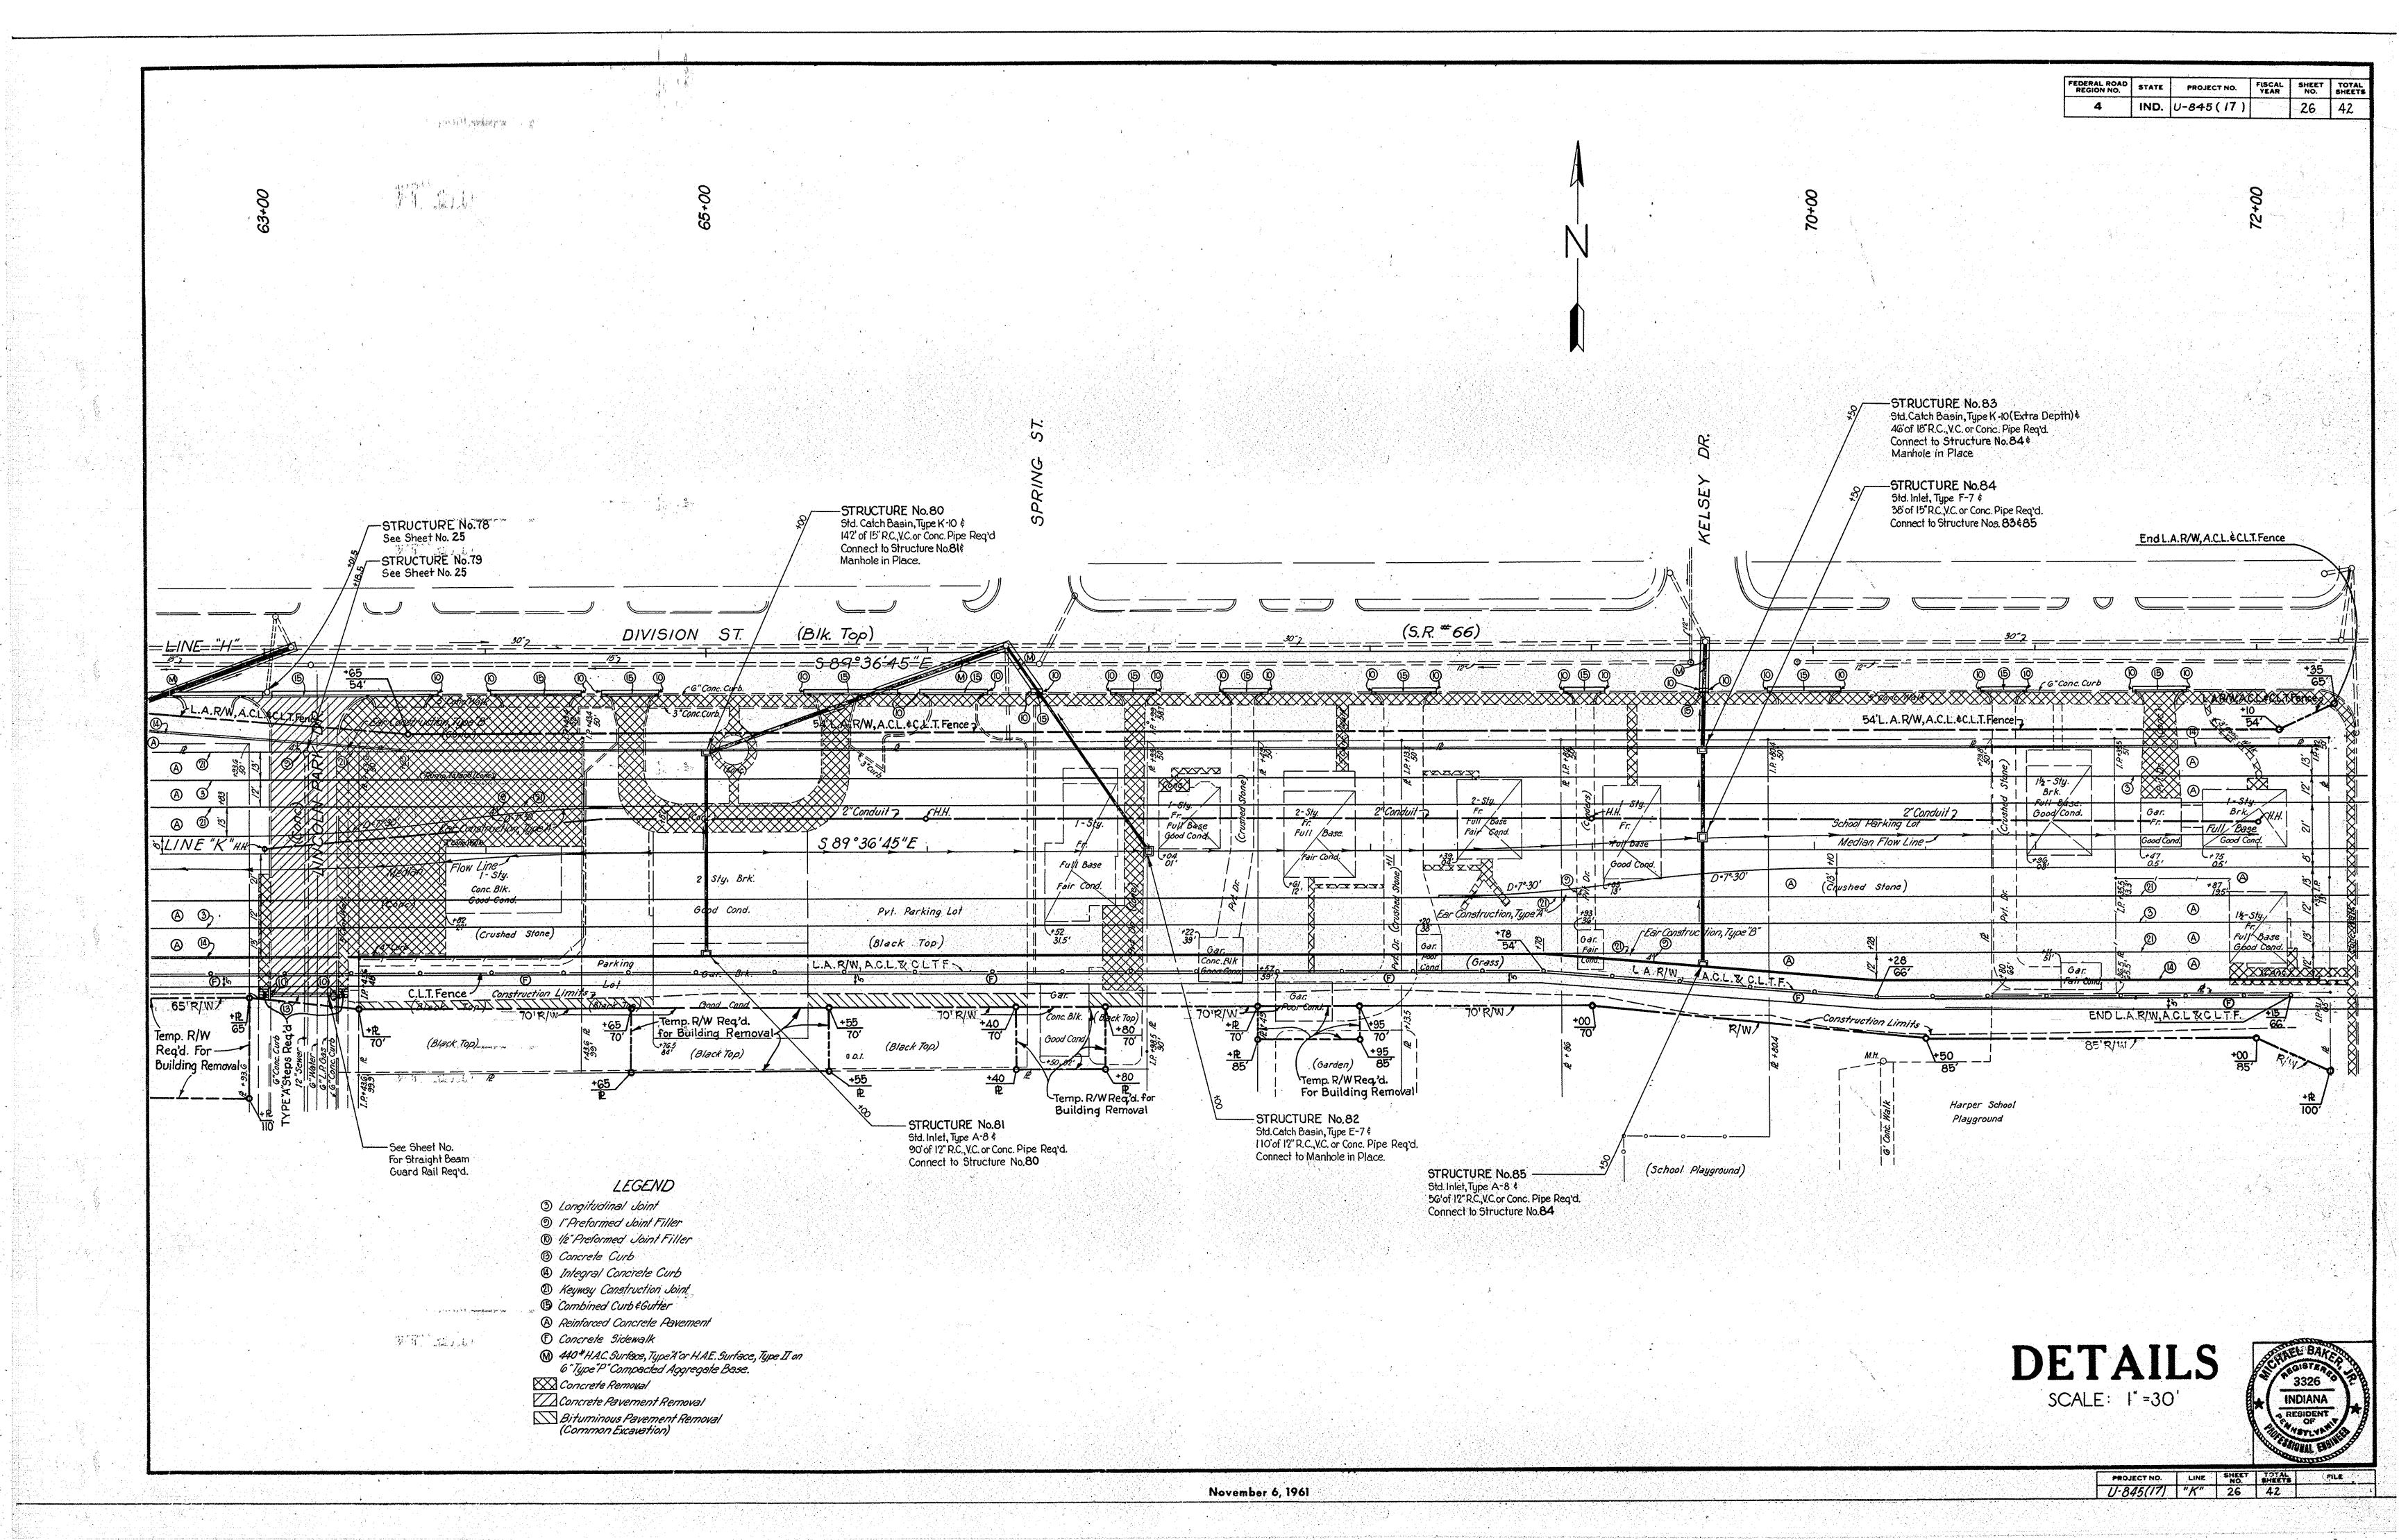


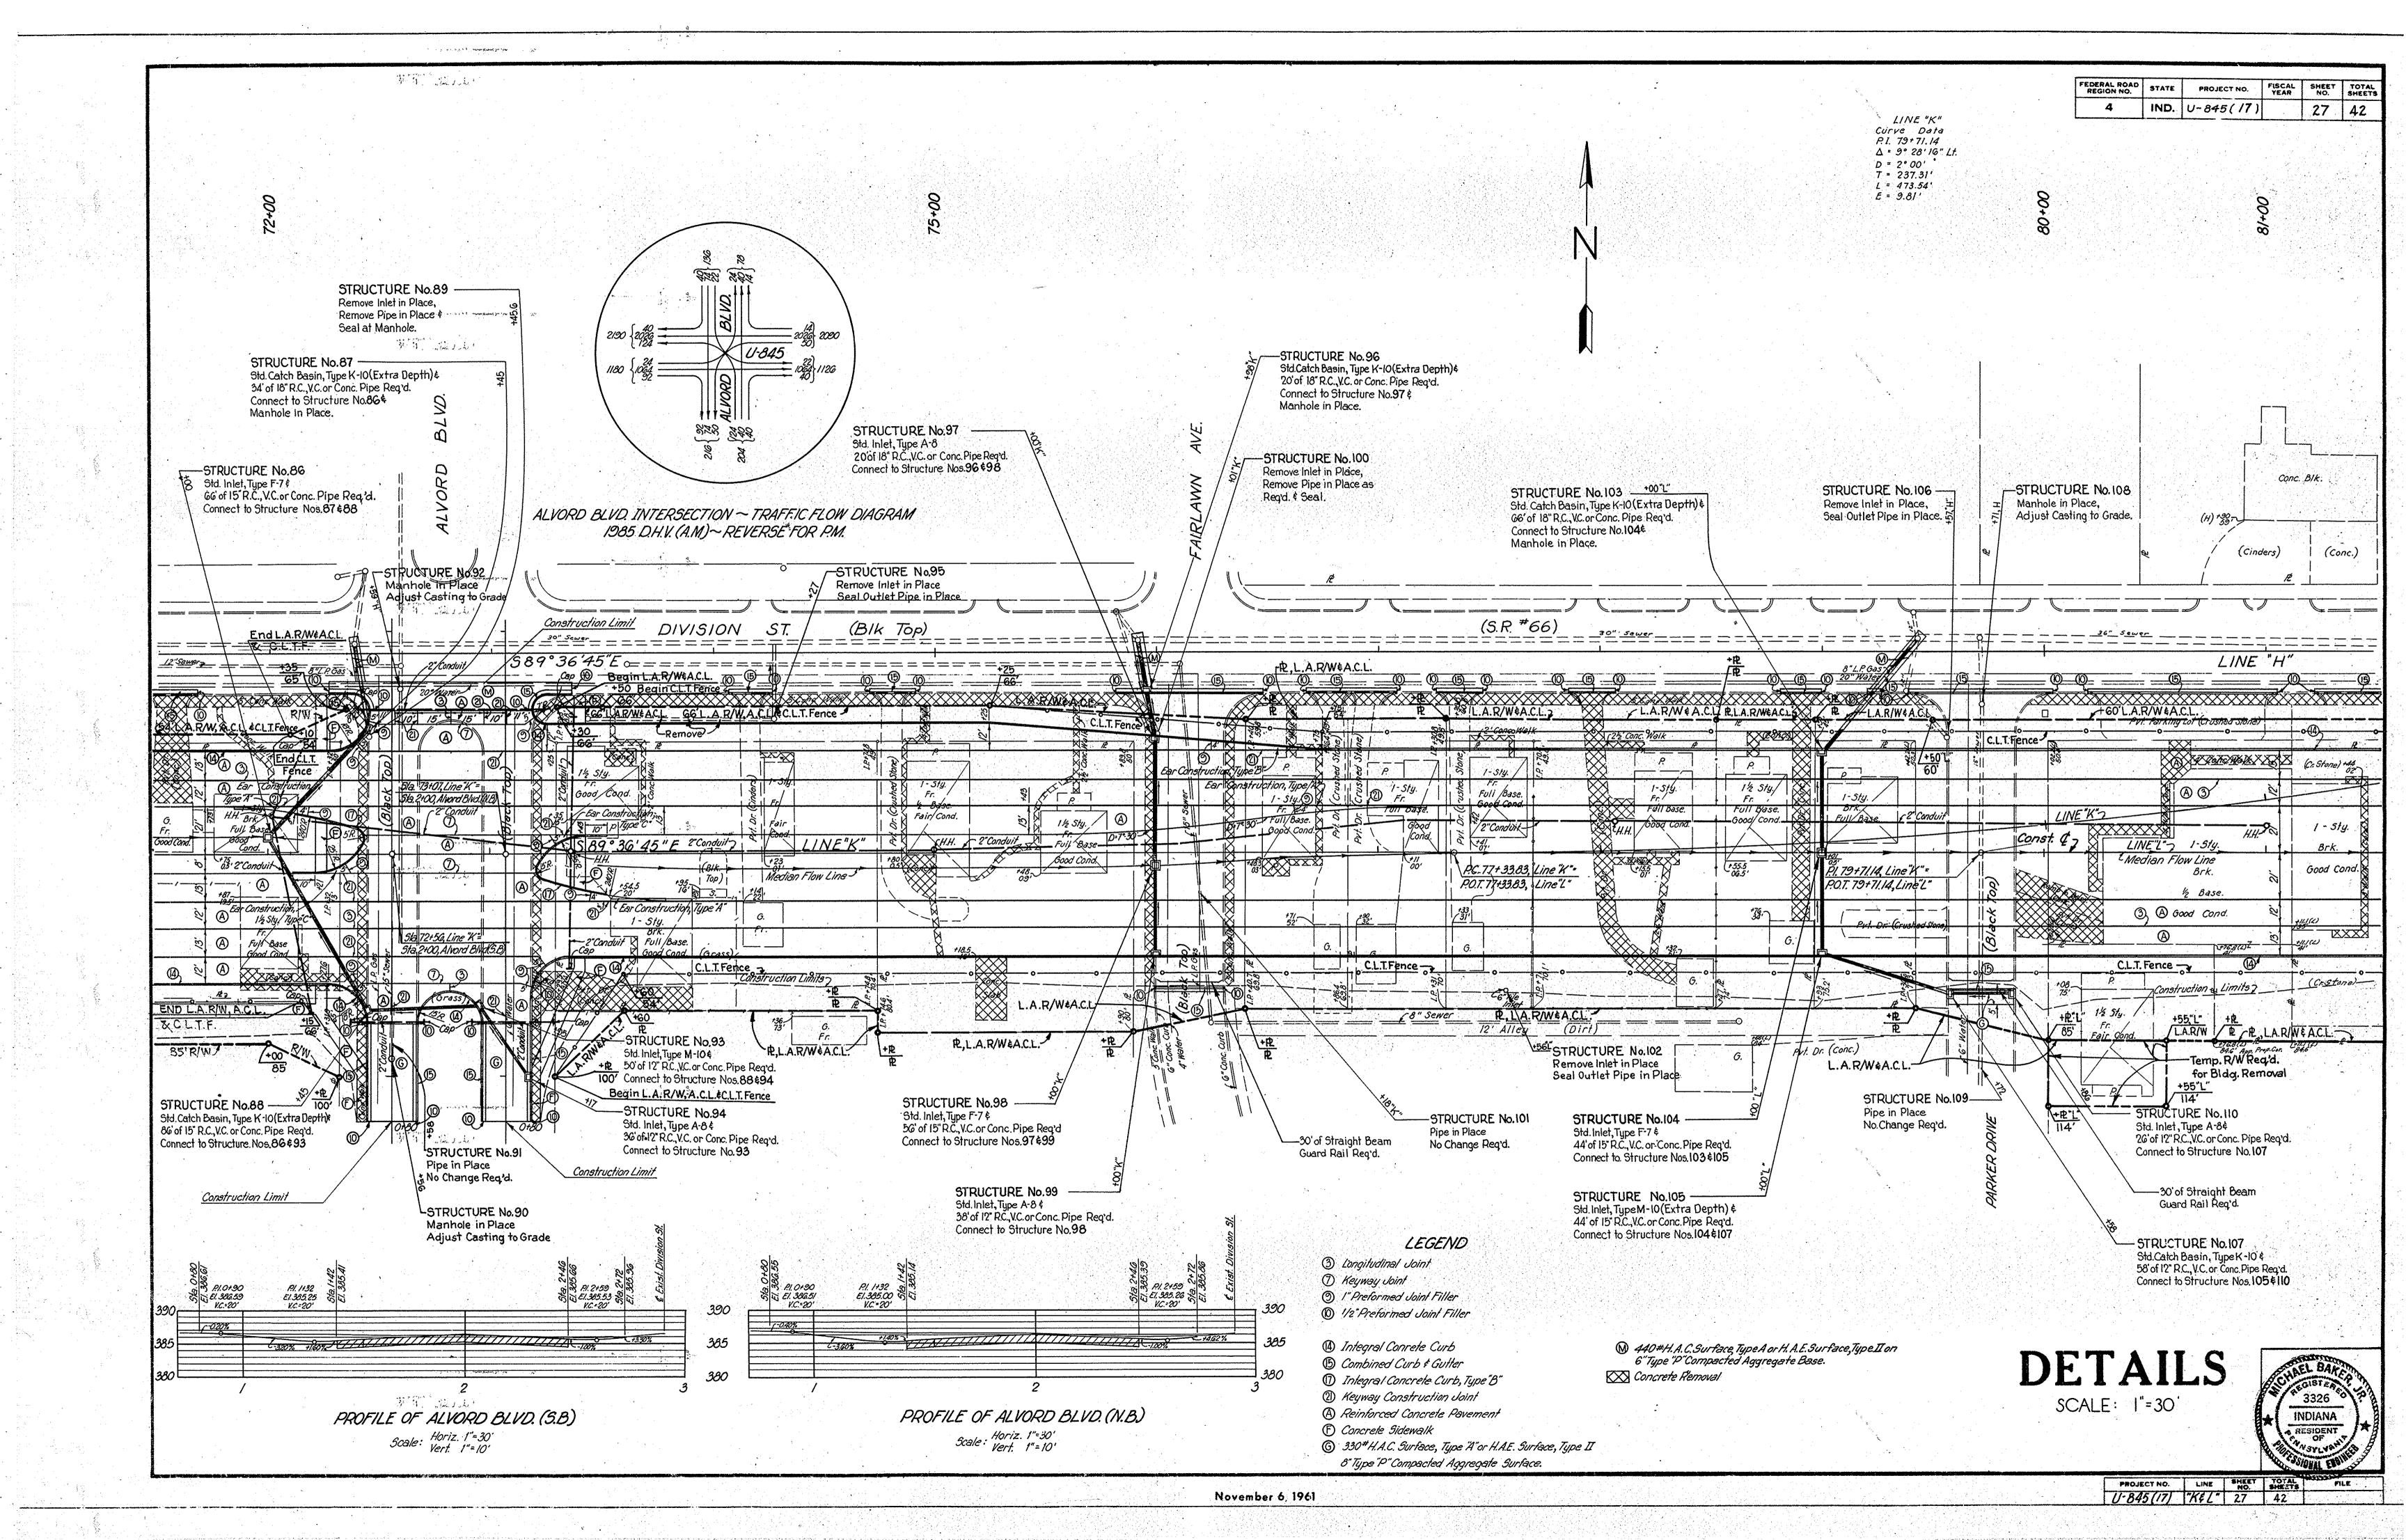


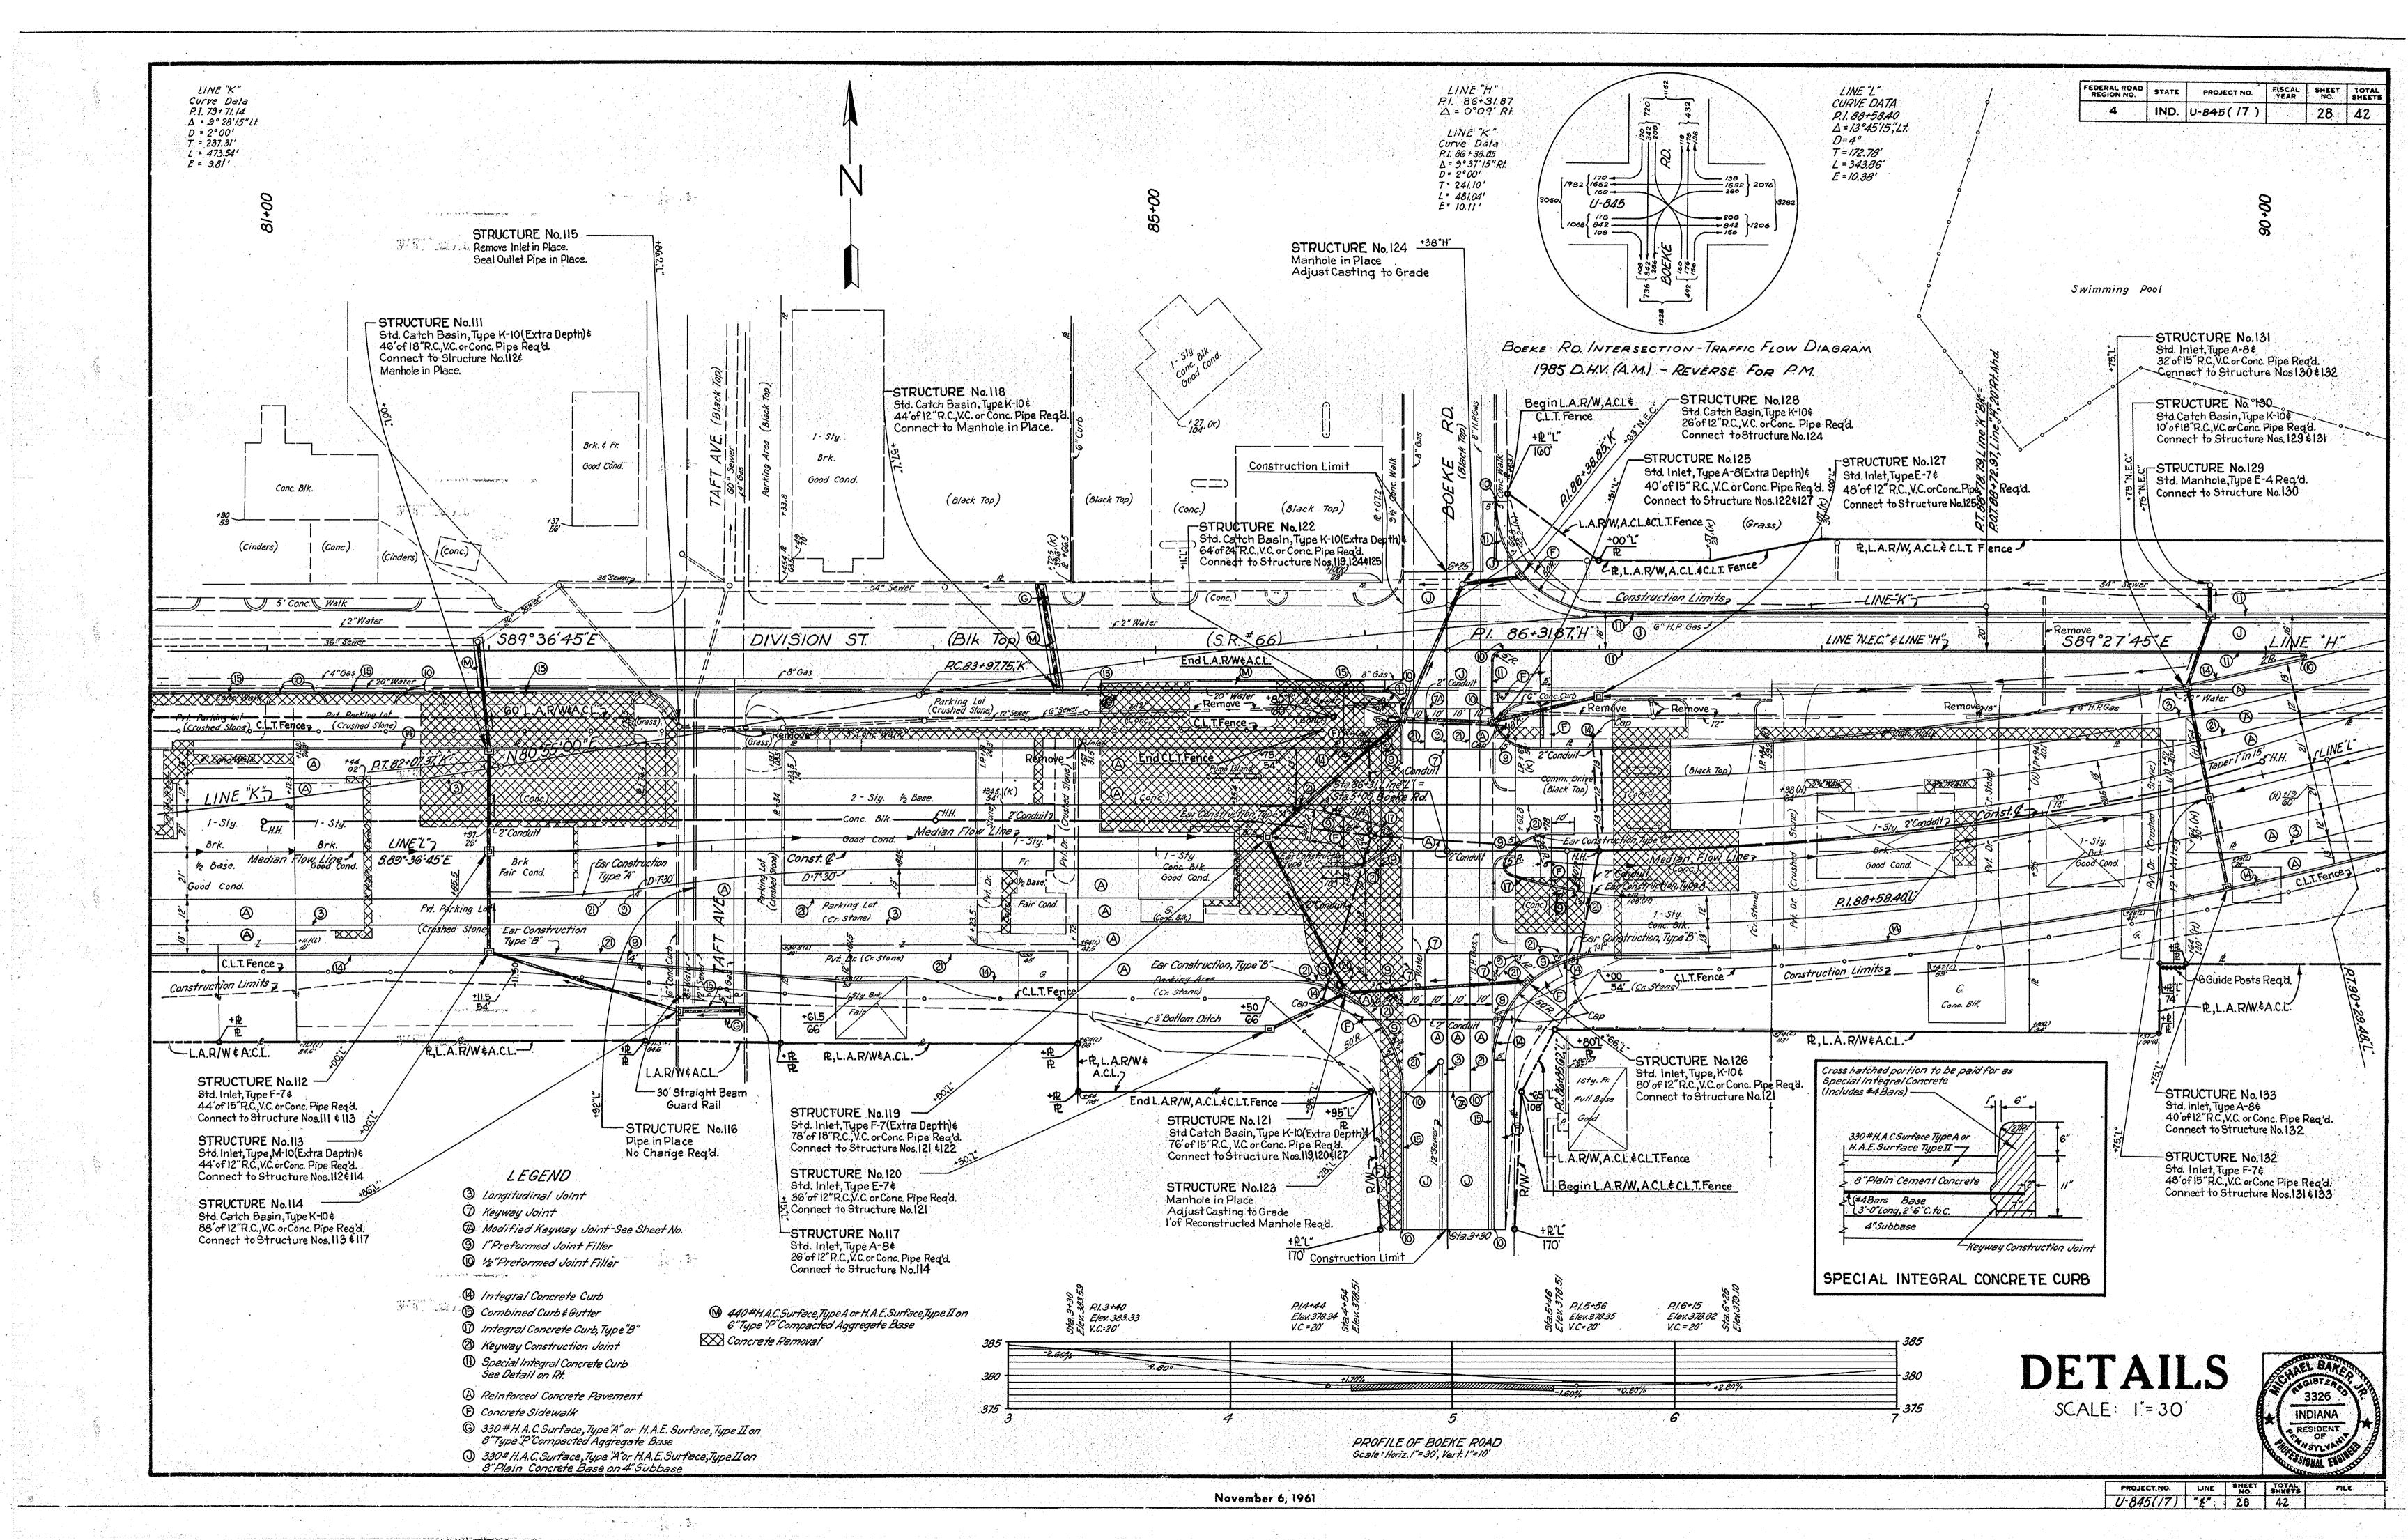

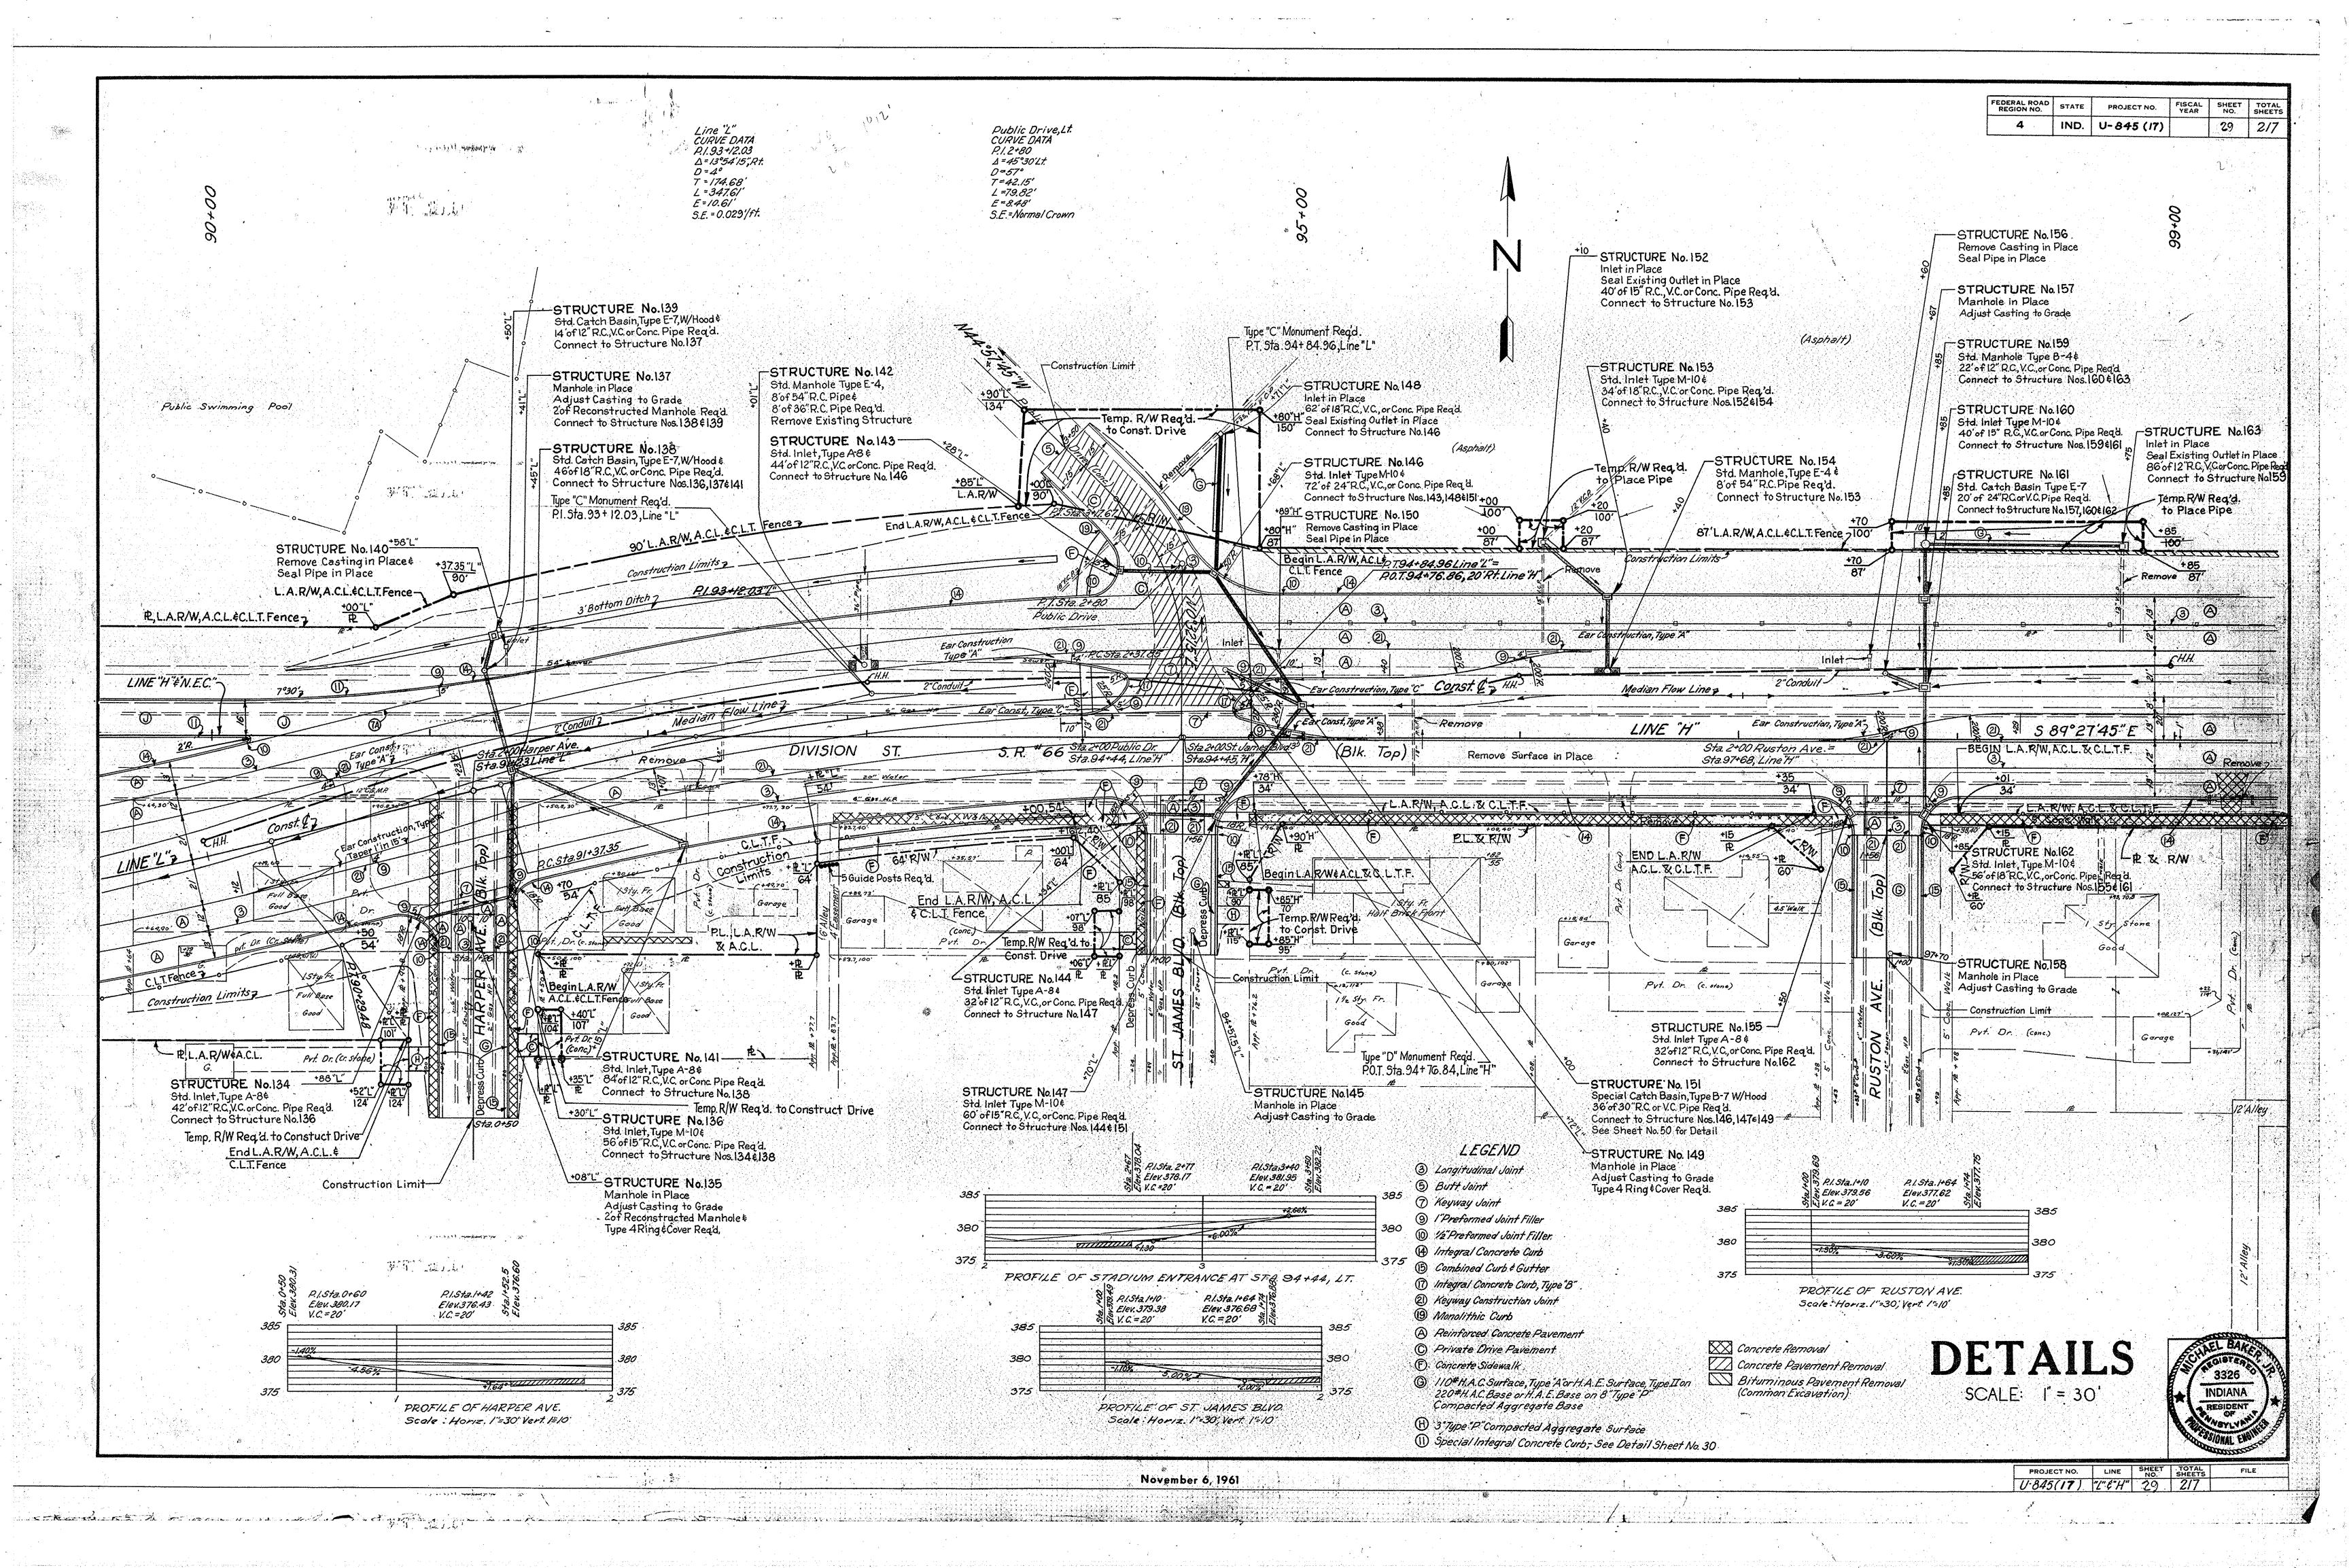

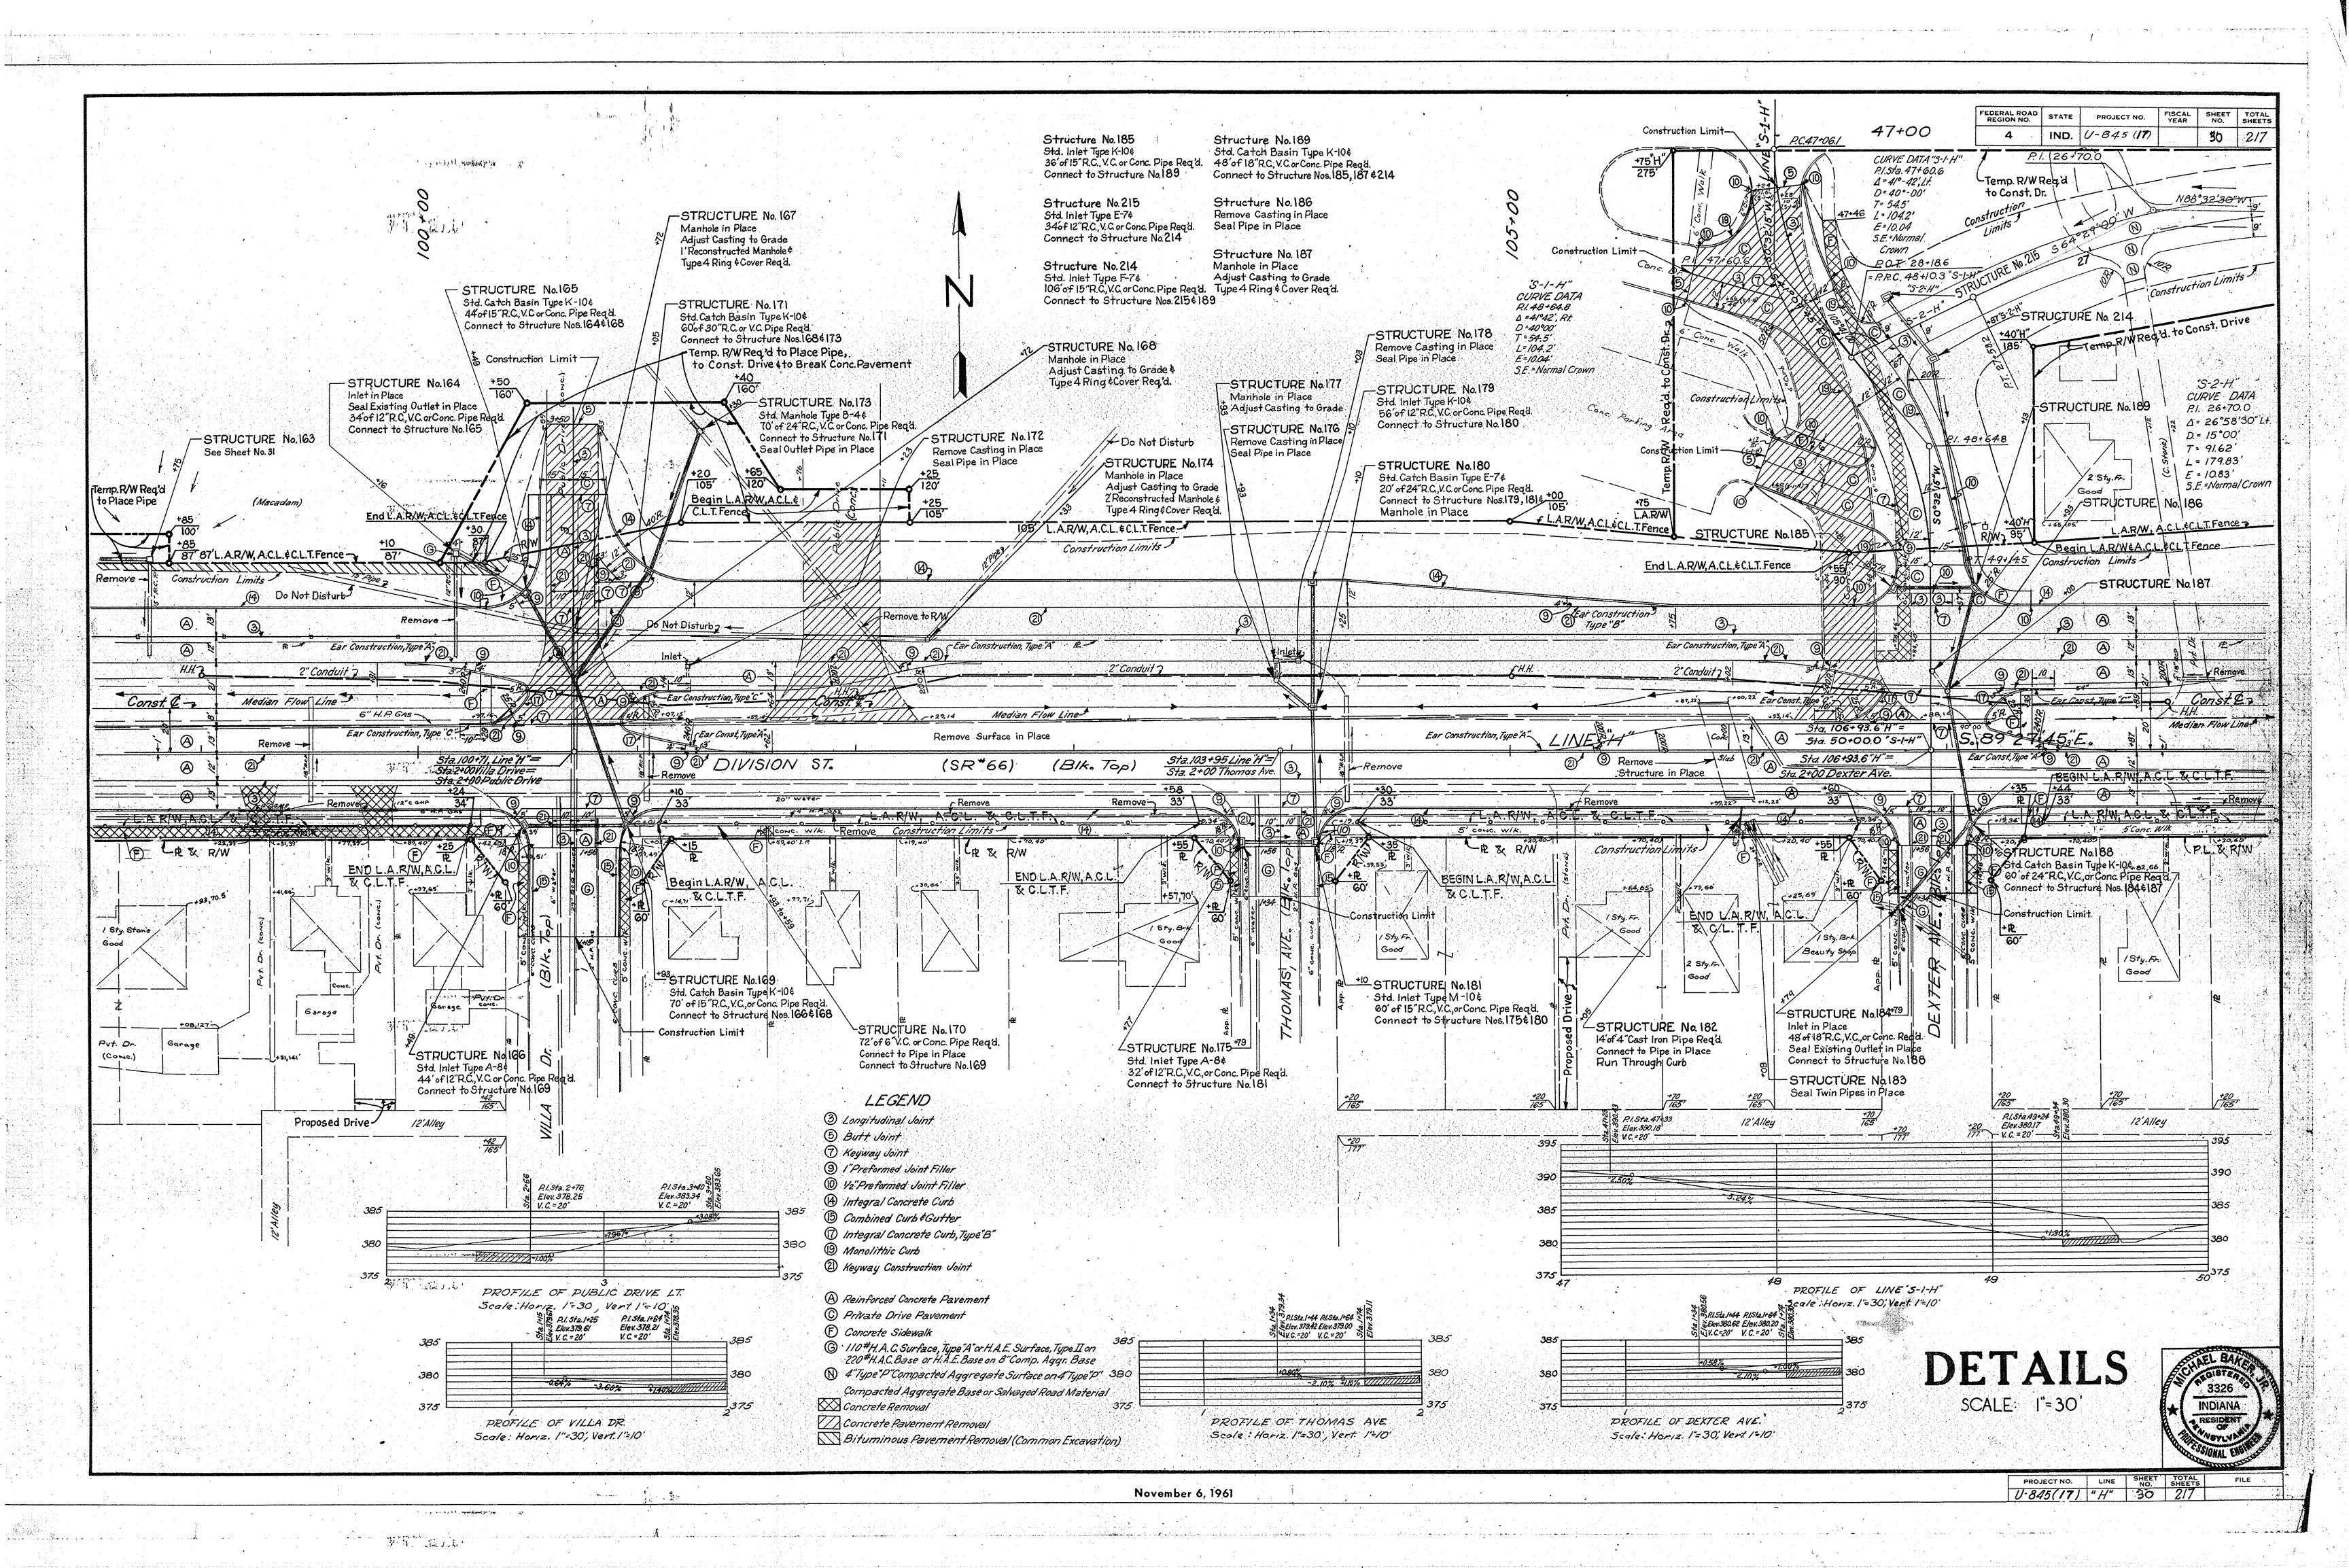


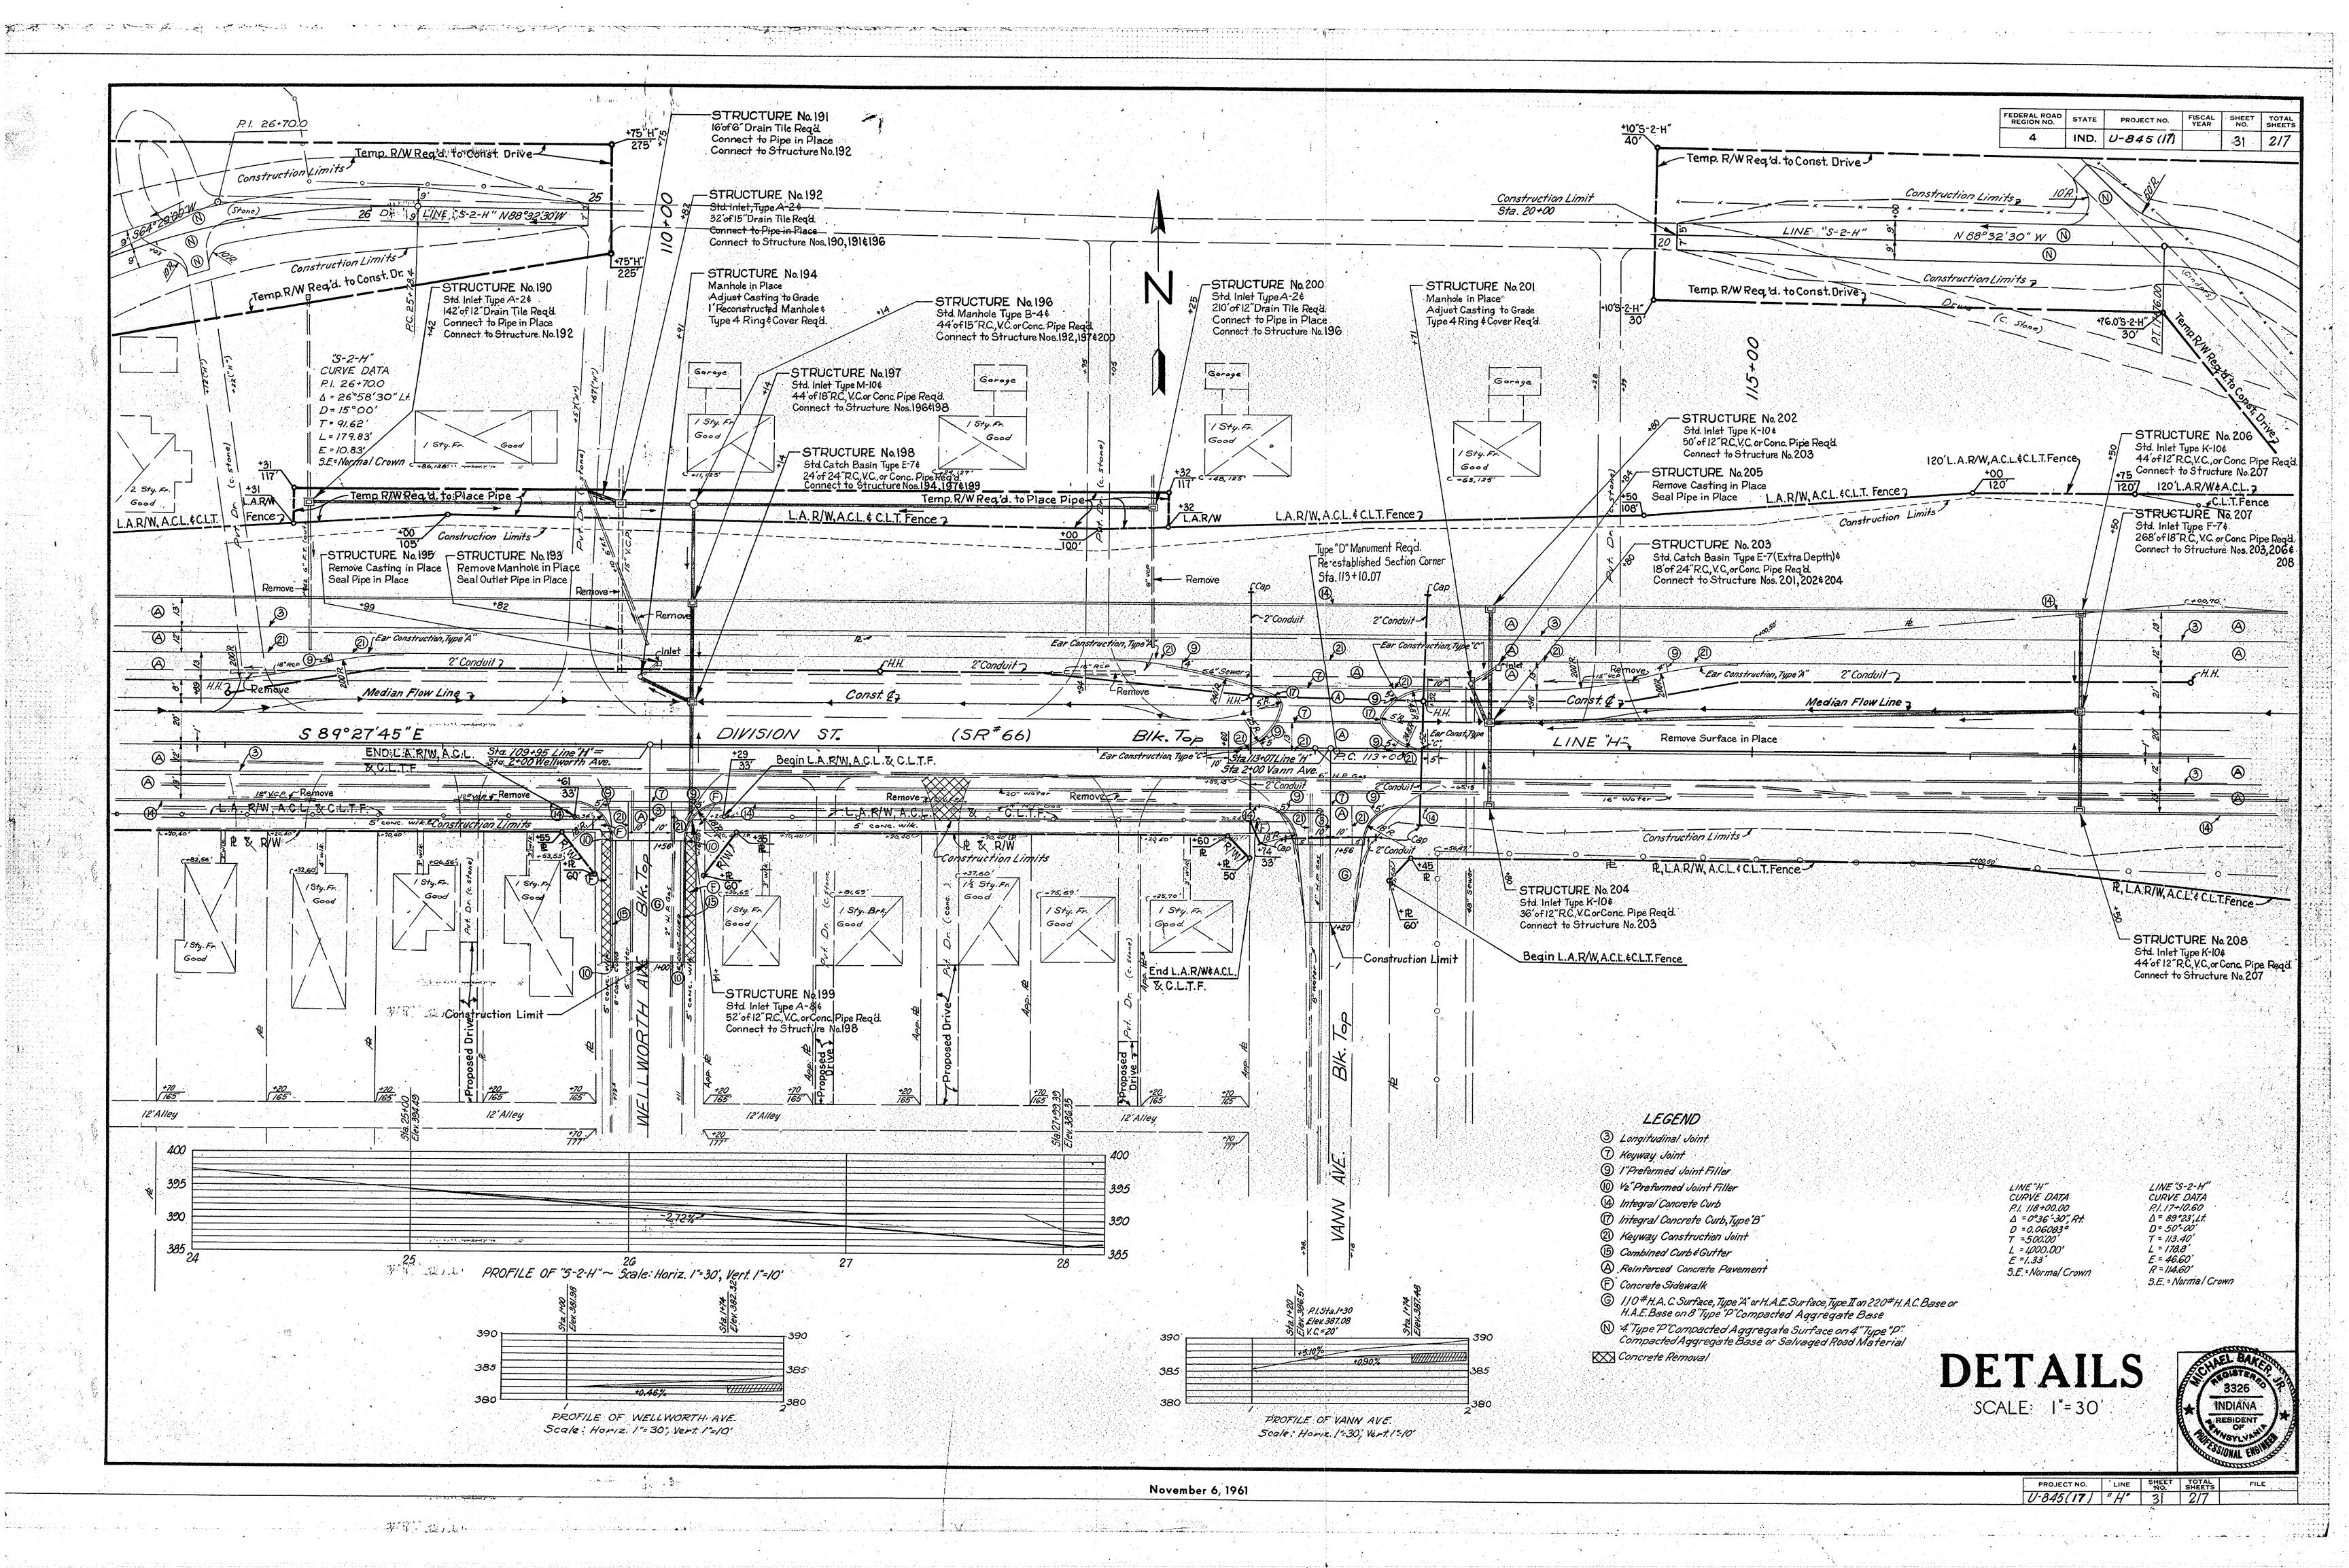

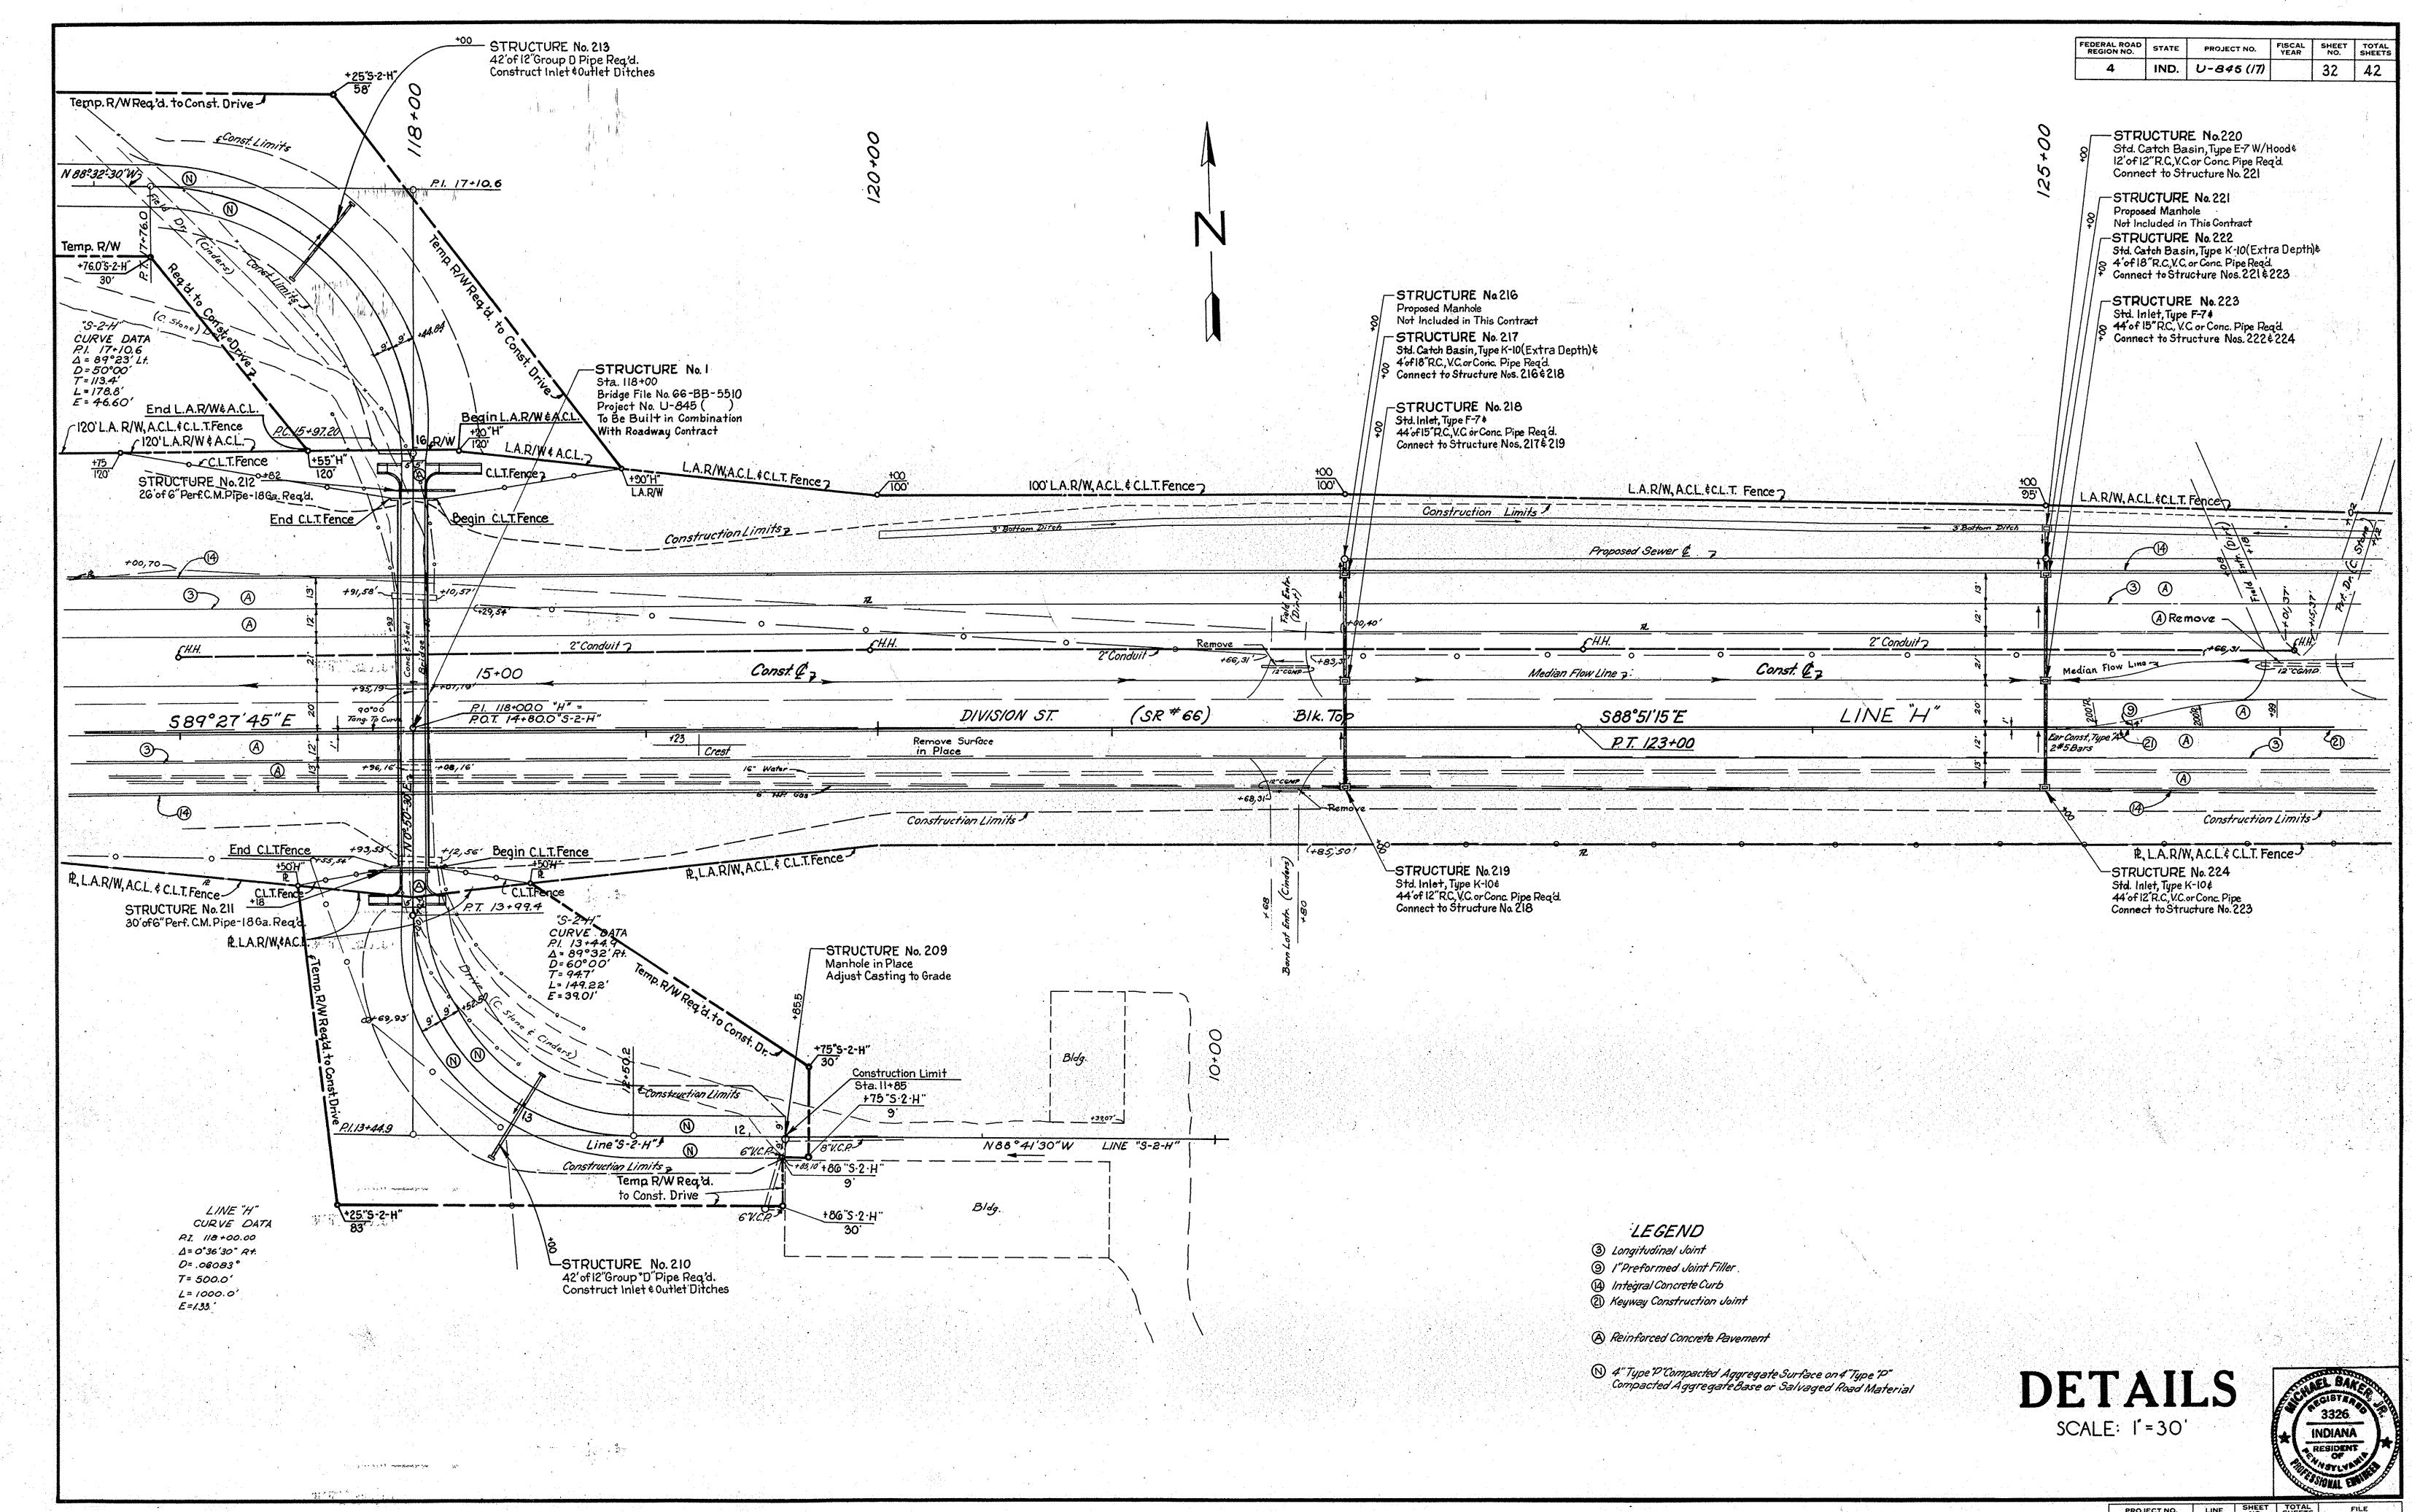


 PROJECT NO.
 LINE
 SHEET NO.
 TOTAL SHEETS


 U-845(17)
 "H"
 32
 42

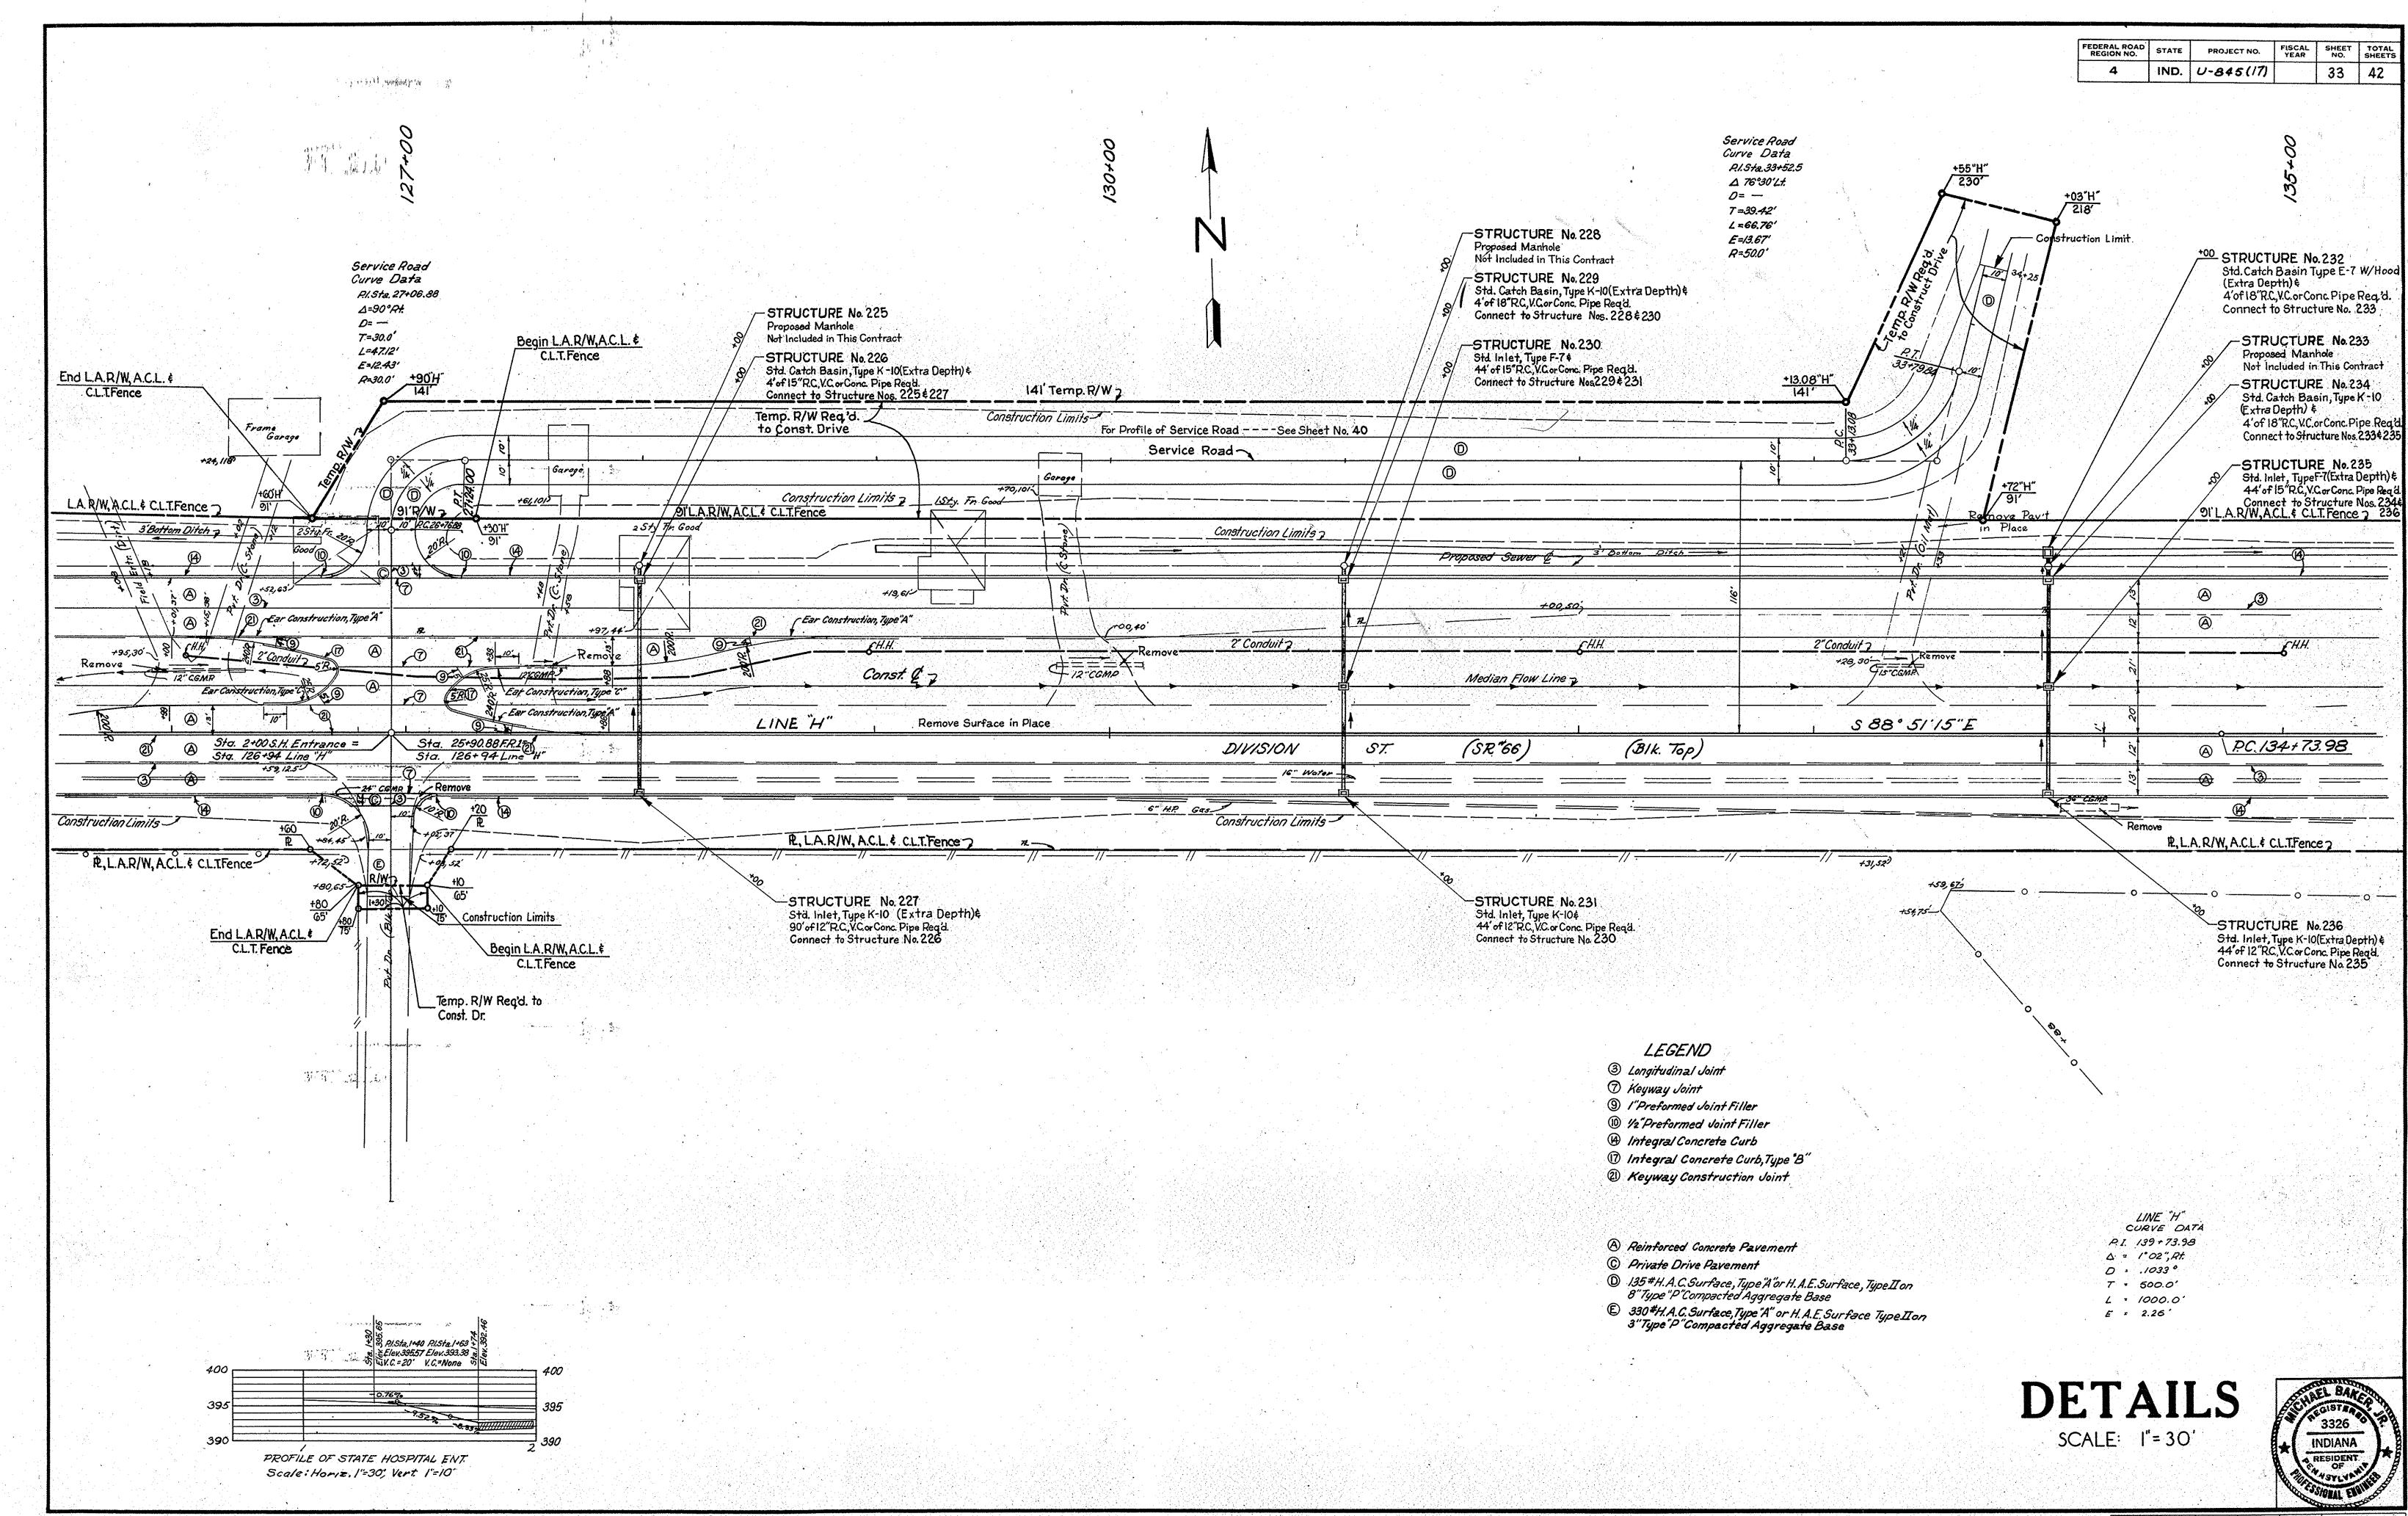



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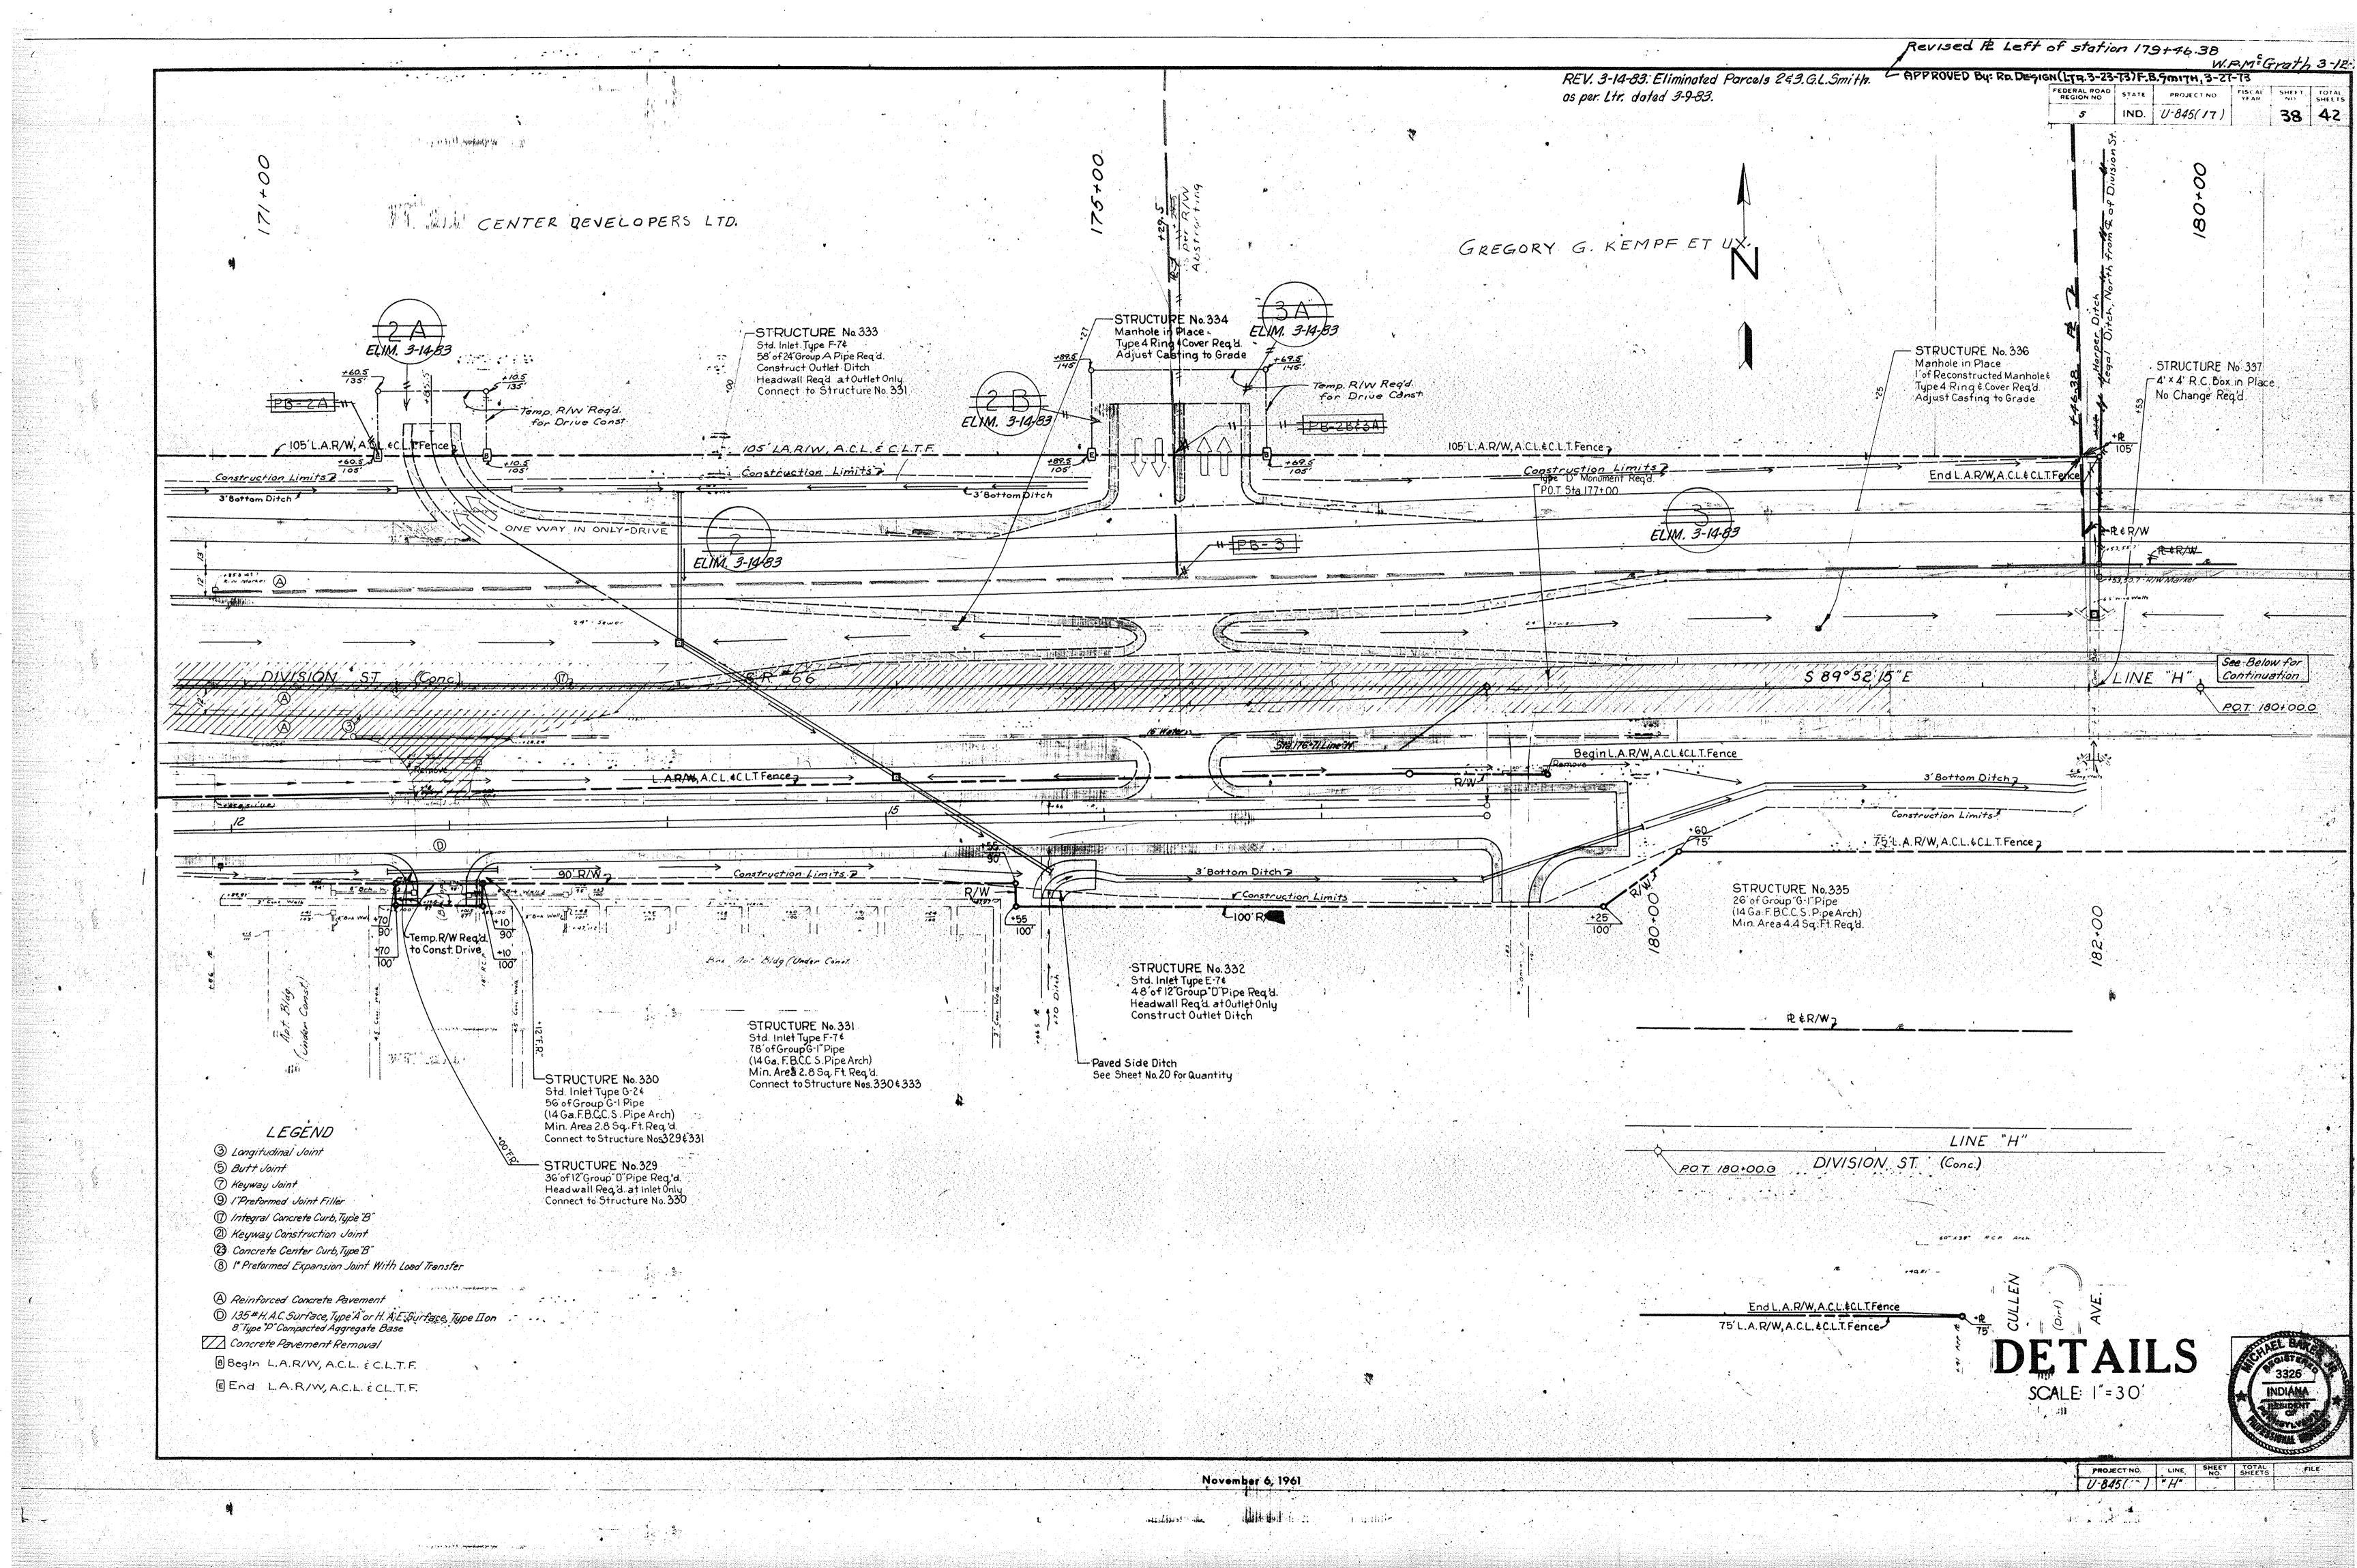
U-845(17) "H" 33 42




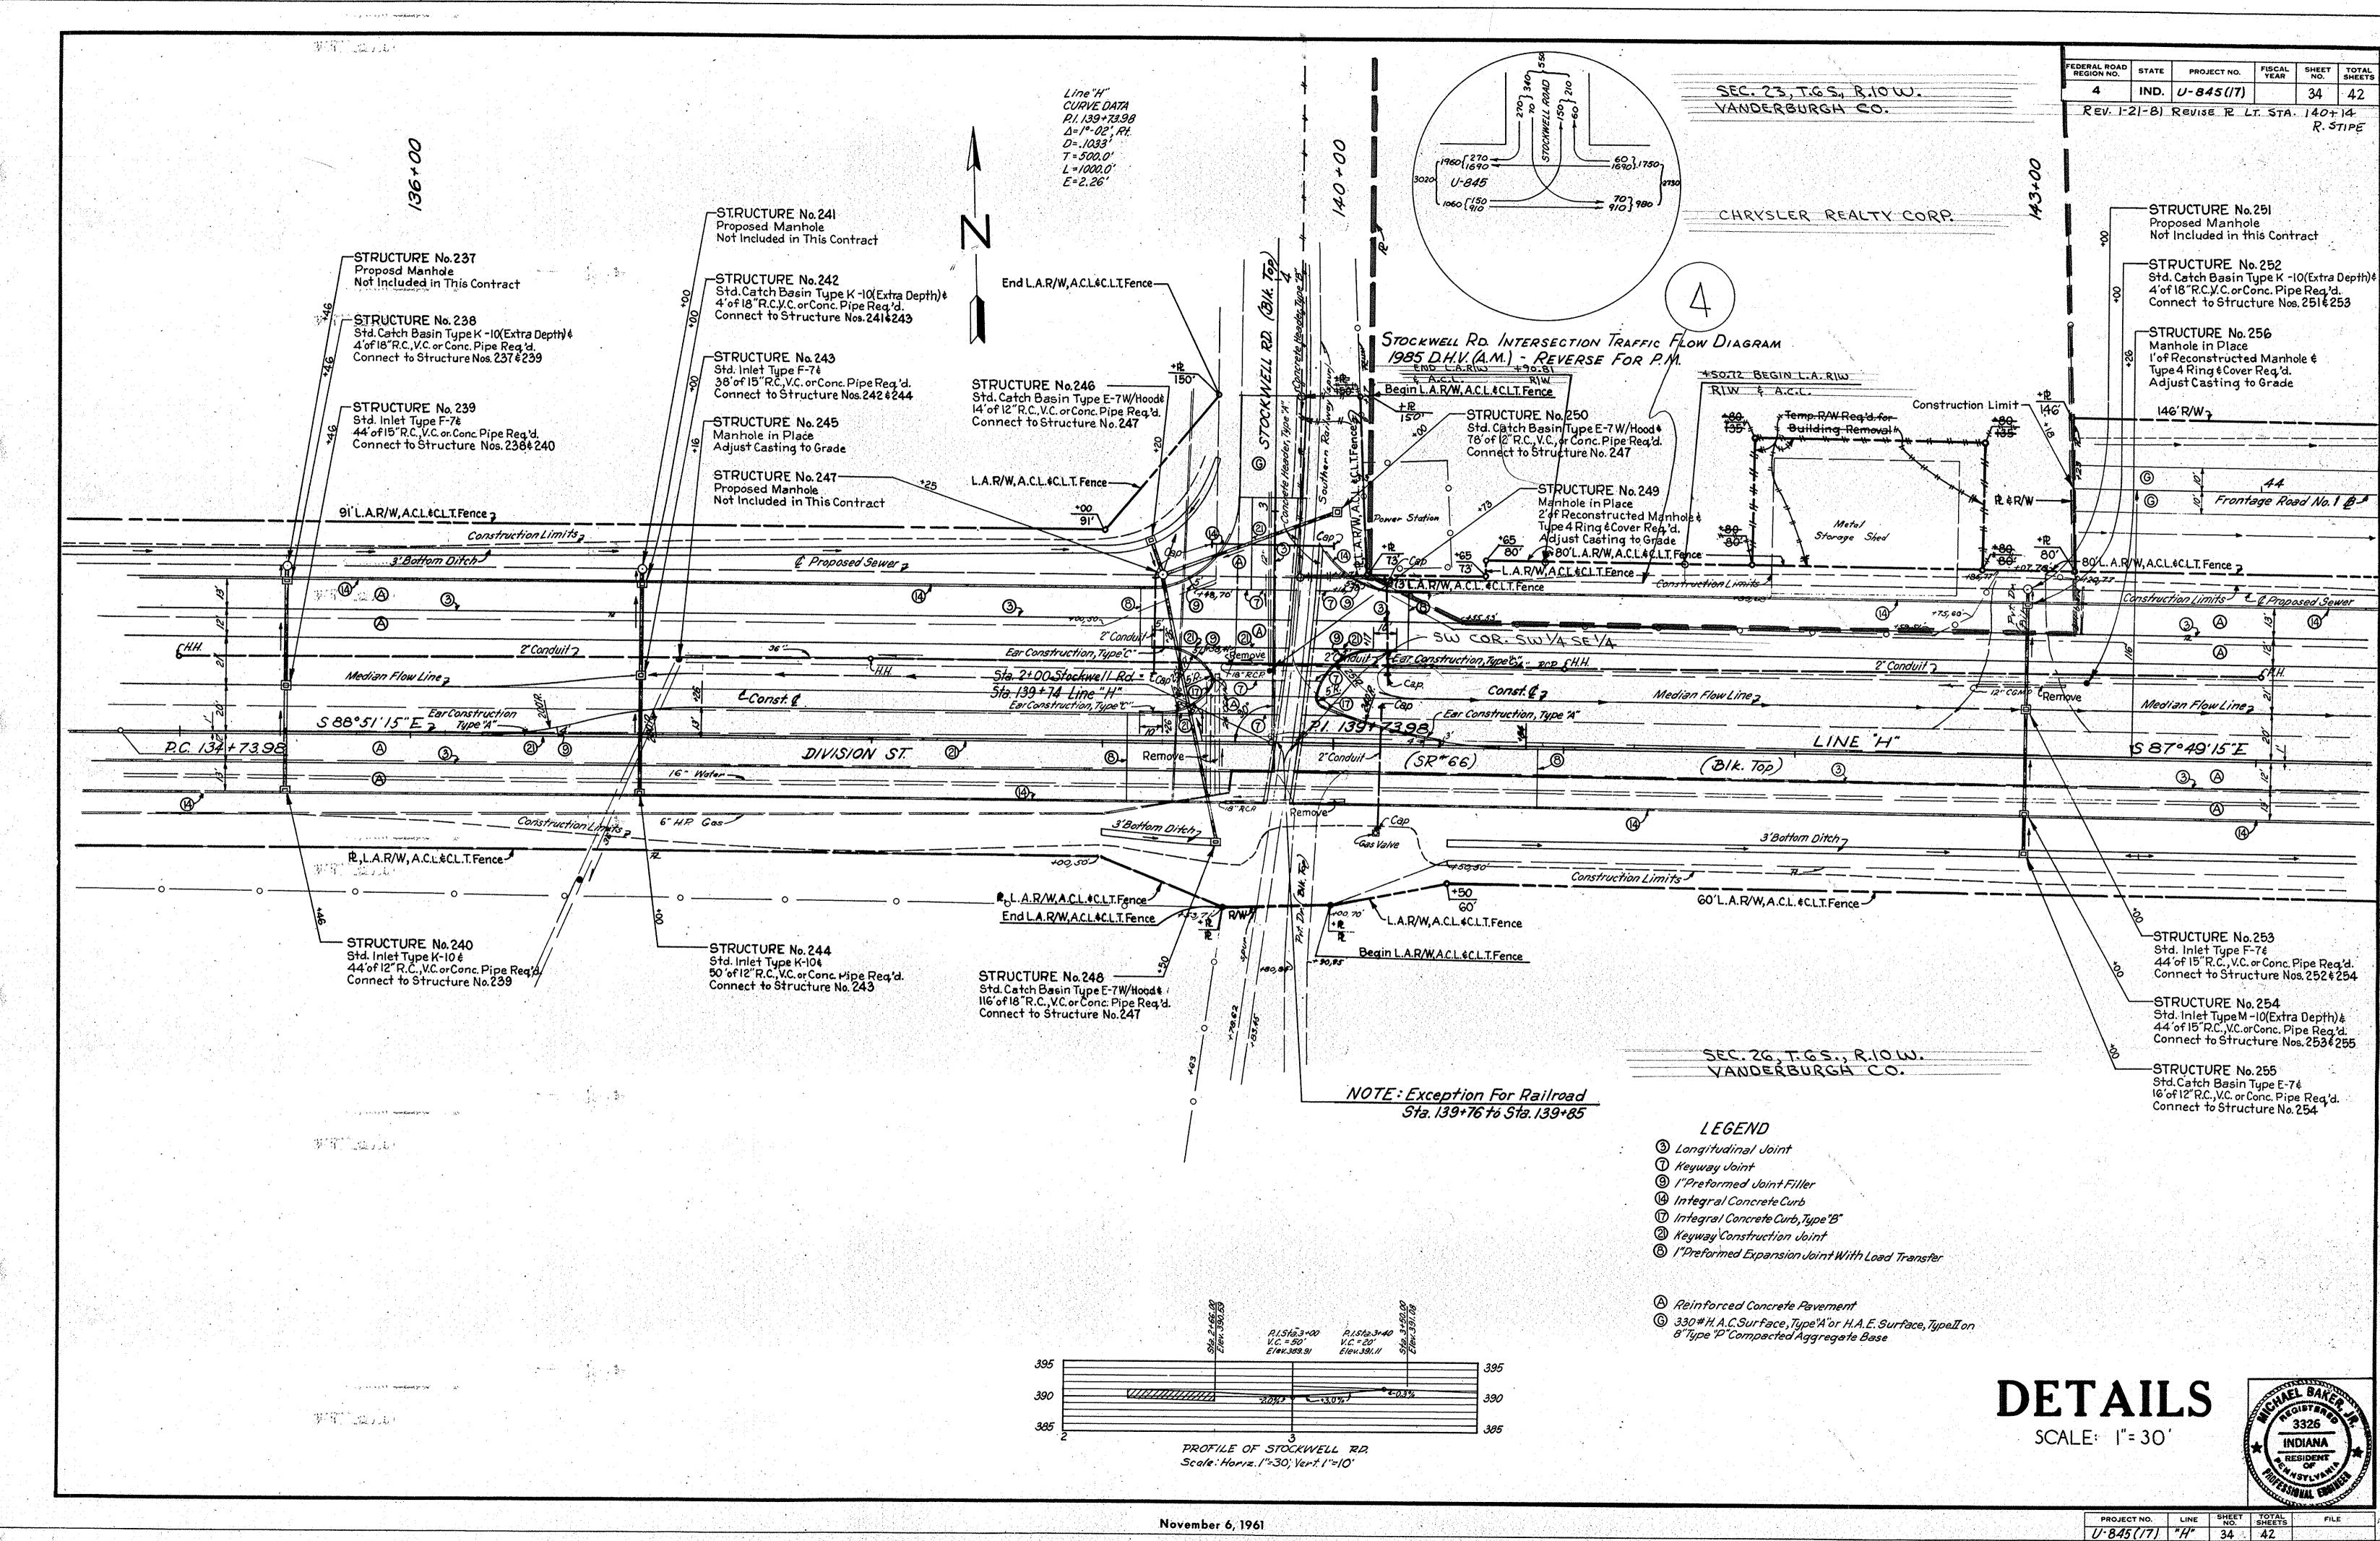

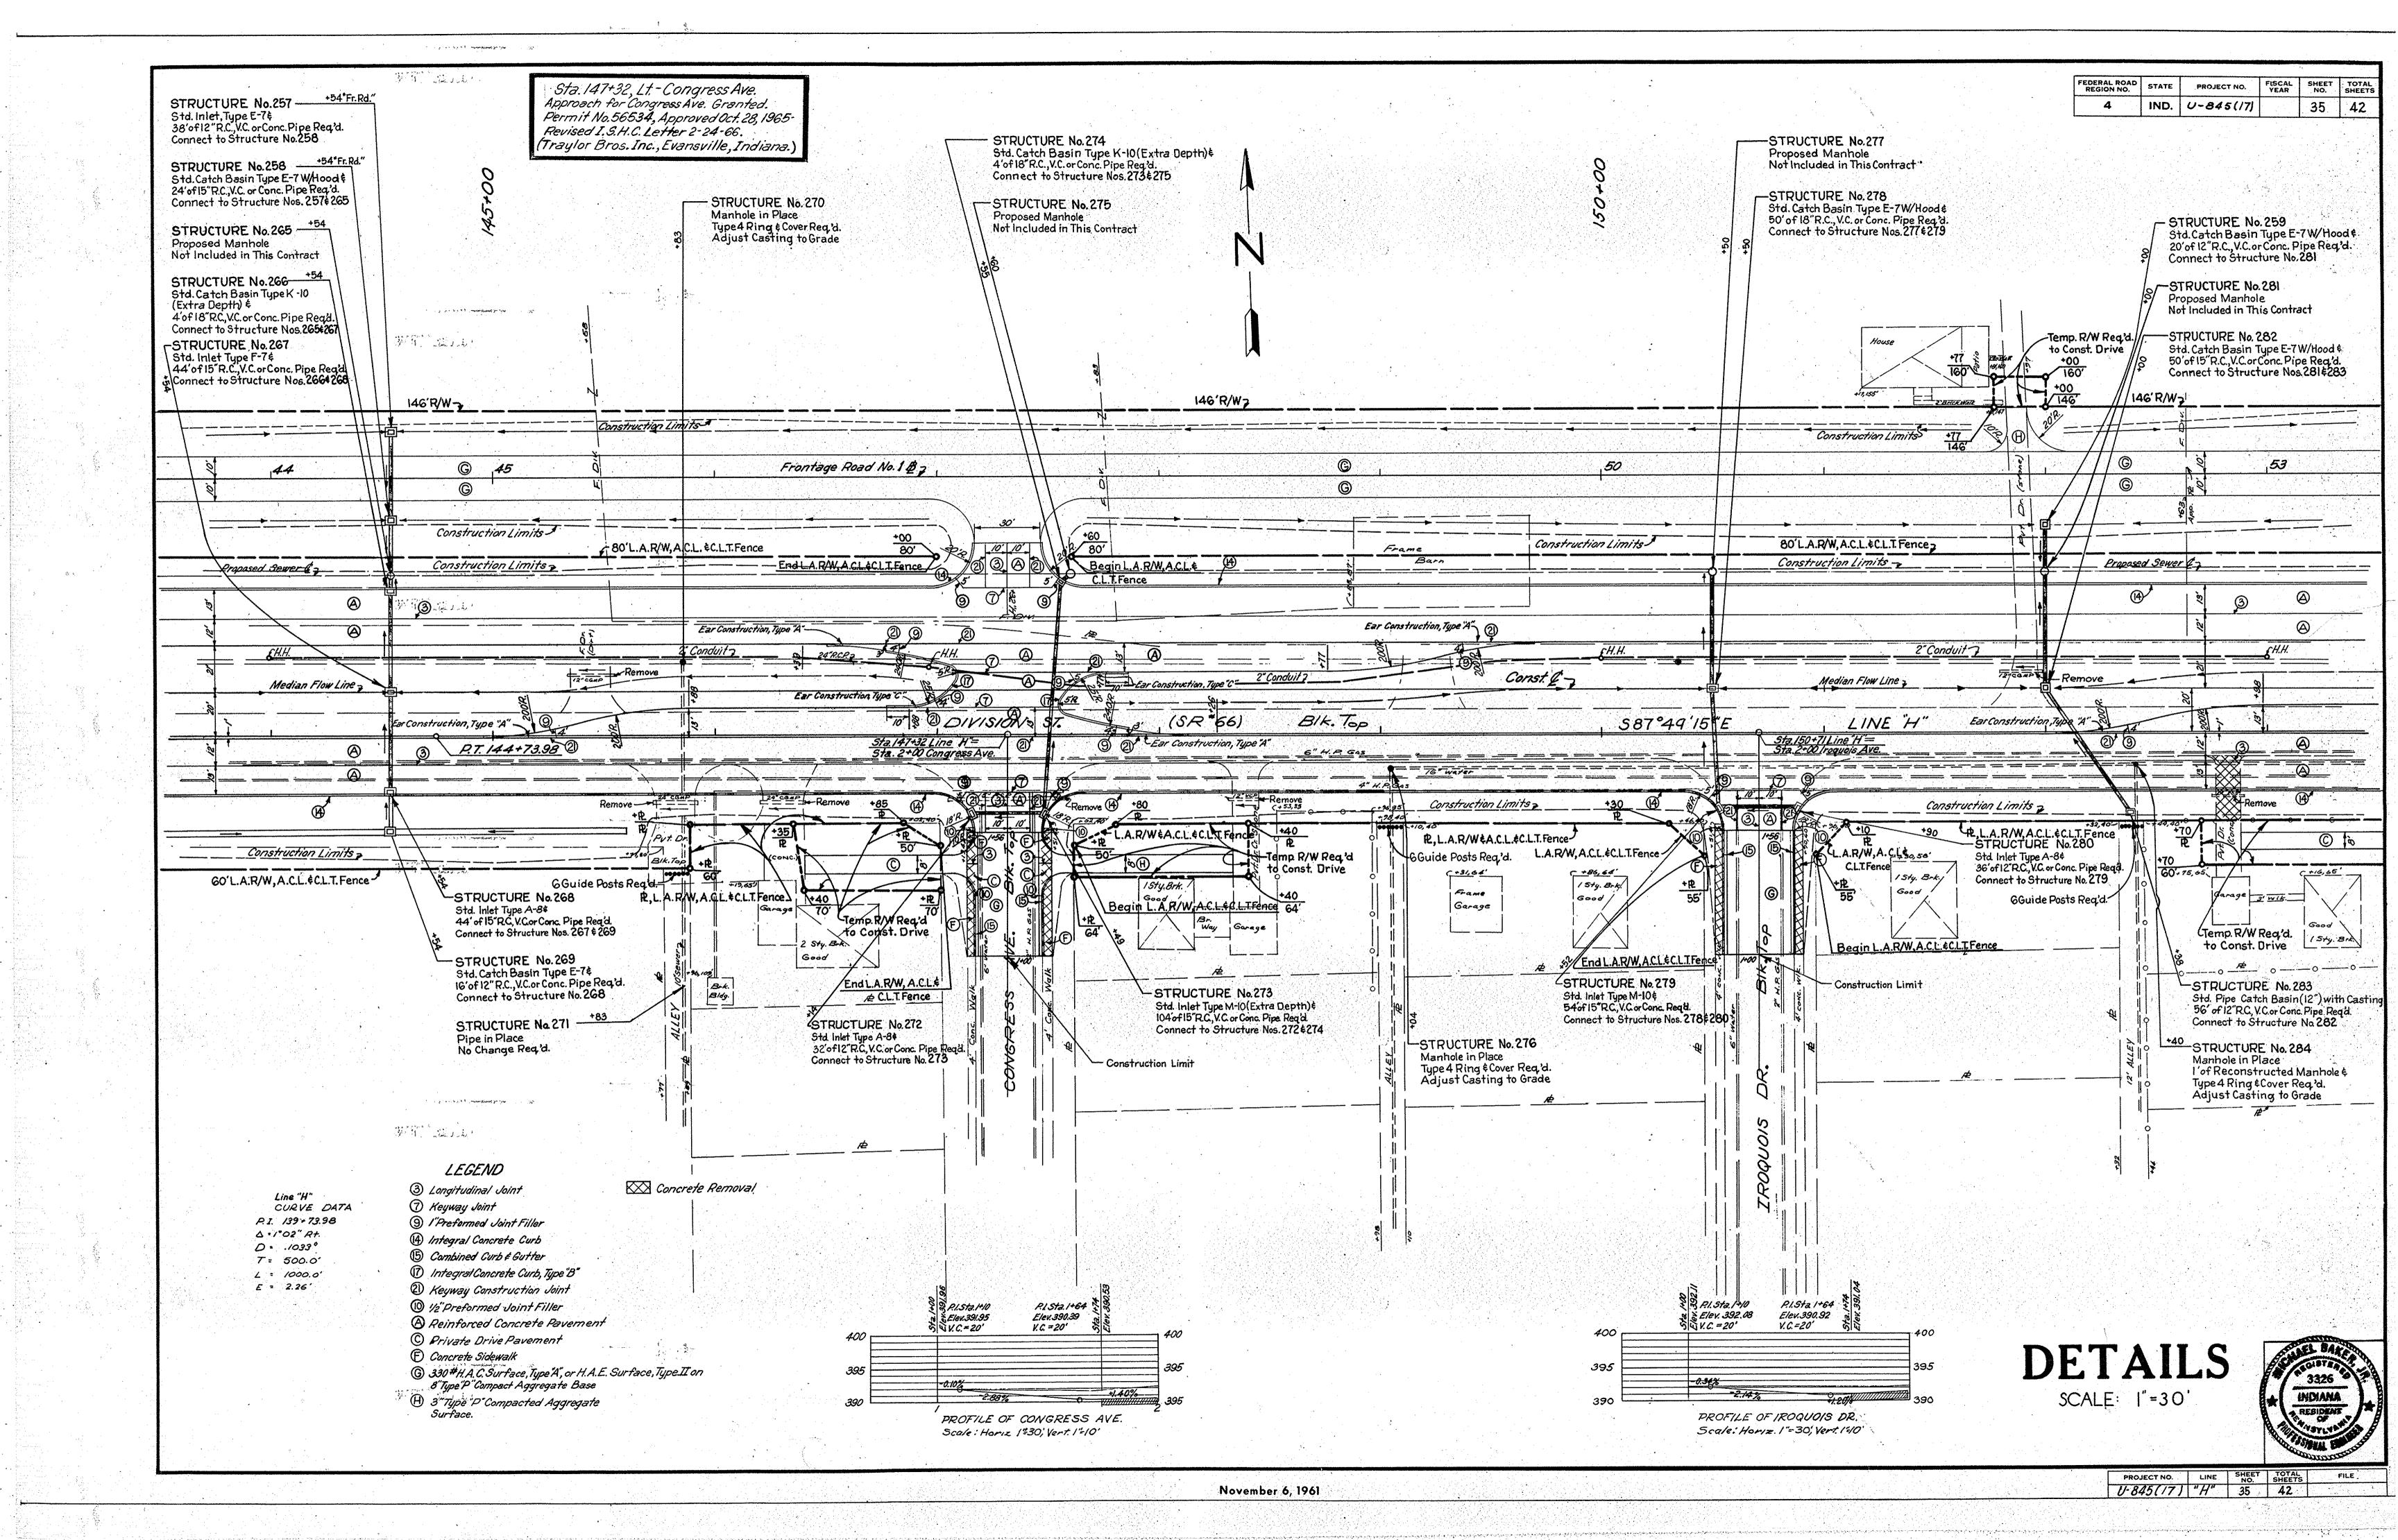


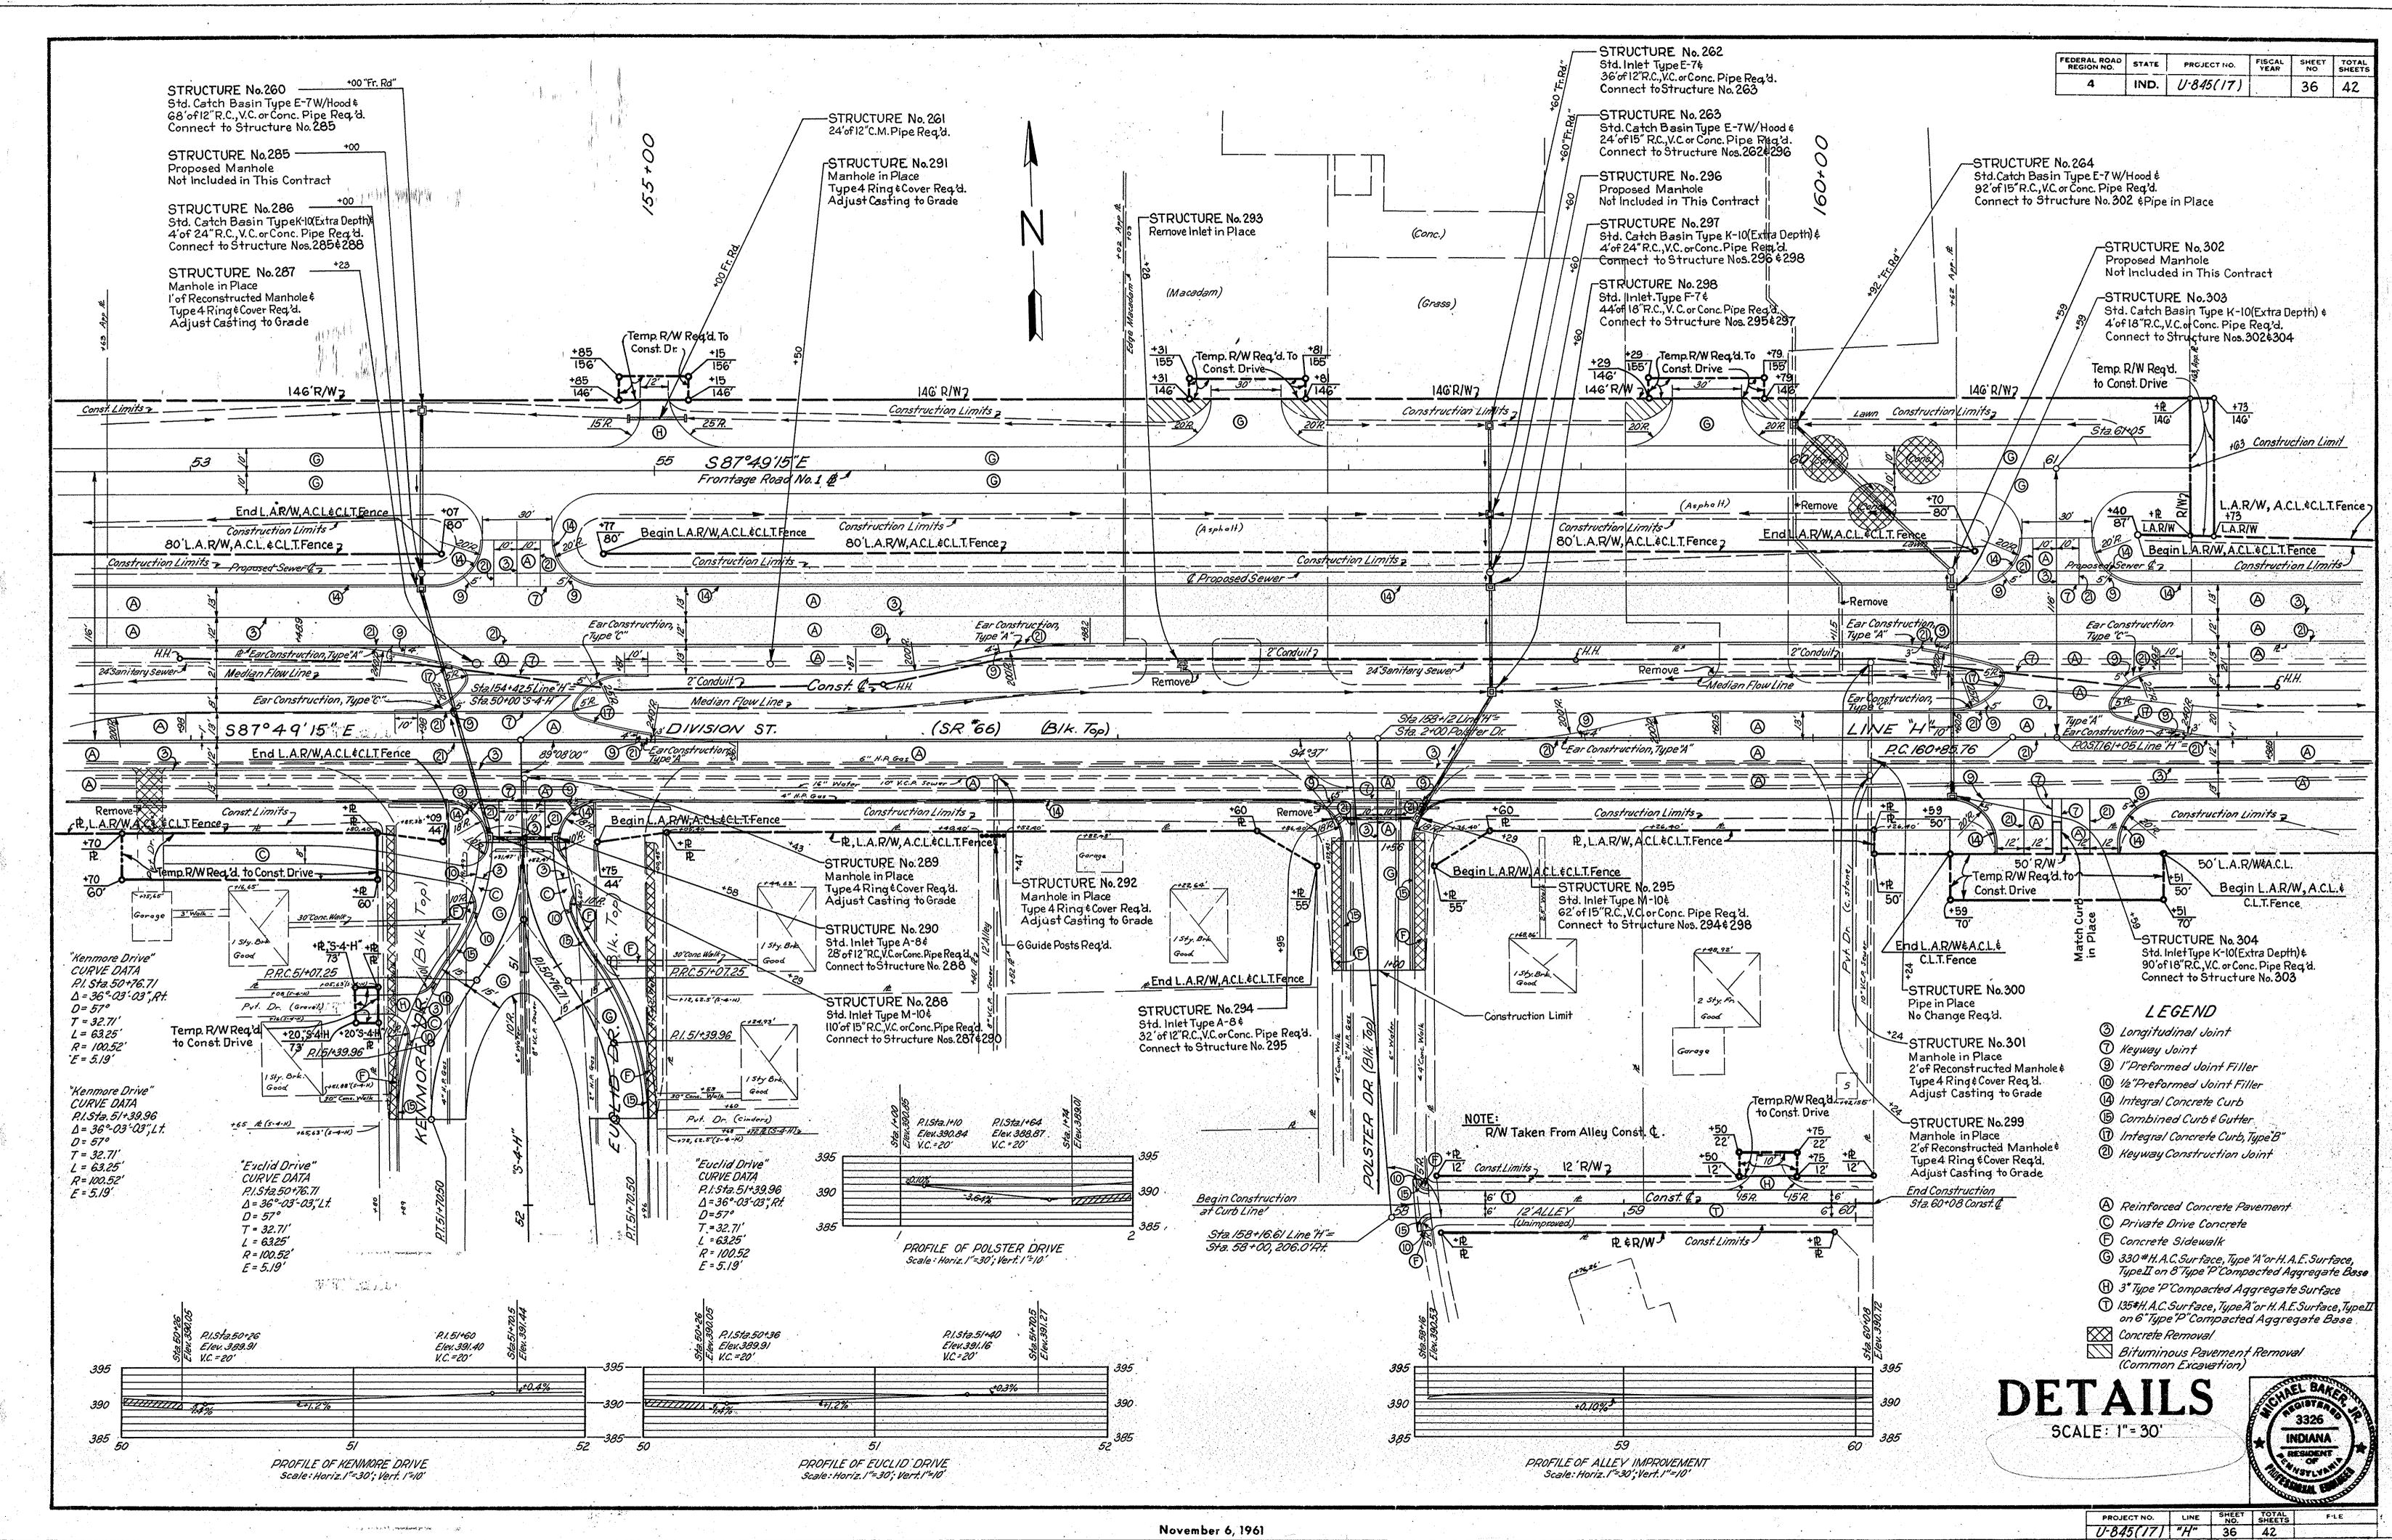

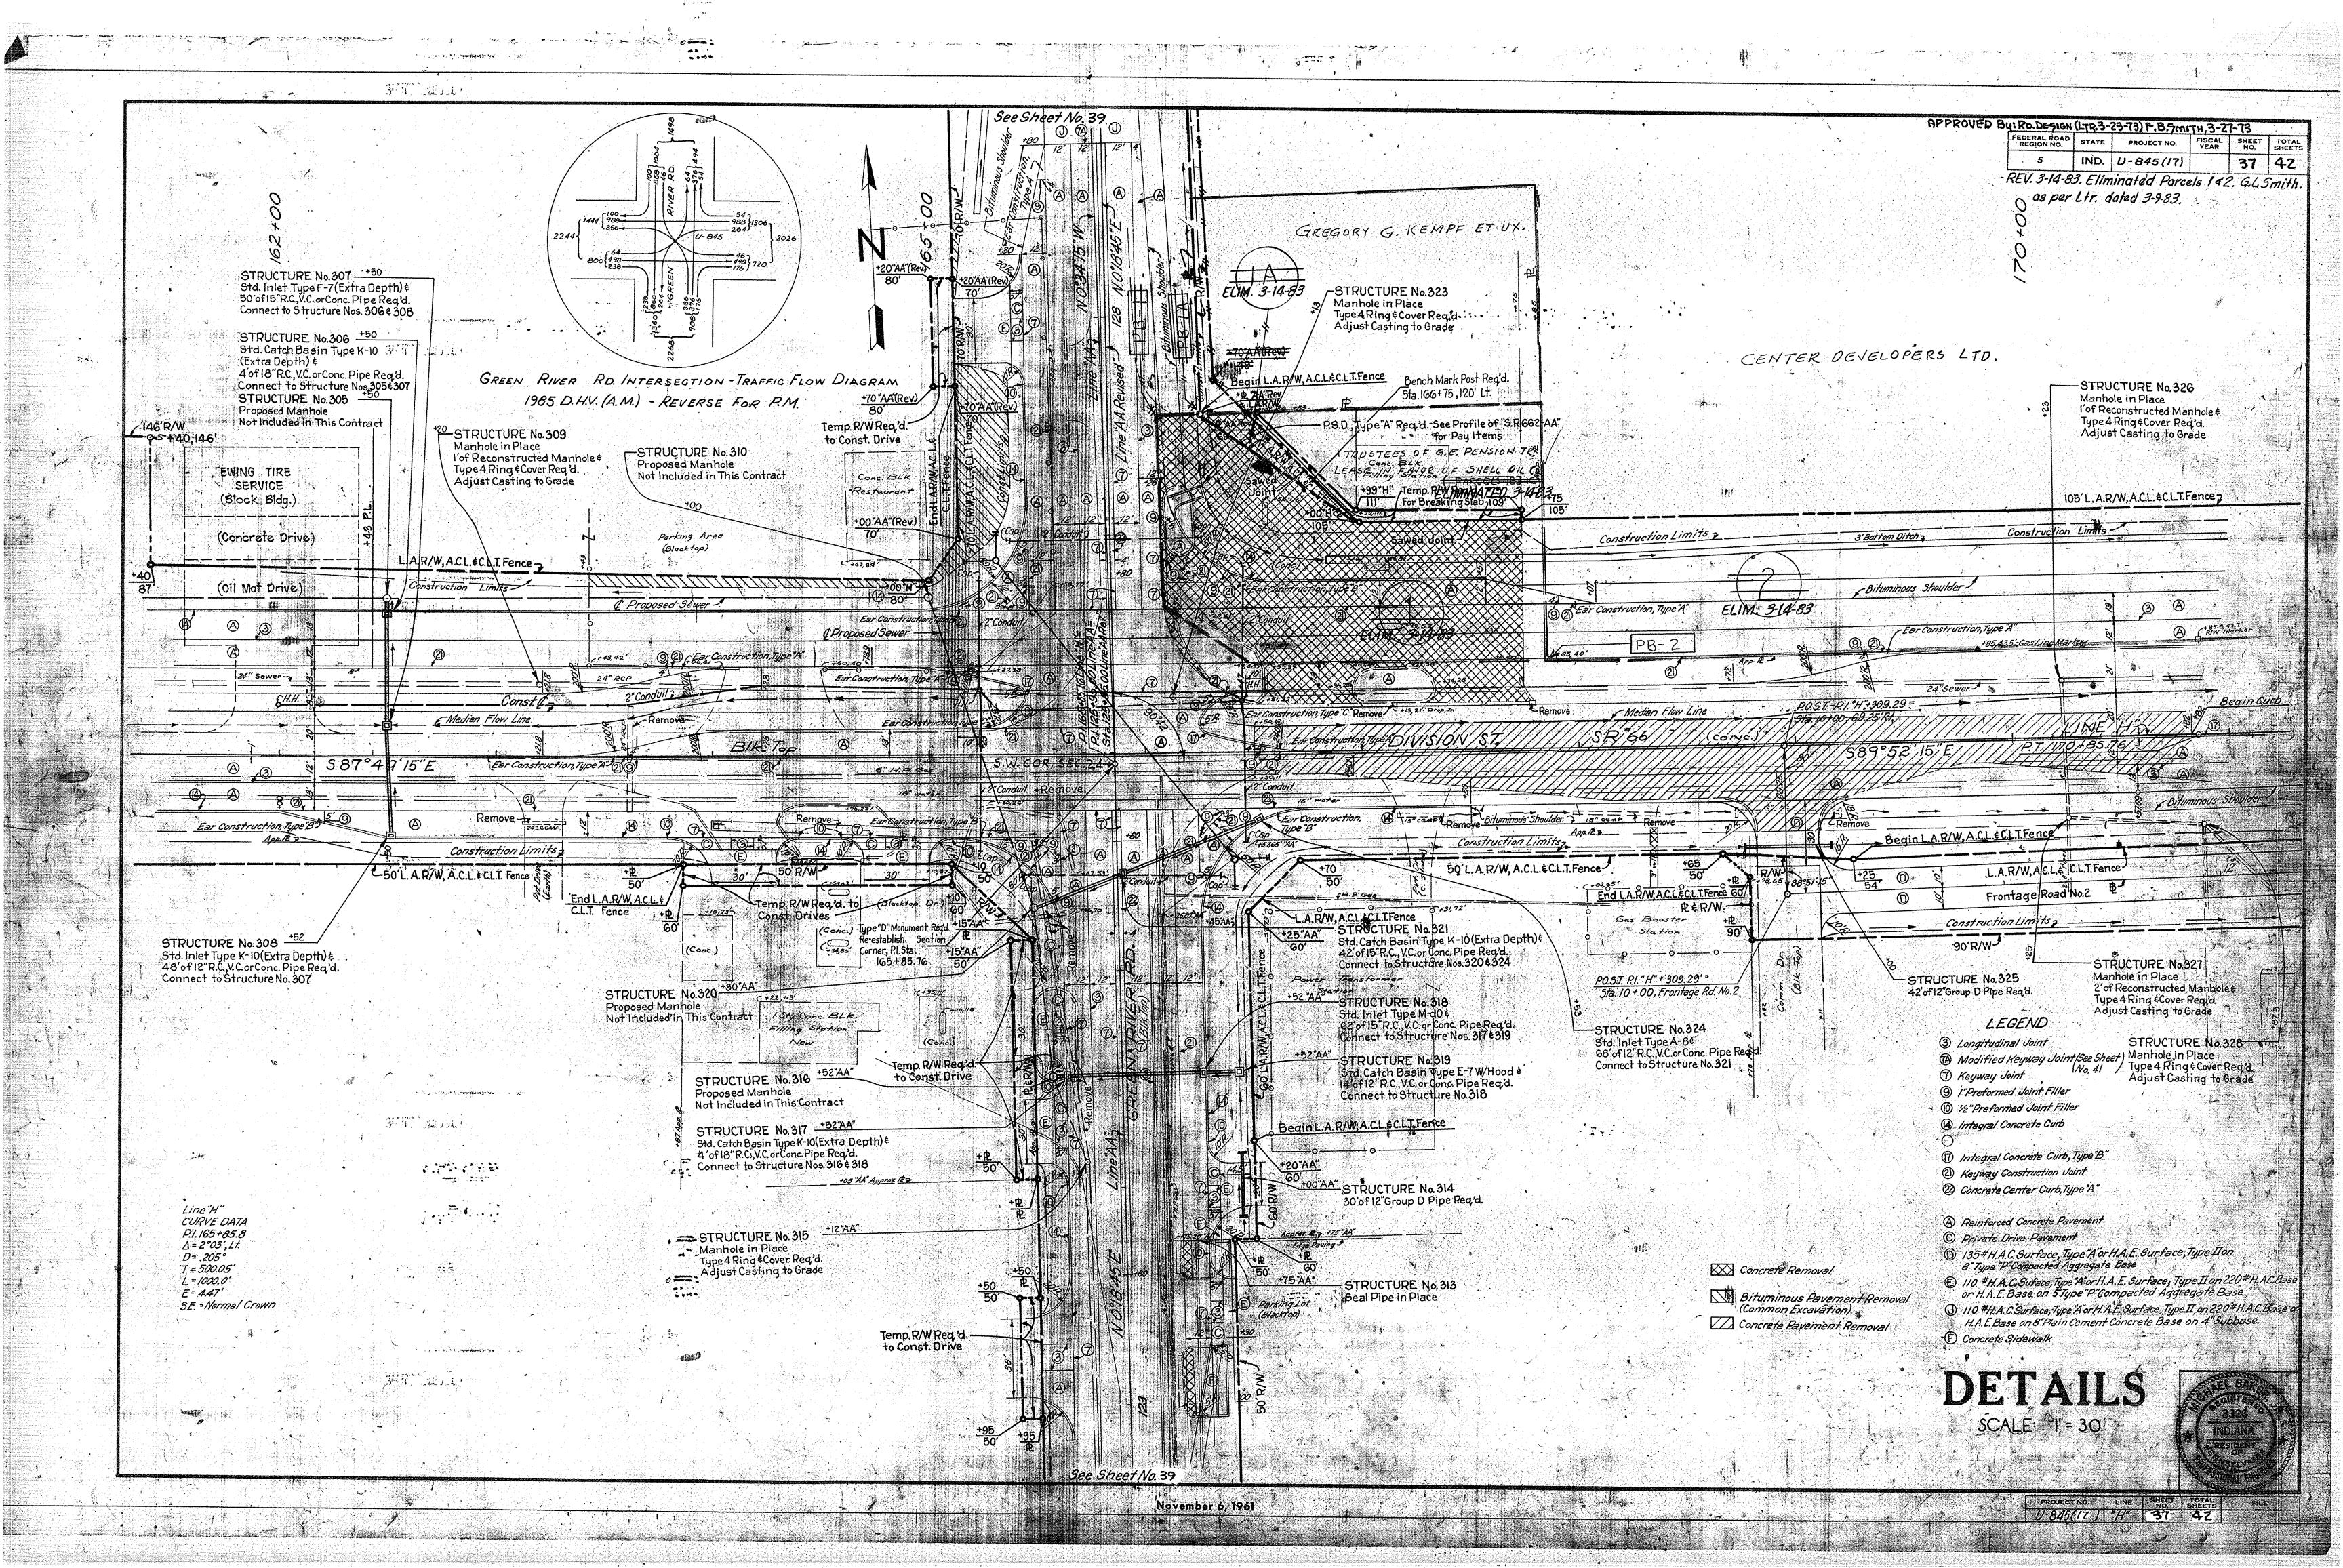

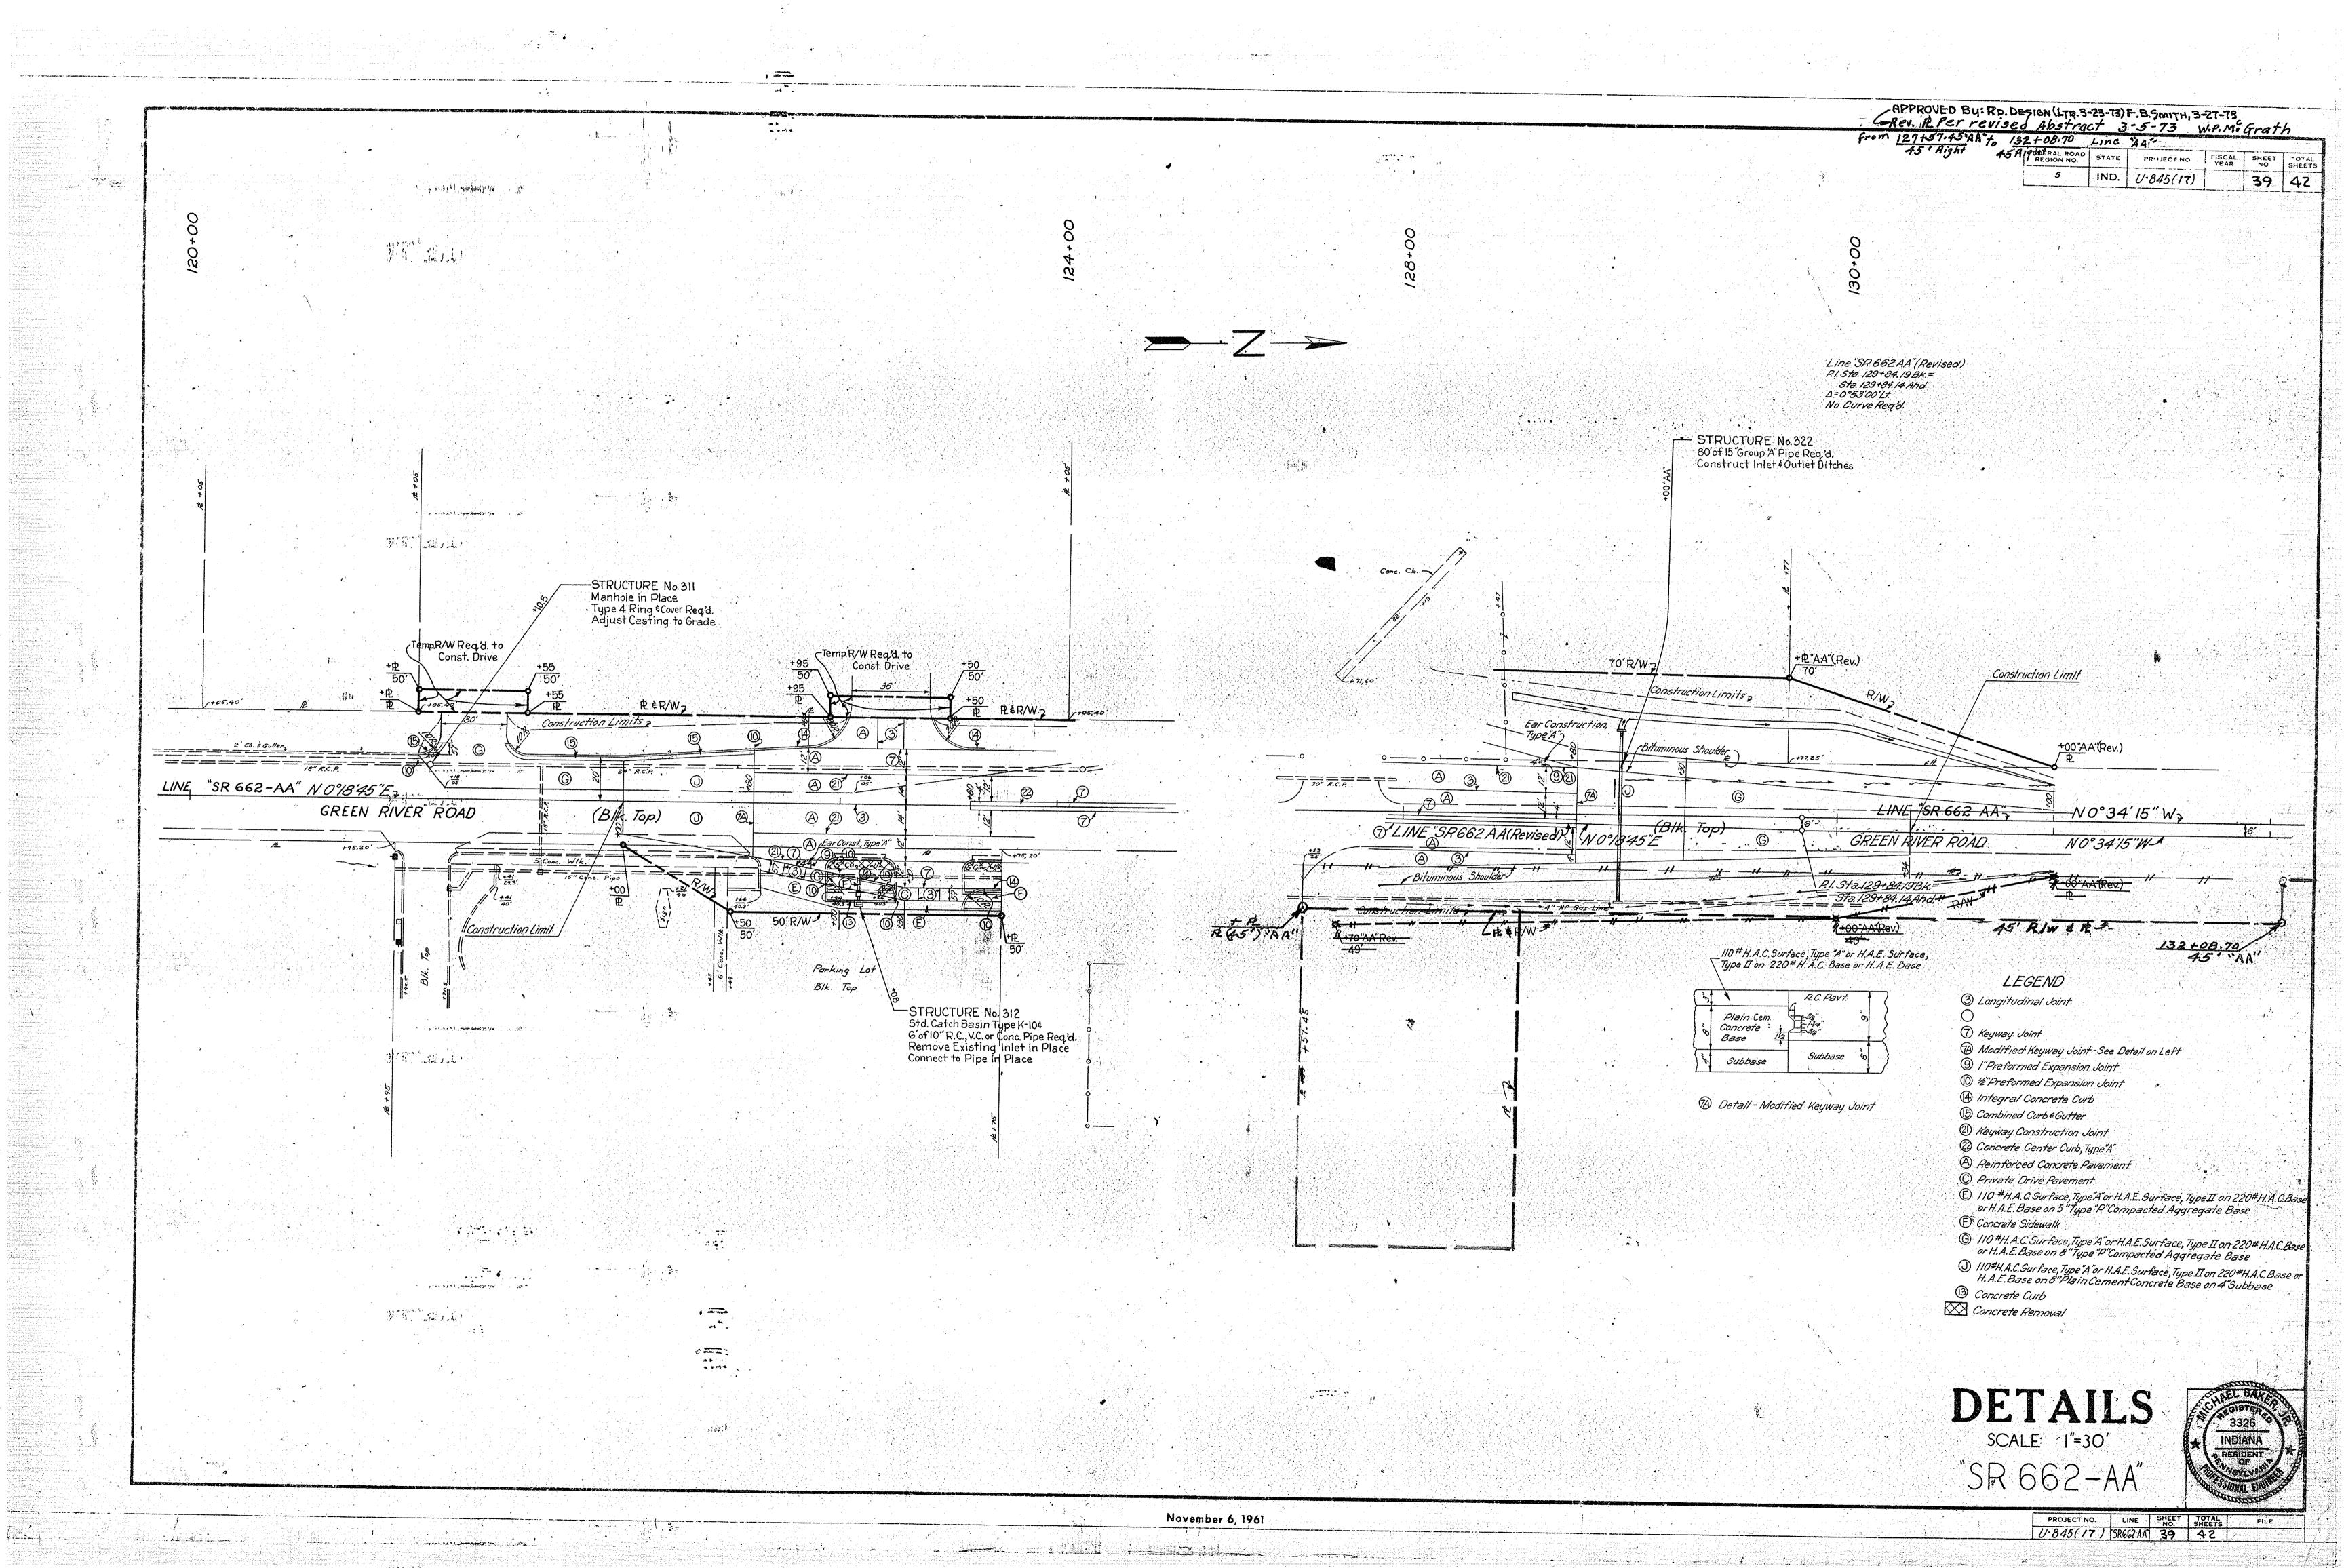

LINE

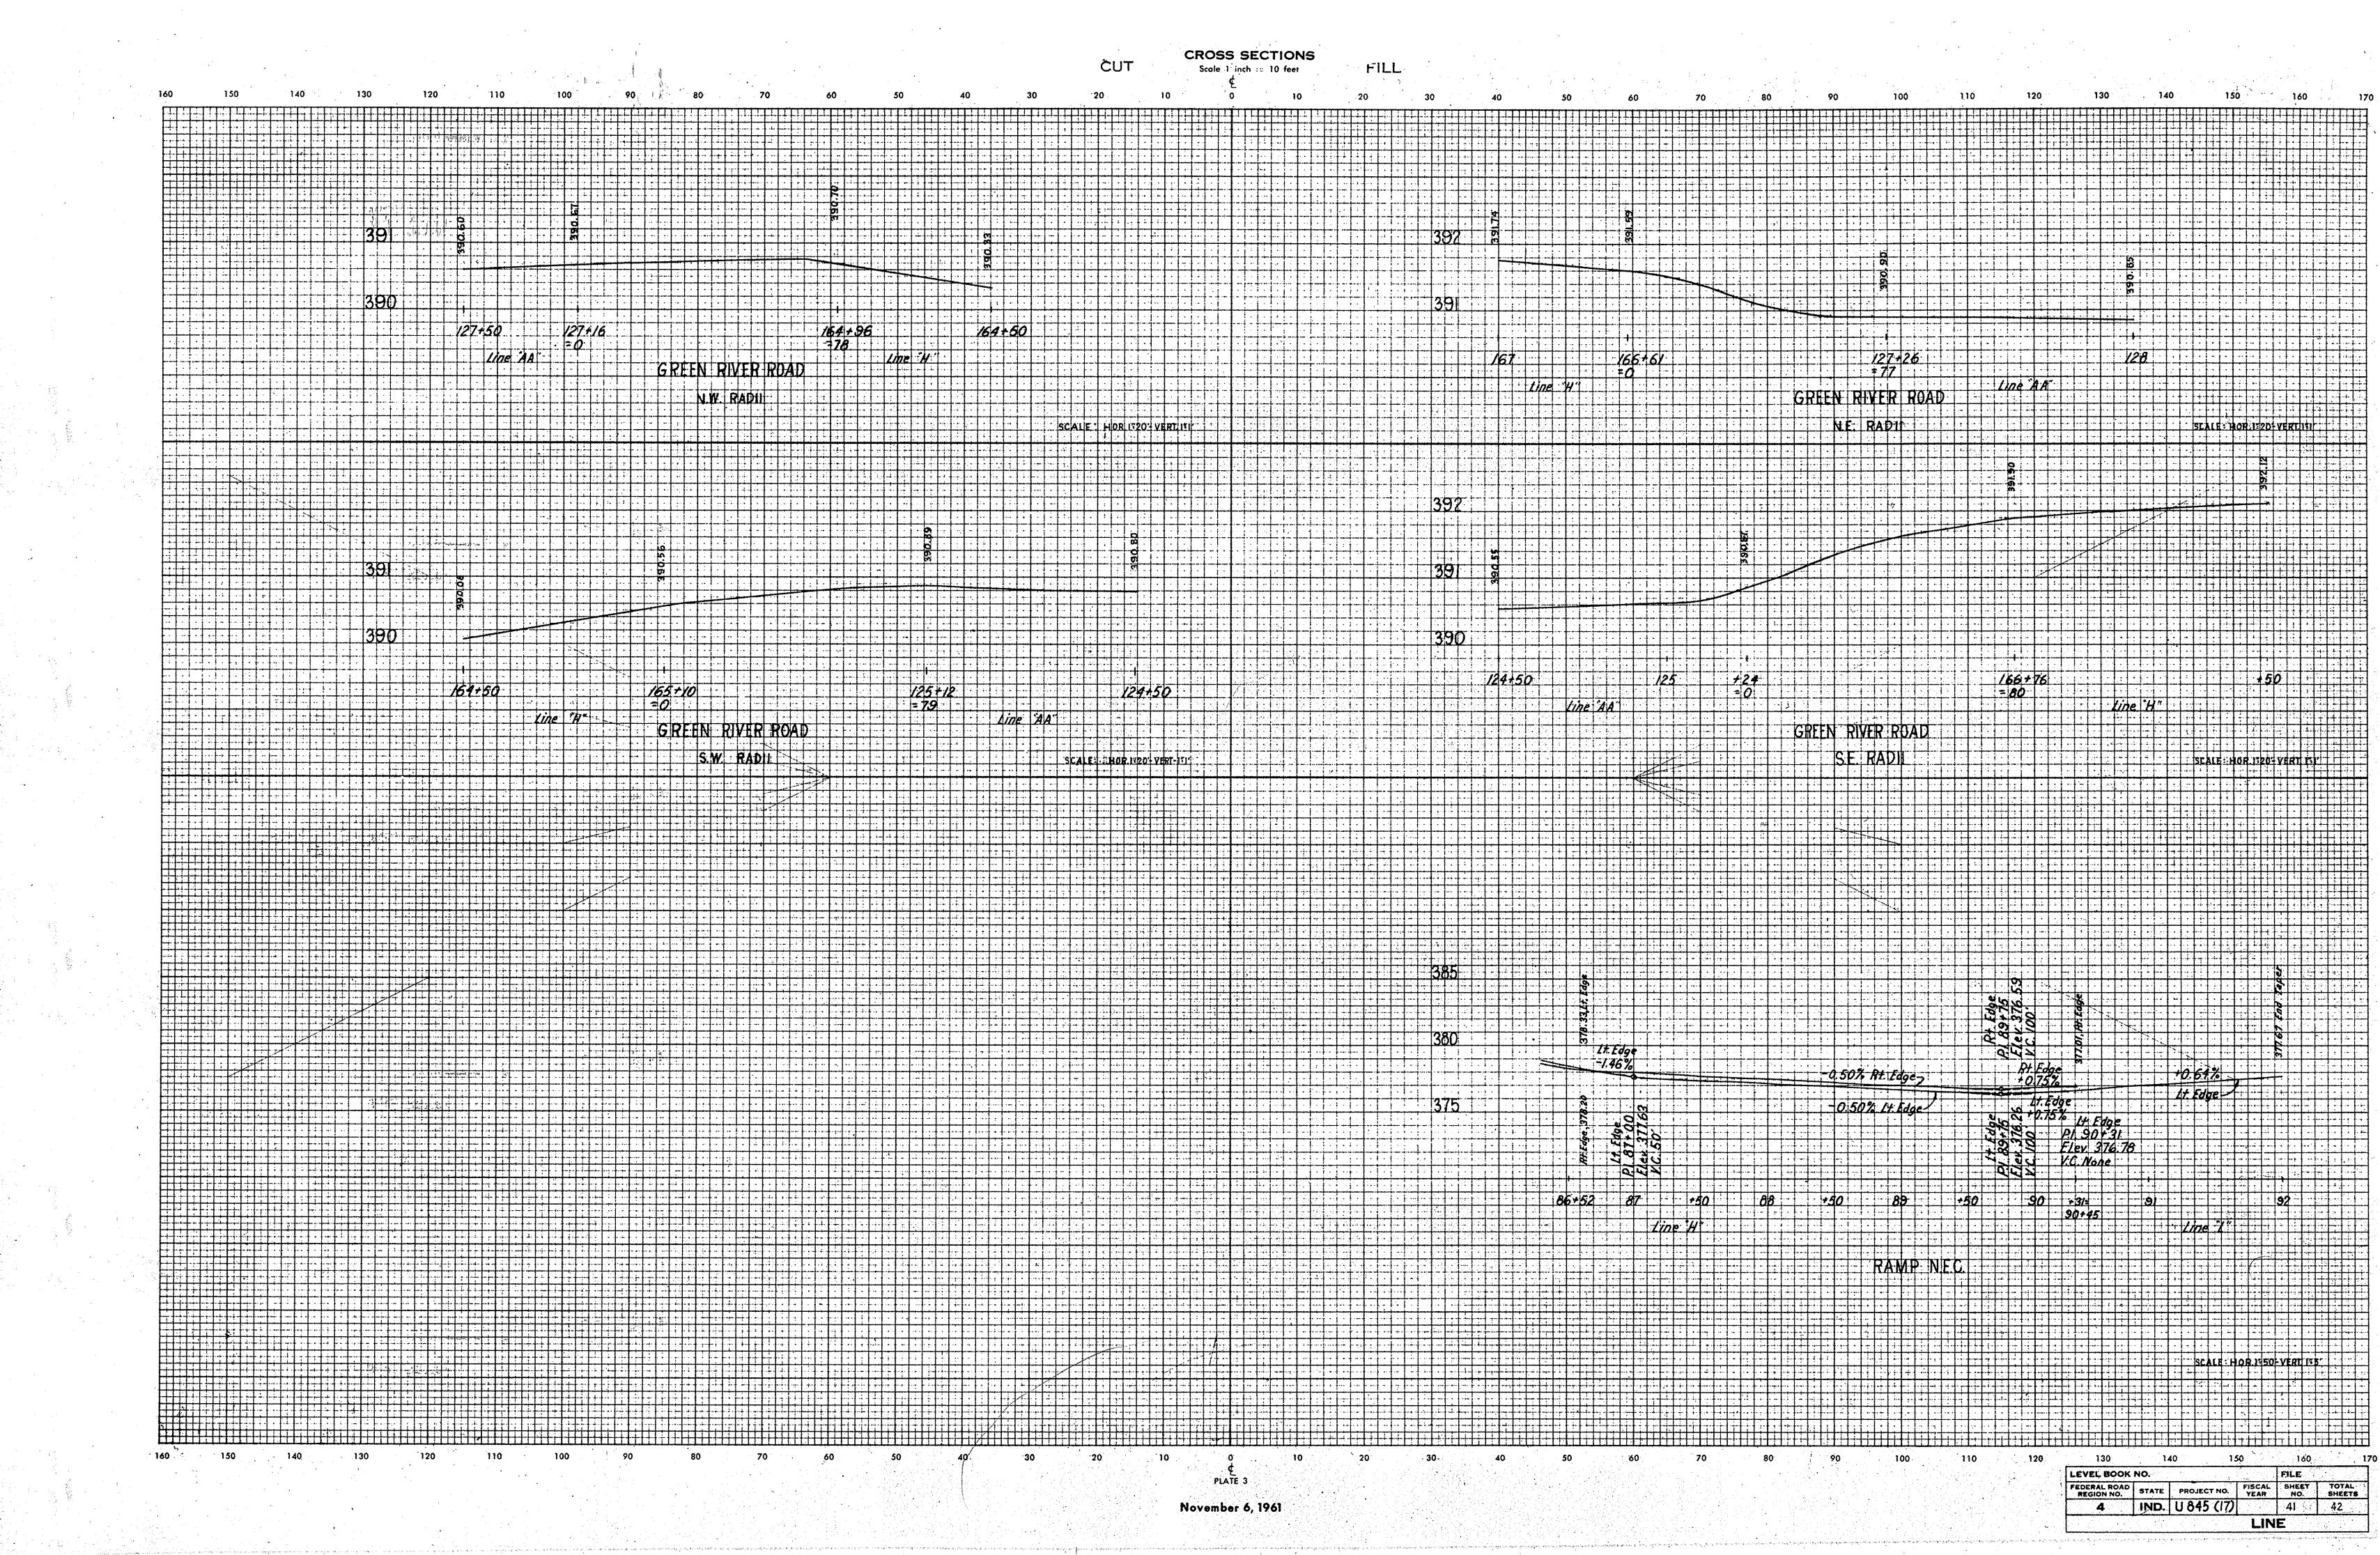

		FYCALLATION		Two-	TIL DADU	Reinf. Conc.	Private Dr. Plain C	A P P Conc. H.A.C. Surface	R O	A C	HE S	Type P*Comn				0-2	ad I	tagval 10		4			4 11	ND. U-845		*HEE NO.
LOCATION	DESCRIPTION	CUT FILL		H WIDT		Pavit.	Private Dr. Plain C Pav't. Bas SYS.	SYS.	•	H.A.E. Base	Surface . A	ggr. Baseor4 Su al. Rd. Matt.	SYS.	Type"P" Comp. Ag		Pre-Form Joint Fill	er C	tegral Conbine oncrete Curb (urb Gutter	d 9"Special Rein Curb Si	forcing Bit. Mat'l	I. Bit. Mat I. 'For Prime Coat	Bit Mat'l Coverir for Tack Aggr. Coat(Appl.)	Conc. Con	nc. Header LFT.	Concrete Dist. Sidewalk - Bey	yond
43, Alley Reloc.,Rt	Alley Approach	2'	13'	12'	6;	3	6" 8"	″ 135 * 110	0# 440#		3" 4"		4" 6"	3″ (6" 8"	//2"		LFT. LFT.		BS.	GAL.	LBS.	Туре	. 'A' Type'B"	1 01	?\W
00 to Sta. 1+54, Willow Rd.	Street Approách		54'	40'	18'	149		99	3	99			25		99	8	6	65 24		20	0.5	0.47				
34, Willow Rd., Rt. 46 to Sta. 2+81, Willow Rd. +64, "K", Lt.	Alley Approach Street Approach	8 25	13' 35'	40'	Depress Curl	95	17		97				16		97	8	H	52 53		19	34	8 2,42			16	
14 to Sta. 1+54, Rotherwood Ave	Exit Street Approach	28	40'	30.	68'-50'	172			67				20		61	19		106		13	23	5 1,67				
16 to Sta.2+77, Rotherwood Ave.	Street Approach		31'	30'	18'-8'-7'	78			56				29 13		56	6	6	88 34 44		111	20	4 1,40	0			
4 to Sta. 1+54, Weinbach Ave. G to Sta. 2+77, Weinbach Ave.	Street Approach Street Approach	47	40' 31'	40'	18'-8'-7'	119			66	99			20 17		99	6	6	40 43 36 126		20	35	2,47 5 1,65	5			
O to Sta. 1+54, Alvord Blvd.S.B. 6 to Sta. 2+77, Alvord Blvd.S.B.	Street Approach	∞×150 ∞ /	74'	21'	18' - 15' 18' - 8'	99		89		89			17.		89	8	6	49 88		18		2,22			37	
O to Sta. 1+54, Alvord Blvd. N.B. 6 to Sta. 2+77, Alvord Blvd. N.B.	Street Approach :	200	74'	21'	18' - 15'	108		89	9 60	89			14		60 89		6	25 23 64 88		12 18	21	5 1,50 2,22	0 5		43	
0 to Sta. 4+54, Boeke Rd.	Street Approach	420	124	40'	50'	460	256	5 256		256			33 77		60	8	34	10 24 160 124		12	21	5 1,50				
6 to Sta. 6+25, Boeke Rd. 00 to Sta. 1+52.5, Harper Ave. 17, Harper Ave. , Lt.	Street Approach Street Approach Private Drive	95 250	102.5	31'	18'-8'	95 110	295	5 256 5 29 23	95 38	295 238			34 16 18		238	3	41	48 152	40	59 48	90 103 83	6,40 7,37 5,9	5		134 59 102	
13, Harper Ave., Rt. 13, Harper Ave., Rt. 10 to Sta. I+74,St. James Blvd	Private Drive	10 15 210	10'	31'	Depress Curl		12	172	.	172																
3.5 St. James Blvd.,Lt. 7 St. James Blvd., Rt.	Private Drive Private Drive	5 10	7.8' 15'	8' 8'	Depress Curt Depress Curt 15' - 50'		7				13				172	4		50 110		34	60	4,30			45	
7 to Sta. 3+50, Public Drive O to Sta. 1+74, Ruston Ave.	Public Road Approach Street Approach	200 150	83' 74'	30' 30'	15' - 50' 18'	77	327	169	3 1 1 1 1 1 1 1 1 1	169			13		169	1 4		48 112		34	59	4,225			17 4	491
5 to Sta. 1+74, Villa Drive 6 to Sta. 3+50, Public Drive	Street Approach Public Road Approach	150 400	59'	41' 30'	2' 18' 25'-40'	97 279	96	174		174			16		174	5		48 82		35		4,350			68	
A to Sta. 1+74, Thomas Ave. A to Sta. 1+74, Dexter Ave.	Street Approach	110 65	40' 40'	36'	18'	87		81		81			14		81	5	6.	128 49 44 52 44		16		2,03	25		21	55′
83, "S-1-H", Rt.	Private Drive	160	43'	Variable	50'		169								09	2		22 44		14	24	1,72	5		37	384
95,"S-1-H", Rt. 80, "S-2-H"Rt.	Private Drive	270	2E'	22,	2' 10' - 50'		195									2	6			4					27	*
84, "5-2-H"Lt.	Private Drive	5	10	10 '							55	55 16														*
00 to Sta. 1+74, Wellworth Ave. 20 to Sta. 1+74, Vann Ave.	Street Approach	125 120	74' 54'	32' 30'	18' 2' 18'	79 75		182 104		182			13		182	5		52 112 57		36	64	4,550			74	
50 to Sta. 1+74, S. Hosp. Ent. 56 to Sta. 3+50, Stockwell Rd.	Private Drive Street Approach	55 275	44' 84'	, ,	2' 20' - 10' 2' 40'	167	23	84 125		84 125			28	86	125			83		17 25	29	2,000 2,100 3,125		0 44		5′
88, Frontage Rd. No. 1 Lt. 00, Frontage Rd. No. 1 Lt.	Private Drive Private Drive	2 3	20' 20'	10'	2' 10' - 20' 2' 10' - 25'						34 47															
56, Frontage Rd. No. 1 Lt. 54, Frontage Rd. No. 1 Lt.	Private Drive Private Drive	2 5	20 20	30) 1	5. 50. 5. 50.			86 86		86 86					89 89					117	30	2,150				
O to Sta. 1+74, Congress Ave. 2, Congress Ave. Lt.	Street Approach Private Drive	70	74	30'	18'	75		169		169			12		169	2		57 54		34		2,150 4,22!			26	
2. Congress Ave. Rt.	Private Drive	5	86.5' 40'	8' 30' 7	10' 2' 20'	85	13	85		85 ,	13														6	31' 72'
+32,"H",Lt. O to Sta. I +74, Iroquois Dr.		70	74	31	18	77		175		175			14		89 175	4		63 57 112		35	30 61	2,125 4,375	5.		45	i,
+41,"H", Lt. +42.5,"H", Rt. (S-4-H)	Public Road Approach Street Approach	10 386 38	40'	30' 7 Yariable	18,	85 78		86 740		86 740			14		89 749			63 48 165		17	30 259	2,150			103	
60, Euclid Dr. Lt. 60, Kenmore Dr., Rt. 20, Kenmore Dr., Rt.	Private Drive Private Drive Private Drive	18 6	2,58 141' 20'	Variable	10,		15 135				F														9	92'
O to Sta. 1+74, Poleter Dr.	Street Approach	200	74'	31'	18	77		175		175			13		175	4		48 112		35	61	4,375			52	
64, Alley,Lt +05, "H", Rl +05, "H",Lt.	Private Drive Commercial Drive	70	6 24	10° 52'	15' 20'	152					5		25					67								
+05,"H,Lt. +14,"H,Rt. +85,"H,Rt.	Public Road Approach Commercial Drive Commercial Drive	4 4	12'	52' 30' 2 30' 7	20' 2' 20' - 10' 2' 10'	86	30 26	86 26 24		86 26 24			14	27	89			63		17 5	30	2,150 650				
+31, Green River Rd.,Lt.	Commercial Drive		20'	30'	10'					65				25	65			20		5	8	600				
+79, Green River Rd.,Rt. +23, Green River Rd.,Lt.	Commercial Drive Commercial Drive			30'	5' 20'	67	20	65 40		40				40				50		8	23	1,625 1,000			17	
+42, Green River Rd., Rt. +00, Green River Rd., Rt.	Commercial Drive		10'	20' 7	2' 20' - 10'		23	15		15				15						3	5	375	20		9	
+27, Green River Rd.Lt. +77, Green River Rd. Lt.	Commercial Drive		14'	30 2			25 30	35 29 31		35 29 31				37 30 32						7 6	12	875 725				
+95 Green River Rd.,Lt. +85.5,"H" Lt. 5+29.5,"H" Lt.	Commercial Drive Commercial Drive		32' 55	230° 2	2' 10' - 20' 4' 40'		30	92		92				95						18	32	775 2,30	0			- :
+95, "H", R1.	Commercial Drive Public Road Approach		30′	29 2	4' 10'-10' 2' 20'-18'			114		114					118					23	40	2,850				
96, Frontage Rd. No.2, Rt.	Public Road Approach Commercial Drive		30.73		2' 15' - 20' 2' 15'			122							127					24		3,050				
+86,"H", Rt.(Rt. of Frontage Rd. No.2)	Commercial Drive		32'	8 2	2' 15' 2' 10'			30						186 JANA 1861	78 35					15	26	1,850			10	0,

* Contained Within Other Temporary R/W.

Included in Other Earthwork

The state of the state of the state of

DETAILS





